
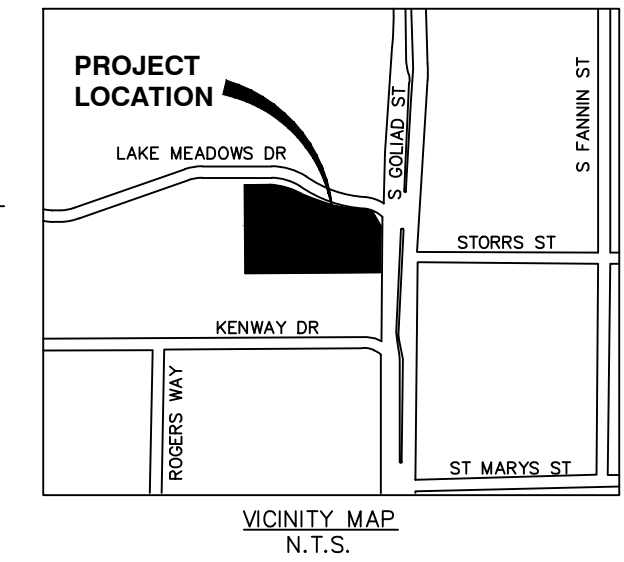


- NOTES**
1. NO EXISTING OR PROPOSED FENCES.
  2. NO UTILITY EQUIPMENT PAD/GROUND OR ROOF MOUNTED.
  3. NO EXISTING OR PROPOSED DUMPSTER.
  4. FIRE HYDRANT DISTANCE IS LESS THAN 400' FROM BUILDING EXTERIOR, R=250' SHOWN TO FIT ON SITE PLAN.

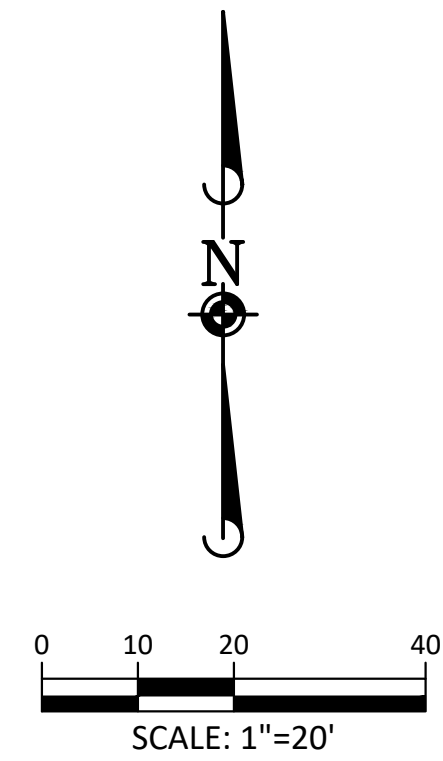

**LEGEND**

⊙	DOUBLE CLEANOUT
⊙	SANITARY MANHOLE
□	JUNCTION BOX
□	CURB INLET
⊞	GRATE INLET
⊞	FDC
⊞	FIRE HYDRANT
⊞	BARRIER FREE RAMP
—	FIRE LANE

**SITE DATA TABLE**

EXISTING ZONING	DT
PROPOSED USE	COMMERCIAL
SITE AREA	0.69 ACRES
<b>BUILDING AREA</b>	
EXISTING BUILDING	2,705 SF
ADDITION	1,246 SF
PROPOSED BUILDING	3,951 SF
<b>PARKING</b>	
PARKING REQUIRED	1/200 SF 15 STANDARD STALLS 1 ACCESSIBLE STALL
PARKING PROVIDED	29 STANDARD STALLS 2 ACCESSIBLE STALLS

NOTE: PROPERTY IS CURRENTLY PLATTED

**PAVING LEGEND**

[Pattern]	EXISTING ASPHALT TO BE MILLED PER TXDOT SPEC ITEM 358.4.4 AND OVERLAID PER TXDOT SPEC ITEM 340.
[Pattern]	LOOP IN ACCESS TO ASSIST LAKE MEADOWS DRIVE AS FIRE APPARATUS TO ATTAIN 150' HOSE LAY DISTANCE (EXISTING CONCRETE)

- NOTES**
1. ALL DIMENSIONS ARE TO FACE OF CURB UNLESS OTHERWISE SPECIFIED.
  2. ALL CURB RADII ARE TO BE 3' UNLESS ALONG FIRELANE UNLESS OTHERWISE SPECIFIED.
  3. REFER TO LANDSCAPE PLANS FOR HARDSCAPE IMPROVEMENTS AND IRRIGATION SLEEVES CROSSING PAVED AREAS.
  4. REFER TO STRUCTURAL PLANS FOR ALL BUILDING, DETACHED GARAGE, AND DUMPSTER ENCLOSURE FOUNDATION DESIGNS AND DETAILS.
  5. FIRELANE STRIPING SHOWN FOR ILLUSTRATIVE PURPOSES ONLY. REFER TO CITY DETAIL AND SPECIFICATIONS FOR EXACT LOCATION.

<b>OWNER</b> DR. STAN LOWRANCE ROCKWALL ROTARY FOUNDATION 408 S. GOLIAD STREET ROCKWALL, TEXAS 75087	<b>DEVELOPER</b> DR. STAN LOWRANCE ROCKWALL ROTARY FOUNDATION 408 S. GOLIAD STREET ROCKWALL, TEXAS 75087	<b>ENGINEER</b> MANHARD CONSULTING 12225 GREENVILLE AVE STE 1000 DALLAS, TEXAS 75243 972.972.4250 PH JESSE CONRAD, P.E.
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**SITE PLAN SIGNATURE BLOCK**

**APPROVED:**  
I hereby certify that the above and foregoing site plan for a development in the City of Rockwall, Texas, was approved by the Planning & Zoning Commission of the City of Rockwall on the \_\_\_\_\_ day of \_\_\_\_\_.

WITNESS OUR HANDS, this \_\_\_\_\_ day of \_\_\_\_\_

\_\_\_\_\_  
Planning & Zoning Commission, Chairman

\_\_\_\_\_  
Director of Planning and Zoning

CASE NUMBER: 2021-013

<b>SITE PLAN</b>			
<b>408 S GOLIAD STREET - 0.69 ACRES</b>			
<b>CITY OF ROCKWALL, ROCKWALL COUNTY, TEXAS</b>			
<b>ROCCA VILLA</b>			
<b>REVISION LOG</b>	<b>DATE:</b>	<b>DESIGN:</b>	<b>AR</b>
05/03/2021 - REVISION #1 PER 1ST CITY COMMENTS	04/16/2021	<b>DRAWN:</b>	<b>AV</b>
05/04/2021 - REVISION #2 PER 1ST CITY COMMENTS		<b>CHECKED:</b>	<b>JC</b>
07/26/2021 - REVISION #3 PER BUILDING FOOTPRINT UPDATE			

**Manhard CONSULTING**

12225 Greenville Avenue, Suite 1000, Dallas, TX 75243, ph: 972.972.4250, manhard.com  
Civil Engineers | Surveyors | Water Resource Engineers | Water & Waste Water Engineers  
Construction Managers | Environmental Scientists | Landscape Architects | Planners  
Texas Board of Professional Engineers and Land Surveyors Registration No. F-217132

**ROCKWALL ROTARY CLUB**

**408 S. GOLIAD, CITY OF ROCKWALL, ROCKWALL COUNTY, TEXAS**

**SITE PLAN**

FOR INTERIM REVIEW ONLY  
THIS DOCUMENT IS NOT  
ISSUED FOR CONSTRUCTION  
OR PERMITTING PURPOSES

JASON T. FYKA, P.E.  
TEXAS P.E. No. 124800  
ISSUED THIS DATE:  
07/26/2021





PROJ. MGR.: JTP  
PROJ. ASSOC.: AAR  
DRAWN BY: ANV  
DATE: 07/26/2021

SHEET  
**C1.0**

09/07/21 Des: Name: P:\611070 Rockwall Rotary Foundation\001 Rockwall Lot Expansion\Site Plan - 005.dwg, Updated By: DSchertz

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PENDING

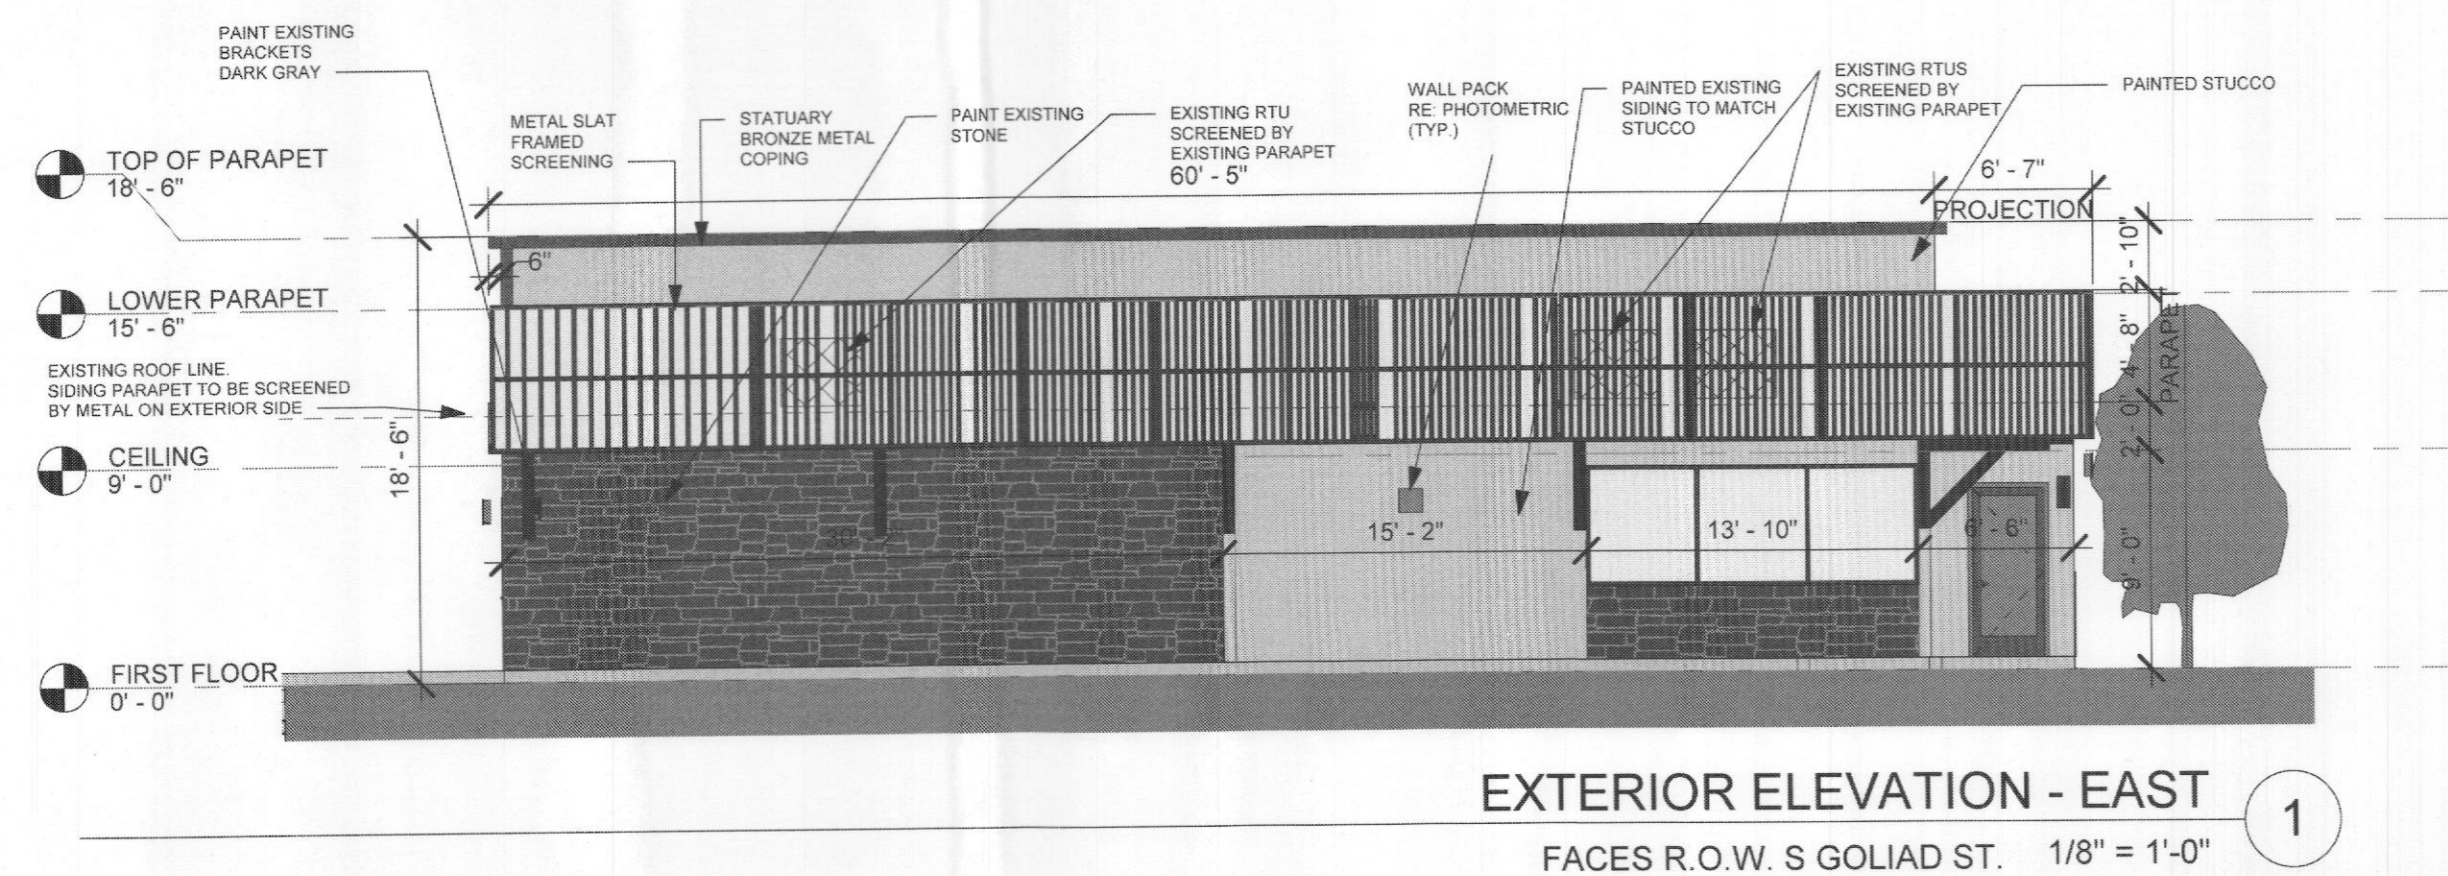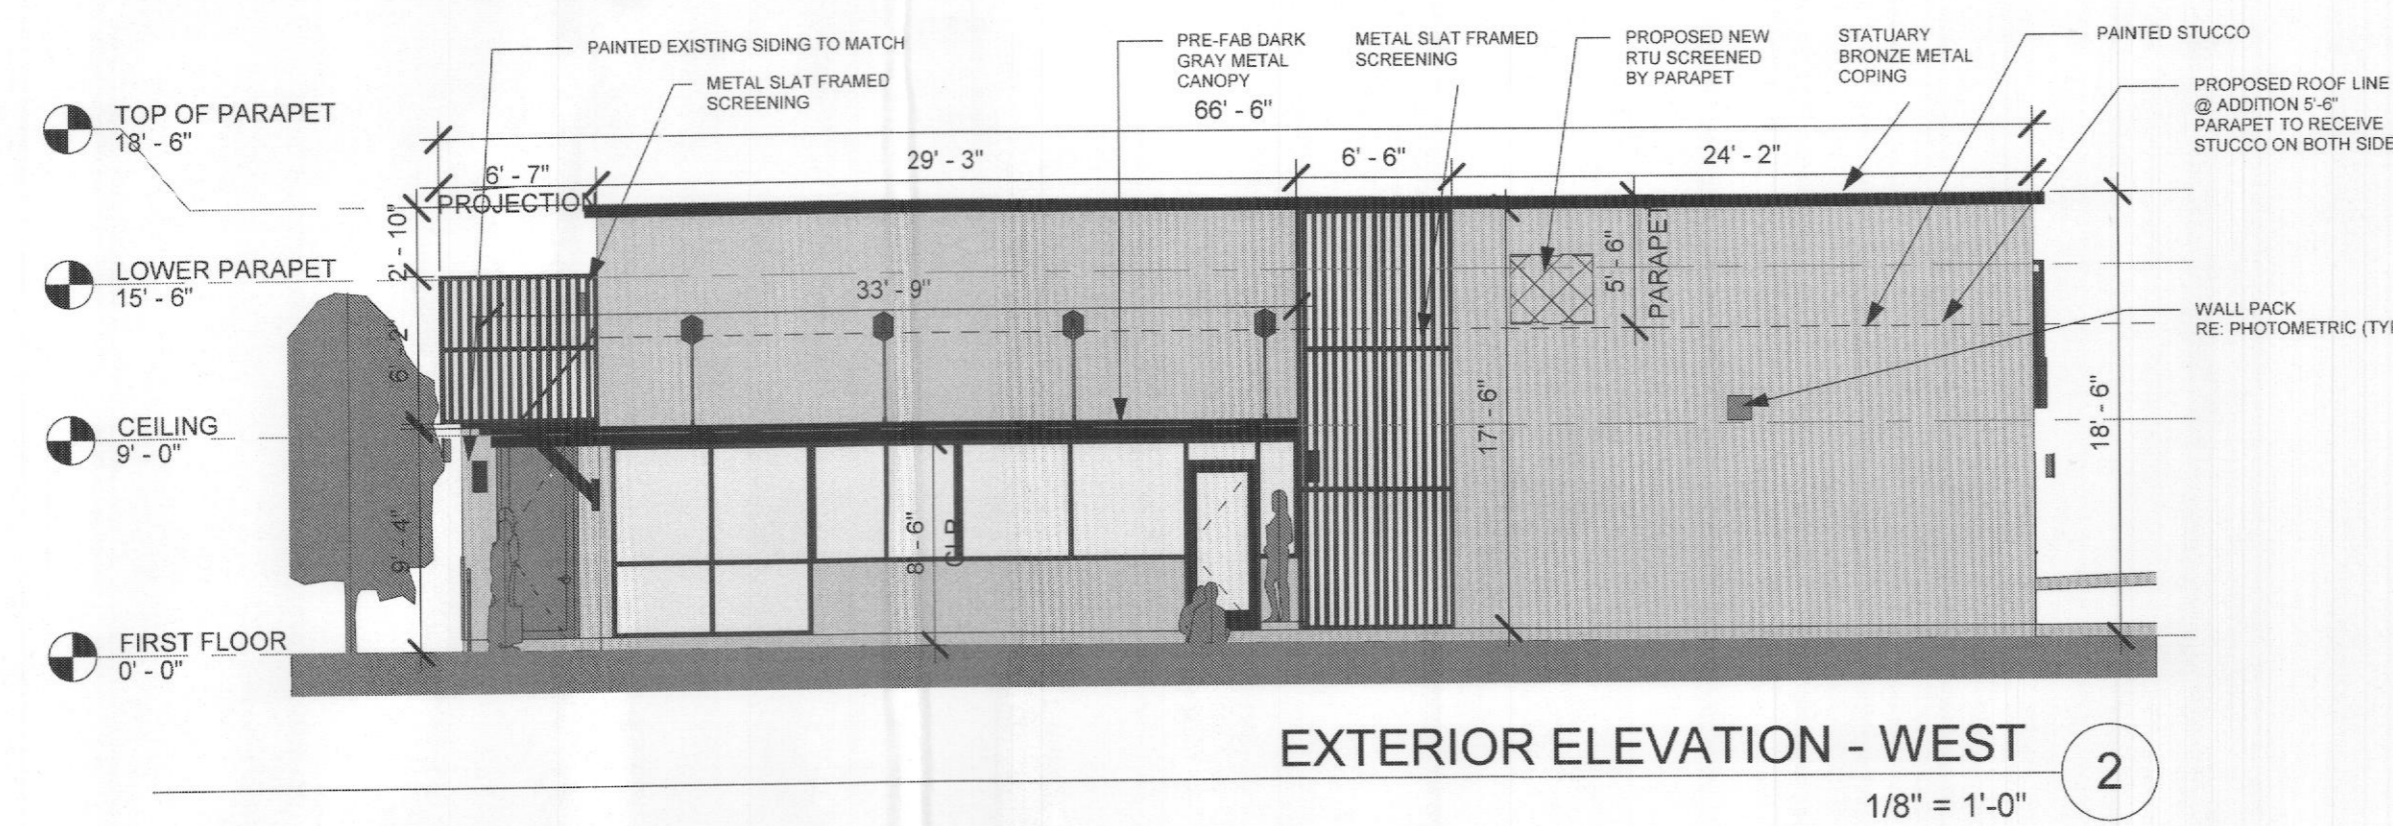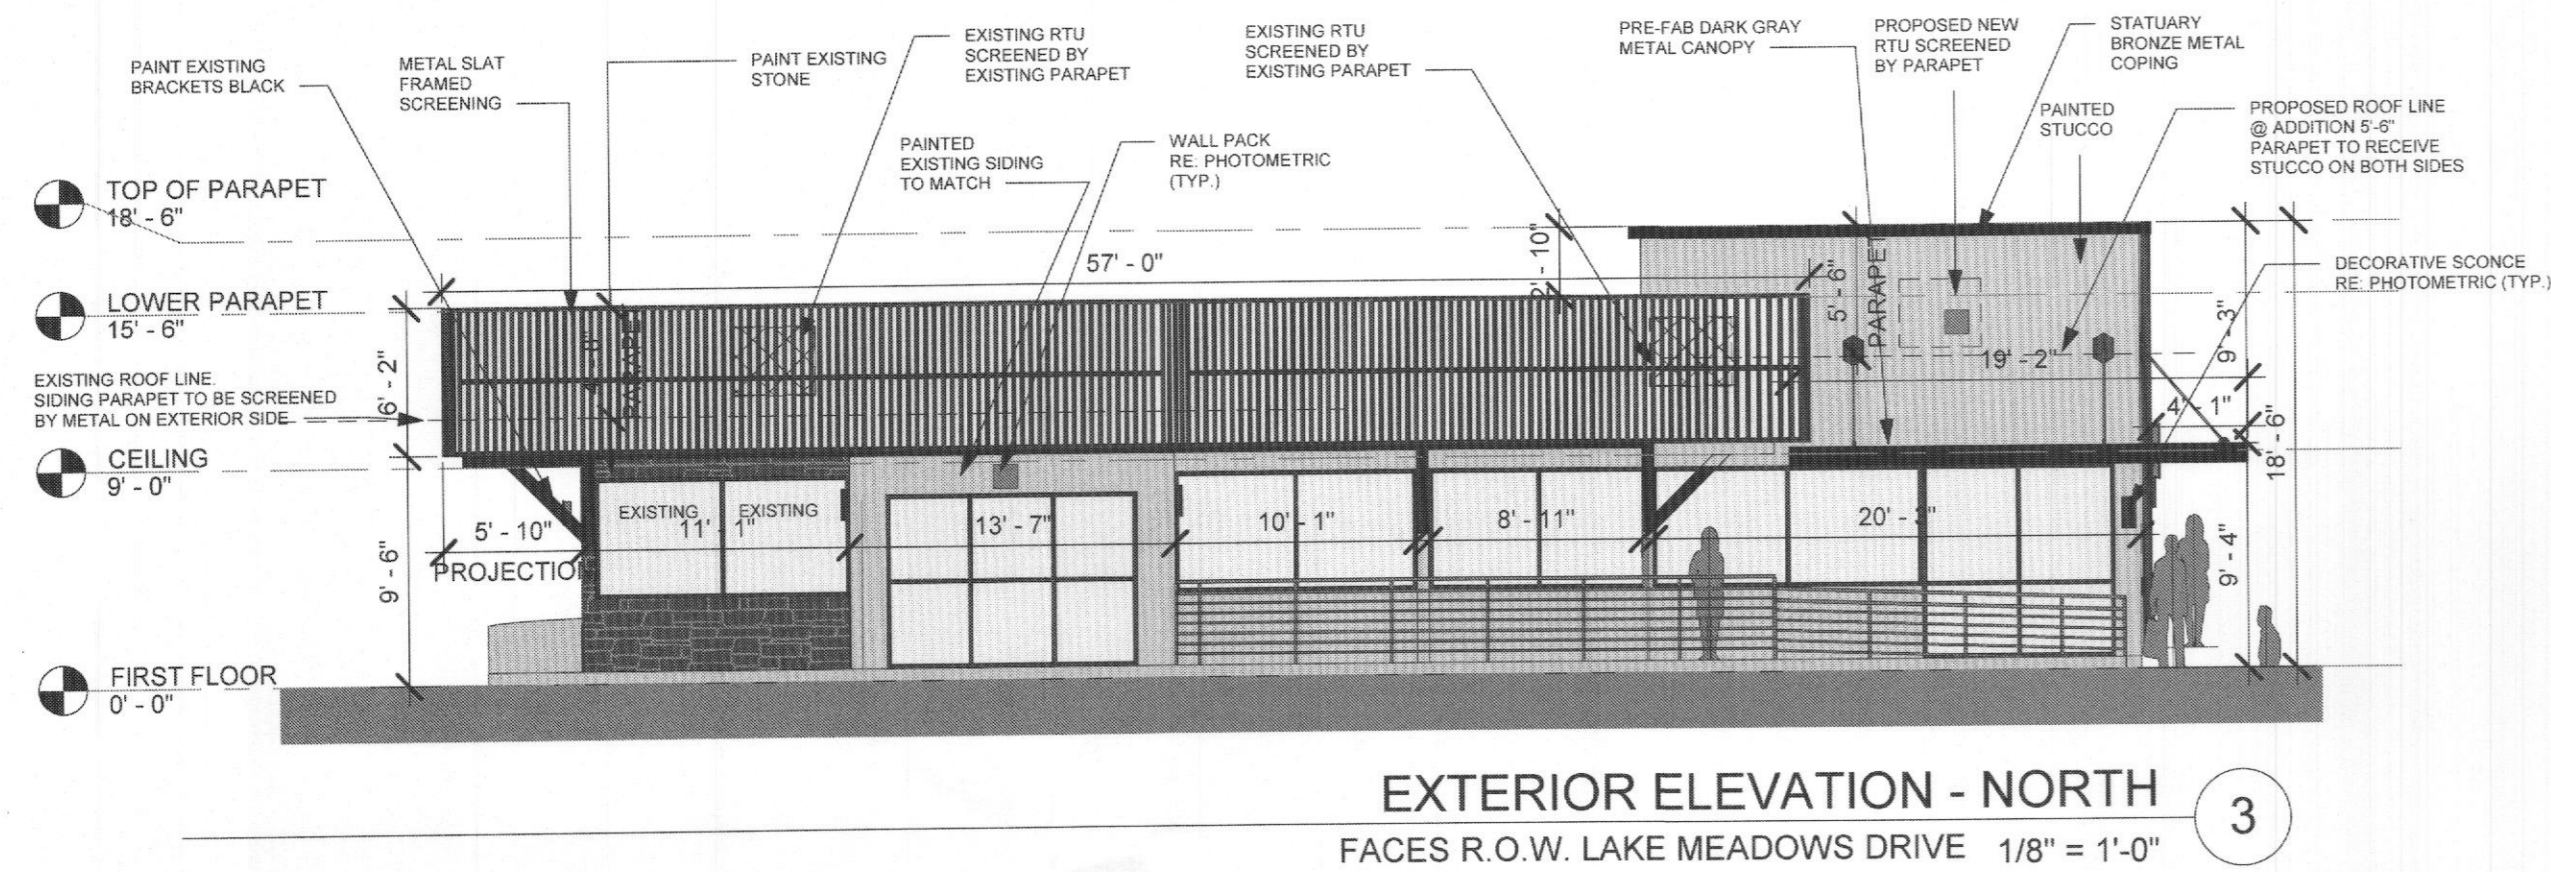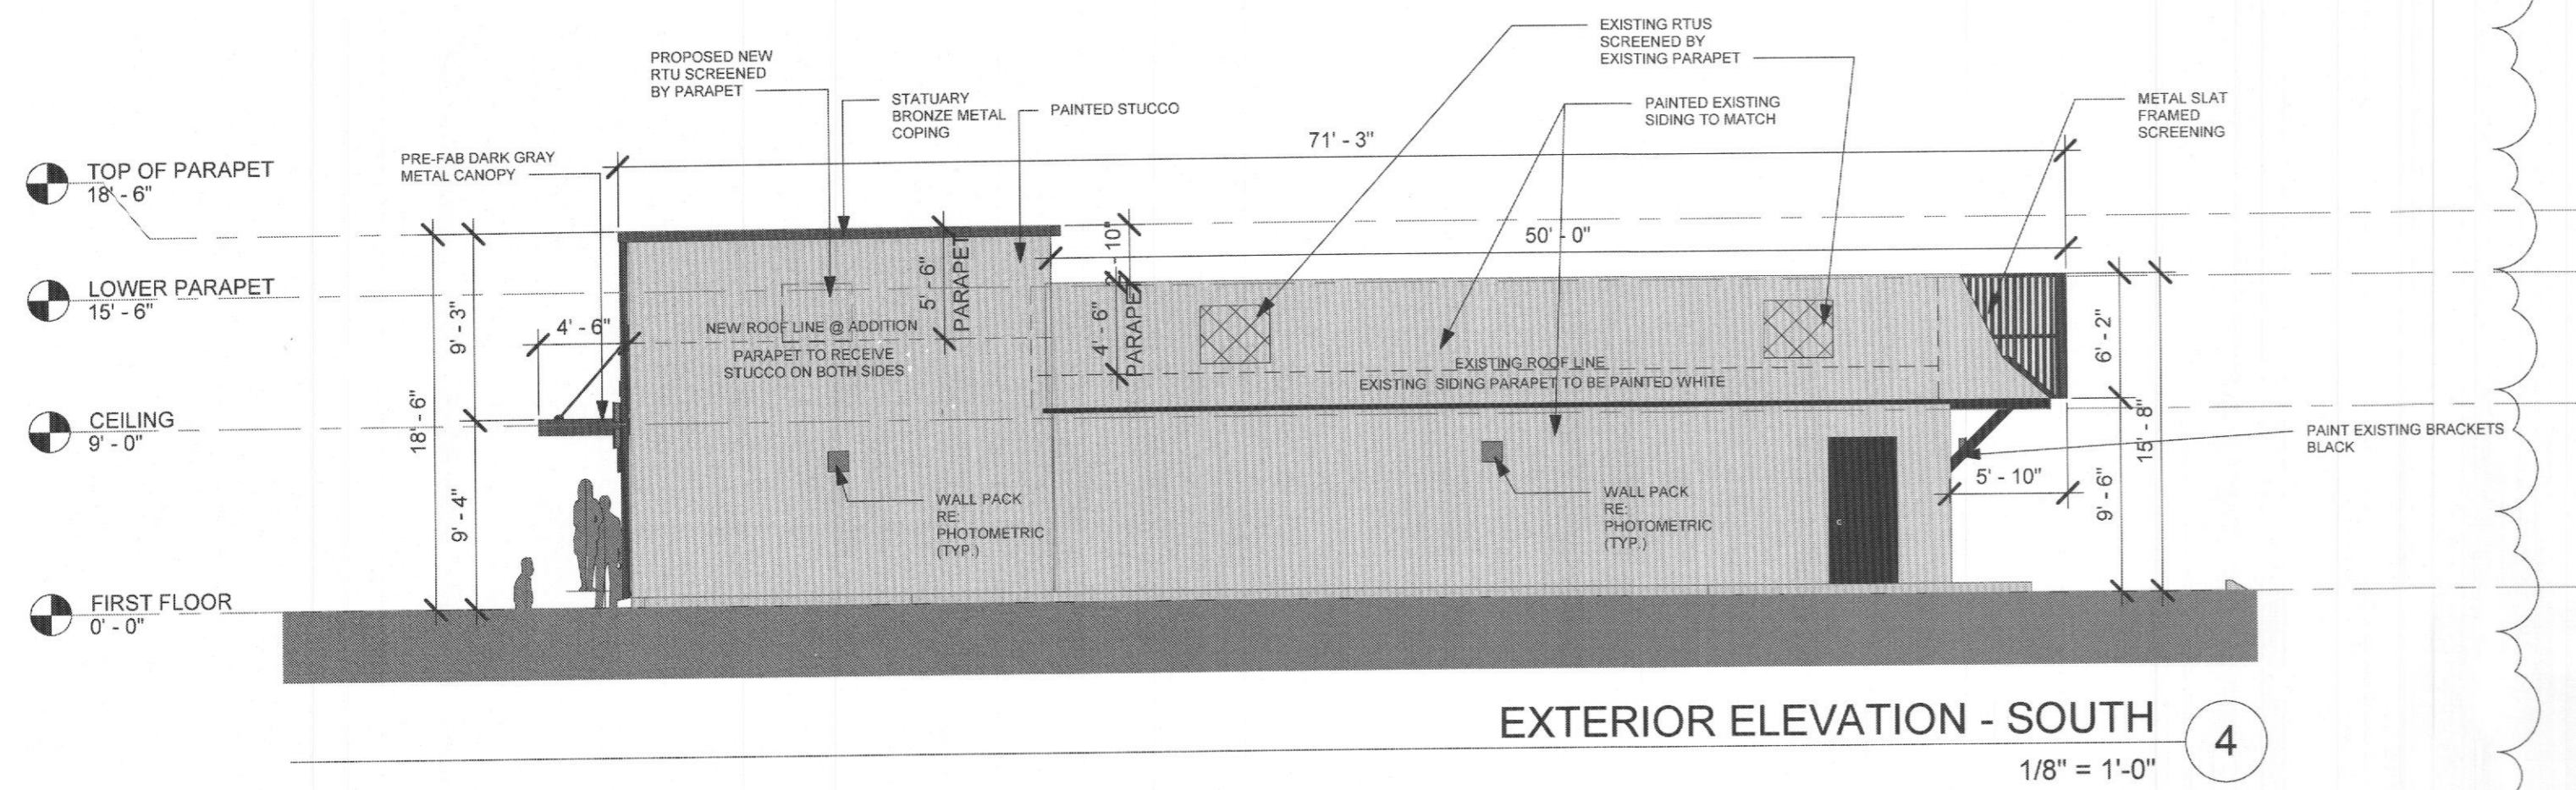

**SOUTH ELEVATION-  
SECONDARY FACADE**

NEW METAL COPING	22.53 SF	1.9%
NEW METAL CANOPY	3.56 SF	1.7%
NEW PAINTED STUCCO	373.5 SF	33%
EXISTING WOOD BRACKETS- PAINTED	5.47 SF	0.5%
NEW METAL SLAT SCREENING	22.75 SF	1.9%
EXISTING SIDING- PAINTED	670.73 SF	61%
TOTAL	1098.54 SF	100%

**NORTH ELEVATION-  
PRIMARY FACADE**

NEW METAL COPING	10.53 SF	1.1%
NEW METAL CANOPY	15.14 SF	1.6%
NEW PAINTED STUCCO	176.3 SF	20.9%
EXISTING WOOD BRACKETS- PAINTED	9.15 SF	1.2%
NEW METAL SLAT SCREENING	350.92 SF	41.9%
EXISTING SIDING- PAINTED	140.69 SF	16.9%
EXISTING STONE- PAINTED	44.62 SF	5.2%
EXISTING GLAZING	52.46 SF	6.1%
NEW GLAZING	42.76 SF	5.1%
TOTAL	842.57 SF	100%

**WEST ELEVATION-  
SECONDARY FACADE**

NEW METAL COPING	30.46 SF	2.6%
NEW METAL CANOPY	26.72 SF	2.3%
NEW PAINTED STUCCO	718.77 SF	62%
EXISTING WOOD BRACKETS- PAINTED	5.47 SF	0.5%
NEW METAL SLAT SCREENING	155.87 SF	13.4%
EXISTING SIDING- PAINTED	24.39 SF	2.1%
NEW GLAZING	204.78 SF	17.1%
TOTAL	1,166.46 SF	100%

**EAST ELEVATION-PRIMARY  
FACADE**

NEW METAL COPING	30.46 SF	2.6%
NEW PAINTED STUCCO	170.46 SF	14.1%
EXISTING WOOD BRACKETS- PAINTED	22.81 SF	2%
NEW METAL SLAT SCREENING	410.48 SF	34%
EXISTING SIDING- PAINTED	185.24 SF	15.3%
EXISTING STONE- PAINTED	317.38 SF	26.3%
EXISTING GLAZING	69.17 SF	5.7%
TOTAL	1206 SF	100%

**SITE PLAN SIGNATURE BLOCK**

**APPROVED:**  
I hereby certify that the above and foregoing site plan for a development in the City of Rockwall, Texas, was approved by the Planning & Zoning Commission of the City of Rockwall on the 11 day of May, 2021.

WITNES OUR HANDS, this 11 day of May, 2021.

*[Signature]*  
Planning & Zoning Commission, Chairman

*[Signature]*  
Director of Planning and Zoning

**MATERIAL INDEX**

	METAL COPING COLOR: STATUARY BRONZE FINISH: MATTE
	EXTRUDECK METAL CANOPY COLOR: DARK GREY FINISH: MATTE
	PAINTED STUCCO COLOR: WHITE DOVE FINISH: MATTE
	PAINTED EXISTING BRACKETS COLOR: BLACK FINISH: MATTE
	ALUMINUM SLAT SCREEN COLOR: WALNUT FINISH: MATTE
	EXISTING SIDING - PAINTED TO MATCH STUCCO COLOR: WHITE DOVE FINISH: MATTE
	EXISTING STONE - PAINTED COLOR: EVENING DOVE FINISH: MATTE

CASE NUMBER: SP2021-013

**PLANTING SPECIFICATIONS**

**GENERAL**

- A. QUALIFICATIONS OF LANDSCAPE CONTRACTOR**
1. ALL LANDSCAPE WORK SHOWN ON THESE PLANS SHALL BE PERFORMED BY A SINGLE FIRM SPECIALIZING IN LANDSCAPE PLANTING.
  2. A LIST OF SUCCESSFULLY COMPLETED PROJECTS OF THIS TYPE, SIZE AND NATURE MAY BE REQUESTED BY THE OWNER FOR FURTHER QUALIFICATION MEASURES.
  3. THE LANDSCAPE CONTRACTOR SHALL HOLD A VALID NURSERY AND FLORAL CERTIFICATE ISSUED BY THE TEXAS DEPARTMENT OF AGRICULTURE, AS WELL AS OPERATE UNDER A COMMERCIAL PESTICIDE APPLICATOR LICENSE ISSUED BY EITHER THE TEXAS DEPARTMENT OF AGRICULTURE OR THE TEXAS STRUCTURAL PEST CONTROL BOARD.

**B. SCOPE OF WORK**

1. WORK COVERED BY THESE SECTIONS INCLUDES THE FURNISHING AND PAYMENT OF ALL MATERIALS, LABOR, SERVICES, EQUIPMENT, LICENSES, TAXES AND ANY OTHER ITEMS THAT ARE NECESSARY FOR THE EXECUTION, INSTALLATION AND COMPLETION OF ALL WORK, SPECIFIED HEREIN AND/OR SHOWN ON THE LANDSCAPE PLANS, NOTES, AND DETAILS.
2. ALL WORK SHALL BE PERFORMED IN ACCORDANCE WITH ALL APPLICABLE LAWS, CODES AND REGULATIONS REQUIRED BY AUTHORITIES HAVING JURISDICTION OVER SUCH WORK, INCLUDING ALL INSPECTIONS AND PERMITS REQUIRED BY FEDERAL, STATE AND LOCAL AUTHORITIES IN SUPPLY, TRANSPORTATION AND INSTALLATION OF MATERIALS.
3. THE LANDSCAPE CONTRACTOR SHALL VERIFY THE LOCATION OF ALL UNDERGROUND UTILITY LINES (WATER, SEWER, ELECTRICAL, TELEPHONE, GAS, CABLE, TELEVISION, ETC.) PRIOR TO THE START OF ANY WORK.






**PRODUCTS**

- A. ALL MANUFACTURED PRODUCTS SHALL BE NEW:**
- B. CONTAINERS, GALLED-AND-BURLAPPED PLANTS:**
1. FURNISH NURSERY-GROWN PLANTS COMPLYING WITH ANSI Z90.1-2014. PROVIDE WELL-SHAPED, FULLY BRANCHED, HEALTHY, VIGOROUS STOCK FREE OF DISEASE, INSECTS, EGGS, LARVAE AND DEFECTS SUCH AS KNOTS, SUN SCALD, INJURIES, ABRASIONS, AND DISFIGUREMENT. ALL PLANTS WITHIN A SPECIES SHALL HAVE SIMILAR SIZE, AND SHALL BE OF A FORM TYPICAL FOR THE SPECIES. ALL TREES SHALL BE OBTAINED FROM SOURCES WITHIN 200 MILES OF THE PROJECT SITE, AND WITH SIMILAR CLIMATIC CONDITIONS.
  2. ROOT SYSTEMS SHALL BE HEALTHY, DENSELY BRANCHED ROOT SYSTEMS, NON-POT-BOUND, FREE FROM ENCIRCLING AND/OR GIRDLING ROOTS, AND FREE FROM ANY OTHER ROOT DEFECTS (SUCH AS J-SHAPED ROOTS).
  3. TREES MAY BE PLANTED FROM CONTAINERS OR GALLED-AND-BURLAPPED (BAB), UNLESS SPECIFIED ON THE PLANTING LEGEND. BARE-ROOT TREES ARE NOT ACCEPTABLE.
  4. ANY PLANT DEEMED UNACCEPTABLE BY THE LANDSCAPE ARCHITECT OR OWNER SHALL BE IMMEDIATELY REMOVED FROM THE SITE AND SHALL BE REPLACED WITH AN ACCEPTABLE PLANT OF LIKE TYPE AND SIZE AT THE CONTRACTOR'S OWN EXPENSE. ANY PLANTS APPEARING TO BE UNHEALTHY EVEN IF DETERMINED TO STILL BE ALIVE, SHALL NOT BE ACCEPTED. THE LANDSCAPE ARCHITECT AND OWNER SHALL BE THE SOLE JUDGES AS TO THE ACCEPTABILITY OF PLANT MATERIAL.
  5. ALL TREES SHALL BE STAKED IN A FORM UNLESS OTHERWISE SPECIFIED. TREES WITH CENTRAL LEADERS WILL NOT BE ACCEPTED IF LEADER IS DAMAGED OR REMOVED. PRUNE ALL DAMAGED TWIGS AFTER PLANTING.
  6. CALIPER MEASUREMENTS FOR STANDARD (SINGLE TRUNK) TREES SHALL BE AS FOLLOWS: SIX INCHES ABOVE THE ROOT FLARE FOR TREES UP TO AND INCLUDING FOUR INCHES IN CALIPER, AND TWELVE INCHES ABOVE THE ROOT FLARE FOR TREES EXCEEDING FOUR INCHES IN CALIPER.
  7. MULTI-TRUNK TREES SHALL BE MEASURED BY THEIR OVERALL HEIGHT, MEASURED FROM THE TOP OF THE ROOT BALL, WHERE CALIPER MEASUREMENTS ARE USED. THE CALIPER SHALL BE CALCULATED AS ONE-HALF OF THE SUM OF THE CALIPER OF THE THREE LARGEST TRUNKS.
  8. ANY TREE OR SHRUB SHOWN TO HAVE EXCESS SOIL PLACED ON TOP OF THE ROOT BALL, SO THAT THE ROOT FLARE HAS BEEN COMPLETELY COVERED, SHALL BE REJECTED.
- C. SOD. PROVIDE WELL-ROOTED SOD OF THE VARIETY NOTED ON THE PLANS. SOD SHALL BE CUT FROM HEALTHY, MATURE TURF WITH SOIL THICKNESS OF 3/4" TO 1". EACH PALLET OF SOD SHALL BE ACCOMPANIED BY A CERTIFICATE FROM SUPPLIER STATING THE COMPOSITION OF THE SOD.**
- D. TOPSOIL: SANDY TO CLAY LOAM TOPSOIL, FREE OF STONES LARGER THAN 1/2" INCH, FOREIGN MATTER, PLANTS, ROOTS, AND SEEDS.**
- E. COMPOST: WELL-COMPOSTED, STABLE, AND WEED-FREE ORGANIC MATTER, pH RANGE OF 5.5 TO 8. MOISTURE CONTENT 35 TO 55 PERCENT BY WEIGHT; 100 PERCENT PASSING THROUGH 3/4-INCH SIEVE. SOLUBLE SALT CONTENT: 10 TO 20 MG/CM; NOT EXCEEDING 0.5 PERCENT INERT CONTAMINANTS AND FREE OF SUBSTANCES TOXIC TO PLANTINGS. NO MANURE OR ANIMAL-BASED PRODUCTS SHALL BE USED.**
- F. FERTILIZER: GRANULAR FERTILIZER CONSISTING OF NITROGEN, PHOSPHORUS, POTASSIUM, AND OTHER NUTRIENTS IN PROPORTIONS, AMOUNTS, AND RELEASE RATES RECOMMENDED IN A SOIL REPORT FROM A QUALIFIED SOIL-TESTING AGENCY (SEE BELOW).**
- G. MULCH: SIZE AND TYPE AS INDICATED ON PLANS, FREE FROM DELETERIOUS MATERIALS AND SUITABLE AS A TOP DRESSING OF TREES AND SHRUBS.**
- H. TREE STAKING AND GUYING**
1. STAKES: 6' LONG GREEN METAL T-POSTS.
  2. GUY AND WIRE: ASTM A 641, CLASS 1, GALVANIZED-STEEL WIRE, 2-STRAND, TWISTED, 0.108 INCH DIAMETER.
  3. STRAP CHAINING GUARD: REINFORCED NYLON OR CANVAS AT LEAST 1-1/2 INCH WIDE, WITH GROMMETS TO PROTECT TREE TRUNKS FROM DAMAGE.
- I. STEEL EDGING: PROFESSIONAL STEEL EDGING, 1/4 GAUGE THICK X 4 INCHES WIDE, FACTORY PAINTED DARK GREEN. ACCEPTABLE MANUFACTURERS INCLUDE COI, MET OR APPROVED EQUAL.**
- J. PRE-EMERGENT HERBICIDES: ANY GRANULAR, NON-STAINING PRE-EMERGENT HERBICIDE THAT IS LABELED FOR THE SPECIFIC ORNAMENTALS OR TURF ON WHICH IT WILL BE UTILIZED. PRE-EMERGENT HERBICIDES SHALL BE APPLIED PER THE MANUFACTURER'S LABELED RATES.**

**METHODS**

- A. SOIL PREPARATION**
1. BEFORE STARTING WORK, THE LANDSCAPE CONTRACTOR SHALL VERIFY THAT THE GRADE OF ALL LANDSCAPE AREAS ARE WITHIN +0.1' OF FINISH GRADE. THE CONTRACTOR SHALL NOTIFY THE OWNER IMMEDIATELY SHOULD ANY DISCREPANCIES EXIST.
  2. SOIL TESTING:
    - a. AFTER FINISH GRADES HAVE BEEN ESTABLISHED, CONTRACTOR SHALL HAVE SOIL SAMPLES FROM THE PROJECT'S LANDSCAPE AREAS TESTED BY AN ESTABLISHED SOIL TESTING LABORATORY. EACH SAMPLE SUBMITTED TO THE LAB SHALL CONTAIN NO LESS THAN ONE QUART OF SOIL, TAKEN FROM BETWEEN THE SOIL SURFACE AND 6" DEPTH. IF NO SAMPLE LOCATIONS ARE INDICATED ON THE PLANS, THE CONTRACTOR SHALL TAKE A MINIMUM OF THREE SAMPLES FROM VARIOUS REPRESENTATIVE LOCATIONS FOR TESTING.
    - b. THE CONTRACTOR SHALL HAVE THE SOIL TESTING LABORATORY PROVIDE RESULTS FOR THE FOLLOWING: SOIL TEXTURE CLASS, GENERAL SOIL FERTILITY, pH, ORGANIC MATTER CONTENT, SALT (EC), LIME, SODIUM ADSORPTION RATIO (SAR) AND BORON CONTENT.
    - c. THE CONTRACTOR SHALL ALSO SUBMIT THE PROJECT'S PLANT LIST TO THE LABORATORY ALONG WITH THE SOIL SAMPLES.
    - d. THE SOIL REPORT PRODUCED BY THE LABORATORY SHALL CONTAIN RECOMMENDATIONS FOR THE FOLLOWING (AS APPROPRIATE): SEPARATE SOIL PREPARATION AND BACKFILL MIX RECOMMENDATIONS FOR GENERAL ORNAMENTAL PLANTS, KERIC TURF, AND NATIVE SEEDS, AS WELL AS PRE-PLANT FERTILIZER APPLICATIONS AND RECOMMENDATIONS FOR ANY OTHER SOIL RELATED ISSUES. THE REPORT SHALL ALSO PROVIDE A FERTILIZER PROGRAM FOR THE ESTABLISHMENT PERIOD AND FOR LONG-TERM MAINTENANCE.
  3. THE CONTRACTOR SHALL INSTALL SOIL AMENDMENTS AND FERTILIZERS PER THE SOILS REPORT RECOMMENDATIONS, ANY CHANGE IN COST DUE TO THE SOIL REPORT RECOMMENDATIONS, EITHER INCREASE OR DECREASE, SHALL BE SUBMITTED TO THE OWNER WITH THE REPORT.
  4. FOR BIDDING PURPOSES ONLY, THE SOIL PREPARATION SHALL CONSIST OF THE FOLLOWING:
    - a. TURF: INCORPORATE THE FOLLOWING AMENDMENTS INTO THE TOP 6" OF SOIL BY MEANS OF ROTOTILLING AFTER CROSS-RIPPING:
      - i. NITROGEN STABILIZED ORGANIC AMENDMENT - 4 CU. YDS. PER 1,000 S.F.
      - ii. PREPLANT TURF FERTILIZER (10-20-10 OR SIMILAR, SLOW RELEASE, ORGANIC) - 15 LBS PER 1,000 S.F.
      - iii. "CLAY BUSTER" OR EQUAL - USE MANUFACTURER'S RECOMMENDED RATE.
    - b. TREES, SHRUBS, AND PERENNIALS: INCORPORATE THE FOLLOWING AMENDMENTS INTO THE TOP 6" OF SOIL BY MEANS OF ROTOTILLING AFTER CROSS-RIPPING:
      - i. NITROGEN STABILIZED ORGANIC AMENDMENT - 4 CU. YDS. PER 1,000 S.F.
      - ii. 12-12-12 FERTILIZER (OR SIMILAR, ORGANIC, SLOW RELEASE) - 10 LBS. PER CU. YD.
      - iii. "CLAY BUSTER" OR EQUAL - USE MANUFACTURER'S RECOMMENDED RATE.
      - iv. IRON SULPHATE - 2 LBS. PER CU. YD.
  5. IN THE CONTEXT OF THESE PLANS, NOTES, AND SPECIFICATIONS, "FINISH GRADE" REFERS TO THE FINAL ELEVATION OF THE SOIL SURFACE (NOT TOP OF MULCH) AS INDICATED ON THE GRADING PLANS.
    - a. BEFORE STARTING WORK, THE LANDSCAPE CONTRACTOR SHALL VERIFY THAT THE ROUGH GRADES OF ALL LANDSCAPE AREAS ARE WITHIN +0.1' OF FINISH GRADE. SEE SPECIFICATIONS FOR MORE DETAILED INSTRUCTION ON TURF AREA AND PLANTING BED PREPARATION.
    - b. CONSTRUCT AND MAINTAIN FINISH GRADES AS SHOWN ON GRADING PLANS, AND CONSTRUCT AND MAINTAIN SLOPES AS RECOMMENDED BY THE GEOTECHNICAL REPORT. ALL LANDSCAPE AREAS SHALL HAVE POSITIVE DRAINAGE AWAY FROM STRUCTURES AT THE MINIMUM SLOPE SPECIFIED IN THE REPORT AND ON THE GRADING PLANS, AND AREAS OF POTENTIAL PONDING SHALL BE REGRADED TO BLEND IN WITH THE SURROUNDING GRADES AND ELIMINATE PONDING POTENTIAL.
    - c. THE LANDSCAPE CONTRACTOR SHALL DETERMINE WHETHER OR NOT THE EXPORT OF ANY SOIL WILL BE NEEDED, TAKING INTO ACCOUNT THE ROUGH GRADE PROVIDED, THE AMOUNT OF SOIL AMENDMENTS TO BE ADDED (BASED ON A SOIL TEST, PER SPECIFICATIONS), AND THE FINISH GRADES TO BE ESTABLISHED.
    - d. ENSURE THAT THE FINISH GRADE IN SHRUB AREAS IMMEDIATELY ADJACENT TO WALKS AND OTHER WALKING SURFACES, AFTER INSTALLING SOIL AMENDMENTS, IS 3" BELOW THE ADJACENT FINISH SURFACE, IN ORDER TO ALLOW FOR PROPER MULCH DEPTH. TAPER THE SOIL SURFACE TO MEET FINISH GRADE, AS SPECIFIED ON THE GRADING PLANS, AT APPROXIMATELY 18" AWAY FROM THE WALKS.
    - e. ENSURE THAT THE FINISH GRADE IN TURF AREAS IMMEDIATELY ADJACENT TO WALKS AND OTHER WALKING SURFACES, AFTER INSTALLING SOIL AMENDMENTS, IS 1" BELOW THE FINISH SURFACE OF THE WALKS. TAPER THE SOIL SURFACE TO MEET FINISH GRADE, AS SPECIFIED ON THE GRADING PLANS, AT APPROXIMATELY 18" AWAY FROM THE WALKS.
    - f. SHOULD ANY CONFLICTS AND/OR DISCREPANCIES ARISE BETWEEN THE GRADING PLANS, GEOTECHNICAL REPORT, THESE NOTES AND PLANS, AND ACTUAL CONDITIONS, THE CONTRACTOR SHALL IMMEDIATELY BRING SUCH ITEMS TO THE ATTENTION OF THE LANDSCAPE ARCHITECT, GENERAL CONTRACTOR, AND OWNER.
    6. ONCE SOIL PREPARATION IS COMPLETE, THE LANDSCAPE CONTRACTOR SHALL ENSURE THAT THERE ARE NO DEBRIS, TRASH, OR STONES LARGER THAN 1" REMAINING IN THE TOP 6" OF SOIL.

- B. SUBMITTALS**
1. THE CONTRACTOR SHALL PROVIDE SUBMITTALS AND SAMPLES, IF REQUIRED, TO THE LANDSCAPE ARCHITECT, AND RECEIVE APPROVAL IN WRITING FOR SUCH SUBMITTALS BEFORE WORK COMMENCES.
  2. SUBMITTALS SHALL INCLUDE PHOTOS OF PLANTS WITH A RULER OR MEASURING STICK FOR SCALE. PHOTOS OR SAMPLES OF ANY REQUIRED MULCHES, AND SOIL TEST RESULTS AND PREPARATION RECOMMENDATIONS FROM THE TESTING LAB (INCLUDING COMPOST AND FERTILIZER RATES AND TYPES), AND OTHER AMENDMENTS FOR TREE/SHRUB, TURF, AND SEED AREAS AS MAY BE APPROPRIATE.
  3. SUBMITTALS SHALL ALSO INCLUDE MANUFACTURER CUT SHEETS FOR PLANTING ACCESSORIES SUCH AS TREE STAKES AND TIES, EDGING, AND LANDSCAPE FABRICS (IF ANY).
  4. WHERE MULTIPLE ITEMS ARE SHOWN ON A PAGE, THE CONTRACTOR SHALL CLEARLY INDICATE THE ITEM BEING CONSIDERED.
- C. GENERAL PLANTING**
1. REMOVE ALL NURSERY TAGS AND STAKES FROM PLANTS.
  2. EXCEPT IN AREAS TO BE PLANTED WITH ORNAMENTAL GRASSES, APPLY PRE-EMERGENT HERBICIDES AT THE MANUFACTURER'S RECOMMENDED RATE.
  3. TRENCHING NEAR EXISTING TREES:
    - a. CONTRACTOR SHALL NOT DISTURB ROOTS 1-1/2" AND LARGER IN DIAMETER WITHIN THE CRITICAL ROOT ZONE (CRZ) OF EXISTING TREES, AND SHALL EXERCISE ALL POSSIBLE CARE AND PRECAUTIONS TO AVOID INJURY TO TREE ROOTS, TRUNKS, AND BRANCHES. THE CRZ IS DEFINED AS A CIRCULAR AREA EXTENDING OUTWARD FROM THE TREE TRUNK, WITH A RADIUS EQUAL TO 1" FOR EVERY 1" OF TRUNK DIAMETER-AT-BREAST-HEIGHT (4.5 ABOVE THE AVERAGE GRADE AT THE TRUNK).
    - b. ALL EXCAVATION WITHIN THE CRZ SHALL BE PERFORMED USING HAND TOOLS. NO MACHINE EXCAVATION OR TRENCHING OF ANY KIND SHALL BE ALLOWED WITHIN THE CRZ.
    - c. ALTER ALIGNMENT OF PIPE TO AVOID TREE ROOTS 1-1/2" AND LARGER IN DIAMETER. WHERE TREE ROOTS 1-1/2" AND LARGER IN DIAMETER ARE ENCOUNTERED IN THE FIELD, TUNNEL UNDER SUCH ROOTS. WRAP EXPOSED ROOTS WITH SEVERAL LAYERS OF BURLAP AND KEEP MOIST. CLOSE ALL TRENCHES WITHIN THE CANOPY DRIP LINES WITHIN 24 HOURS.
    - d. ALL SEVERED ROOTS SHALL BE HAND PRUNED WITH SHARP TOOLS AND ALLOWED TO AIR-DRY. DO NOT USE ANY SORT OF SEALERS OR WOUND PAYS.

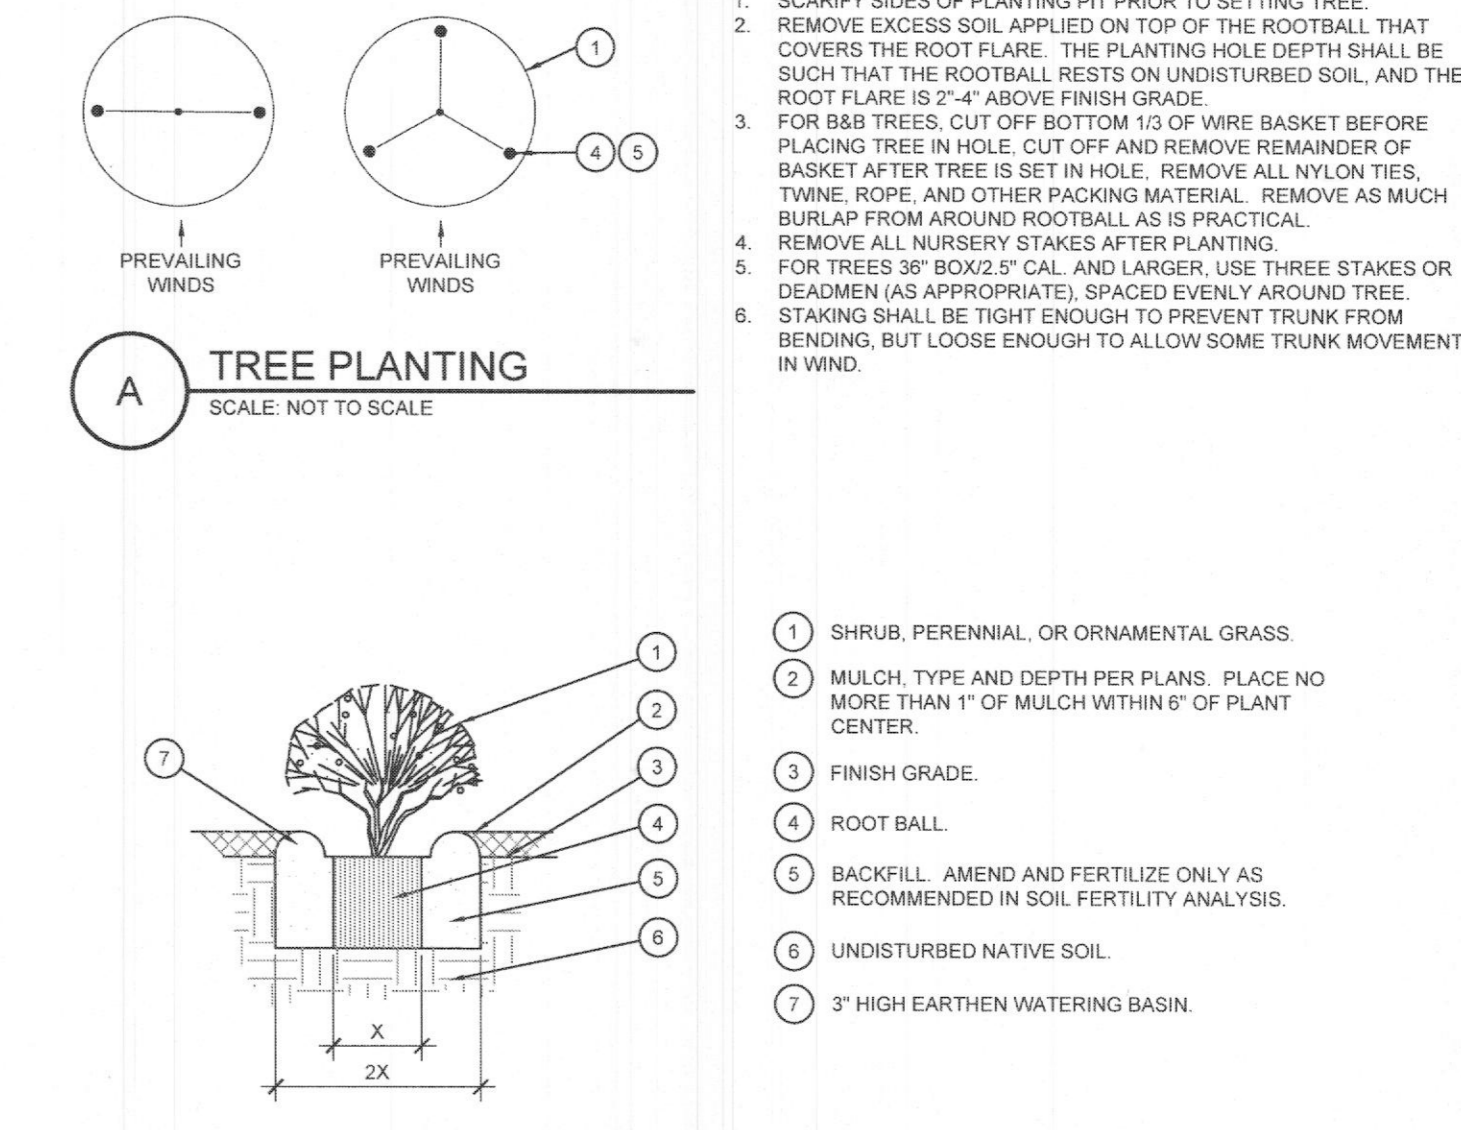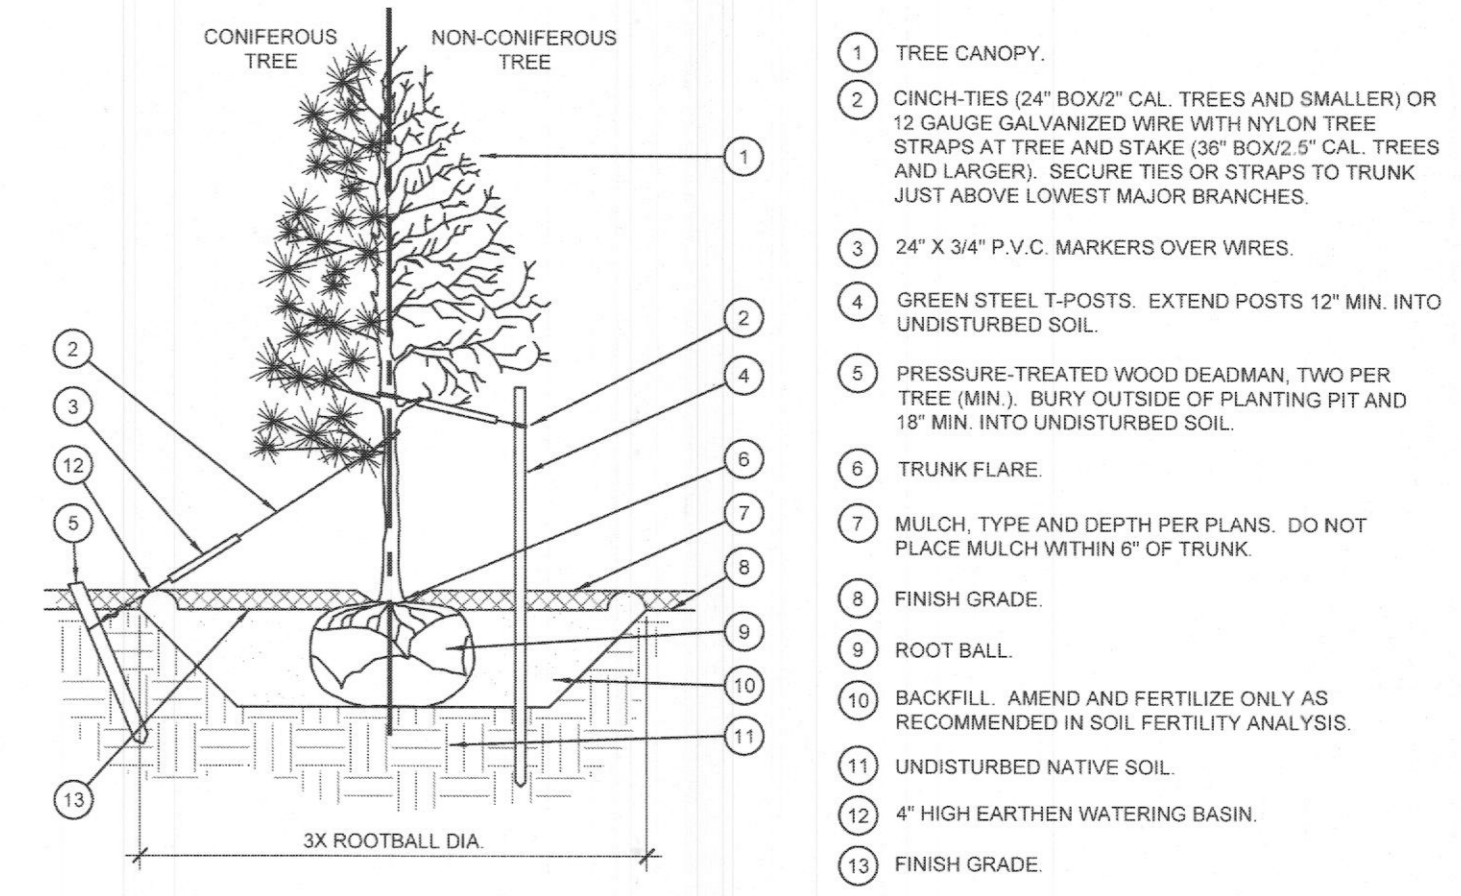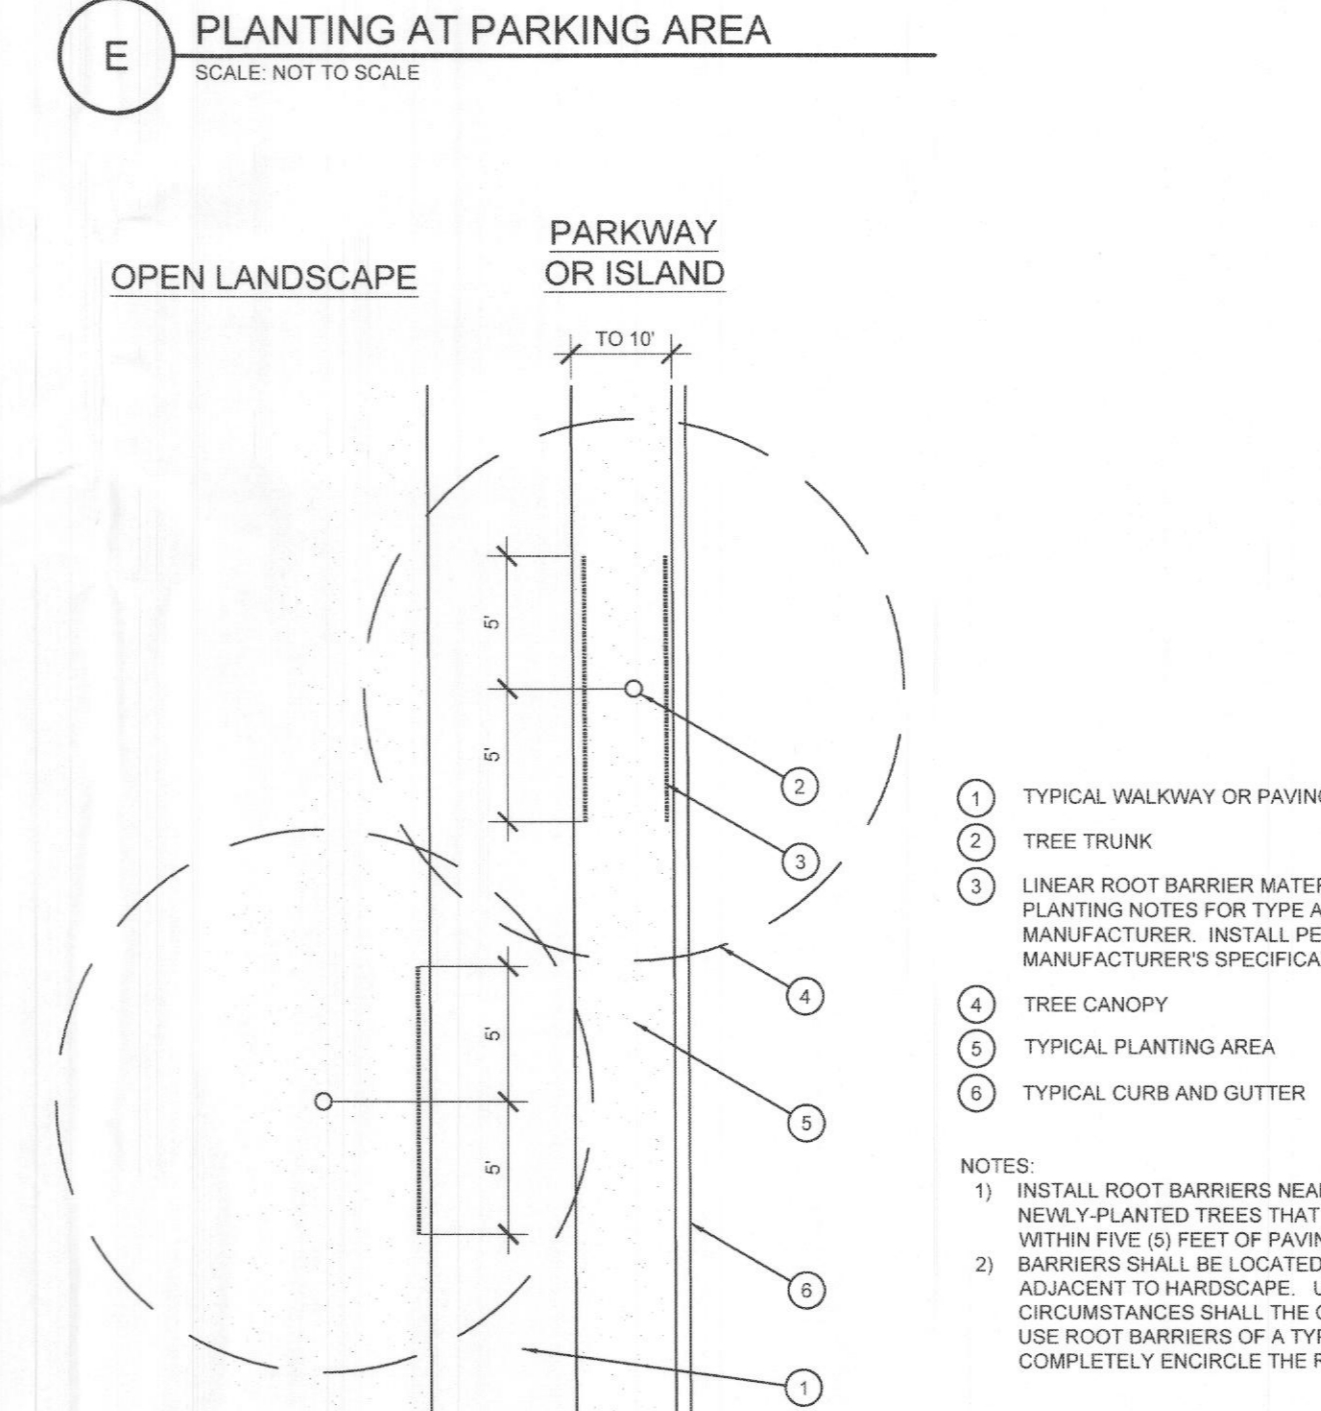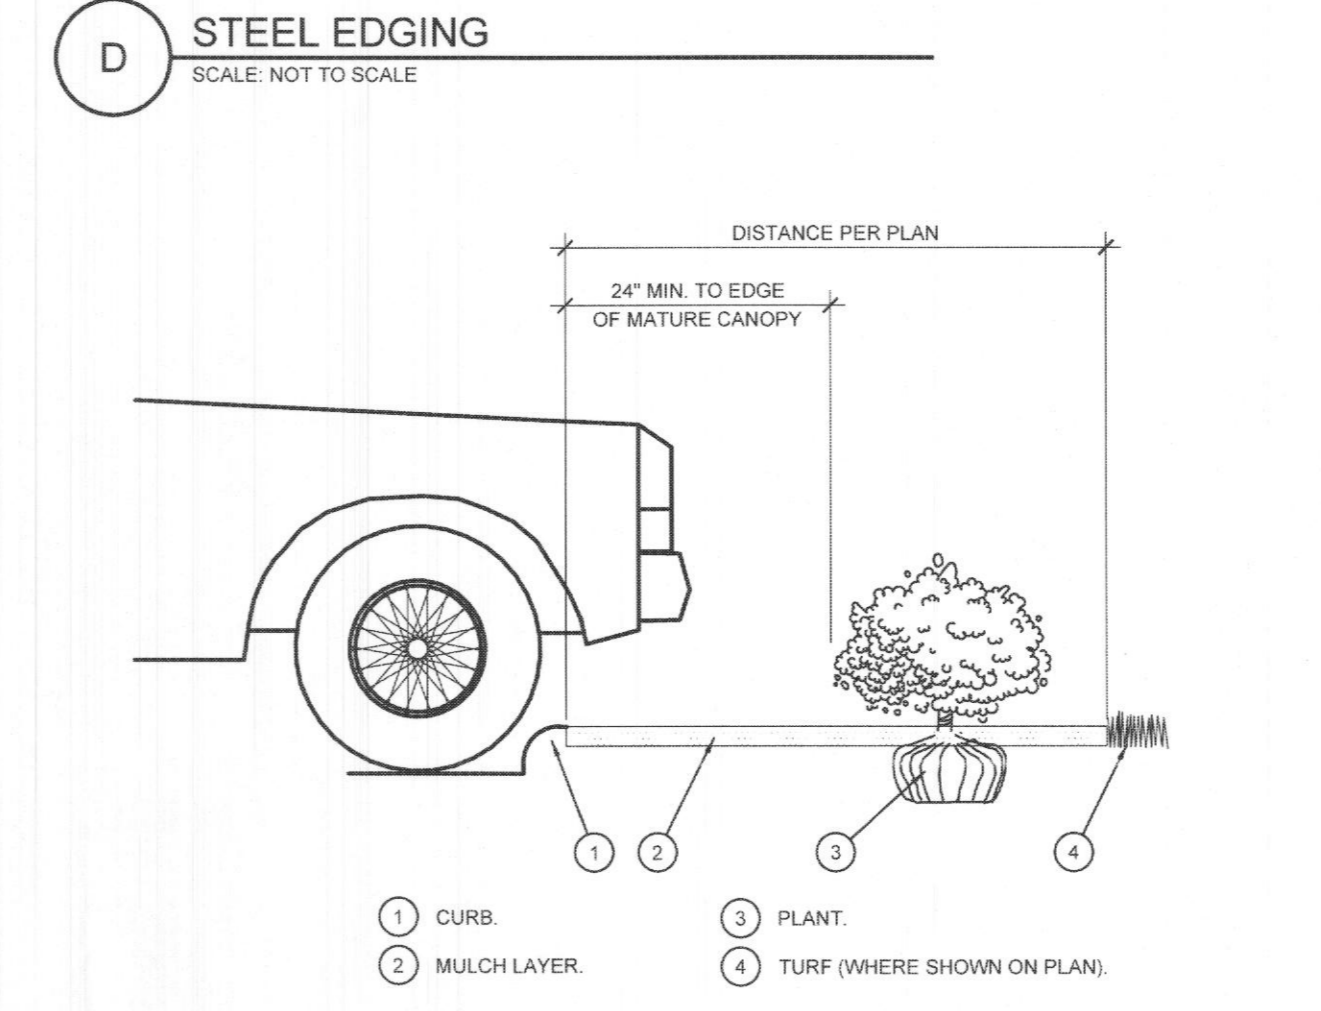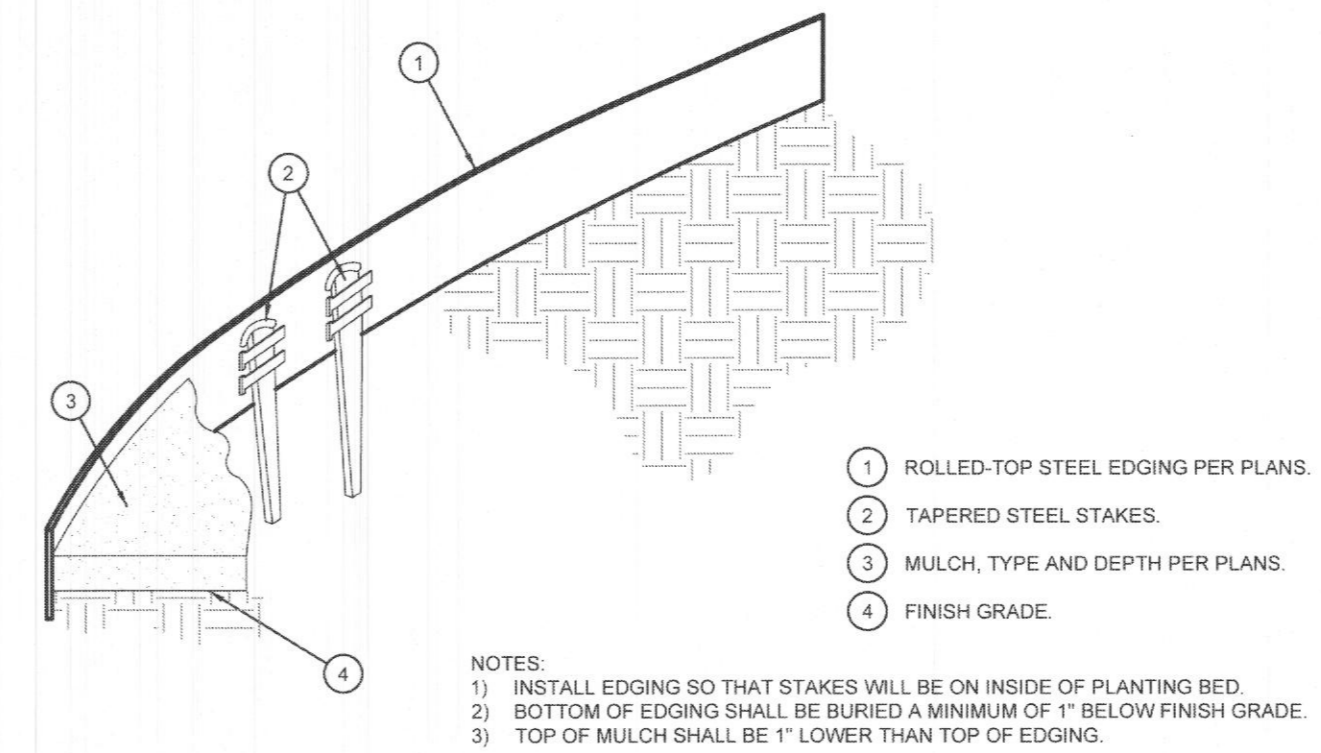

**EVERGREEN DESIGN GROUP**

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Addison, TX 75001  
www.EvergreenDesignGroup.com

REGISTERED LANDSCAPE ARCHITECT  
STATE OF TEXAS  
3423

05/11/2021

Project Name

**Rockwall Rotary Foundation**  
408 S. Goliad Street  
Rockwall, TX 75086

**Rockwall Rotary Foundation**  
408 S. Goliad Street  
Rockwall, TX 75086

Landscape Planting  
Details & Specs.

Date	Comment

Project Number: SP2021-013  
Date: 05/05/2021  
Drawn By: DB  
Checked By: DB/RM

**LP-2**

SITE PLAN SIGNATURE BLOCK

APPROVED:

I hereby certify that the above and foregoing site plan for a development in the City of Rockwall, Texas, was approved by the Planning & Zoning Commission of the City of Rockwall on the 11 day of May, 2021.

WITNESS OUR HANDS, this 11 day of May, 2021.

Planning & Zoning Commission, Chairman

Director of Planning and Zoning

**GENERAL GRADING AND PLANTING NOTES**

- BY SUBMITTING A PROPOSAL FOR THE LANDSCAPE PLANTING SCOPE OF WORK, THE CONTRACTOR CONFIRMS THAT HE HAS READ, AND WILL COMPLY WITH, THE ASSOCIATED NOTES, SPECIFICATIONS, AND DETAILS WITH THIS PROJECT.
- THE GENERAL CONTRACTOR IS RESPONSIBLE FOR REMOVING ALL EXISTING VEGETATION (EXCEPT WHERE NOTED TO REMAIN) IN THE CONTEXT OF THESE PLANS, NOTES, AND SPECIFICATIONS. "FINISH GRADE" REFERS TO THE FINAL ELEVATION OF THE SOIL SURFACE (NOT TOP OF MULCH) AS INDICATED ON THE GRADING PLANS.
- BEFORE STARTING WORK, THE LANDSCAPE CONTRACTOR SHALL VERIFY THAT THE ROUGH GRADES OF ALL LANDSCAPE AREAS ARE WITHIN +0.1' OF FINISH GRADE. SEE SPECIFICATIONS FOR MORE DETAILED INSTRUCTION ON TURF AREA AND PLANTING BED PREPARATION.
- CONSTRUCT AND MAINTAIN FINISH GRADES AS SHOWN ON GRADING PLANS, AND CONSTRUCT AND MAINTAIN SLOPES AS RECOMMENDED BY THE GEOTECHNICAL REPORT. ALL LANDSCAPE AREAS SHALL HAVE POSITIVE DRAINAGE AWAY FROM STRUCTURES AT THE MINIMUM SLOPE SPECIFIED IN THE REPORT AND ON THE GRADING PLANS, AND AREAS OF POTENTIAL PONDING SHALL BE REGRADED TO BLEND IN WITH THE SURROUNDING GRADES AND ELIMINATE PONDING POTENTIAL.
- THE LANDSCAPE CONTRACTOR SHALL DETERMINE WHETHER OR NOT THE EXPORT OF ANY SOIL WILL BE NEEDED, TAKING INTO ACCOUNT THE ROUGH GRADE PROVIDED, THE AMOUNT OF SOIL AMENDMENTS

- TO BE ADDED (BASED ON A SOIL TEST, PER SPECIFICATIONS), AND THE FINISH GRADES TO BE ESTABLISHED.
- ENSURE THAT THE FINISH GRADE IN SHRUB AREAS IMMEDIATELY ADJACENT TO WALKS AND OTHER WALKING SURFACES, AFTER INSTALLING SOIL AMENDMENTS, IS 3" BELOW THE ADJACENT FINISH GRADE. IN ORDER TO ALLOW FOR PROPER MULCH DEPTH, TAPER THE SOIL SURFACE TO MEET FINISH GRADE, AS SPECIFIED ON THE GRADING PLANS, AT APPROXIMATELY 18" AWAY FROM THE WALKS.
- ENSURE THAT THE FINISH GRADE IN TURF AREAS IMMEDIATELY ADJACENT TO WALKS AND OTHER WALKING SURFACES, AFTER INSTALLING SOIL AMENDMENTS, IS 1" BELOW THE FINISH GRADE OF THE WALKS. TAPER THE SOIL SURFACE TO MEET FINISH GRADE, AS SPECIFIED ON THE GRADING PLANS, AT APPROXIMATELY 18" AWAY FROM THE WALKS.
- SHOULD ANY CONFLICTS AND/OR DISCREPANCIES ARISE BETWEEN THE GRADING PLANS, GEOTECHNICAL REPORT, THESE NOTES AND PLANS, AND ACTUAL CONDITIONS, THE CONTRACTOR SHALL IMMEDIATELY BRING SUCH ITEMS TO THE ATTENTION OF THE LANDSCAPE ARCHITECT, GENERAL CONTRACTOR, AND OWNER. VERIFIED WITH THE LANDSCAPE ARCHITECT OR DESIGNER PRIOR TO PLANTING. THE LANDSCAPE CONTRACTOR SHALL ENSURE THAT ALL REQUIREMENTS OF THE PERMITTING AUTHORITY ARE MET (I.E. MINIMUM PLANT QUANTITIES, PLANTING METHODS, TREE PROTECTION METHODS, ETC.)

- THE LANDSCAPE CONTRACTOR IS RESPONSIBLE FOR DETERMINING PLANT QUANTITIES. PLANT QUANTITIES SHOWN ON LEGENDS AND CALLOUTS ARE FOR GENERAL INFORMATION ONLY. IN THE EVENT OF A DISCREPANCY BETWEEN THE PLAN AND THE PLANT LEGEND, THE PLANT QUANTITY AS SHOWN ON THE PLAN (FOR INDIVIDUAL SYMBOLS) OR CALLOUT (FOR GROUNDCOVER PATTERNS) SHALL TAKE PRECEDENCE.
- NO SUBSTITUTIONS OF PLANT MATERIALS SHALL BE ALLOWED WITHOUT THE WRITTEN PERMISSION OF THE LANDSCAPE ARCHITECT. IF SOME OF THE PLANTS ARE NOT AVAILABLE, THE LANDSCAPE CONTRACTOR SHALL NOTIFY THE LANDSCAPE ARCHITECT IN WRITING (VIA PROPER CHANNELS).
- THE CONTRACTOR SHALL, AT A MINIMUM, PROVIDE REPRESENTATIVE PHOTOS OF ALL PLANTS PROPOSED FOR THE PROJECT. THE CONTRACTOR SHALL ALLOW THE LANDSCAPE ARCHITECT AND THE OWNER/OWNER'S REPRESENTATIVE TO INSPECT AND APPROVE OR REJECT ALL PLANTS DELIVERED TO THE JOBSITE. REFER TO SPECIFICATIONS FOR ADDITIONAL REQUIREMENTS FOR SUBMITTALS.
- THE CONTRACTOR SHALL MAINTAIN THE LANDSCAPE IN A HEALTHY CONDITION FOR 90 DAYS AFTER ACCEPTANCE BY THE OWNER. REFER TO SPECIFICATIONS FOR CONDITIONS OF ACCEPTANCE FOR THE START OF THE MAINTENANCE PERIOD, AND FOR FINAL ACCEPTANCE AT THE END OF THE MAINTENANCE PERIOD.
- SEE SPECIFICATIONS AND DETAILS FOR FURTHER REQUIREMENTS.


**PLANTING LEGEND**

SYMBOL	BOTANIC NAME	COMMON NAME	MIN. SIZE	QUANTITY	REMARKS
<b>TREES</b>					
ACRU	ACER RUBRUM 'OCTOBER GLORY'	OCTOBER GLORY MAPLE	4" cal., 14' high	4	CANOPY TREE
CECA	CERCIS CANADENSIS	EASTERN REDBUD	2" cal., 6'-8' high	7	ACCENT TREE
QUVI	QUERCUS VIRGINIANA	LIVE OAK	4" cal., 14' high	4	CANOPY TREE
<b>SHRUBS</b>					
BETH	BERBERIS THUN. 'CRIMSON PYGMY'	CRIMSON PYGMY BARBERRY	5 gallon	13	
HEPA	HESPERALOE PARVIFLORA	RED YUCCA	5 gallon	25	
ILCO	ILEX CORNUTA 'BURFORDII NANA'	DWARF BURFORD HOLLY	5 gallon	23	
JUCO	JUNIPERUS CONFERTA 'PACIFIC BLUE'	PACIFIC BLUE SHORE JUNIPER	5 gallon	29	
LOPE	LOROPETALUM CHINENSE 'RUBRUM'	CHINESE FRINGEFLOWER	5 gallon	9	
<b>TURF AND SEED</b>					
[Symbol]	Cynodon 'Tifway 419'	Tifway Hybrid Bermuda Grass	Sod	---	
[Symbol]	2"-4" Texas River Cobble, 3" Deep, Lay over permeable landscape fabric				

NOTE: ALL TREES SHALL BE CONTAINER-GROWN, CONTAINER SIZE AS APPROPRIATE FOR THE CALIPER SPECIFIED. SEE SPECS. FOR PROPER ROOT QUALITY.

NOTE: THE DEVELOPER SHALL ESTABLISH GRASS AND MAINTAIN THE SODDED AREA, INCLUDING WATERING, UNTIL A PERMANENT STAND OF GRASS IS OBTAINED AT WHICH TIME THE PROJECT WILL BE ACCEPTED BY THE CITY. A STAND OF GRASS SHALL CONSIST OF 75%-80% COVERAGE AND A MINIMUM OF 1" IN HEIGHT AS DETERMINED BY THE CITY.

ROCCA VILLA (BENT CREEK CONDO) UNIT 101, BUILDING 1 101 LAKE MEADOWS DR ZONING: MF-14

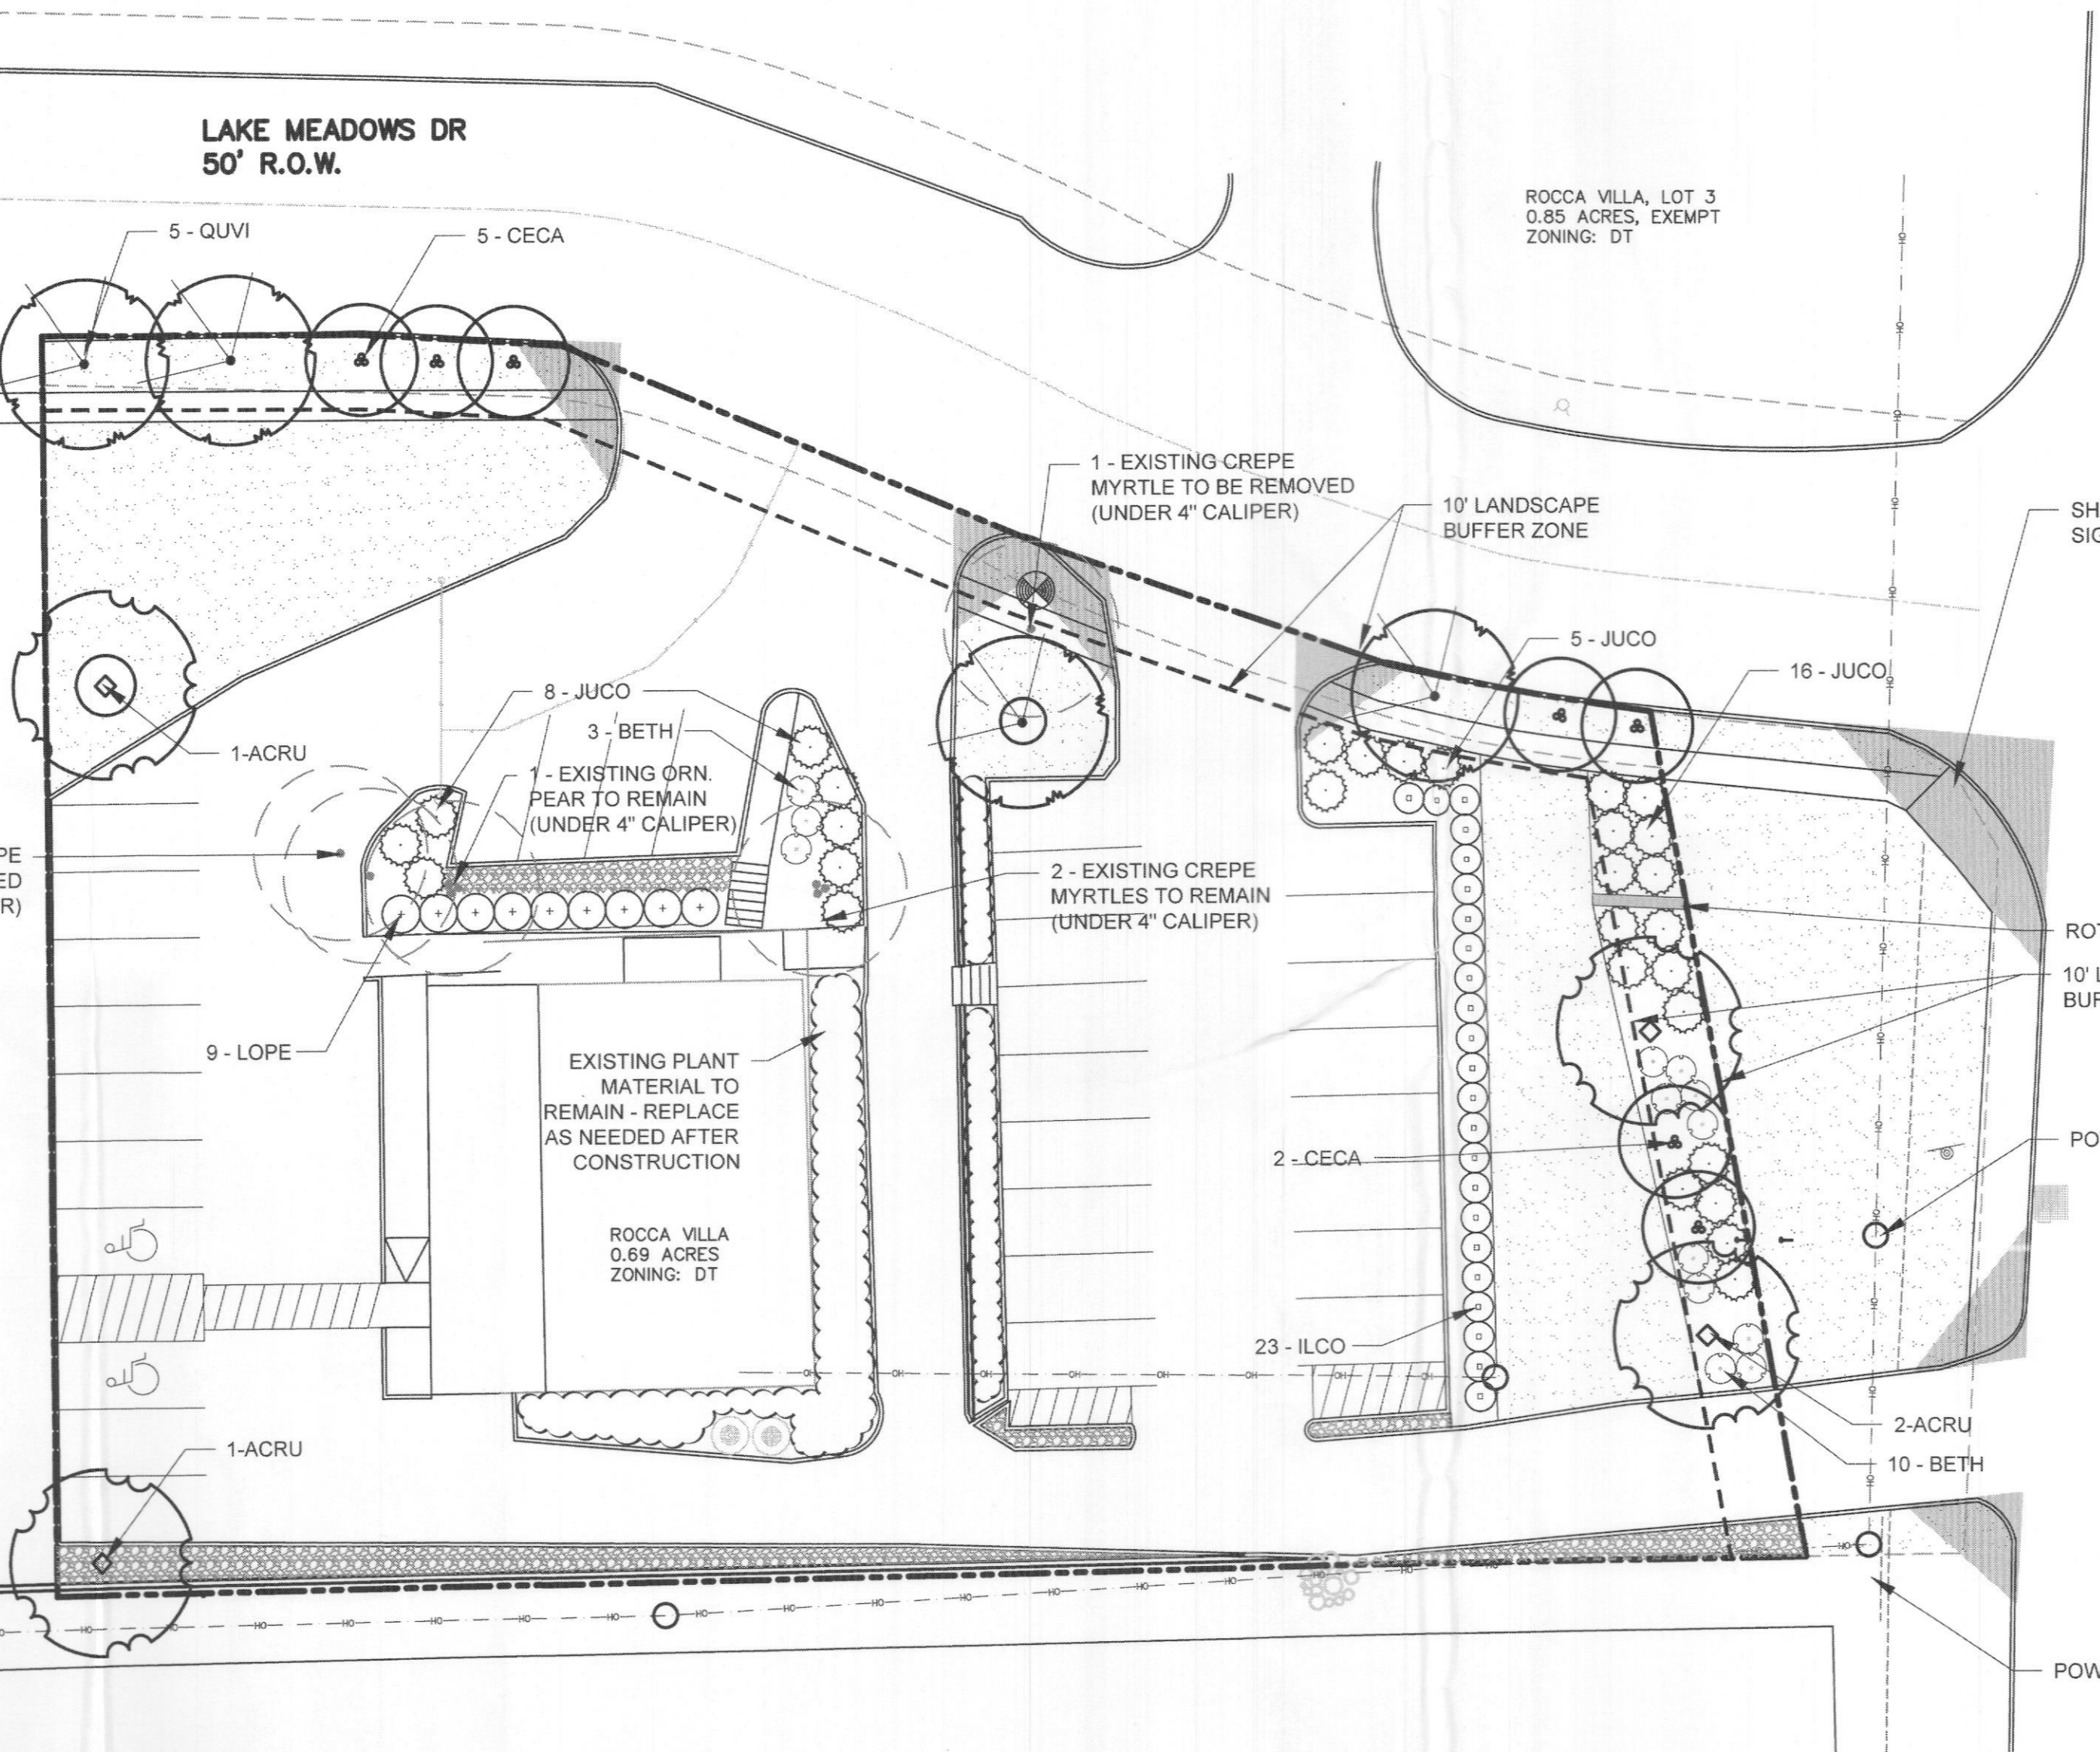

ROCCA VILLA (BENT CREEK CONDO) UNIT 102, BUILDING 1 102 LAKE MEADOWS DR ZONING: MF-14

ROCCA VILLA, LOT 3 0.85 ACRES, EXEMPT ZONING: DT

ROCCA VILLA 0.69 ACRES ZONING: DT

KENWAY HILL ADDITION BLOCK A, LOT 1, 0.8161 ACRES ZONING: GR


**LANDSCAPE STANDARDS**

- 05.01 LANDSCAPE BUFFERS - NON-RESIDENTIAL**  
REQ. ABUTTING A PUBLIC RIGHT-OF-WAY:  
10' WIDE LANDSCAPE BUFFER W/ GROUND COVER, BERM, AND SHRUBBERY 30" HIGH + 1 CANOPY TREE & 1 ACCENT TREE PER 50 LIN. FEET OF FRONTAGE  
2 CANOPY TREES, 2 ACCENT TREES REQUIRED  
2 MAPLE (CANOPY), 2 REDBUD (ACCENT) PROVIDED
- S. GOLIAD ST. - ±116' STREET FRONTAGE:**  
LAKE MEADOWS DR. ±225' STREET FRONTAGE:  
5 CANOPY TREES, 5 ACCENT TREES REQUIRED  
4 LIVE OAK (CANOPY), 5 REDBUD (ACCENT) PROVIDED UNABLE TO MEET CANOPY REQ. DUE TO SITE CONSTRAINTS
- 05.02 LANDSCAPE SCREENING**  
REQ. HEADLIGHT SCREENING  
PROVIDED SCREENING  
HEAD-IN PARKING ADJ. TO STREET SHALL INCORP. MIN. 2' BERM W/ MATURE EVERGREEN SHRUBS ALONG ENTIRE PARKING AREAS  
HOLLY SHRUBS PLANTED ALONG PARKING SPACES

- 05.03 LANDSCAPE REQUIREMENTS - COMMERCIAL (C) DISTRICT**  
TOTAL SITE AREA: ±35,301 SF  
LANDSCAPE AREA REQUIRED, TOTAL SITE: ±7,060 SF (20%)  
LANDSCAPE PROVIDED, TOTAL SITE: ±10,769 SF (30%)
- LOCATION OF LANDSCAPING:**  
MIN. 50% OF REQ. LANDSCAPING SHALL BE LOCATED IN THE FRONT OF & ALONG THE SIDE OF BUILDINGS W/ STREET FRONTAGE.
- MIN. SIZE OF AREAS**  
ALL REQ. LANDSCAPING SHALL BE NO LESS THAN 5' WIDE AND A MIN. OF 25 SF IN AREA
- DETENTION BASINS**  
NONE PROPOSED
- PARKING LOT LANDSCAPING**  
MIN. 5% OR 200 SF OF LANDSCAPING, WHICHEVER IS GREATER, IN THE INTERIOR OF THE PARKING LOT AREA.
- PROPOSED PARKING AREA:**  
REQ. PARKING LOT LANDSCAPING: ±11,824 SF  
PROPOSED PARKING LOT LANDSCAPING: ±591 SF  
±750 SF (6.3%)  
REQ. PARKING SPACES MUST BE WITHIN 80' OF A CANOPY TREE TRUNK

**IRRIGATION CONCEPT**

- AN AUTOMATIC IRRIGATION SYSTEM SHALL BE INSTALLED AND OPERATIONAL BY THE TIME OF FINAL INSPECTION. THE ENTIRE IRRIGATION SYSTEM SHALL BE INSTALLED BY A LICENSED AND QUALIFIED IRRIGATION CONTRACTOR.
- THE IRRIGATION SYSTEM WILL OPERATE ON POTABLE WATER, AND THE SYSTEM WILL HAVE APPROPRIATE BACKFLOW PREVENTION DEVICES INSTALLED TO PREVENT CONTAMINATION OF THE POTABLE SOURCE.
- ALL NON-TURF PLANTED AREAS SHALL BE DRIP IRRIGATED. SODDED AND SEEDDED AREAS SHALL BE IRRIGATED WITH SPRAY OR ROTOR HEADS AT 100% HEAD-TO-HEAD COVERAGE.
- ALL PLANTS SHARING SIMILAR HYDROZONE CHARACTERISTICS SHALL BE PLACED ON A VALVE DEDICATED TO PROVIDE THE NECESSARY WATER REQUIREMENTS SPECIFIC TO THAT HYDROZONE.
- THE IRRIGATION SYSTEM SHALL BE DESIGNED AND INSTALLED, TO THE MAXIMUM EXTENT POSSIBLE, TO CONSERVE WATER BY USING THE FOLLOWING DEVICES AND SYSTEMS: MATCHED PRECIPITATION RATE TECHNOLOGY ON ROTOR AND SPRAY HEADS (WHEREVER POSSIBLE), RAIN SENSORS, AND MULTI-PROGRAM COMPUTERIZED IRRIGATION CONTROLLERS FEATURING SENSORY INPUT CAPABILITIES.

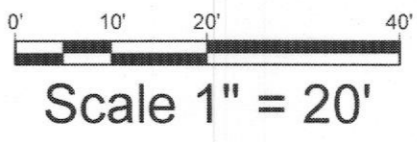

**ROOT BARRIERS**

THE CONTRACTOR SHALL INSTALL ROOT BARRIERS NEAR ALL NEWLY-PLANTED TREES THAT ARE LOCATED WITHIN FIVE (5) FEET OF PAVING OR CURBS. ROOT BARRIERS SHALL BE "CENTURY" OR "DEEP ROOT" 24" DEEP PANELS (OR EQUAL). BARRIERS SHALL BE LOCATED IMMEDIATELY ADJACENT TO HARDSCAPE. INSTALL PANELS PER MANUFACTURER'S RECOMMENDATIONS. UNDER NO CIRCUMSTANCES SHALL THE CONTRACTOR USE ROOT BARRIERS OF A TYPE THAT COMPLETELY ENCIRCLE THE ROOTBALL.

**MULCHES**

AFTER ALL PLANTING IS COMPLETE, CONTRACTOR SHALL INSTALL 3" THICK LAYER OF 1-1/2" SHREDDED WOOD MULCH, NATURAL (UNDYED), IN ALL PLANTING AREAS (EXCEPT FOR TURF AND SEEDDED AREAS). CONTRACTOR SHALL SUBMIT SAMPLES OF ALL MULCHES TO LANDSCAPE ARCHITECT AND OWNER FOR APPROVAL PRIOR TO CONSTRUCTION. ABSOLUTELY NO EXPOSED GROUND SHALL BE LEFT SHOWING ANYWHERE ON THE PROJECT AFTER MULCH HAS BEEN INSTALLED (SUBJECT TO THE CONDITIONS AND REQUIREMENTS OF THE "GENERAL GRADING AND PLANTING NOTES" AND SPECIFICATIONS).


**SITE PLAN SIGNATURE BLOCK**

APPROVED:  
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WITNESS OUR HANDS, this 11 day of May, 2021.

*[Signature]*  
Planning & Zoning Commission, Chairman

*[Signature]*  
Director of Planning and Zoning

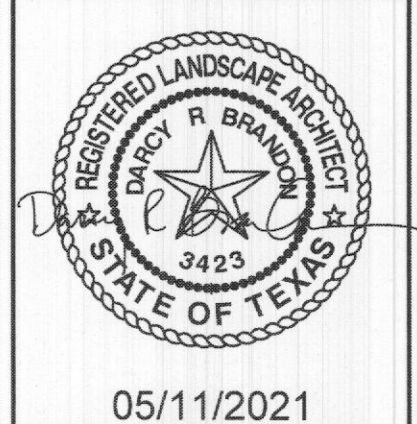

Owner  
Rockwall Rotary Foundation  
408 S. Goliad Street  
Rockwall, TX 75086

Project Name  
Rockwall Rotary Foundation  
408 S. Goliad Street  
Rockwall, TX 75086

**Landscape Planting Plan**

Date	Comment

Project Number: SP2021-013  
Date: 05/05/2021  
Drawn By: DB  
Checked By: DB/RM

**LP-1**


**SITE DATA TABLE**

<b>EXISTING ZONING</b>	DT
<b>PROPOSED USE</b>	COMMERCIAL
<b>SITE AREA</b>	0.69 ACRES
<b>BUILDING AREA</b>	
EXISTING BUILDING	2,123 SF
ADDITION	831 SF
PROPOSED BUILDING	2,954 SF
<b>PARKING</b>	
PARKING REQUIRED	1/200 SF
	15 STANDARD STALLS
	1 ACCESSIBLE STALLS
PARKING PROVIDED	29 STANDARD SPACES
	2 ACCESSIBLE SPACES

NOTE: PROPERTY IS CURRENTLY PLATTED

**EXTERIOR LIGHTING SCHEDULE**

FIXTURE TAG	DESCRIPTION:	MANUFACTURER	MODEL NUMBER	LAMPING TYPE		NO.	VOLTAGE	MOUNTING	FINISH	NOTES:
				W	L					
WP3 (WP3E)	LED Exterior Wall Pack	HE Williams	VWPH-L30-740-T3-BLK-CGL-DIM-UNV WP3E = "EM/10W/C"	36W	3327L	1	120V	Surface (Wall)	Black	Wet Listed, Mtd @ 7.5' AFF
WFF	LED Exterior Wall Pack	HE Williams	VWPH-L60-740-TFT-BLK-CGL-DIM-UNV	69W	5688L	1	120V	Surface (Wall)	Black	Wet Listed, Mtd @ 14' AFF U/C/N
WS (WSE)	LED Exterior Wall Sconce	Bega	66516 WSE-PROVIDE 90 MIN EM INVERTER	21W	1047L	1	120V	Surface (Wall)	Black	Wet Listed, Mtd @ 6' AFF
S1	LED Pole Light	Lithonia	DSX1 LED P1 40K 1FTM MVOLT NLTAIR2 HS SSS20-4C-DM19-DBLXD	54W	6963L	1	120V	Pole	Black	MOUNT AT 20' AFF

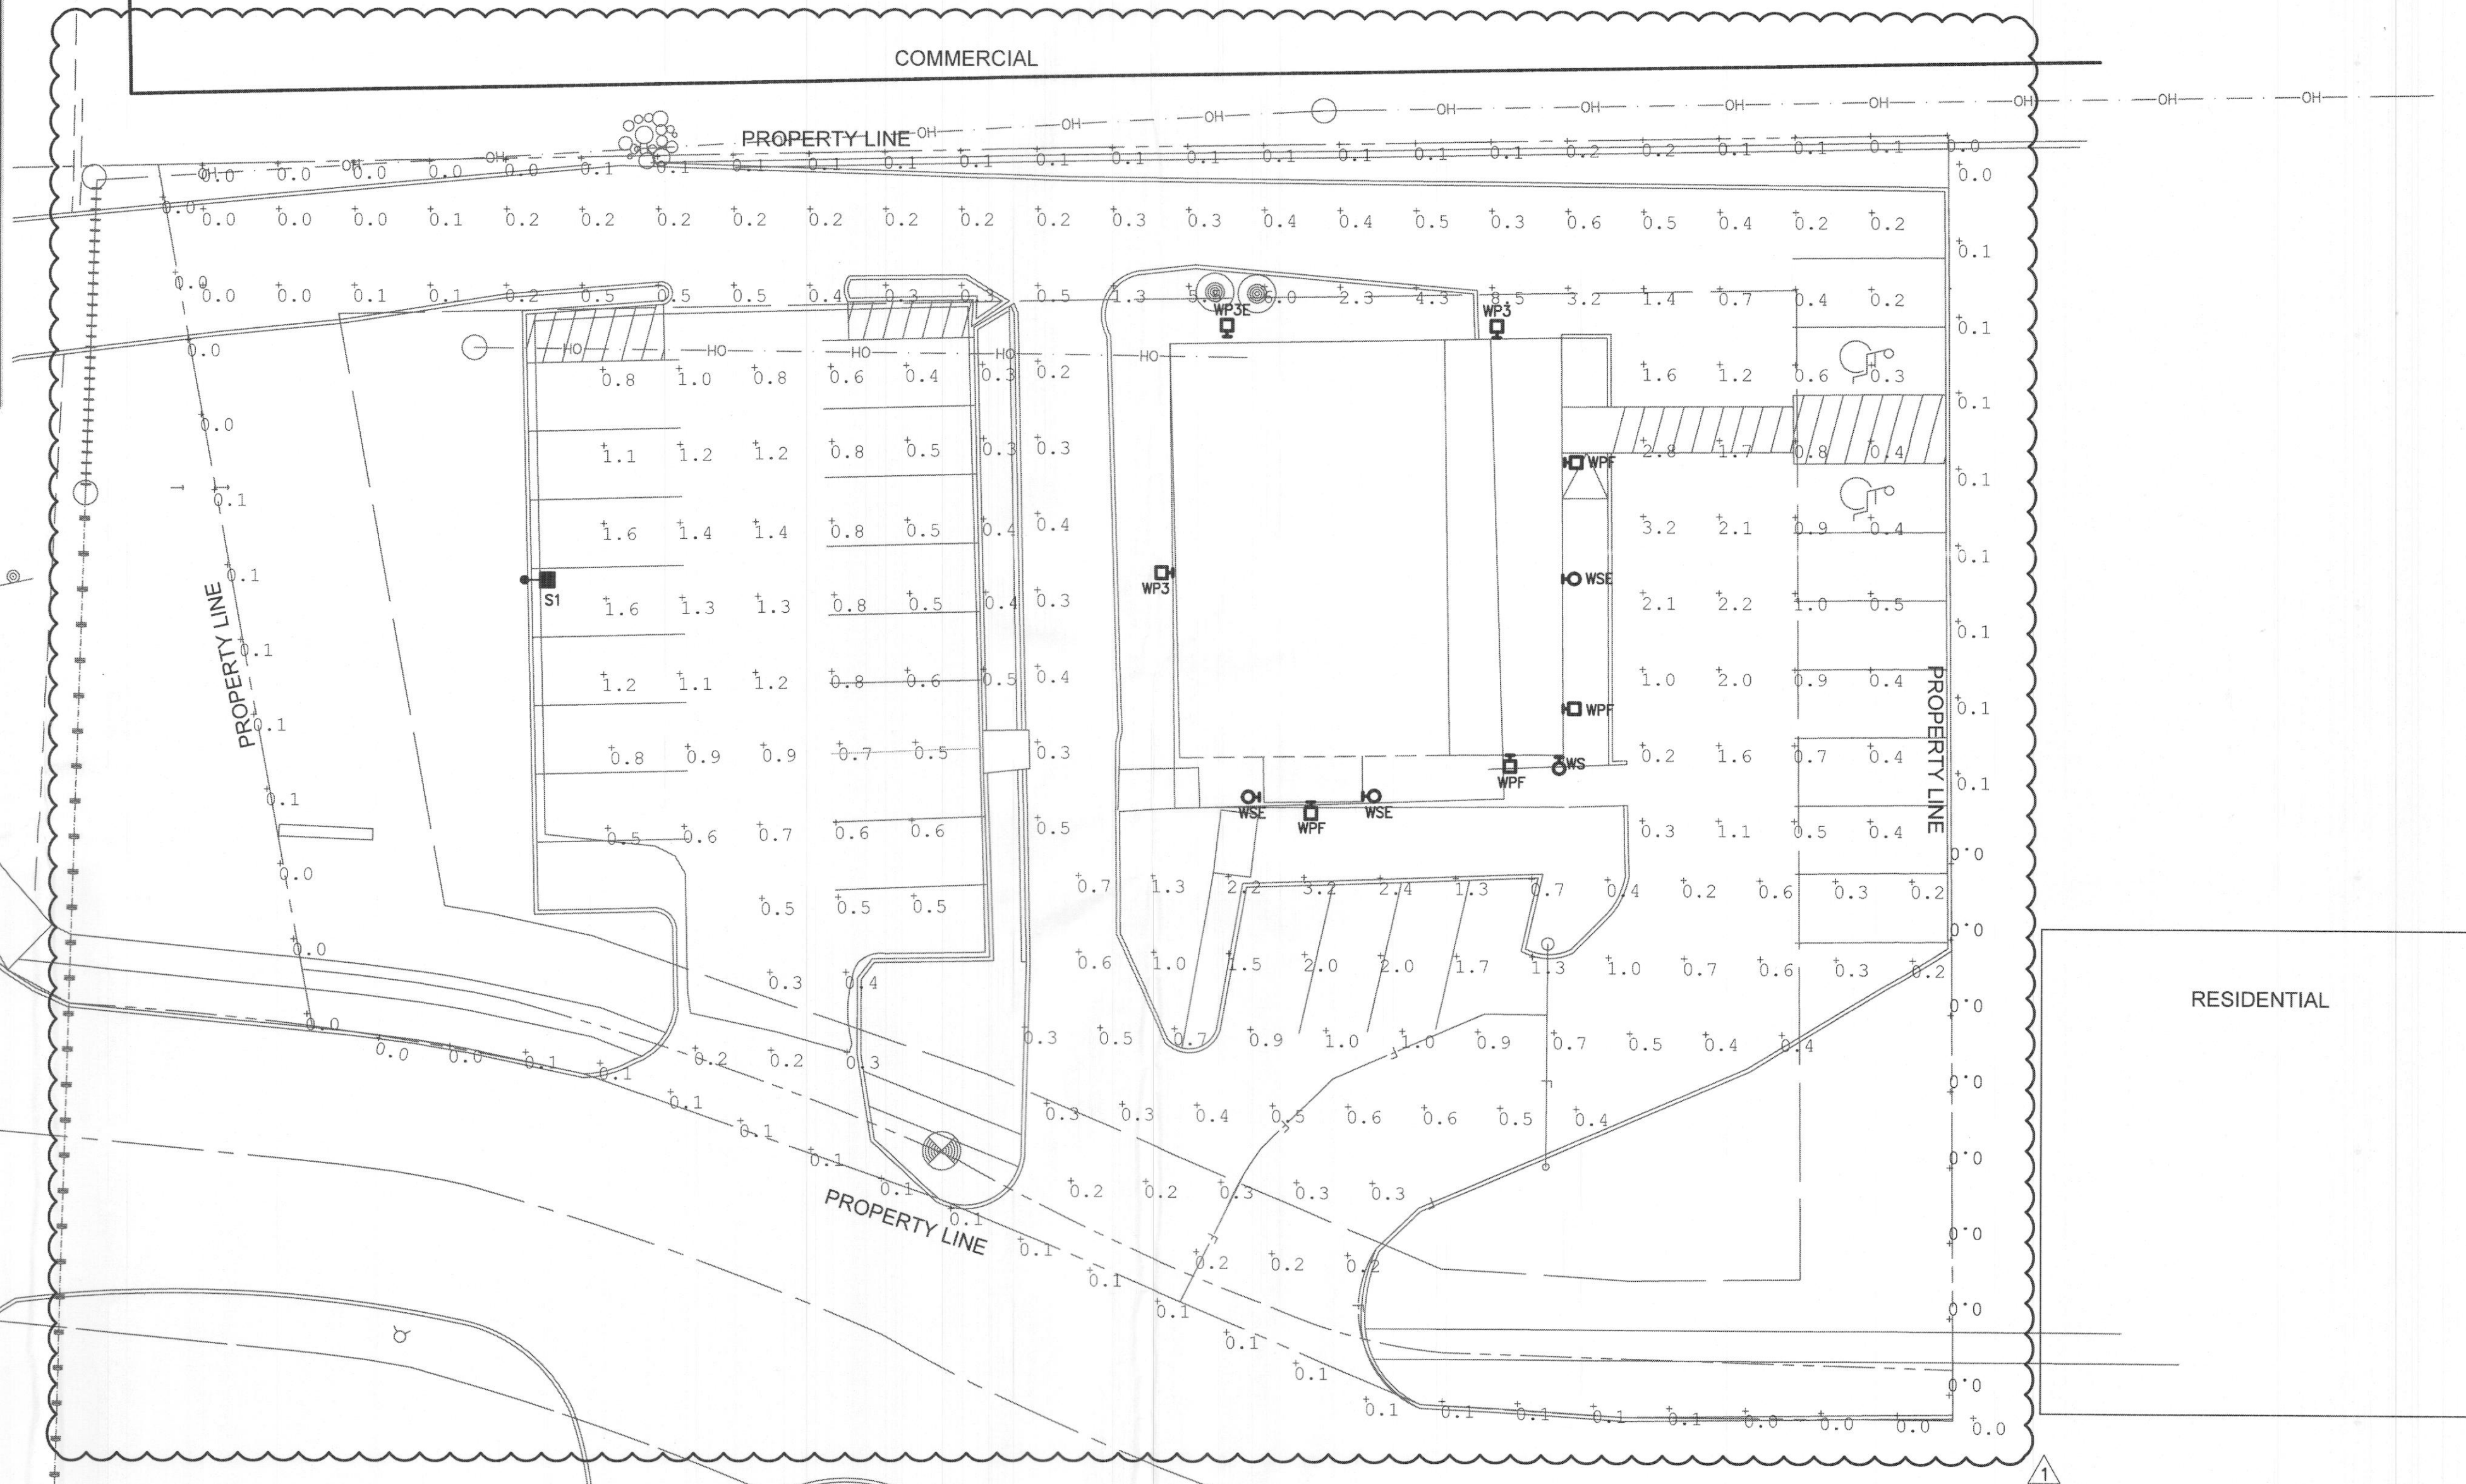

**STATISTICS**

AREA	AVERAGE	MAX	MIN	AVG/MIN	MAX/MIN
DRIVE/PARKING	1.0	8.5	0.2	5.0	43




1 SITE PLAN - PHOTOMETRIC  
SCALE: 1/16" = 1'-0"

APPROVED:  
I hereby certify that the above and foregoing site plan for development in the City of Rockwall, Texas, was approved by the Planning & Zoning Commission on the 11 day of May, 2024.

*[Signature]*  
Director of Planning & Zoning

**METHOD architecture**  
1919 MCKINNEY AVE, SUITE 2011  
DALLAS, TEXAS 75201  
(469) 640-6331

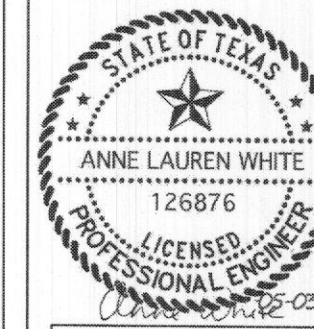


**ROTARY CLUB**  
ROCKWALL  
408 S GOLIAD ST.  
ROCKWALL, TX 75087

PROJECT: MB205016  
SHEET: E12  
SITE PLAN  
PHOTOMETRIC


**STMS ENGINEERING, LLC**  
11700 PRESTON ROAD | SUITE 650 | #104  
DALLAS, TEXAS 75241 | 214-398-9978  
WWW.STMSINC.COM | REG. E. 20274



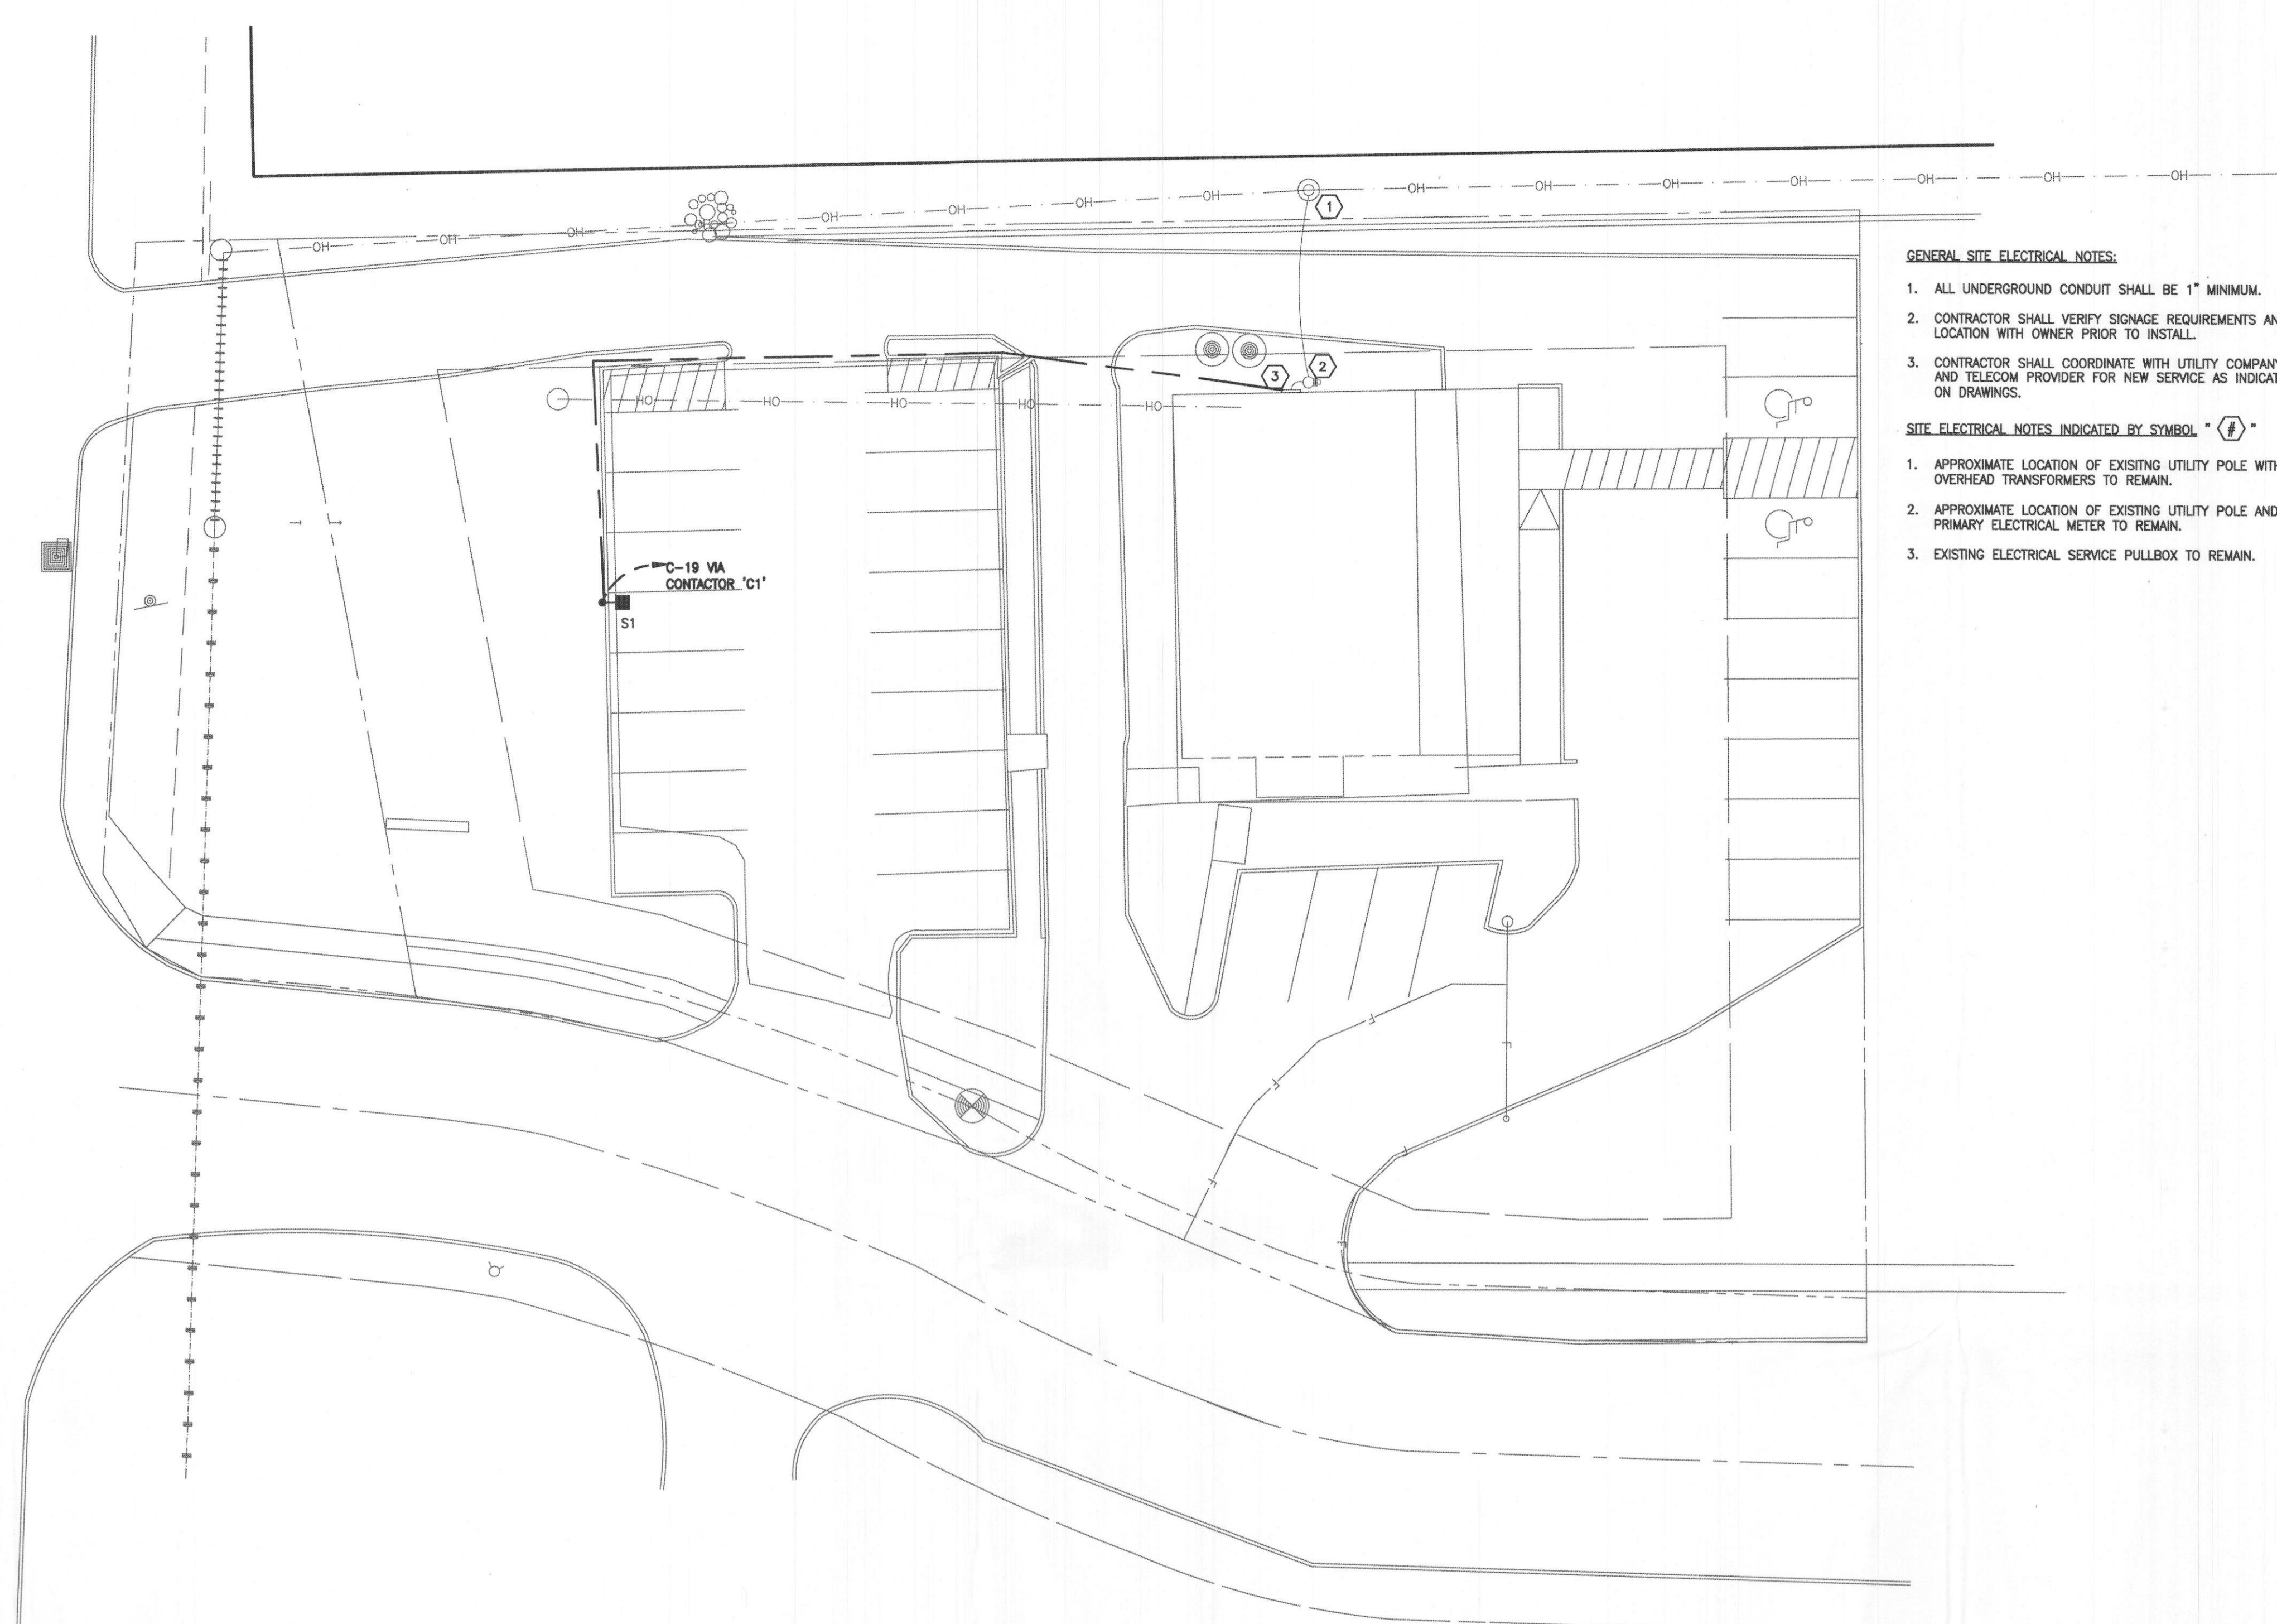

- GENERAL SITE ELECTRICAL NOTES:**
1. ALL UNDERGROUND CONDUIT SHALL BE 1" MINIMUM.
  2. CONTRACTOR SHALL VERIFY SIGNAGE REQUIREMENTS AND LOCATION WITH OWNER PRIOR TO INSTALL.
  3. CONTRACTOR SHALL COORDINATE WITH UTILITY COMPANY AND TELECOM PROVIDER FOR NEW SERVICE AS INDICATED ON DRAWINGS.
- SITE ELECTRICAL NOTES INDICATED BY SYMBOL "Ⓢ":**
1. APPROXIMATE LOCATION OF EXISTING UTILITY POLE WITH OVERHEAD TRANSFORMERS TO REMAIN.
  2. APPROXIMATE LOCATION OF EXISTING UTILITY POLE AND PRIMARY ELECTRICAL METER TO REMAIN.
  3. EXISTING ELECTRICAL SERVICE PULLBOX TO REMAIN.


**1 SITE PLAN - ELECTRICAL**  
SCALE: 1/16" = 1'-0"

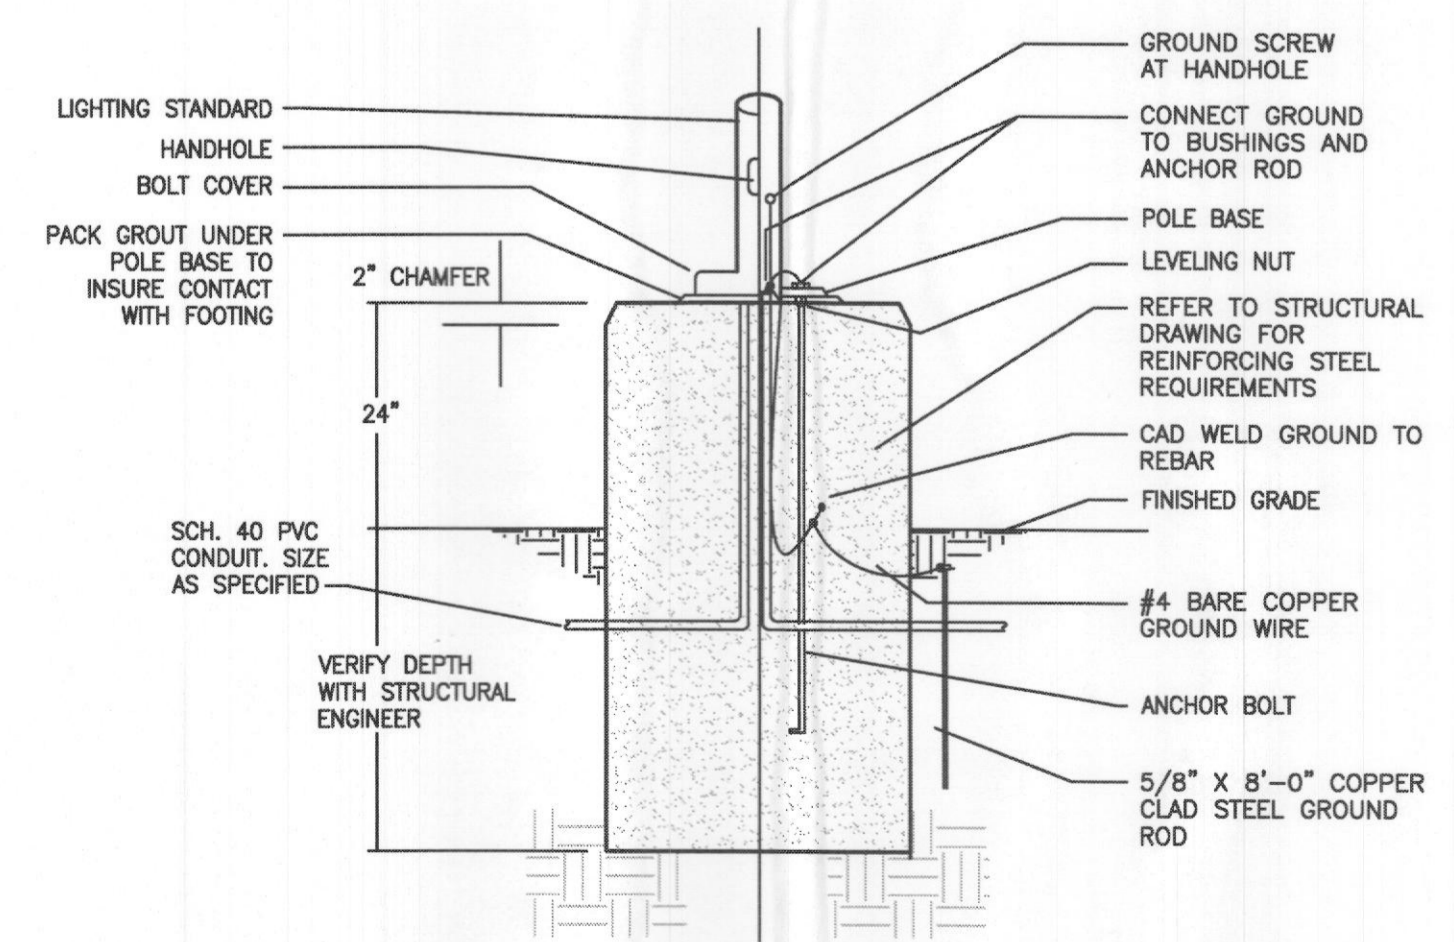

**2 POLE BASE DETAIL**  
SCALE: NONE

**METHOD architecture**  
1919 MCKINNEY AVE, SUITE 2011  
DALLAS, TEXAS 75201  
(469) 640-6331

05-0321	COMMENT RESPONSE
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**ROTARY CLUB  
ROCKWALL**  
408 S. COLIAD ST.  
ROCKWALL, TX 75087

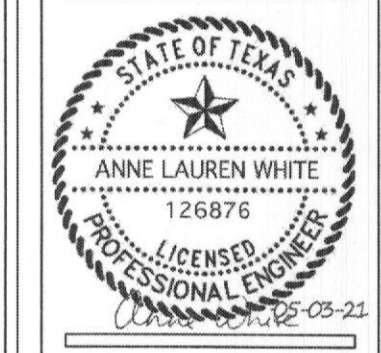PM: DR:  
PROJECT:  
**MB205016**  
SHEET:  
**E1.1**  
SITE PLAN  
ELECTRICAL

**SIMS ENGINEERING, LLC**  
11700 PRESTON ROAD | SUITE 660 #504  
DALLAS, TEXAS 75220 | 214.296.9571  
WWW.SIMSENG.COM | REG. # 10371