



PROPOSED BUILDING ADDITION 912 E INTERSTATE 30 ROCKWALL COUNTY ROCKWALL, TEXAS **ZONING: COMMERCIAL**

SHEET INDEX:

C0.0 **COVER SHEET**


DEMOLITION, SITE, AND GRADING PLAN C1.0

C2.0CONSTRUCTION DETAILS

ATTACHMENTS

PHOTOMETRIC PLAN


LANDSCAPE PLAN, NOTES AND DETAILS L1.0

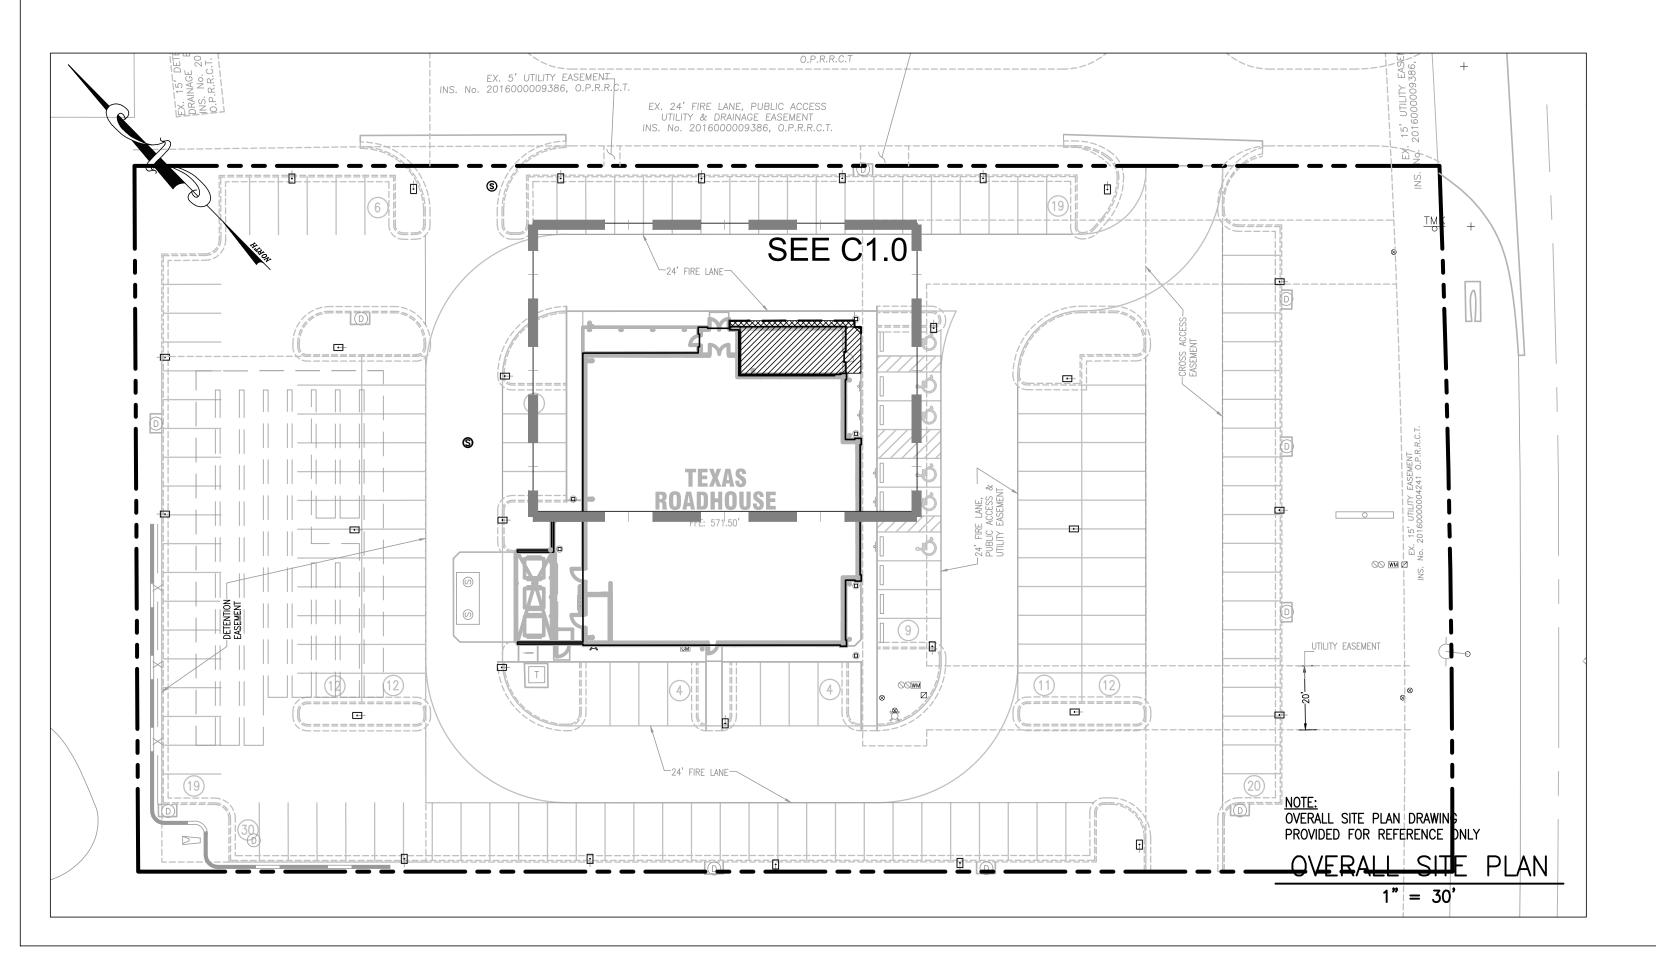

PROJECT INFORMATION:

TEXAS ROADHOUSE SITE AREA: C-COMMERCIAL RESTAURANT 28'-10" (ONE STORY) 487 SQ. FT. 7,907 SQ. FT. 321 SEATS 75 STALLS 162 STALLS (INCLUDING 6 ADA STALLS)

- 2. EXISTING PARKING COUNT IS SUFFICIENT FOR THE PROPOSED BUILDING

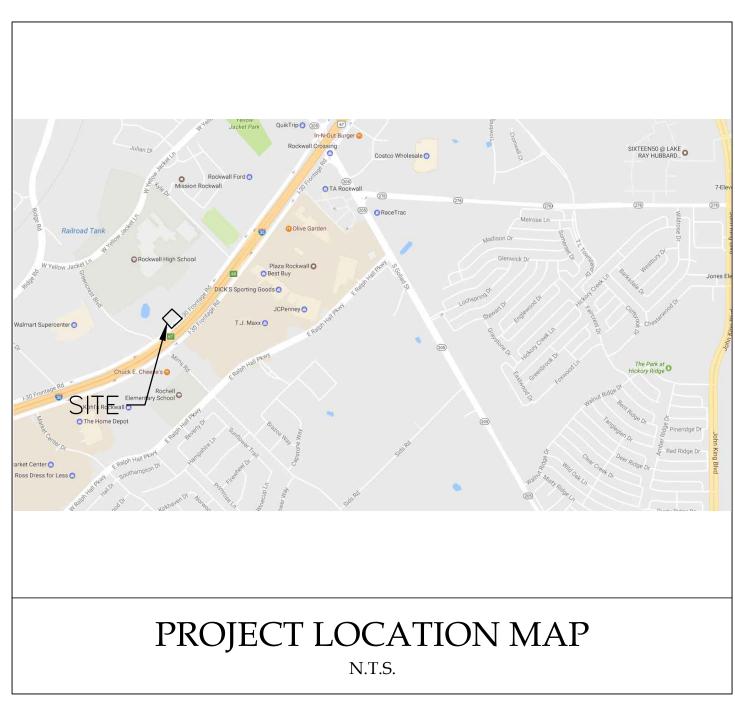

CONTACTS:

SAN. & STORM: PLANNING:

ENGINEERING DEPARTMENT CONTACT: AMY WILLIAMS.

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ROCKWALL FIRE DEPARTMENT 385 S. GOLIAD STREET CONTACT: KEVIN CLARK, FIRE MARSHAL TEL: (972) 771-7770

FIRE:

ELECTRIC: CONSTRUCTION AND BUILDER SERVICES

DEVELOPER:

TEXAS ROADHOUSE CONTACT: CAITLIN KINCAID TEXAS ROADHOUSE HOLDINGS, LLC 6040 DUTCHMANS LANE, SUITE 400 LOUISVILLE, KENTUCKY 40205 EMAIL: CAITLIN.KINCAID@TEXASROADHOUSE.COM

ENGINEER: GreenbergFarrow



CONTACT: MATTHEW H. BUDDE 21 S. EVERGREEN AVENUE, SUITE 200 ARLINGTON HEIGHTS, ILLINOIS 60005

TEL: (920) 843-9690 EMAIL: MBUDDE@GREENBERGFARROW.COM

JOB NO. 20190968.0

DATE: 08-02-2019

GENERAL DEMOLITION NOTES:

- 1. CONTRACTOR SHALL OBTAIN ALL NECESSARY PERMITS PRIOR TO COMMENCEMENT OF CONSTRUCTION.
- 2. CONTRACTOR SHALL COORDINATE ALL DEMOLITION WORK WITH THE MUNICIPALITY AND OWNERS REPRESENTATIVE TO ENSURE PROTECTION AND MAINTENANCE OF EXISTING UTILITY SERVICES AND SITE FEATURES NOT NOTED FOR REMOVAL.
- 3. CONTRACTOR SHALL CONTACT STATE ONE CALL SYSTEM (811) AND/OR PRIVATE LOCATING SERVICE TO LOCATE ALL UNDERGROUND UTILITY LINES PRIOR TO STARTING ANY DEMOLITION AND/OR EXCAVATION. EXACT LOCATIONS OF ANY
- EXISTING ELECTRIC, GAS, TELEPHONE, ETC. LINES ARE UNKNOWN. 4. CONTRACTOR SHALL PERFORM ALL DEMOLITION WORK IN ACCORDANCE WITH ALL
- APPLICABLE FEDERAL, STATE, AND LOCAL REQUIREMENTS. 5. ALL EROSION AND SEDIMENTATION CONTROL MEASURES AND DEVICES SHALL BE INSTALLED AND FUNCTIONAL BEFORE THE SITE IS OTHERWISE DISTURBED. THEY SHALL BE KEPT OPERATIONAL AND MAINTAINED CONTINUOUSLY THROUGHOUT THE PERIOD OF LAND DISTURBANCE UNTIL PERMANENT SITE STABILIZATION IS ACHIEVED.
- 6. THE PURPOSE OF THIS DRAWING IS TO CONVEY THE OVERALL SCOPE OF DEMOLITION WORK AND IT IS NOT INTENDED TO COVER ALL DETAILS OR SPECIFICATIONS REQUIRED TO COMPLY WITH GENERALLY ACCEPTED DEMOLITION PRACTICES. CONTRACTOR SHALL THOROUGHLY FAMILIARIZE THEMSELVES WITH THE SITE, SCOPE OF WORK, AND ALL EXISTING CONDITIONS AT THE JOB SITE PRIOR TO BIDDING AND COMMENCING THE WORK. THE DEMOLITION CONTRACTOR SHALL BE SOLELY RESPONSIBLE FOR MEANS, METHODS, TECHNIQUES, OR PROCEDURES USED TO COMPLETE THE WORK IN ACCORDANCE WITH THE CONSTRUCTION DOCUMENTS AND IS LIABLE FOR THE SAFETY OF THE PUBLIC AND CONTRACTOR'S EMPLOYEES DURING THE COURSE OF THE PROJECT.
- 7. THE DEMOLITION PLAN IS INTENDED TO SHOW REMOVAL OF KNOWN SITE FEATURES AND UTILITIES AS SHOWN ON THE ORIGINAL CIVIL ENGINEERING PLANS PROVIDED TO THE ENGINEER FOR DESIGN. THERE MAY BE OTHER SITE FEATURES, UTILITIES, STRUCTURES, AND MISCELLANEOUS ITEMS BOTH BURIED AND ABOVE GROUND THAT ARE WITHIN THE LIMITS OF WORK THAT MAY REQUIRE REMOVAL FOR THE PROPOSED SITE IMPROVEMENTS BUT THAT ARE NOT SHOWN HEREON. THE CONTRACTOR IS RESPONSIBLE FOR THE REMOVAL OF SUCH ITEMS AT NO ADDITIONAL COST TO THE OWNER.
- 8. CONTRACTOR SHALL UTILIZE CARE WHEN WORKING NEAR EXISTING UTILITIES TO REMAIN. ANY DAMAGE TO EXISTING UTILITIES NOT NOTED TO BE REMOVED SHALL BE REPAIRED AT CONTRACTOR'S EXPENSE AND TO THE SATISFACTION OF THE OWNER AND/OR ENGINEER.
- 9. ALL EXISTING SANITARY SEWERS, STORM SEWERS, WATER MAINS OR IRRIGATION LINES AND APPURTENANCES NOTED FOR REMOVAL WITHIN THE AREA OF THE PROPOSED CONSTRUCTION SHALL BE REMOVED FROM THE SITE AND DISPOSED OF BY THE CONTRACTOR. ALL ABANDONED SEWER LINES SHALL BE PLUGGED AT BOTH ENDS WITH A MINIMUM OF TWO (2) FEET LONG NON-SHRINK CONCRETE MORTAR
- 10. VOIDS LEFT BY ANY ITEM REMOVED UNDER ANY PROPOSED BUILDINGS, PAVEMENTS, OR WALKS OR WITHIN 24" THEREOF SHALL BE SHALL BE BACKFILLED IN
- ACCORDANCE WITH THE PROJECT SPECIFICATIONS AND GEOTECHNICAL REPORT. 11. ALL EXISTING LANDSCAPING NOTED TO BE REMOVED SHALL BE REMOVED FROM THE SITE AND DISPOSED OF BY THE CONTRACTOR.
- 12. PRIOR TO REMOVAL OF ANY PORTION OF THE EXISTING IRRIGATION SYSTEM AFFECTED BY THE PROPOSED BUILDING ADDITION CONTRACTOR SHALL LOCATE AND CAP THE EXISTING IRRIGATION LINES AT THE PROJECT AREA LIMITS. THE REMAINDER OF THE EXISTING SYSTEM SHALL REMAIN OPERATIONAL AT ALL TIMES DURING CONSTRUCTION. IF FOR ANY REASON THE SYSTEM WILL NOT BE OPERATIONAL CONTRACTOR SHALL UTILIZE CARE TO ENSURE EXISTING PLANT MATERIAL IS ADEQUATELY WATERED DURING DRY PERIODS OR TIMES OF EXTENDED HEAT.
- 13. CONTRACTOR SHALL REPAIR AT HIS EXPENSE ANY DAMAGE TO EXISTING ASPHALT, CONCRETE, CURBS, SIDEWALKS, ETC. RESULTING FROM CONSTRUCTION TRAFFIC AND/OR OPERATIONS. REPAIRS SHALL BE MADE TO THE SATISFACTION OF THE OWNER AND/OR ENGINEER.


DEMOLITION LEGEND:



EXISTING LANDSCAPING TO BE REMOVED



EXISTING CONCRETE SIDEWALK TO BE REMOVED

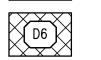

— x — PROPOSED CONSTRUCTION / SILT FENCE

SAWCUT LINE

XSTM>X EXISTING STORM SEWER LINE TO BE REMOVED


DEMOLITION KEY NOTES:

- D1 EXISTING TEXAS ROADHOUSE BUILDING TO REMAIN
- D2 EXISTING CONCRETE SIDEWALK TO REMAIN
- D3 SAW CUT EXISTING CONCRETE PAVEMENT D4 FXISTING ADA PARKING SIGN TO REMAIN
- D5 EXISTING LANDSCAPING TO BE REMOVED AS NEEDED FOR CONSTRUCTION OF PROPOSED BUILDING ADDITION. LANDSCAPING STONES SHALL BE REPLACED IN AREAS DISTURBED DURING CONSTRUCTION OPERATIONS.
- D6 EXISTING CONCRETE SIDEWALK TO BE REMOVED D7 PROPOSED CONSTRUCTION / SILT FENCE (SEE DETAIL)
- D9 EXISTING LANDSCAPING TO REMAIN. REPLACE ANY ITEMS DAMAGED AS A RESULT OF CONSTRUCTION OPERATIONS.
- D10 EXISTING STORM SEWER TO REMAIN
- D11 EXISTING STORM SEWER TO BE REMOVED D12 EXISTING ADA PARKING SIGN TO BE REMOVED

EXISTING CONDITIONS REFERENCE NOTE:

EXISTING CONDITIONS SHOWN REPRESENTS SITE CONDITIONS PER:

- TEXAS ROADHOUSE CONSTRUCTION PLANS PREPARED BY GREENBERGFARROW INC.
- (PROJECT #20151291.0) AND LAST REVISED NOVEMBER 20, 2017. CONTRACTOR SHALL FIELD VERIFY ALL EXISTING SITE IMPROVEMENTS AND UTILITY
- LOCATIONS PRIOR TO COMMENCEMENT OF CONSTRUCTION AND SHALL IMMEDIATELY NOTIFY THE ENGINEER OF ANY PLAN DISCREPANCIES OR OMISSIONS.

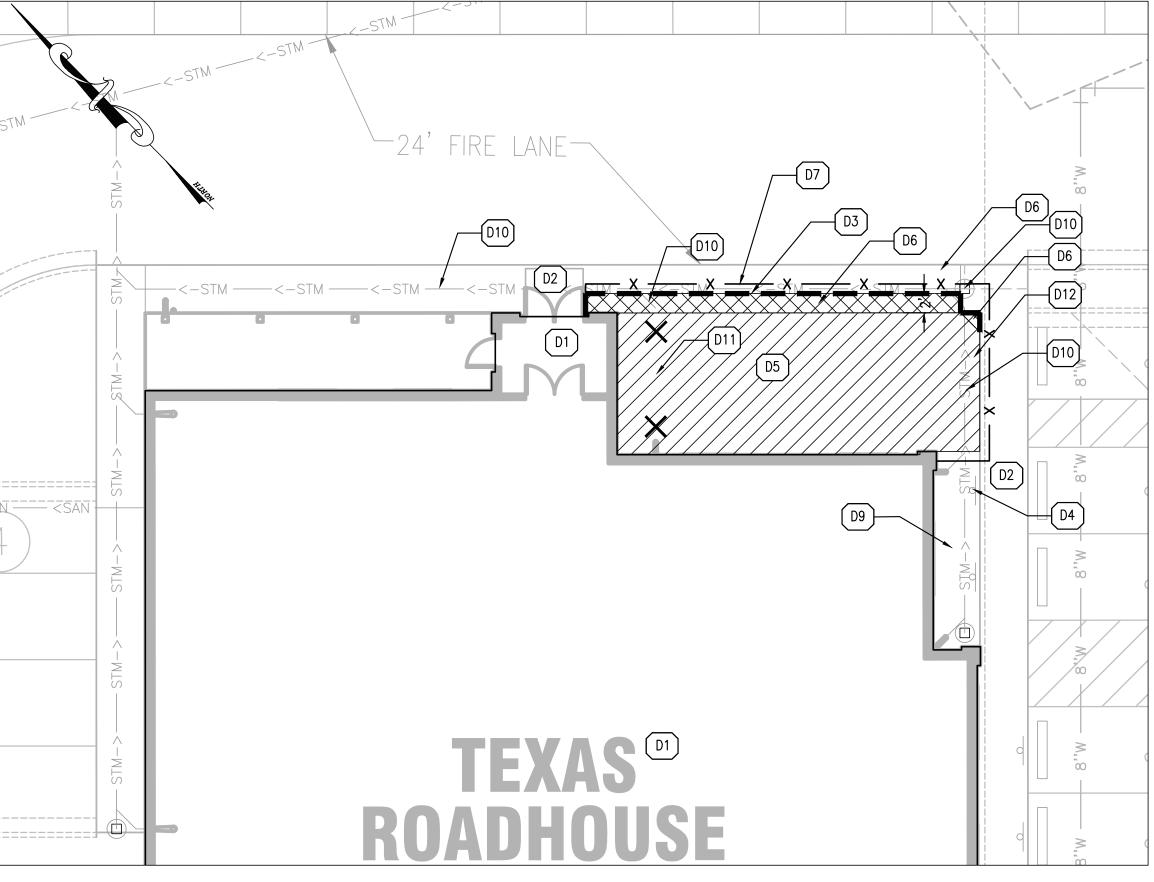

EXISTING CONDITIONS & DEMOLITION PLAN 1" = 10'

GENERAL SITE AND GRADING NOTES:

- 1. CONTRACTOR SHALL BE RESPONSIBLE FOR PROVIDING SAFE AND ADEQUATE WORKING CONDITIONS THROUGHOUT THE DURATION OF CONSTRUCTION OF THE PROPOSED SITE IMPROVEMENTS.
- 2. ALL CONSTRUCTION MATERIALS AND WORKMANSHIP SHALL BE IN ACCORDANCE WITH THE LATEST STATE AND LOCAL GOVERNMENT CONSTRUCTION STANDARDS AND SPECIFICATIONS.
- 3. ALL HANDICAP ACCESSIBLE SITE IMPROVEMENTS SHALL BE CONSTRUCTED IN ACCORDANCE WITH ALL FEDERAL, STATE AND LOCAL CODES AND REQUIREMENTS. 4. CONSTRUCTION SURVEY AND STAKEOUT SHALL BE THE RESPONSIBILITY OF THE
- CONTRACTOR. 5. IF DURING THE COURSE OF CONSTRUCTION THE CONTRACTOR FINDS ANY DISCREPANCIES OR CONFLICTS BETWEEN THE PROPOSED SITE IMPROVEMENTS INDICATED ON THE PLANS AND THE PHYSICAL CONDITIONS OF THE SITE, OR ANY ERRORS OR OMISSIONS WITHIN THE PLANS OR IN THE SITE LAYOUT AS PROVIDED BY THE ENGINEER, IT SHALL BE THE RESPONSIBILITY OF THE CONTRACTOR TO IMMEDIATELY NOTIFY THE ENGINEER. UNTIL AUTHORIZED TO PROCEED, ANY WORK PERFORMED BY THE CONTRACTOR AFTER SUCH A DISCOVERY WILL BE AT THE
- CONTRACTOR'S SOLE RISK AND EXPENSE. 6. CONTRACTOR SHALL COORDINATE ALL SITE IMPROVEMENTS WITH ARCHITECTURAL PLANS. ARCHITECTURAL PLANS SHALL BE USED FOR BUILDING STAKEOUT.
- 7. ALL PROPOSED GRADING, PAVEMENT, APRONS, CURBS, WALKS, ETC. SHALL MATCH EXISTING GRADES FLUSH.
- 8. ALL GRADING AND SITE PREPARATION WORK SHALL CONFORM WITH THE RECOMMENDATIONS AND SPECIFICATIONS CONTAINED IN THE GEOTECHNICAL REPORT. 9. MAXIMUM CROSS SLOPES AND LONGITUDINAL SLOPES FOR ALL CONCRETE SIDEWALKS AND HANDICAP ACCESSIBLE ROUTES SHALL NOT EXCEED 2% AND 5%,
- RESPECTIVELY. 10. CONTRACTOR SHALL ENSURE POSITIVE DRAINAGE TO EXISTING AND/OR PROPOSED STORM DRAINAGE STRUCTURES. AREAS OF SURFACE PONDING SHALL BE CORRECTED BY THE CONTRACTOR AT NO ADDITIONAL EXPENSE TO THE OWNER.
- 11. CONTRACTOR IS SPECIFICALLY CAUTIONED THAT THE LOCATION AND/OR ELEVATION OF EXISTING UTILITIES AS SHOWN ON THESE PLANS IS BASED ON THE ORIGINAL CIVIL ENGINEERING PLANS PROVIDED TO THE ENGINEER. THE INFORMATION IS NOT TO BE RELIED ON AS BEING EXACT OR COMPLETE. THE CONTRACTOR MUST CALL THE STATE ONE CALL SYSTEM (811) AT LEAST FORTY-EIGHT (48) HOURS BEFORE ANY EXCAVATION TO REQUEST EXACT FIELD LOCATIONS OF THE UTILITIES. IT SHALL BE THE RESPONSIBILITY OF THE CONTRACTOR TO RELOCATE ALL EXISTING UTILITIES WHICH CONFLICT WITH THE PROPOSED SITE IMPROVEMENTS SHOWN ON THE PLANS.
- 12. CONTRACTOR SHALL RESTORE ALL DISTURBED AREAS OUTSIDE OF CONSTRUCTION LIMITS TO ORIGINAL CONDITION OR BETTER. 13. ALL FIRE ACCESS LANES WITHIN THE PROJECT AREA SHALL REMAIN IN SERVICE, CLEAN OF DEBRIS, AND ACCESSIBLE FOR USE BY EMERGENCY VEHICLES AT ALL

TIMES DURING CONSTRUCTION.

SITE AND GRADING LEGEND:

PROPOSED CONCRETE LANDING

PROPOSED CONCRETE SIDEWALK



6" PORTLAND CEMENT CONCRETE WITH 6X6 W2.9XW2.9 WWF 4" AGGREGATE BASE (SEE STRUCTURAL PLANS FOR ADDITIONAL INFORMATION)



3000 PSI MIN, 5.5 SACK MIN 5" PORTLAND CEMENT CONCRETE 6" AGGREGATE BASE



PROPOSED INTEGRAL BLACK CONCRETE SIDEWALK 3000 PSI MIN, 5.5 SACK MIN 5" PORTLAND CEMENT CONCRETE 6" AGGREGATE BASE



(SEE LANDSCAPE PLANS FOR ADDITIONAL INFORMATION AND DETAILS)

472.35 Fl

PROPOSED SPOT ELEVATION

— x — PROPOSED CONSTRUCTION / SILT FENCE

PROPOSED LANDSCAPE AREA

FFE: FINISHED FLOOR ELEVATION TC: TOP OF CURB ELEVATION CURB FLOWLINE ELEVATION

TOP OF CONCRETE ELEVATION TOP OF PAVEMENT ELEVATION FG: FINISHED GRADE ELEVATION


ME: MATCH EXISTING ELEVATION

S1 EXISTING TEXAS ROADHOUSE BUILDING TO REMAIN

SITE AND UTILITY KEY NOTES:

- S2 PROPOSED BUILDING ADDITION (SEE ARCHITECTURAL AND STRUCTURAL PLANS FOR ADDITIONAL INFORMATION AND DETAILS). CONTRACTOR SHALL FIELD VERIFY EXISTING BUILDING FINISHED FLOOR ELEVATION (FFE) AND MATCH
- ELEVATION WITH PROPOSED ADDITION S3 PROPOSED 6" CONCRETE LANDING (SEE STRUCTURAL PLANS)
- S4A PROPOSED CONCRETE SIDEWALK TO MATCH EXISTING (SEE DETAIL) S4B PROPOSED INTEGRAL BLACK CONCRETE SIDEWALK TO MATCH EXISTING (SEE
- DETAIL) S6 PROPOSED BUILDING ROOF DRAIN LOCATION (CONTRACTOR SHALL COORDINATE EXACT DOWNSPOUT LOCATIONS WITH ARCHITECTURAL PLANS) CONNECT TO

- EXISTING PRIVATE DOWNSPOUT LEADER (SEE DETAIL) S7 PROPOSED CONSTRUCTION / SILT FENCE (SEE DETAIL)
- S13 PROPOSED LANDSCAPE AREA
- S14 PROPOSED RAILING SEE DETAIL
- S19 PROPOSED ACCESSIBLE PARKING SIGN PER LOCAL CODE

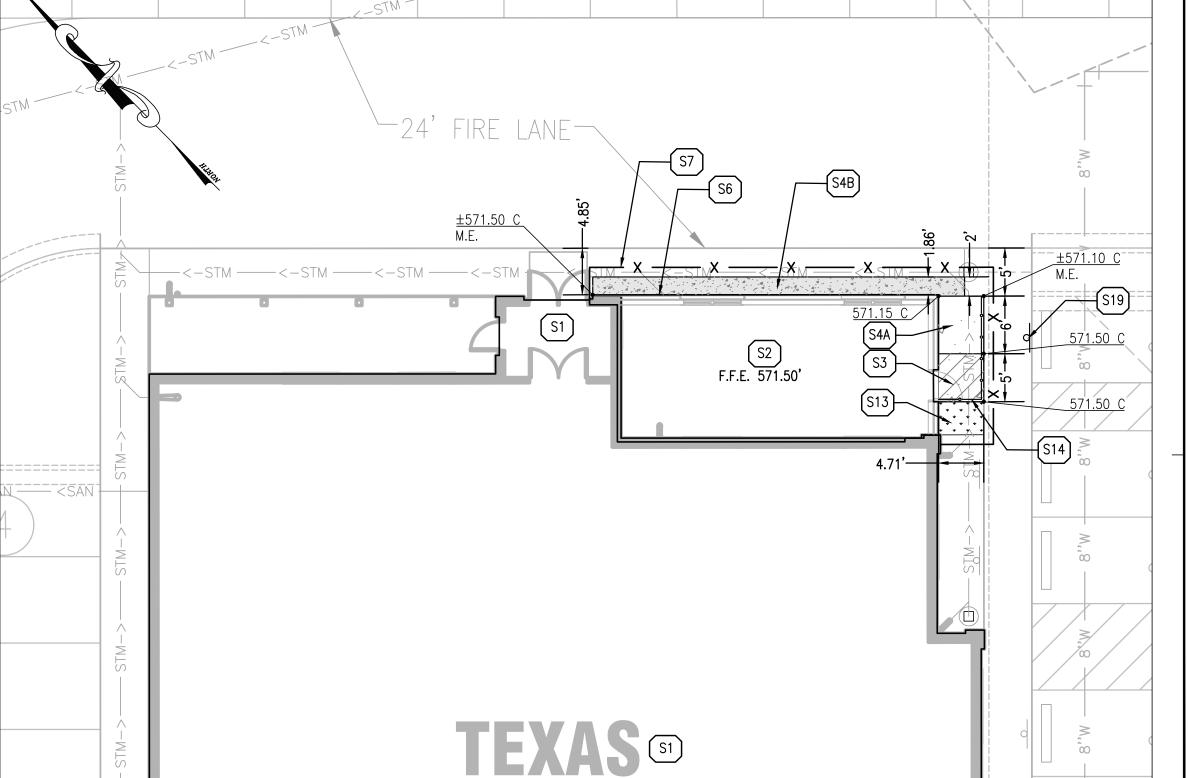

PROPOSED SITE & GRADING PLAN

21 South Evergreen Avenue Suite 200 Arlington Heights, IL 60005 t: 847 788 9200 f: 847 788 9537 **PROJECT TEAM**

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DESCRIPTION 08/02/19 PERMIT SET

PROFESSIONAL SEAL



PROFESSIONAL IN CHARGE KERI WILLIAMS, P.E. PROFESSIONAL ENGINEER LICENSE NO. 127846

PROJECT MANAGER MATTHEW H. BUDDE **QUALITY CONTROL** MITCH HEFFERNAN DRAWN BY

MATTHEW H. BUDDE PROJECT NAME

TEXAS ROADHOUSE

ROCKWALL **TEXAS**

912 E INTERSTATE 30




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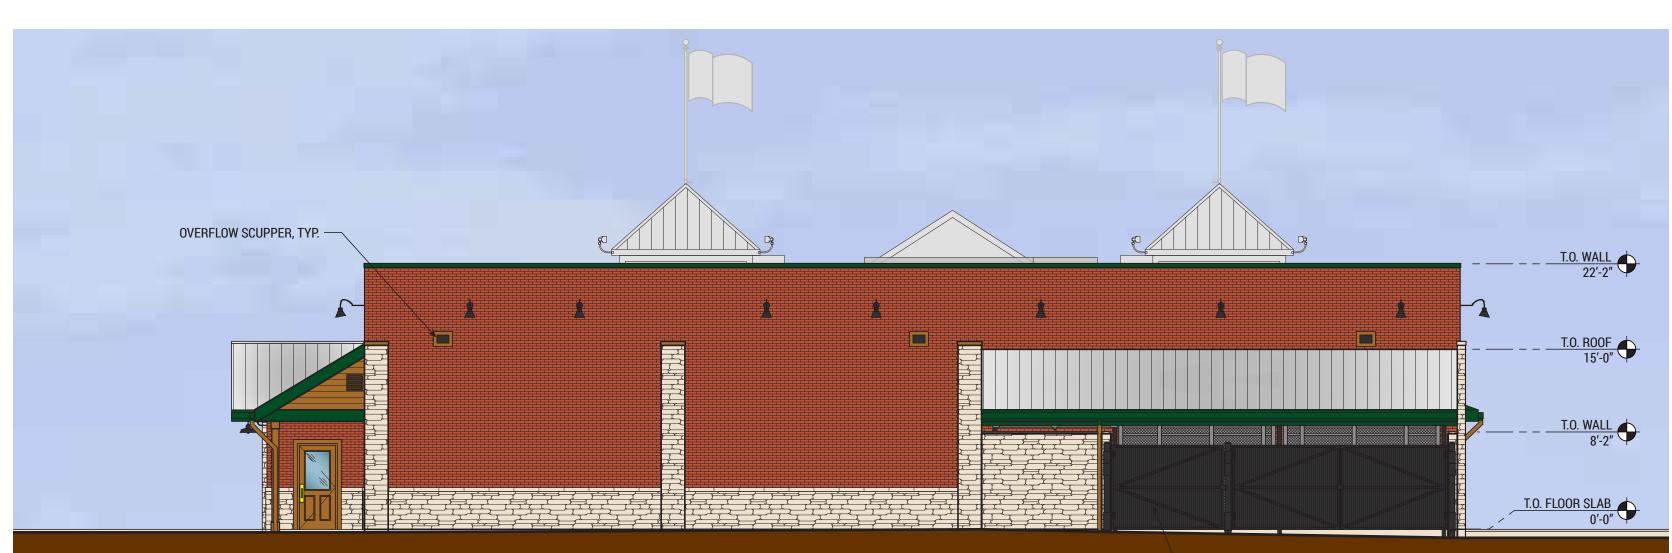
SHEET TITLE **DEMOLITION, SITE, AND GRADING PLAN**

SHEET NUMBER



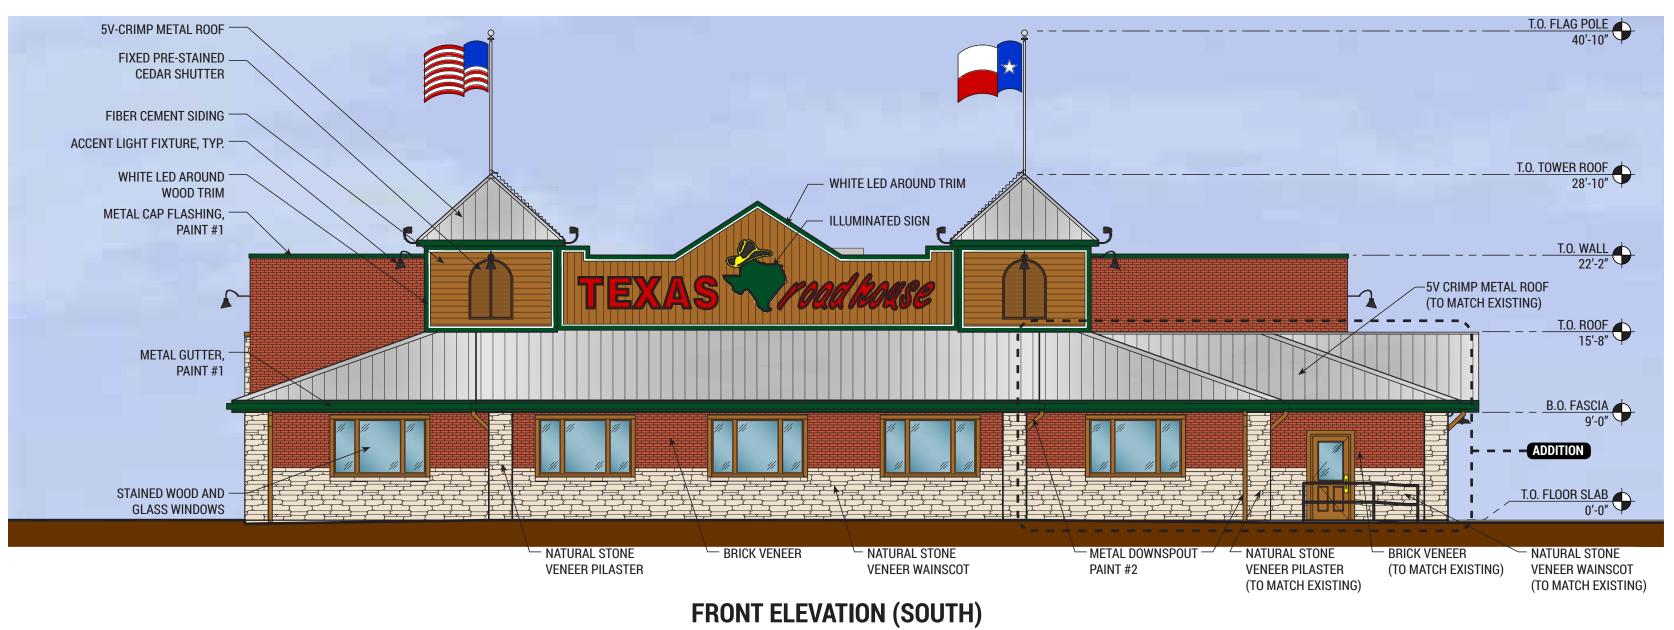

LEFT ELEVATION (WEST)



STEEL BOLLARDS WITH METAL WALL PANEL, PAINT #3

REAR ELEVATION (NORTH)



EXTERIOR FINISH SCHEDULE PRE-STAINED CEDAR, HENRY POOR LUMBER TRIM & WOOD SHUTTERS CEDARTONE TWP #1501 STAIN FORMULA FIBER CEMENT SIDING LAP SIDING, RUSTIC CEDAR; COLOR: MAPLE VERTICAL PANEL, RUSTIC 8" O.C. GROOVE; COLOR: MAPLE METAL DOORS (FAUX WOOD) FRONT ENTRANCE DOORS STEELCRAFT "GRAIN-TECH" (MAPLE FINISH) PAINT #1: TRIM, METAL FLASHING & GUTTERS SHERWIN WILLIAMS PAINTS, GREEN PAINT #2: SHERWIN WILLIAMS PAINTS, #2195 "ROADSIDE" **DOWNSPOUTS** FINISH COLOR TO MATCH PRE-STAINED CEDAR METAL DOORS & FRAMES, PAINT #3: **DUMPSTER GATES & BOLLARDS, RAILING** SHERWIN WILLIAMS PAINTS, GLOSS BLACK CLAYMEX **BRICK VENEER** OLD DENVER GENERAL SHALE BRICK VENEER (ALTERNATE) PHOENIX C652 NATURAL STONE VENEERS INTERNATIONAL, INC. **NATURAL STONE VENEER** TRADITIONAL COLLECTION, FAIRMONT METAL SALES **METAL ROOF** 5V-CRIMP, GALVALUME DISCLAIMER NOTE: THE COLORS DEPICTED ON THESE ELEVATIONS ARE FOR GRAPHIC REPRESENTATION PURPOSES ONLY. PLEASE REFER TO MATERIAL BOARD FOR ACTUAL SAMPLE OF COLORS AND TEXTURES



