

VICINITY MAP

PROPERTY LINE

_____W^12" WATER WATER LINE

∞F.D.C.

F.A.W.E.

____B.S.____

-Ó- FH

™. v.

F.A.U.E.

0 0

• C.O.

∞ C.O.

s EX. SANITARY SEWER LINE

PROP. 8" S.S. S PROP. SANITARY SEWER LINE

PREVENTER

PROPOSED STORM SEWER

PROPOSED FIRE HYDRANT

PROPOSED FIRE CONNECTION

PROPOSED WATER METERS

SANITARY SEWER EASEMENT

FIRE LANE, PUBLIC ACCESS

PROPOSED BACK FLOW

PEDESTERIAN SIGNT &

VISIBILITY EASEMENT

UTILITY EASEMENT

WATER EASEMENT

DRAINAGE EASEMENT

& WATER EASEMENT

VISIBILITY EASEMENT

PROPOSED FIRE LANE

LANDSCAPE SET BACK

EXISTING STORM SEWER

EXISTING PAVEMENT/CURB

EXISTING SEWER MANHOLE

PROPOSED HANDICAP

EXISTING POWER POLE

EXISTING STORM INLETS

EXISTING FIRE HYDRANT

EXISTING WATER VALVE

PROPOSED BOLLARDS

PROPOSED CAR STACKING

FIRE LANE, PUBLIC ACCESS &

PROP.6' HIGH WROUGHT

IRON FENCE

EXISTING TREE

TRANSFORMER

GREASE TRAP

SAMPLING WELL

SINGLE CLEAN OUT

DOUBLE CLEAN OUT

MONUMENT/POLE SIGN

PROPOSED WHEEL STOP PROPOSED HANDICAP SIGN

UTILITY EASEMENT

PARKING SPACE

BARRIER FREE RAMP

FRONT SET BACK



2. A PERMIT IS REQUIRED TO CUT A CITY STREET OR WORK WITHIN THE RIGHT-OF-WAY. THE PERMIT IS ISSUED BY THE PUBLIC WORKS

3. THE LOCATION OF UNDERGROUND UTILITIES INDICATED ON THE PLANS IS TAKEN FROM PUBLIC RECORDS. IT IS THE CONTRACTOR'S RESPONSIBILITY TO MAKE ARRANGEMENTS WITH THE OWNERS OF SUCH UNDERGROUND UTILITIES PRIOR TO WORKING IN THE AREA TO CONFIRM THEIR EXACT LOCATION AND TO DETERMINE WHETHER ANY ADDITIONAL UTILITIES OTHER THAN THOSE SHOWN ON THE PLANS MAY BE PRESENT. THE CONTRACTOR SHALL PRESERVE AND PROTECT ALL UNDERGROUND UTILITIES. IF EXISTING UNDERGROUND UTILITIES ARE DAMAGED, THE CONTRACTOR WILL BE RESPONSIBLE FOR THE COST OF REPAIRING THE UTILITY.

4. WHERE EXISTING UTILITIES OR SERVICE LINES ARE CUT, BROKEN OR DAMAGED, THE CONTRACTOR SHALL REPLACE OR REPAIR THE UTILITIES OR SERVICE LINES WITH THE SAME TYPE OF ORIGINAL MATERIAL AND CONSTRUCTION, OR BETTER, UNLESS OTHERWISE SHOWN OR NOTED ON THE PLANS, AT HIS OWN COST AND EXPENSE. THE CONTRACTOR SHALL IMMEDIATELY NOTIFY THE ENGINEER AT ONCE OF ANY CONFLICTS IN GRADES AND ALIGNMENT.

OPERATIONS SHALL COMPLY WITH THE REQUIREMENTS OF THE U. S. DEPARTMENT OF LABOR, OSHA, "CONST. SAFETY AND HEALTH REGULATIONS.", VOL. 29, SUBPART P. PG. 128

PREVENT EROSION. IN THE EVENT THAT SIGNIFICANT EROSION OCCURS AS A RESULT OF CONSTRUCTION THE CONTRACTOR SHALL RESTORE THE ERODED AREA TO ORIGINAL CONDITION OR BETTER.

DISTURBED BY CONSTRUCTION TO ORIGINAL CONDITION OR BETTER. RESTORED AREAS INCLUDE, BUT ARE NOT LIMITED TO TRENCH BACKFILL, SIDE SLOPES, FENCES, CULVERT PIPES, DRAINAGE DITCHES, DRIVEWAYS, PRIVATE

8. ANY CHANGES NEEDED AFTER CONSTRUCTION PLANS HAVE BEEN RELEASED, SHALL BE APPROVED BY THE CITY ENGINEER. THESE CHANGES MUST BE RECEIVED IN WRITING FROM THE FROM THE DESIGN ENGINEER. THE DIRECTOR OF PUBLIC WORKS SHALL APPROVE

MARKED PRINTS TO THE ENGINEER PRIOR TO FINAL INSPECTION INDICATING ALL CONSTRUCTION WHICH DEVIATED FROM THE PLANS OR WAS CONSTRUCTED IN ADDITION TO

. ALL CONSTRUCTION SHALL BE IN STRICT ACCORDANCE WITH THE STANDARDS OF THE CITY OF ROCKWALL.

DEPARTMENT.

5. ALL EXCAVATIONS, TRENCHING AND SHORING 137, AND ANY AMENDMENTS THERETO.

6. ADEQUATE MEASURES SHALL BE TAKEN TO

7. THE CONTRACTOR SHALL RESTORE ALL AREAS YARDS AND ROADWAYS.

ANY DEVIATIONS FROM STATE REGULATIONS.

9. THE CONTRACTOR SHALL PROVIDE "RED LINED" THAT INDICATED ON THE PLANS.

COOPER GENERAL CONTRACTORS

2560 TECHNOLOGY DRIVE, SUITE 100

PLANO, TEXAS 75074 **CONTACT: DOUG GALLOWAY**

TEL: (972) 245-7960


TRIANGLE ENGINEERING LLC

1784 McDERMOTT DRIVE, SUITE 110

CONTACT: KARTAVYA PATEL

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ALLEN, TEXAS 75013

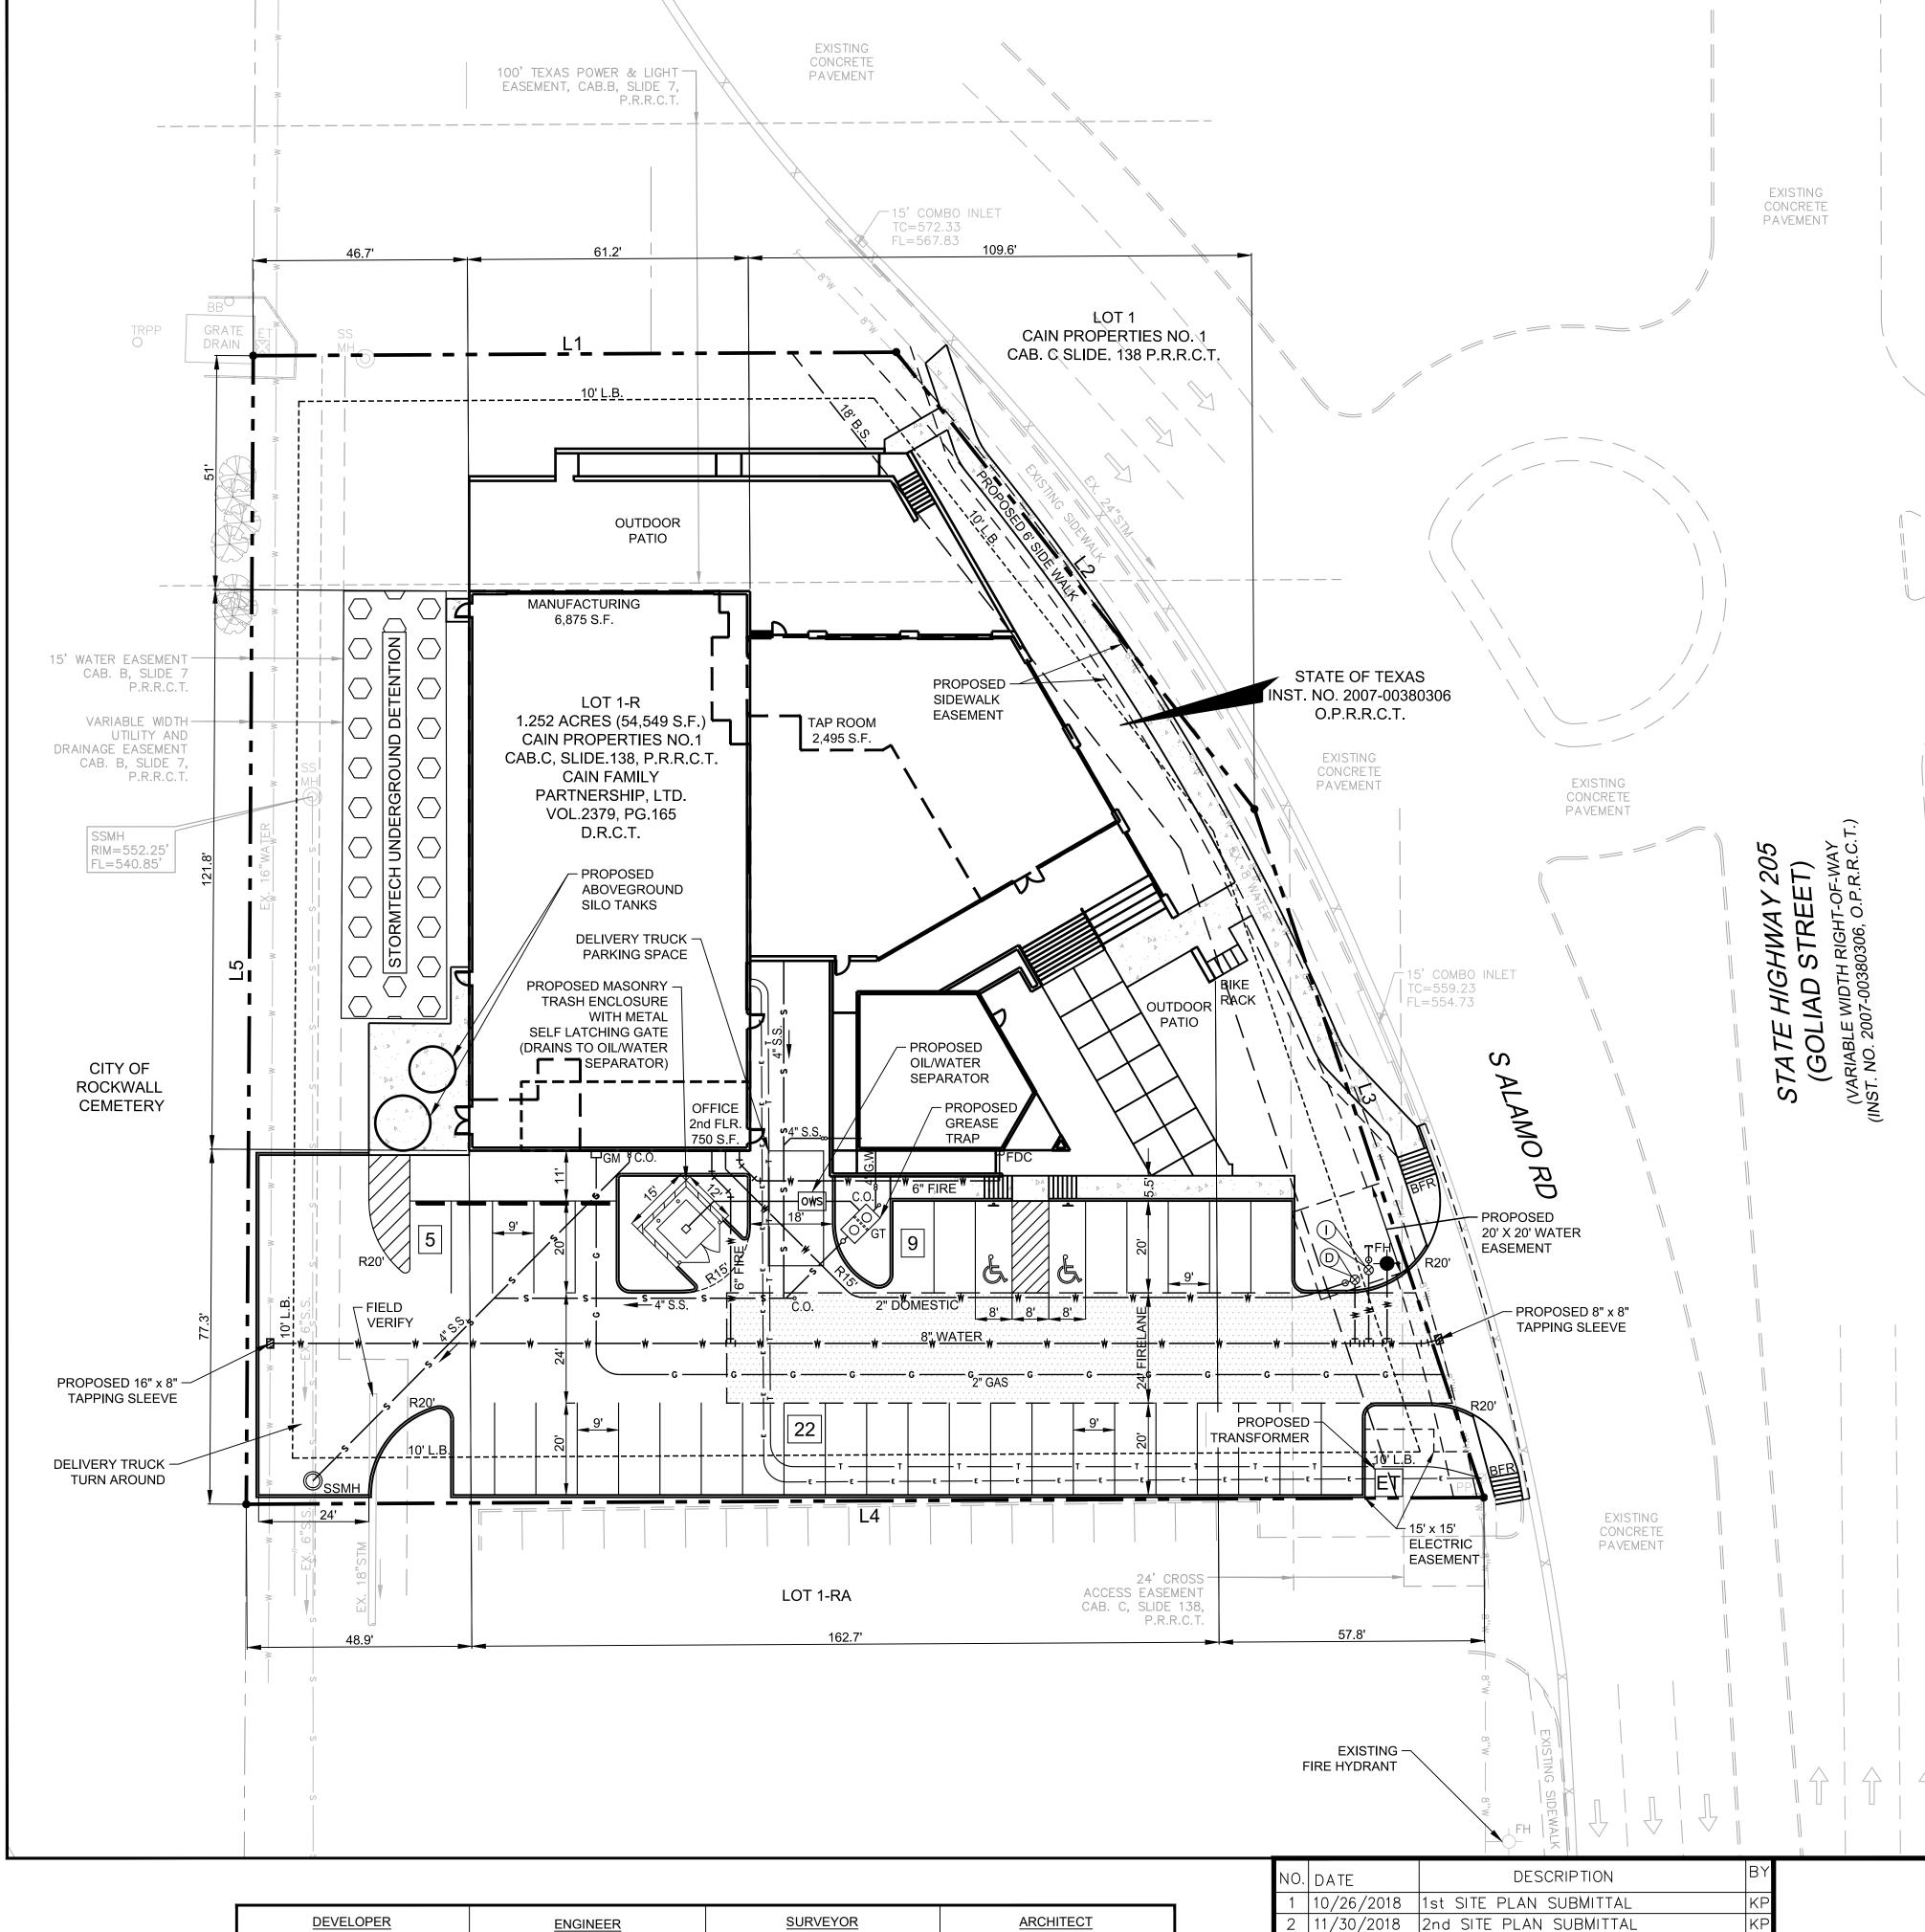

A&W SURVEYORS INC.

P.O. BOX 870029

MESQUITE, TEXAS 75157

CONTACT: JOHN TURNER, R.P.L.S.

TEL: (972) 881-4975

MUNN HARRIS ARCHITECTS, PLLC

5646 MILTON STREET, SUITE 437

DALLAS, TEXAS 75206

CONTACT: JOHN MUNN

TEL: (214) 564-5343

	BOUNDARY LINE DATA				
LINE NO.	LINE NO. BEARING DISTANCE				
L1	N 89°41'09" E	140.00'			
L2	S 38°05'53" E	126.41'			
L3	S 18°25'49" E	157.96'			
L4	S 89°41'12" W	269.46'			
L5	N 00°20'48" E	250.05'			

LEGEND				
UTILITY EASEMENT	U.E.			
SANITARY SEWER EASEMNET	S.S.E.			
DETENTION & DRAINAGE EASEMENT	D.D.E.			
WATERLINE EASEMENT	W.E.			
VISIBILITY EASEMENT	V.E.			
SIDEWALK EASEMENT	S.E.			
ELECTRICAL EASEMENT	E.E.			
CLEAN OUT	C.O.			
GAS METER	GM			
ELECTRICAL VAULT	EV			
LIGHT POLE	LP			
TRAFFIC SIGN	TS			
ELECTRICAL TRANSFORMER	ET			
FIRE HYDRANT	FH			
SANITARY SEWER MANHOLE	SSMH			
STORM SEWER MANHOLE	STMMH			
BUILDING SET BACK	B.S.			
LANDSCAPE BUFFER	L.B.			
PRESSURE REDUCING VALVE	PRV			
FIRE DEPARTMENT CONNECTION	F.D.C.			
SCREENING WALL &	S.W.L.E.			
LANDSCAPE ESAEMENT				
BARRIER FREE RAMP	BFR			
VISIBILITY EASEMENT	V.E.			
VISIBILITY CLIP				

PHYSICAL ADDRESS	S. ALAMO ROAD			
GROSS SITE AREA	1.252 ACRES (54,549 S.			
NET AREA	1.252 ACRES (54,549 S.I			
ZONING	DT - DOWNTOWN			
CURRENT USE	VACANT			
PROPOSED USE	BREWERY			
LOT COVER	AGE DATA			
BREW HOUSE COVERAGE	6,875 S.F. (12.60%)			
TAP ROOM COVERAGE	2,495 S.F. (4.57%)			
OFFICE/ADMIN. COVERAGE (2ND LEVEL)	750 S.F. (1.37%)			
BUILDING FOOTPRINT	11,931 S.F. (21.87%)			
TOTAL BUILDING AREA	13,781 S.F. (25.26%)			
IMPERVIOUS COVERAGE	23,053 S.F. (42.26%)			
PERVIOUS COVERAGE	31,496 S.F. (57.74%)			
PARKING SUMMARY				
PARKING SPACE REQUIREMENTS				
MANUFACTURING - 1 PER 1,000 S.F. (7)				
TAP ROOM - 1 PER 100 S.F. (25)				
OFFICE - 1 PER 300 S.F. (3)				
FOOD TRUCK PARKING (1)				
TOTAL PARKING SPACES REQUIRED = 36				
TOTAL PARKING SPACES PROVIDED= 36				
BUILDING DATA				
BUILDING	1			
PEAK HEIGHT	34'-0"			
TOTAL SQUARE FOOTAGE	13,781 S.F.			

DETENTION NOTE


1. ONSITE DETENTION WILL BE PROVIDED.

WATER METER & SANITARY SEWER SCHEDULE					
ID	TYPE	SIZE	NO.	SAN. SEW.	
(D)	DOM.	2"	1	4"	
	IRR.	1"	1	N/A	

CASE # SP2018-038

REDESIGNED SITE PLAN **ROCKWALL BREWERY**

310 SOUTH GOLIAD STREET CITY OF ROCKWALL ROCKWALL COUNTY, TEXAS

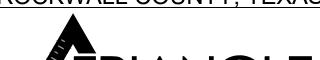



T: 214.609.92711 F: 469.359.6709 | E: kpatel@triangle-engr.com W: triangle-engr.com | O: 1333 McDermott Drive, Suite 200, Allen, TX 75013

Vlanagement	Planning Civil Engineering Construction N					
SHEET NO.	PROJECT NO.	SCALE	DATE	DRAWN	DESIGN	
2	003–18	1"=20'	11/15/18	AR	KP	
3	TX PE FIRM #11525					



ALAMO STREET ELEVATION (EAST)



SOUTH ELEVATION


SIREN ROCK BREWING CO.

11.27.2018

WWW.MUNNHARRIS.COM




NORTH ELEVATION

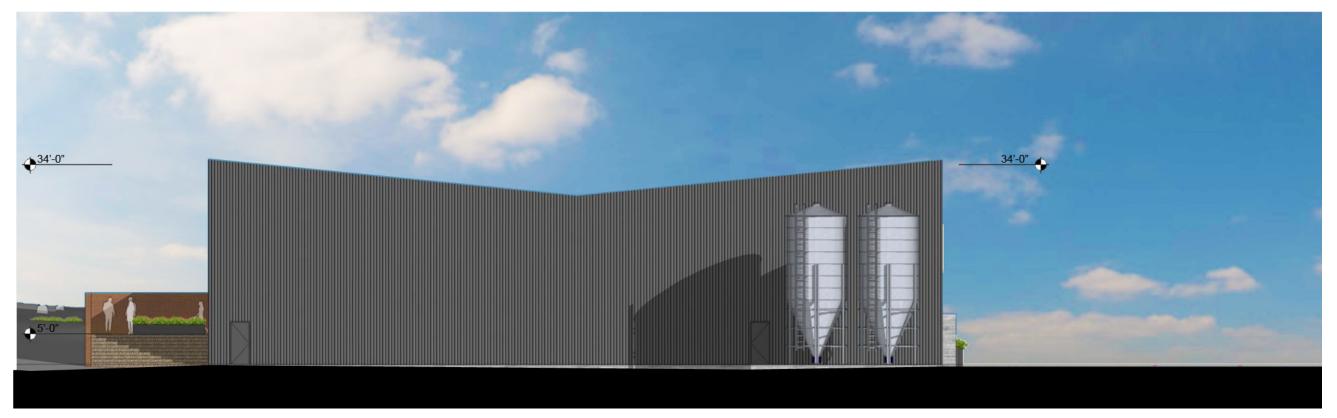

WEST ELEVATION

SIREN ROCK BREWING CO.

11.27.2018

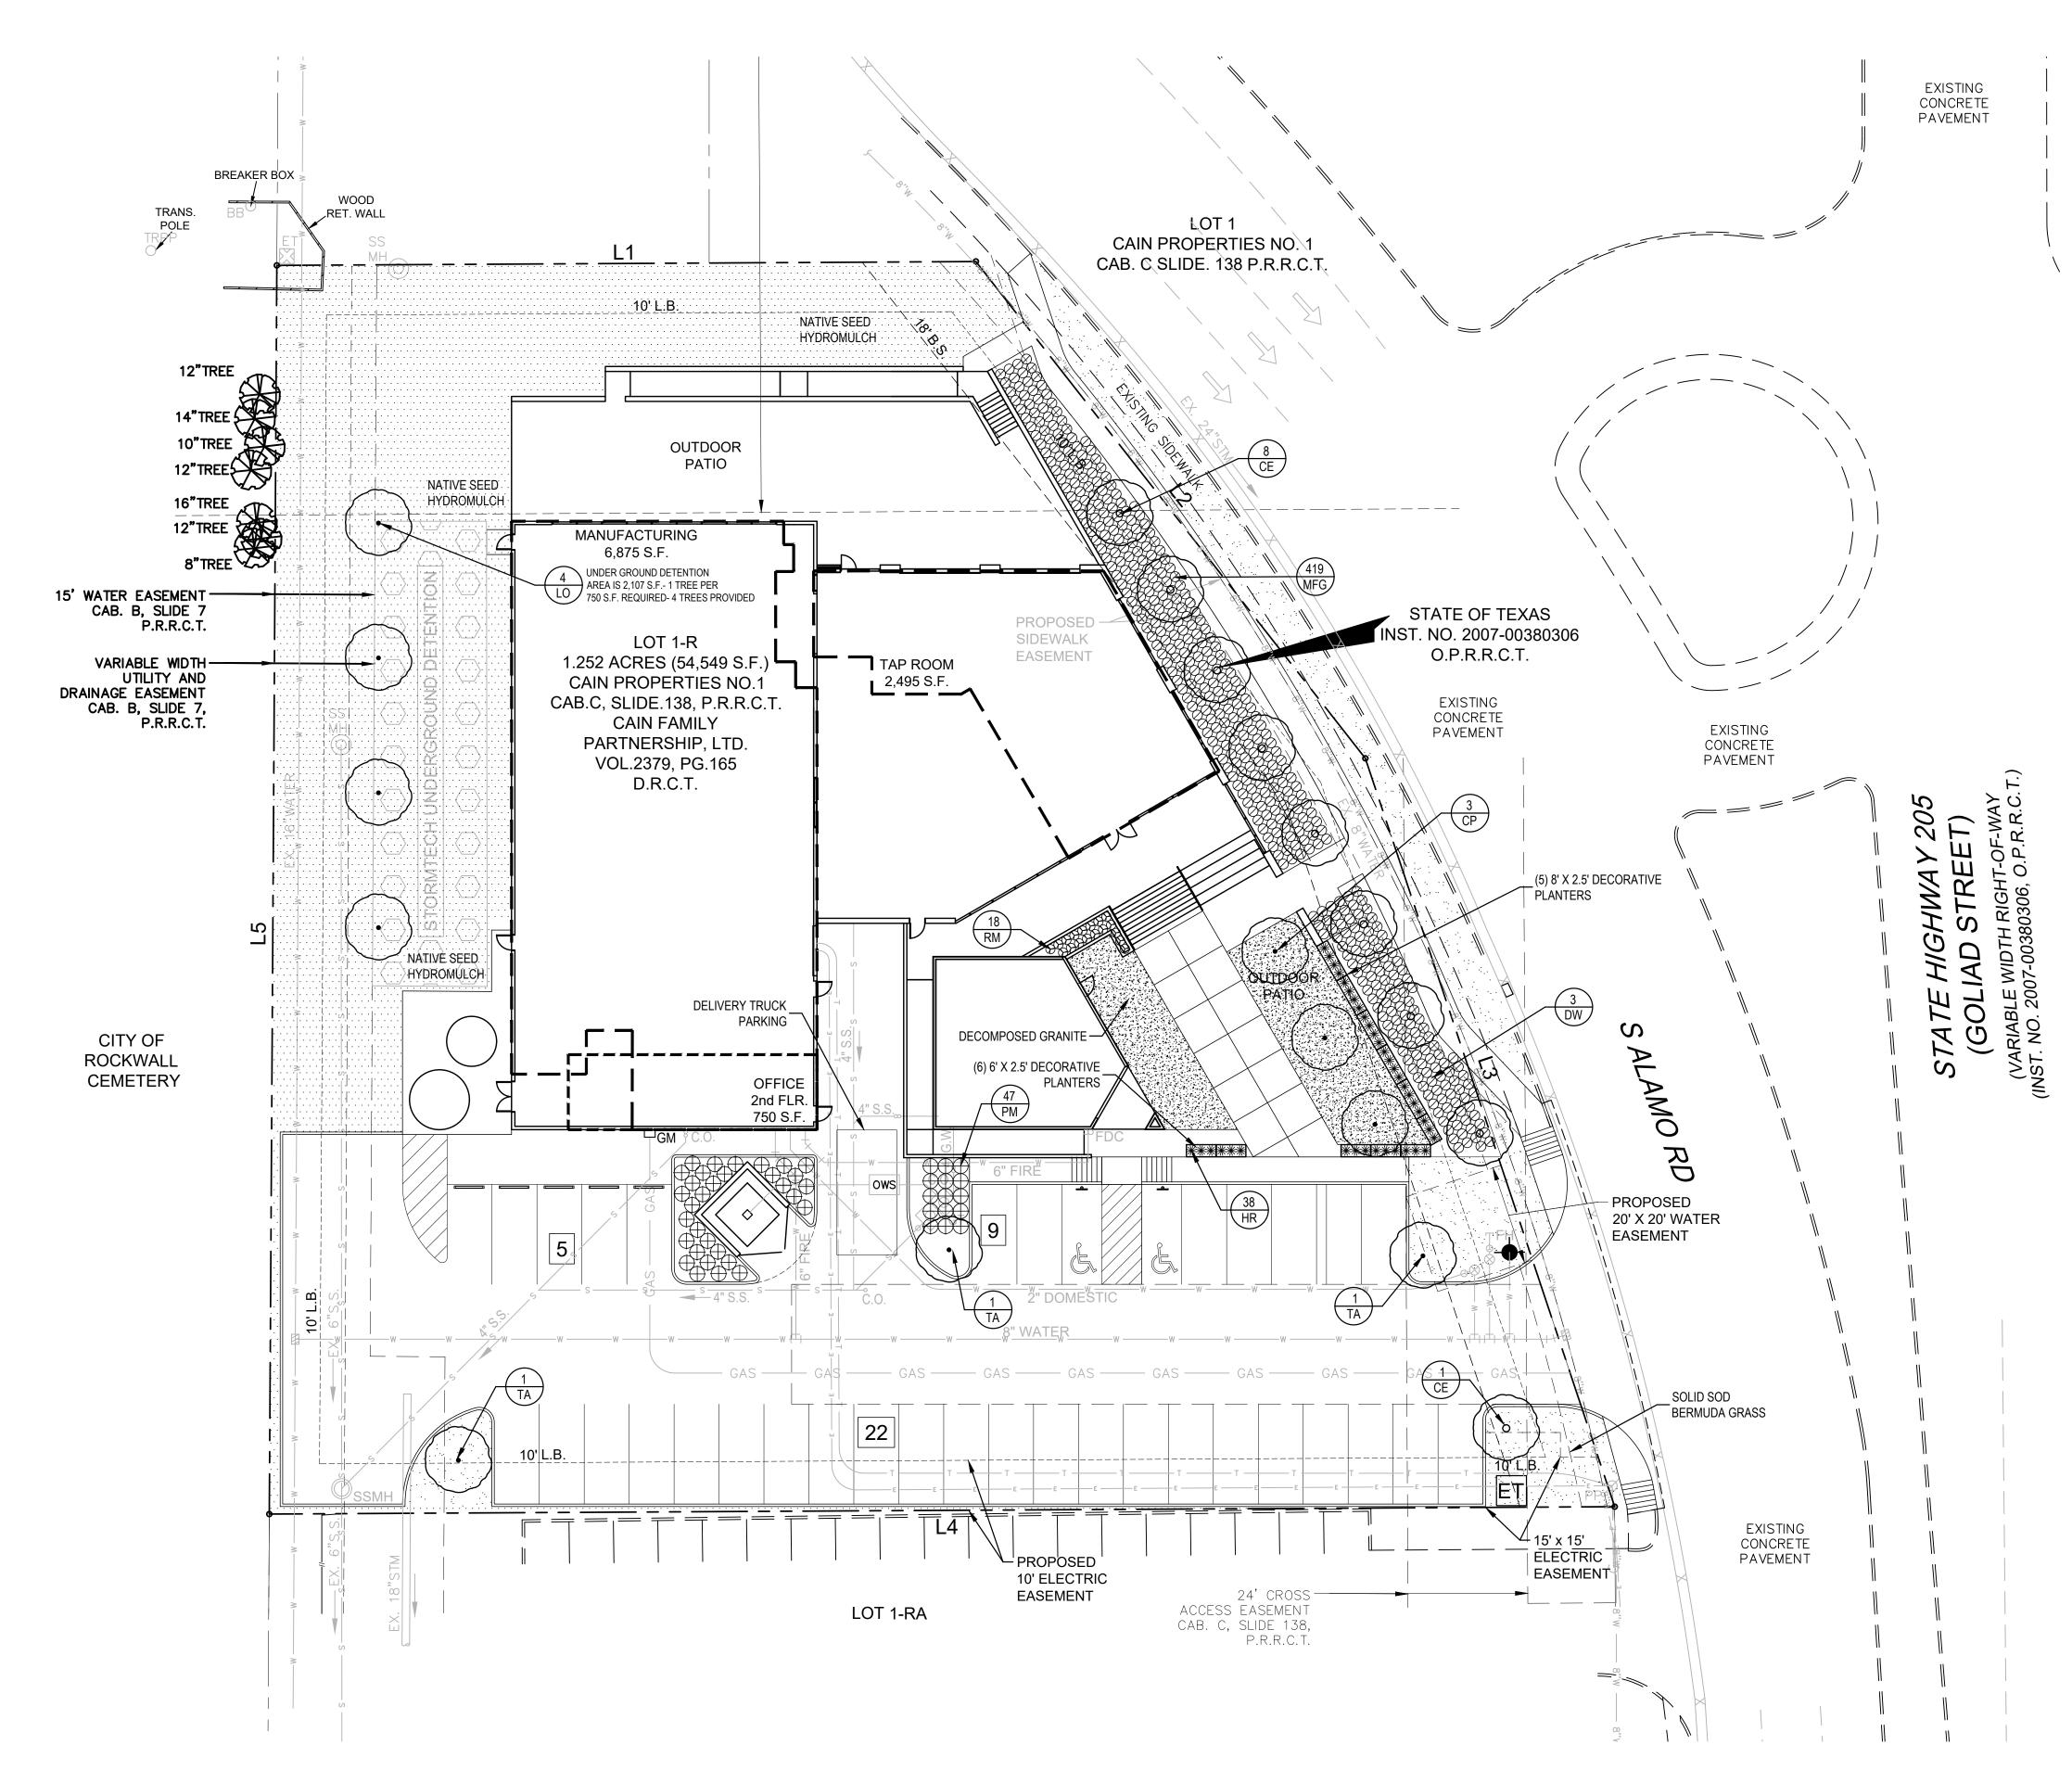

GENERAL LAWN NOTES

- 1. FINE GRADE AREAS TO ACHIEVE FINAL CONTOURS INDICATED ON CIVIL
- ADJUST CONTOURS TO ACHIEVE POSITIVE DRAINAGE AWAY FROM BUILDINGS. PROVIDE UNIFORM ROUNDING AT TOP AND BOTTOM OF SLOPES AND OTHER BREAKS IN GRADE. CORRECT IRREGULARITIES AND AREAS WHERE WATER MAY STAND.
- ALL LAWN AREAS TO RECEIVE SOLID SOD SHALL BE LEFT IN A MAXIMUM OF 1" BELOW FINAL FINISH GRADE. CONTRACTOR TO COORDINATE OPERATIONS WITH ON-SITE CONSTRUCTION MANAGER.
- 4. IMPORTED TOPSOIL SHALL BE NATURAL, FRIABLE SOIL FROM THE REGION, KNOWN AS BOTTOM AND SOIL, FREE FROM LUMPS, CLAY, TOXIC SUBSTANCES, ROOTS, DEBRIS, VEGETATION, STONES, CONTAINING NO SALT AND BLACK TO BROWN IN COLOR.
 - ALL LAWN AREAS TO BE FINE GRADED, IRRIGATION TRENCHES
 COMPLETELY SETTLED, AND FINISH GRADE APPROVED BY THE OWNER'S
 CONSTRUCTION MANAGER OR ARCHITECT PRIOR TO INSTALLATION.
- ALL ROCKS 3/4" DIAMETER AND LARGER, DIRT CLODS, STICKS, CONCRETE SPOILS, ETC. SHALL BE REMOVED PRIOR TO PLACING TOPSOIL AND ANY LAWN INSTALLATION
- CONTRACTOR SHALL PROVIDE (1") ONE INCH OF IMPORTED TOPSOIL ON ALL AREAS TO RECEIVE LAWN.

SOLID SOD NOTES

- 1 FINE GRADE AREAS TO ACHIEVE FINAL CONTOURS INDICATED.
 LEAVE AREAS TO RECEIVE TOPSOIL 3" BELOW FINAL DESIRED
 GRADE IN PLANTING AREAS AND 1" BELOW FINAL GRADE IN TURF
 AREAS.
- 2. ADJUST CONTOURS TO ACHIEVE POSITIVE DRAINAGE AWAY FROM BUILDINGS. PROVIDE UNIFORM ROUNDING AT TOP AND BOTTOM OF SLOPES AND OTHER BREAKS IN GRADE. CORRECT IRREGULARITIES AND AREAS WHERE WATER MAY STAND.
- 3. ALL LAWN AREAS TO RECEIVE SOLID SOD SHALL BE LEFT IN A MAXIMUM OF 1" BELOW FINAL FINISH GRADE. CONTRACTOR TO COORDINATE OPERATIONS WITH ON-SITE CONSTRUCTION MANAGER
- 4. CONTRACTOR TO COORDINATE WITH ON-SITE CONSTRUCTION MANAGER FOR AVAILABILITY OF EXISTING TOPSOIL.
- 5. PLANT SOD BY HAND TO COVER INDICATED AREA COMPLETELY. INSURE EDGES OF SOD ARE TOUCHING. TOP DRESS JOINTS BY HAND WITH TOPSOIL TO FILL VOIDS.
- 6. ROLL GRASS AREAS TO ACHIEVE A SMOOTH, EVEN SURFACE, FREE FROM UNNATURAL UNDULATIONS.
- . WATER SOD THOROUGHLY AS SOD OPERATION PROGRESSES.
- 8. CONTRACTOR SHALL MAINTAIN ALL LAWN AREAS UNTIL FINAL ACCEPTANCE. THIS SHALL INCLUDE, BUT NOT LIMITED TO: MOWING, WATERING, WEEDING, CULTIVATING, CLEANING AND REPLACING DEAD OR BARE AREAS TO KEEP PLANTS IN A VIGOROUS, HEALTHY CONDITION.
- 9. CONTRACTOR SHALL GUARANTEE ESTABLISHMENT OF AN ACCEPTABLE TURF AREA AND SHALL PROVIDE REPLACEMENT FROM LOCAL SUPPLY IF NECESSARY.
- 10. IF INSTALLATION OCCURS BETWEEN SEPTEMBER 1 AND MARCH 1, ALL SOD AREAS TO BE OVER-SEEDED WITH WINTER RYEGRASS, AT A RATE OF (4) POUNDS PER ONE THOUSAND (1000) SQUARE FEET.

LANDSCAPE NOTES

- IVIL 1. CONTRACTOR SHALL VERIFY ALL EXISTING AND PROPOSED SITE ELEMENTS AND NOTIFY ARCHITECT OF ANY DISCREPANCIES.
 SURVEY DATA OF EXISTING CONDITIONS WAS SUPPLIED BY OTHERS.
 - 2. CONTRACTOR SHALL LOCATE ALL EXISTING UNDERGROUND UTILITIES AND NOTIFY ARCHITECT OF ANY CONFLICTS. CONTRACTOR SHALL EXERCISE CAUTION WHEN WORKING IN THE VICINITY OF UNDERGROUND UTILITIES.
 - 3. CONTRACTOR IS RESPONSIBLE FOR OBTAINING ALL REQUIRED LANDSCAPE AND IRRIGATION PERMITS.
 - 4. CONTRACTOR TO PROVIDE A MINIMUM 2% SLOPE AWAY FROM ALL STRUCTURES.
 - 5. ALL PLANTING BEDS AND LAWN AREAS TO BE SEPARATED BY STEEL EDGING. NO STEEL TO BE INSTALLED ADJACENT TO SIDEWALKS OR
 - 6. ALL LANDSCAPE AREAS TO BE 100% IRRIGATED WITH AN UNDERGROUND AUTOMATIC IRRIGATION SYSTEM AND SHALL INCLUDE RAIN AND FREEZE SENSORS.
 - 7. ALL LAWN AREAS TO BE SOLID SOD BERMUDAGRASS, UNLESS OTHERWISE NOTED ON THE DRAWINGS.

LANDSCAPE ARCHITECT
STUDIO GREEN SPOT, INC.
1784 W. McDERMOTT DR.
SUITE 110
ALLEN, TEXAS 75013
(469) 369-4448
CHRIS@STUDIOGREENSPOT.COM



PLANT MATERIAL SCHEDULE

IKEES					
TYPE	QTY	COMMON NAME	BOTANICAL NAME	SIZE	REMARKS
CE CP DW LO TA	9 3 3 4 3	Cedar Elm Chinese Pistache Desert Willow Live Oak Texas Ash	Ulmus crassifolia Chinese pistache Chilopsis linearis Quercus virginiana Fraxinus albicans	3" cal. 5" cal. 8' ht. 3" cal. 3" cal.	B&B, 13' ht., 5' spread min., 5' clear trunk B&B. 15' ht., 6' spread, 6' clear trunk container 3 or 5 trucks, tree form container, 12' ht., 4' spread, 5' clear straight trunk container, 12' ht., 4' spread, 5' clear straight trunk
		TOXAG FIOT	Traxinas aibisans	o dan	Softanioi, 12 Ita, 1 oprodu, 0 clod otraight traint
SHRUBS					
TYPE	QTY.	COMMON NAME	BOTANICAL NAME	SIZE	REMARKS
HR MFG PM RM	38 419 47 18	Horestail Reed Mexican Feather Grass Pink Muhly Grass Prostrate Rosemary	Equisetum hyemale Nassella tenuissima Muhlenbergia capillaris Rosmarinus officinalis 'Prostratus'	3 gal. 3 gal. 3 gal. 3 gal.	container full, well rooted container full, well rooted container full, well rooted container, 12" ht., 18" spread
GROUNI	DCOVERS				
TYPE	QTY	COMMON NAME	BOTANICAL NAME	SIZE	REMARKS
		'419' Bermudagrass	Cynodon dactylon '419'		Solid Sod refer to notes

NOTE: Plant list is an aid to bidders only. Contractor shall verify all quantities on plan. All heights and spreads are minimums. All plant material shall meet or exceed remarks as indicated. All trees to have straight trunks and be matching within varieties.

NO TREE TO BE PLANTED WITHIN 5 FEET OF ANY UTILITY LINE

CASE# SP2018-038

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BREWIN

SIREN ROCK

ISSUE:

FOR REVIEW 11.14.2018

CITY COMMENTS 12.03.2018

DATE: 12.03.2018

SHEET NAME: LANDSCAPE PLAN

SHEET NUMBER:

_.2

EXISTING TREE NOTES

- Existing trees to remain shall be protected during construction from tree structure damage and compaction of soil under and around dripline (canopy) of tree.
- If any root structure is damaged during adjacent excavation/construction, notify the Architect immediately. It is recommended that a licensed Arborist be secured for the treatment of any possible tree wounds.
- 3. No disturbance of the soil greater than 4" shall be located closer to the tree trunk than 1/2 the distance of the drip line to the tree trunk. A minimum of 75% of the drip line and root zone shall be preserved at natural grade.
- 4. Any fine grading done within the critical root zones of the protected trees must be done with light machinery such as a bobcat or light tractor. No earth moving equipment with tracks is allowed within the critical root zone of the trees.
- 5. Material Storage: No materials intended for use in construction or waste materials accumulated due to excavation or demolition shall be placed within the limits of the dripline of any tree.
- Equipment Cleaning/Liquid Disposal: No equipment may be cleaned, toxic solutions, or other liquid chemicals shall be deposited within the limits of the dripline of a tree. This would include but not be limited to paint, oil, solvents, asphalt, concrete, mortar, primers, etc.
- 7. Tree Attachments: No signs, wires or other attachments, other than those of a protective nature shall be attached to any tree.
- 8. Vehicular Traffic: No vehicular and construction equipment traffic or parking is allowed within the limits of the dripline of trees.
- 9. Boring of Utilities: May be permitted under protected trees in certain circumstances. The minimum length of the bore shall be the width of the tree's canopy and shall be a minimum depth of forty-eight (48") inches.
- 10. Trenching: Any irrigation trenching which must be done within the critical root zone of a tree shall be dug by hand and enter the area in a radial manner.
- 11. Tree Flagging: All trees to be removed from the site shall be flagged by the Contractor with bright red vinyl tape (3" width) wrapped around the main trunk at a height of four (4') feet above grade. Flagging shall be approved by Landscape Architect prior to any tree removal. Contractor shall contact Landscape Architect with 72 hour notice to schedule on-site meeting.
- 12. Protective Fencing: All trees to remain, as noted on drawings, shall have protective fencing located at the tree's dripline. The protective fencing may be comprised of snow fencing, orange vinyl construction fencing, chain link fence or other similar fencing with a four (4') foot approximate height. The protective fencing will be located as indicated on the Tree Protection Detail(s).
- 13. Bark Protection: In situations where a tree remains in the immediate area of intended construction, the tree shall be protected by enclosing the entire circumference of the tree's trunk with lumber encircled with wire or other means that does not damage the tree. Refer to Tree Protection Detail(s).
- 14. Construction Pruning: In a case where a low hanging limb is broken during the course of construction, the Contractor shall notify the Landscape Architect immediately. In no instance shall the Contractor prune any portion of the damaged tree without the prior approval by the Landscape Architect.

TREE SURVEY FIELD DATA

NO.	DIA. INCHES	SPECIES (COMMON NAME)	REMARKS
1 2 3 4 5 6 7 8	20 14 14 20 14 16 6 10	ELM ELM HACKBERRY ELM HACKBERRY HACKBERRY HACKBERRY ELM	PROTECTED TO BE REMOVED PROTECTED TO BE REMOVED PROTECTED TO BE REMOVED
10 11 12 13	12 12 14 6 6	HACKBERRY ELM HACKBERRY HACKBERRY HACKBERRY	TO BE REMOVED PROTECTED TO BE REMOVED TO BE REMOVED TO BE REMOVED TO BE REMOVED

99 CALIPER INCHES OF TREES TO BE REMOVED 63 CALIPER INCHES TO BE PLANTED BACK ON SITE AN ADDITIONAL 31 CALIPER INCHES WILL BE PLANTED OR PAID INTO THE CITY FUND (36 X \$100.00=\$3,600)

NO TREE TO BE PLANTED WITHIN 5 FEET OF ANY UTILITY LINE

EXISTING TREE LEGEND



EXISTING TREE TO REMAIN



Y EXISTING TREE

TO BE REMOVED

TREE PROTECTION FENCING
TO REMAIN DURING CONSTRUCTION
REFER TO 01/L1.00

01 TREE PRESERVATION PLAN
SCALE 1"=20'-0"

10 20 40

LANDSCAPE ARCHITECT
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SIREN ROCK BREWING (

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CASE# SP2018-038

ISSUE:

FOR REVIEW 11.15.2018

CITY COMMENTS 12.03.2018

DATE:

SHEET NAME: TREE PRESERVATION PLAN

SHEET NUMBER:

_.1

12.03.2018



MUNN HARRIS

ARCHITECTS 5646 MILTON STREET STE.437, DALLAS, TX 75206 P.214.841.9090 WWW.MUNNHARRIS.COM

CONSULTANTS

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STRUCTURAL ENGINEERING Cory W. Potts, P.E. Lobsinger & Potts Engineering, INC 1723 E. Southlake Blvd., Ste. 200 Southlake, Texas 76092 817.488.9933

MEP ENGINEERING: George Hammons T. Tabor Consulting, PLLC 1301 East Debbie Lane Suite 102-152 Mansfield, Texas 76063

817.229.1839 BREWING EQUIPMENT SUPPLIER: Brad Perkinson American Beer Equipment 2001 SW 6th Street

Lincoln, Nebraska 68522 402.441.4784

> REWIN $\underline{\Upsilon}$

MUNN HARRIS PROJECT #:

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PROFESSIONAL OF RECORD PHONE: 214-841-9090

REVISION

DRAWN BY: CHECKED BY:

ORIG. DATE: REV. ISSUE DATE: 00/00/18 ISSUED FOR:

CONTENTS: PHOTOMETRIC LIGHTING PLAN