



Nassif Engineering & Architecture, LLC



TXBPE Registration No.: F-16335 TBAE Registration No.: BR400 Copyright 2015 Nassif Engineering

& Architecture, LLC

ISSUED FOR DEVELOPMENT REVIEW

> **STERLING MANAGEMENT GROUP, LLC**

SUMMER LEE CONDOMINIUMS

ROCKWALL, TX 75032

15-118

Project Number: Drawing Date: 3/3/2015

Checked:

AS SHOWN

Copyright 2015 Strohmeyer Architects, Inc.


Revisions:

3/3/2015 - Revisions per Rockwall Development Review (2/16/2015)

Sheet Title:

SITE PLAN PARKING STRUCTURE LOWER LEVEL

C-101

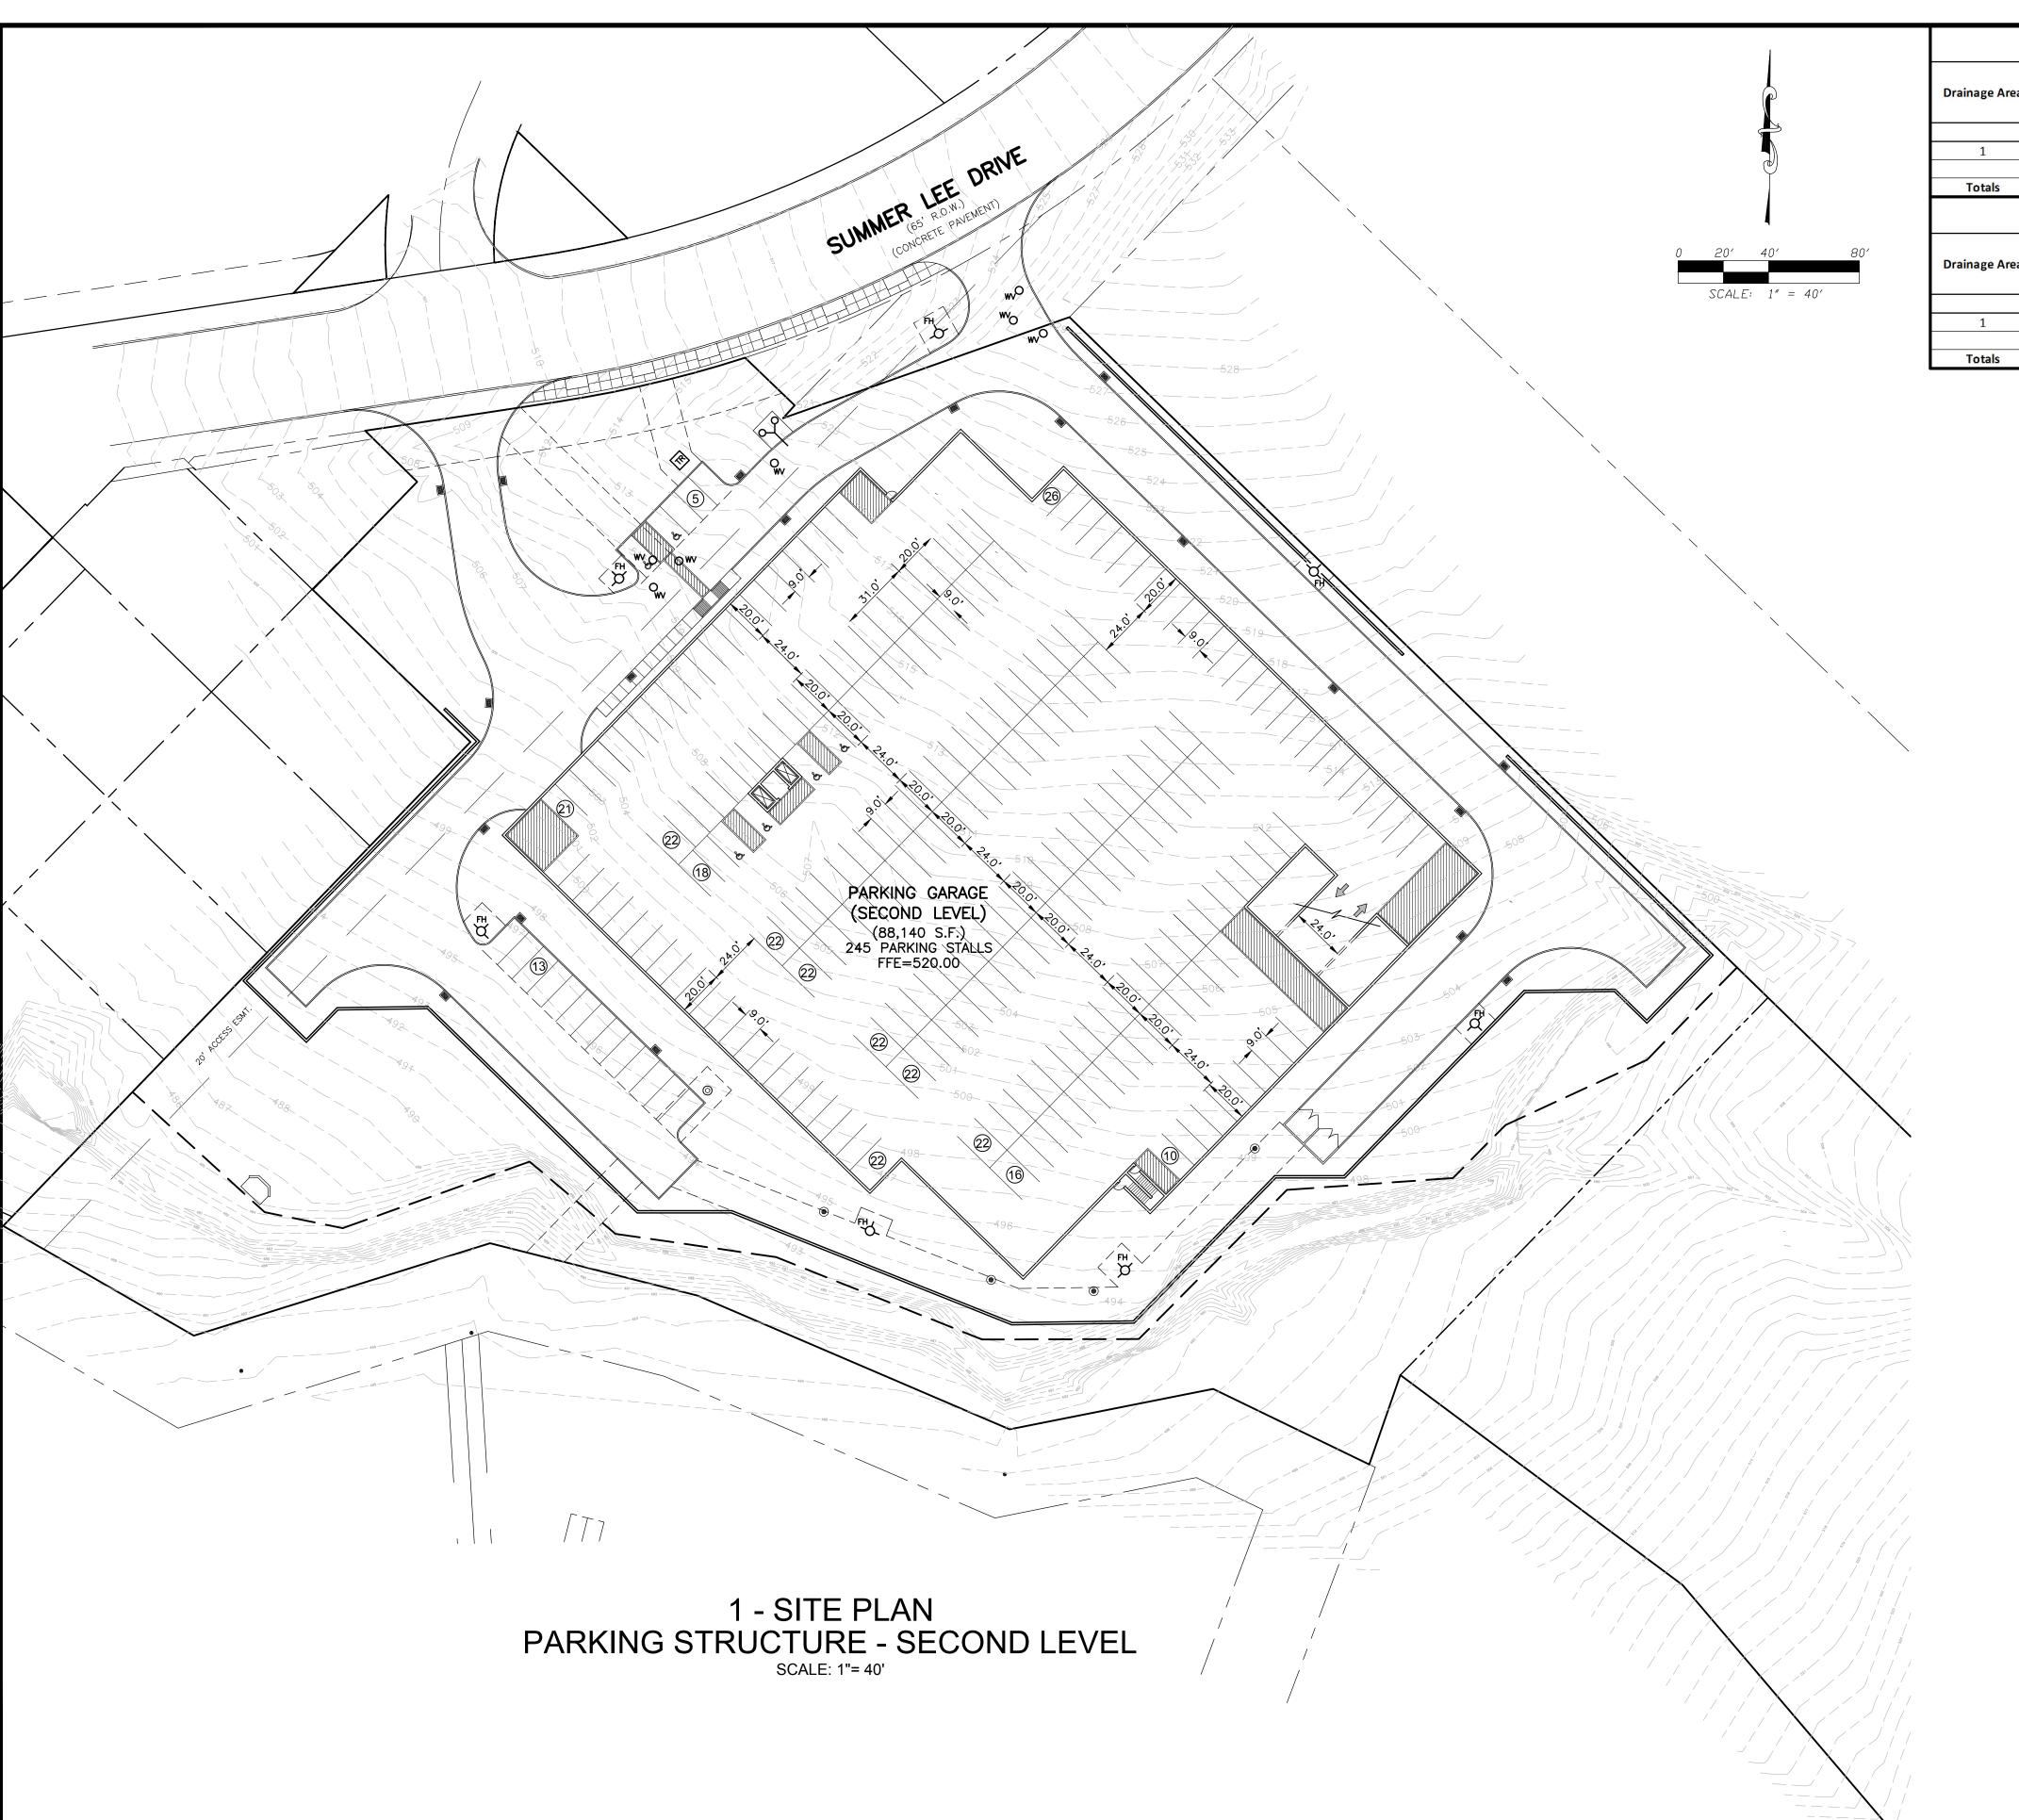

	Pre-Development Drainage Calculations					
Drainage Area	Area (acres)	Runoff Coefficient Coefficient Time of Concentration (minutes)		Intensity (in./hr.) 100-year	Runoff (c.f.s) 100-year	
	Α	С	Tc	l100	Q100	
1	5.32	0.35	20	8.40	15.64	
Totals					15.64	

Post-Development Drainage Calculations

Drainage Area	Area (acres)	Runoff Coefficient Time of Concentration (minutes)		Intensity (in./hr.) 100-year	Runoff (c.f.s) 100-year
	Α	С	Tc	l100	Q100
1	5.32	0.90	10	9.80	46.92
Totals					16 02



Consultants:


Nassif Engineering & Architecture, LLC



TXBPE Registration No. : F-16335 TBAE Registration No. : BR400

Copyright 2015 Nassif Engineering & Architecture, LLC

I S S U E D F O R DEVELOPMENT REVIEW

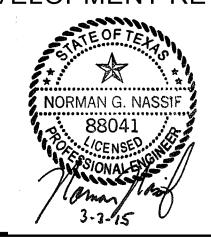

STERLING MANAGEMENT GROUP, LLC

SUMMER LEE CONDOMINIUMS

ROCKWALL, TX 75032

Project Number: Drawing Date:

Date: 2/13/2015

15-118

AS SHOWN

Checked: Scale:

ACAD File: Copyright 2015 Strohmeyer Architects, Inc.

Revisions:


Drawn:

3/3/2015 - Revisions per Rockwall Development Review (2/16/2015)

Sheet Title:

SITE PLAN PARKING STRUCTURE SECOND LEVEL

C-102

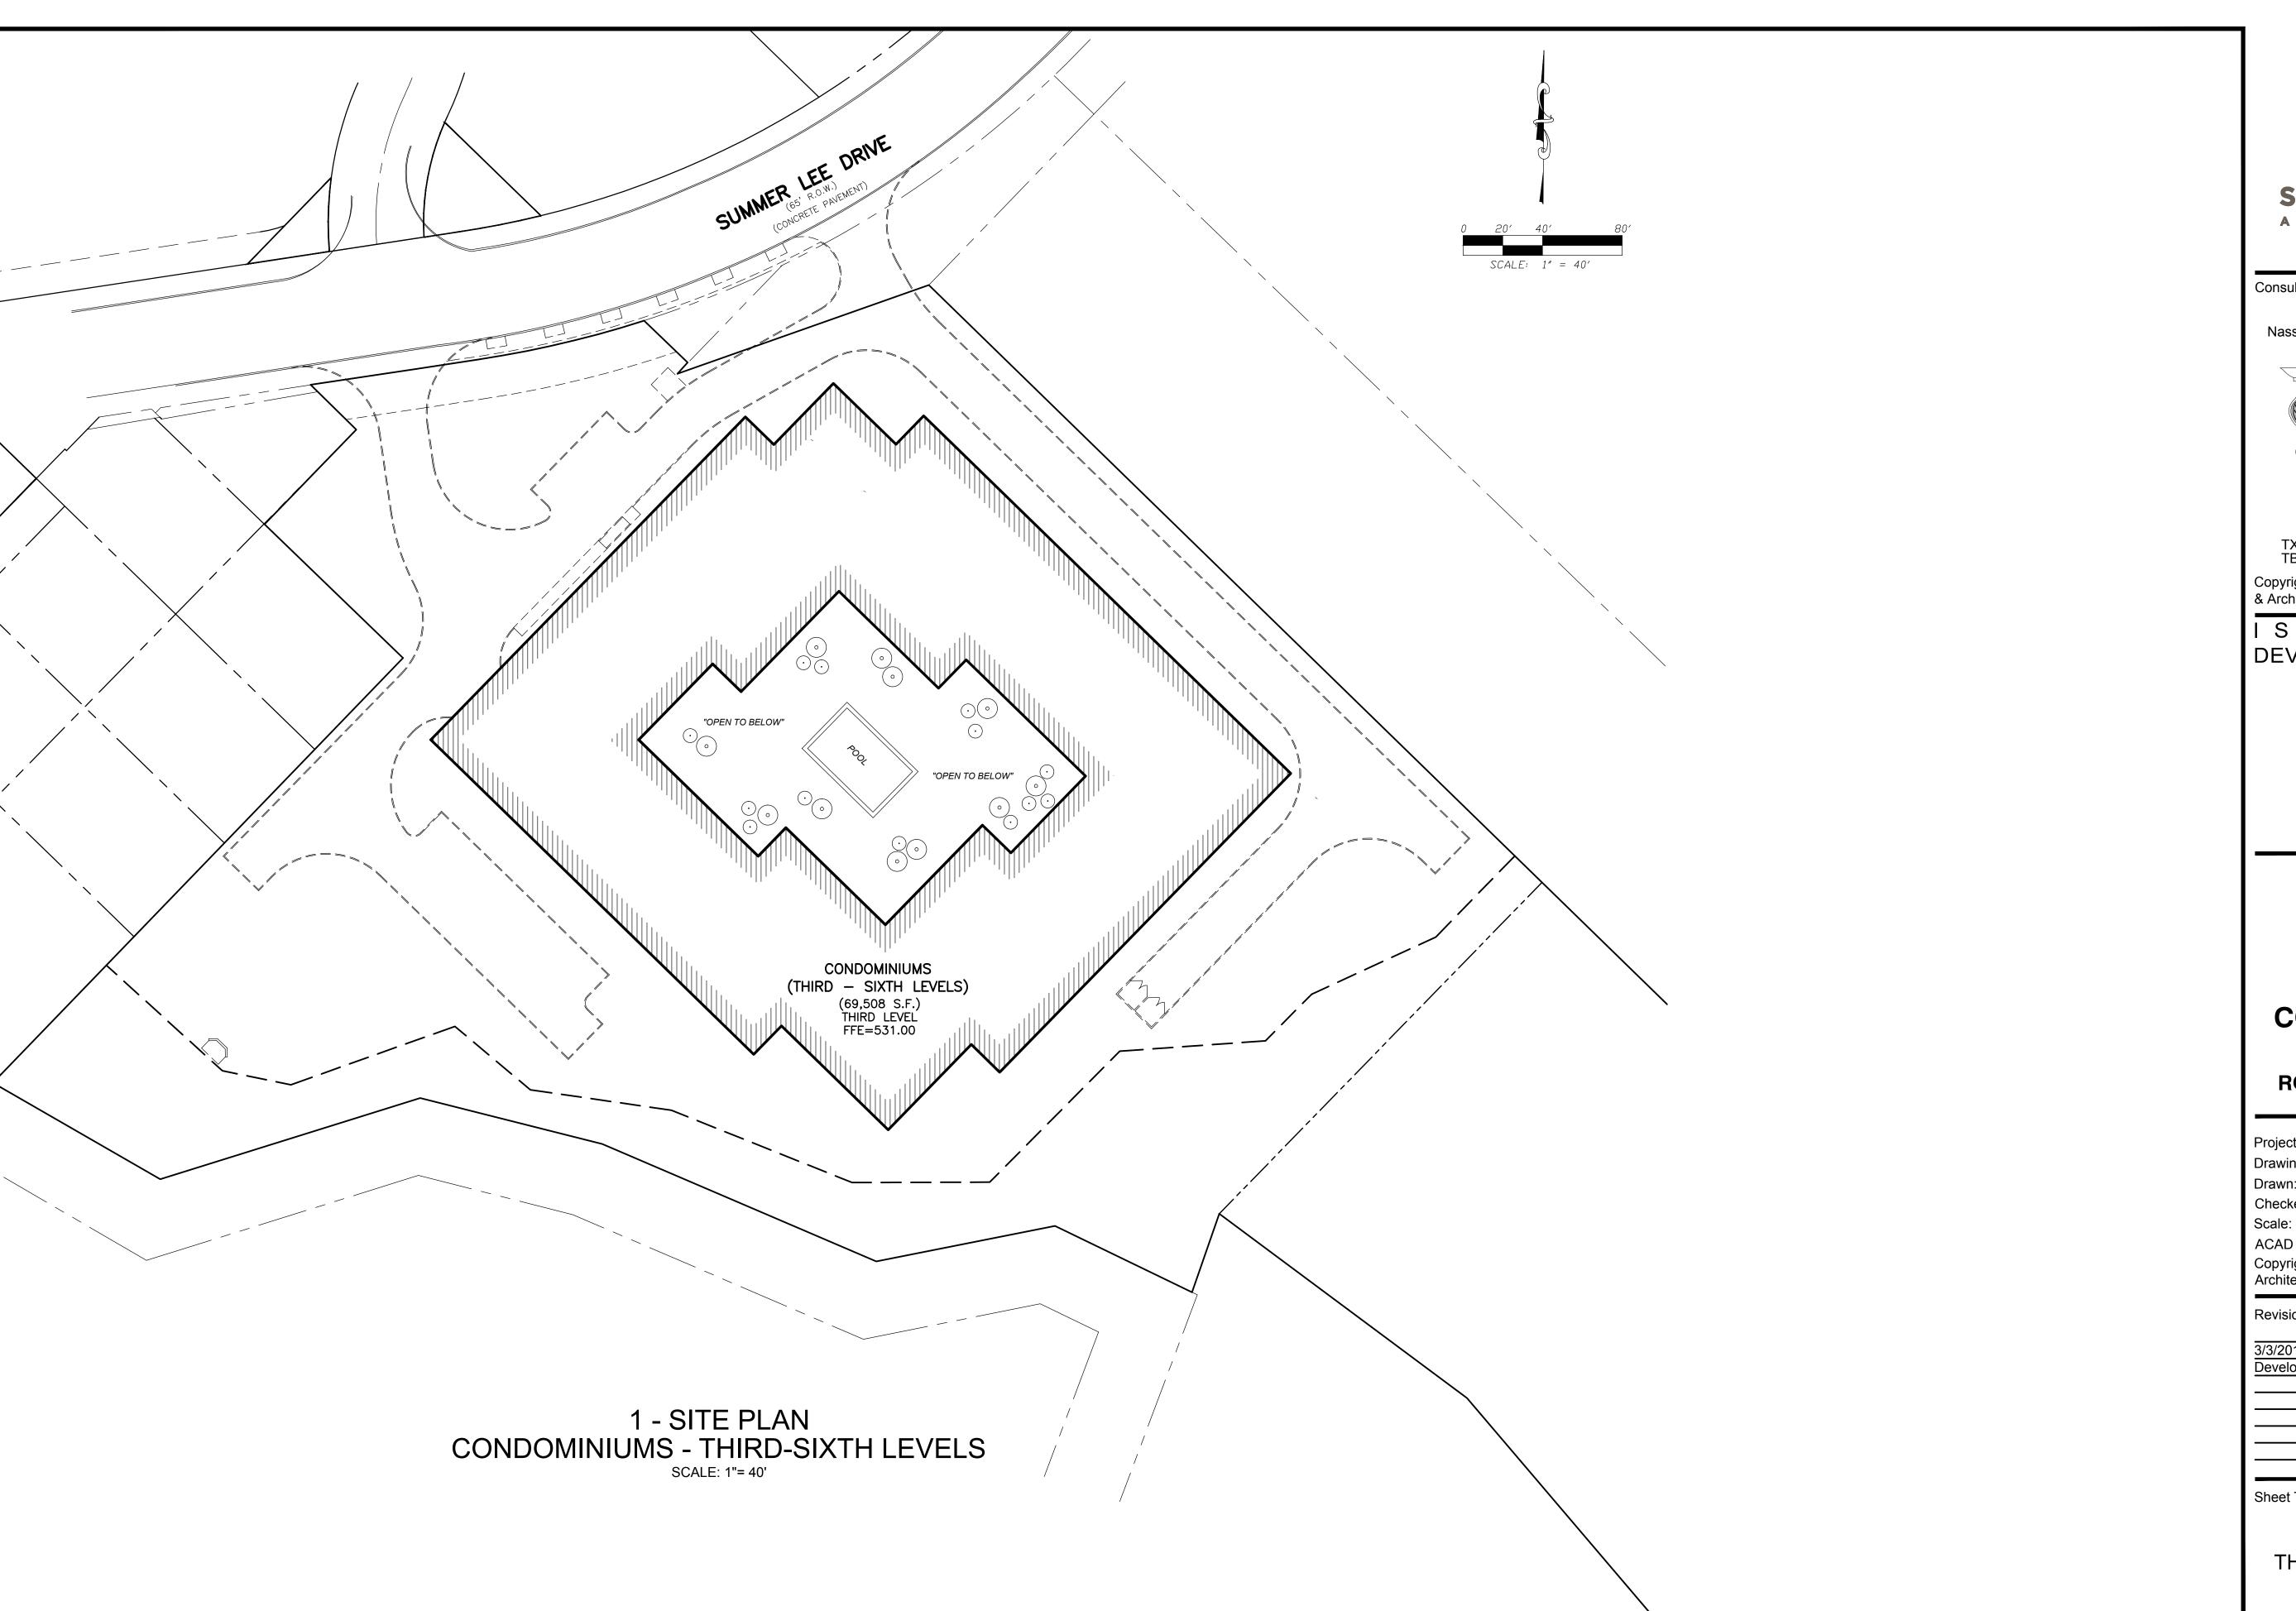




Nassif Engineering & Architecture, LLC



TXBPE Registration No. : F-16335 TBAE Registration No. : BR400

Copyright 2015 Nassif Engineering & Architecture, LLC

ISSUED FOR DEVELOPMENT REVIEW

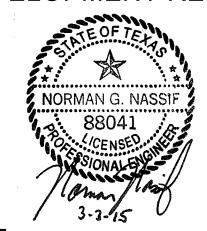

STERLING MANAGEMENT GROUP, LLC

SUMMER LEE CONDOMINIUMS

ROCKWALL, TX 75032

15-118 Project Number: 2/13/2015 Drawing Date:

Drawn: Checked:

AS SHOWN

ACAD File:

Copyright 2015 Strohmeyer Architects, Inc.

Revisions:

3/3/2015 - Revisions per Rockwall Development Review (2/16/2015)

Sheet Title:

SITE PLAN CONDOMINIUMS THIRD - SIXTH LEVELS

C-103

MATERIAL SCHEDULE CLAY TILE ROOFING (C1)- BORAL BUILDING STONE (S1) -3 PART STUCCO COLOR 1 -TEJAS ESPANA -BRAZOS BLEND ELDORADO STONE - MOUNTAIN LEDGE 3 PART STUCCO COLOR 2 -RETAINING WALL - (S2) - AUSTIN STONE 3 PART STUCCO COLOR 3 -ROOF MOUNTED CONDENSER UNITS SCREENED BY ROOF MANSARD 2 EAST ELEVATION SCALE: 1/8" = 1'-0" TOTAL BUILDING WALL HARD SURFACE: 12,841 SF TOTAL STUCCO: 11,043 SF = 86% TOTAL BUILDING STONE: 1,798 SF = 14% ROOF MOUNTED CONDENSER UNITS SCREENED BY ROOF MANSARD ORNAMENTAL ONLY NOT OCCUPIED HIGHEST OCCUPIED FLOOR = 55' HIGHEST OCCUPIED **FLOOR ELEVATION 565** LOWEST FIRE LANE **ELEVATION 510** NORTH ELEVATION - SUMMER LEE 1 | SCALE: 1/8" = 1'-0" TOTAL BUILDING WALL HARD SURFACE: 11,186 SF TOTAL STUCCO: 9,388 SF = 83.93% TOTAL BUILDING STONE: 1,798 SF = 16.07%

- 11:05am _6177/SL-Cor STROHMEYER ARCHITECTS INC.

Consultants:

PRELIMINARY DESIGN

SUMMER LEE CONDOS, LLC

SUMMER LEE CONDOMINIUMS ROCKWALL, TEXAS ROCKWALL COUNTY

Pro	ect	Nur	nbe

Drawing Date:

Drawn:

Checked:

ACAD File: SL-Condos-NE-Elevations.dwg © 2015 Strohmeyer Architects, Inc.

02/13/2015

Revisions:

A Sheet Title:

A201

SP2015-004

3 PART STUCCO COLOR 3 -

BUILDING STONE (S1) ELDORADO STONE - MOUNTAIN LEDGE

RETAINING WALL - (S2) - AUSTIN STONE



CLAY TILE ROOFING (C1)- BORAL TEJAS ESPANA -BRAZOS BLEND





PRELIMINARY DESIGN

SUMMER LEE CONDOS, LLC

Consultants:

2 SOUTH ELEVATION SCALE: 1/8" = 1'-0"

TOTAL BUILDING WALL HARD SURFACE: 11,882 SF
TOTAL PLASTER: 11,272 SF = 95%
TOTAL BUILDING STONE: 610 SF = 5%

1 WEST ELEVATION SCALE: 1/8" = 1'-0"

TOTAL BUILDING WALL HARD SURFACE: 13,054 SF

TOTAL PLUI DING STONE: 1 260 SE -

TOTAL BUILDING STONE: 1,360 SF = 10.4%

SUMMER LEE
CONDOMINIUMS
ROCKWALL, TEXAS
ROCKWALL COUNTY

Pro	ect	Nur	nbe

Drawing Date: Drawn:

Checked:

cale:

© 2015 Strohmeyer Architects, Inc.

ACAD File: SL-Condos-SW-Elevations-030315.dwg

02/13/2015

Revisions:


.

△ Sheet Title:

A-202

SP2015-004

ar 03, 2015 — 11:25am — User: jimmystrohmeyer tmp/AcPublish_6177/SL—Condos—SW—Elevations—030315.dwg

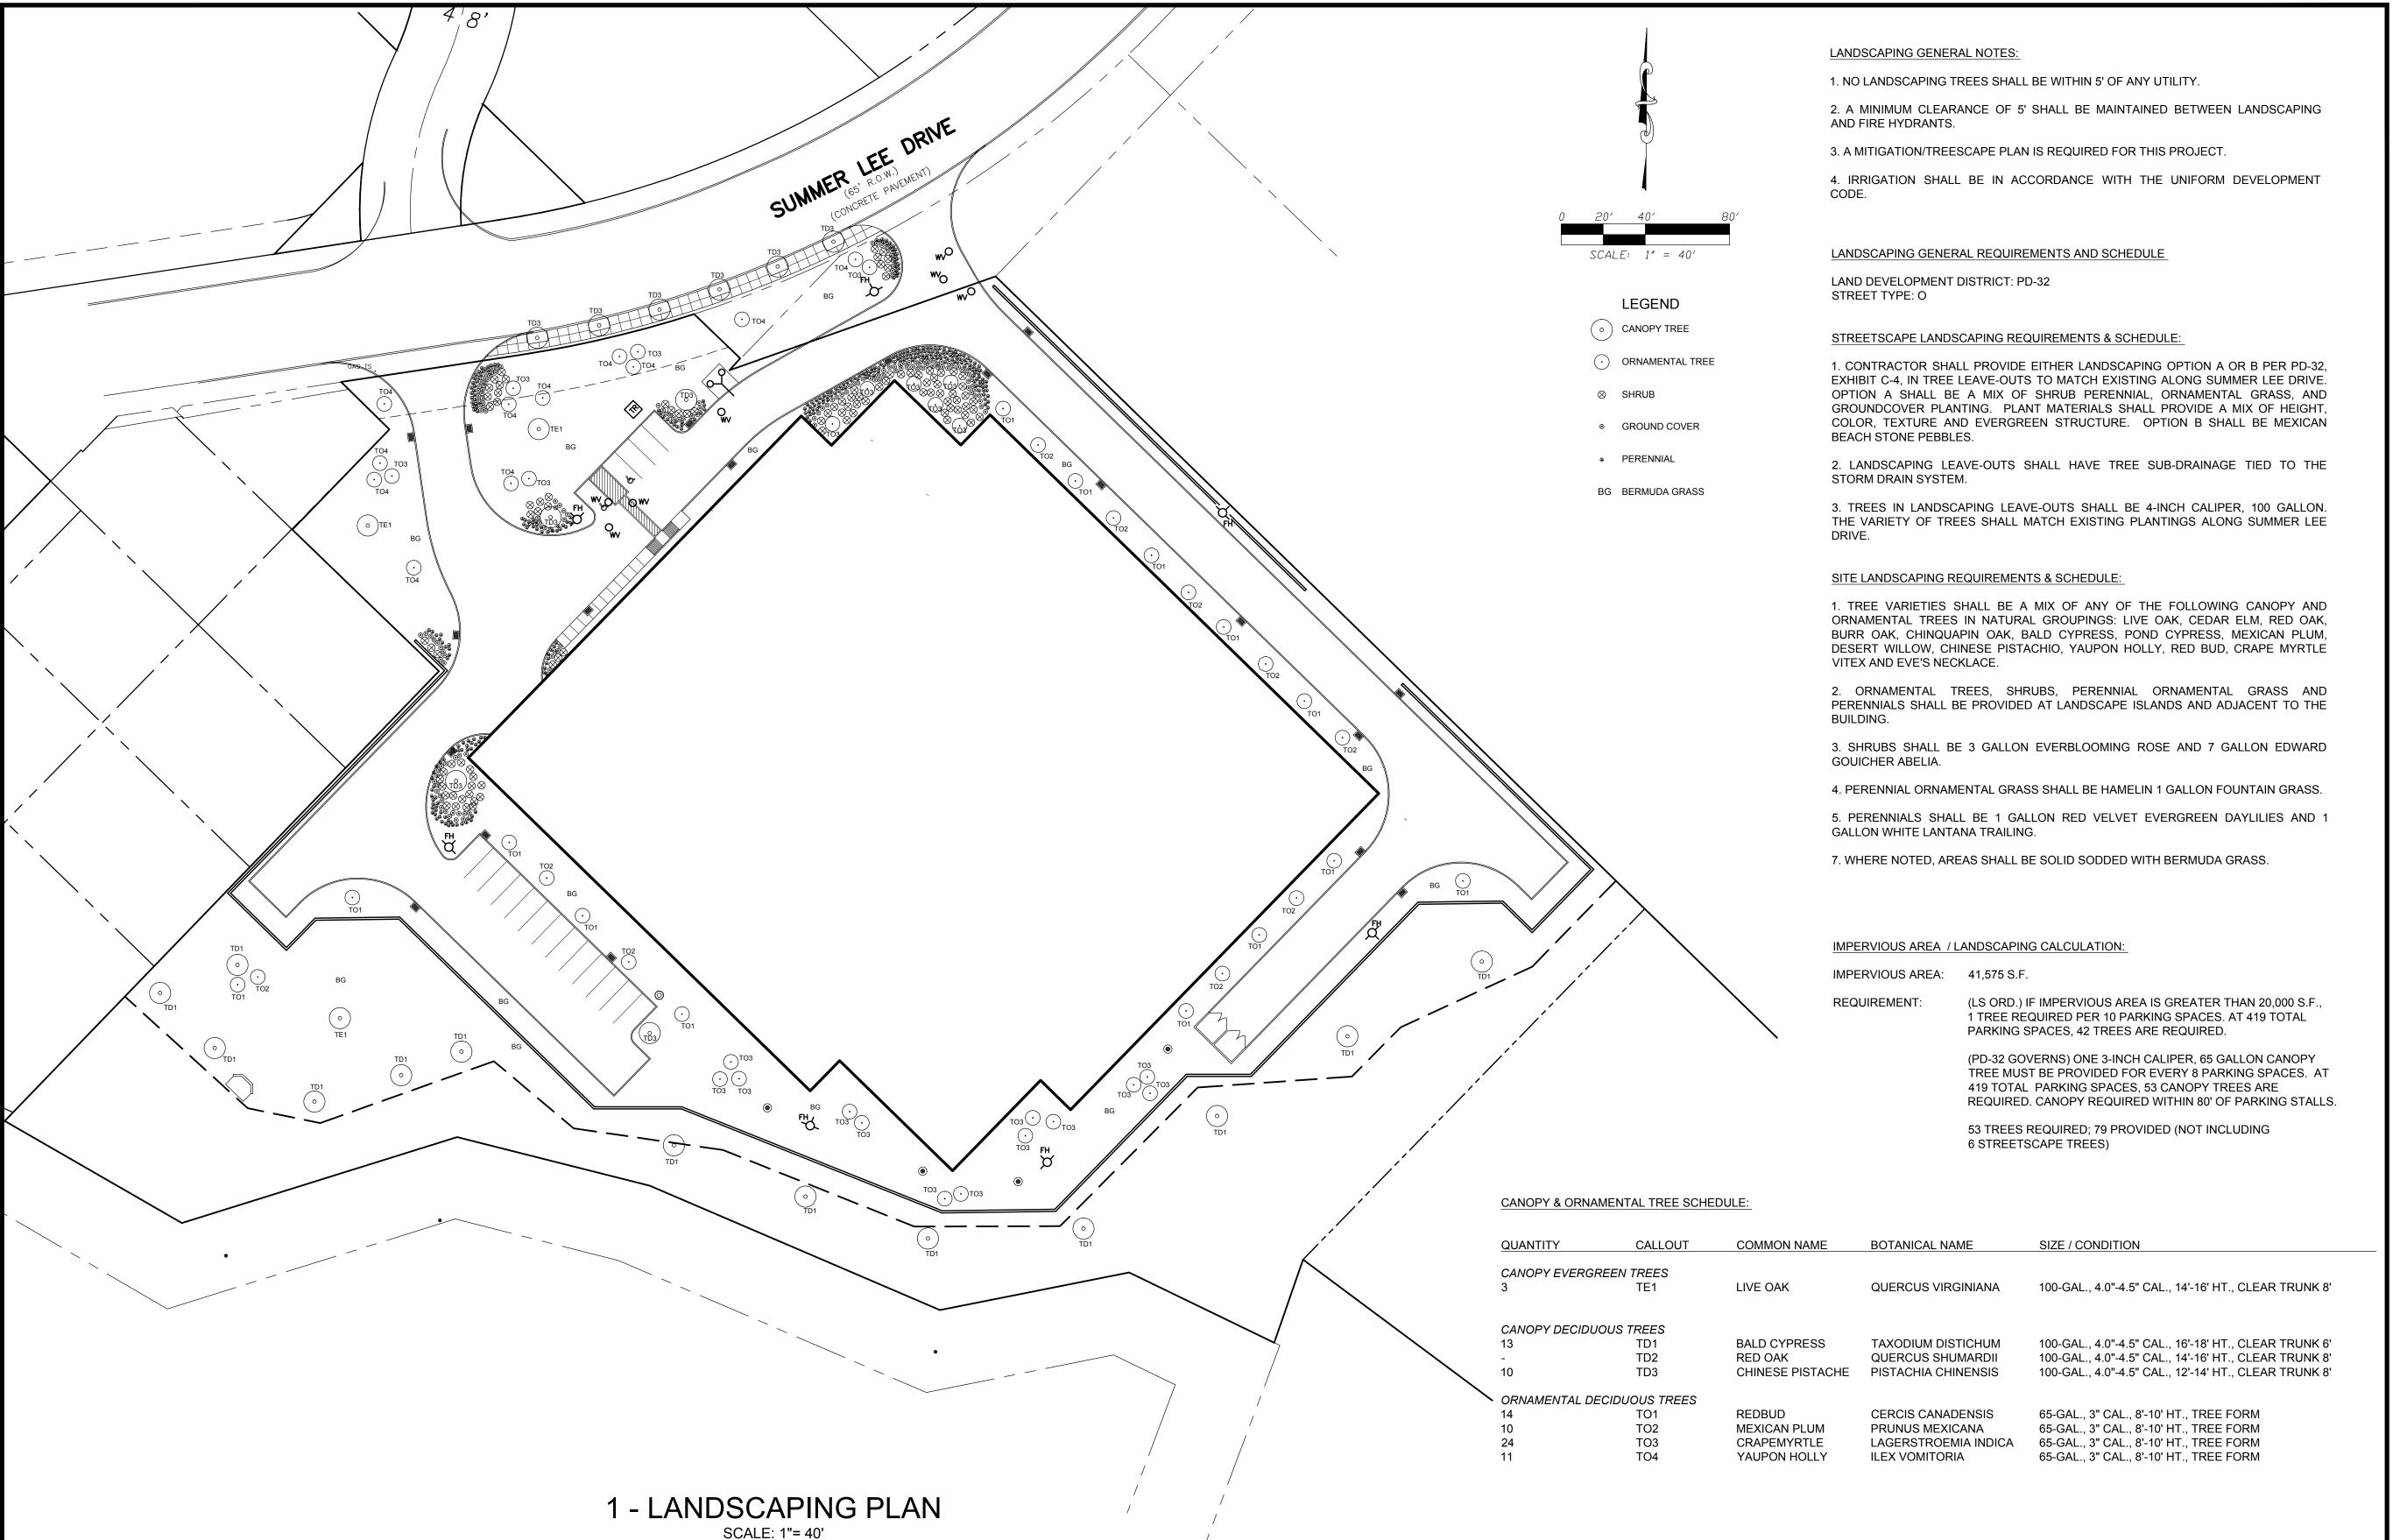




Nassif Engineering & Architecture, LLC



TXBPE Registration No. : F-16335 TBAE Registration No. : BR400

Copyright 2015 Nassif Engineering & Architecture, LLC

ISSUED FOR DEVELOPMENT REVIEW

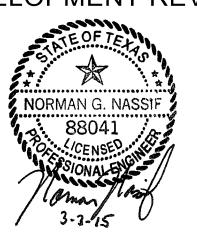

STERLING MANAGEMENT GROUP, LLC

SUMMER LEE CONDOMINIUMS

ROCKWALL, TX 75032

Project Number: 15-118
Drawing Date: 2/13/2015

Drawn: Checked:

AS SHOWN

ACAD File: Copyright 2015 Strohmeyer

Revisions:

Architects, Inc.


Scale:

3/3/2015 - Revisions per Rockwall Development Review (2/16/2015)

Sheet Title:


LANDSCAPING PLAN

L-101

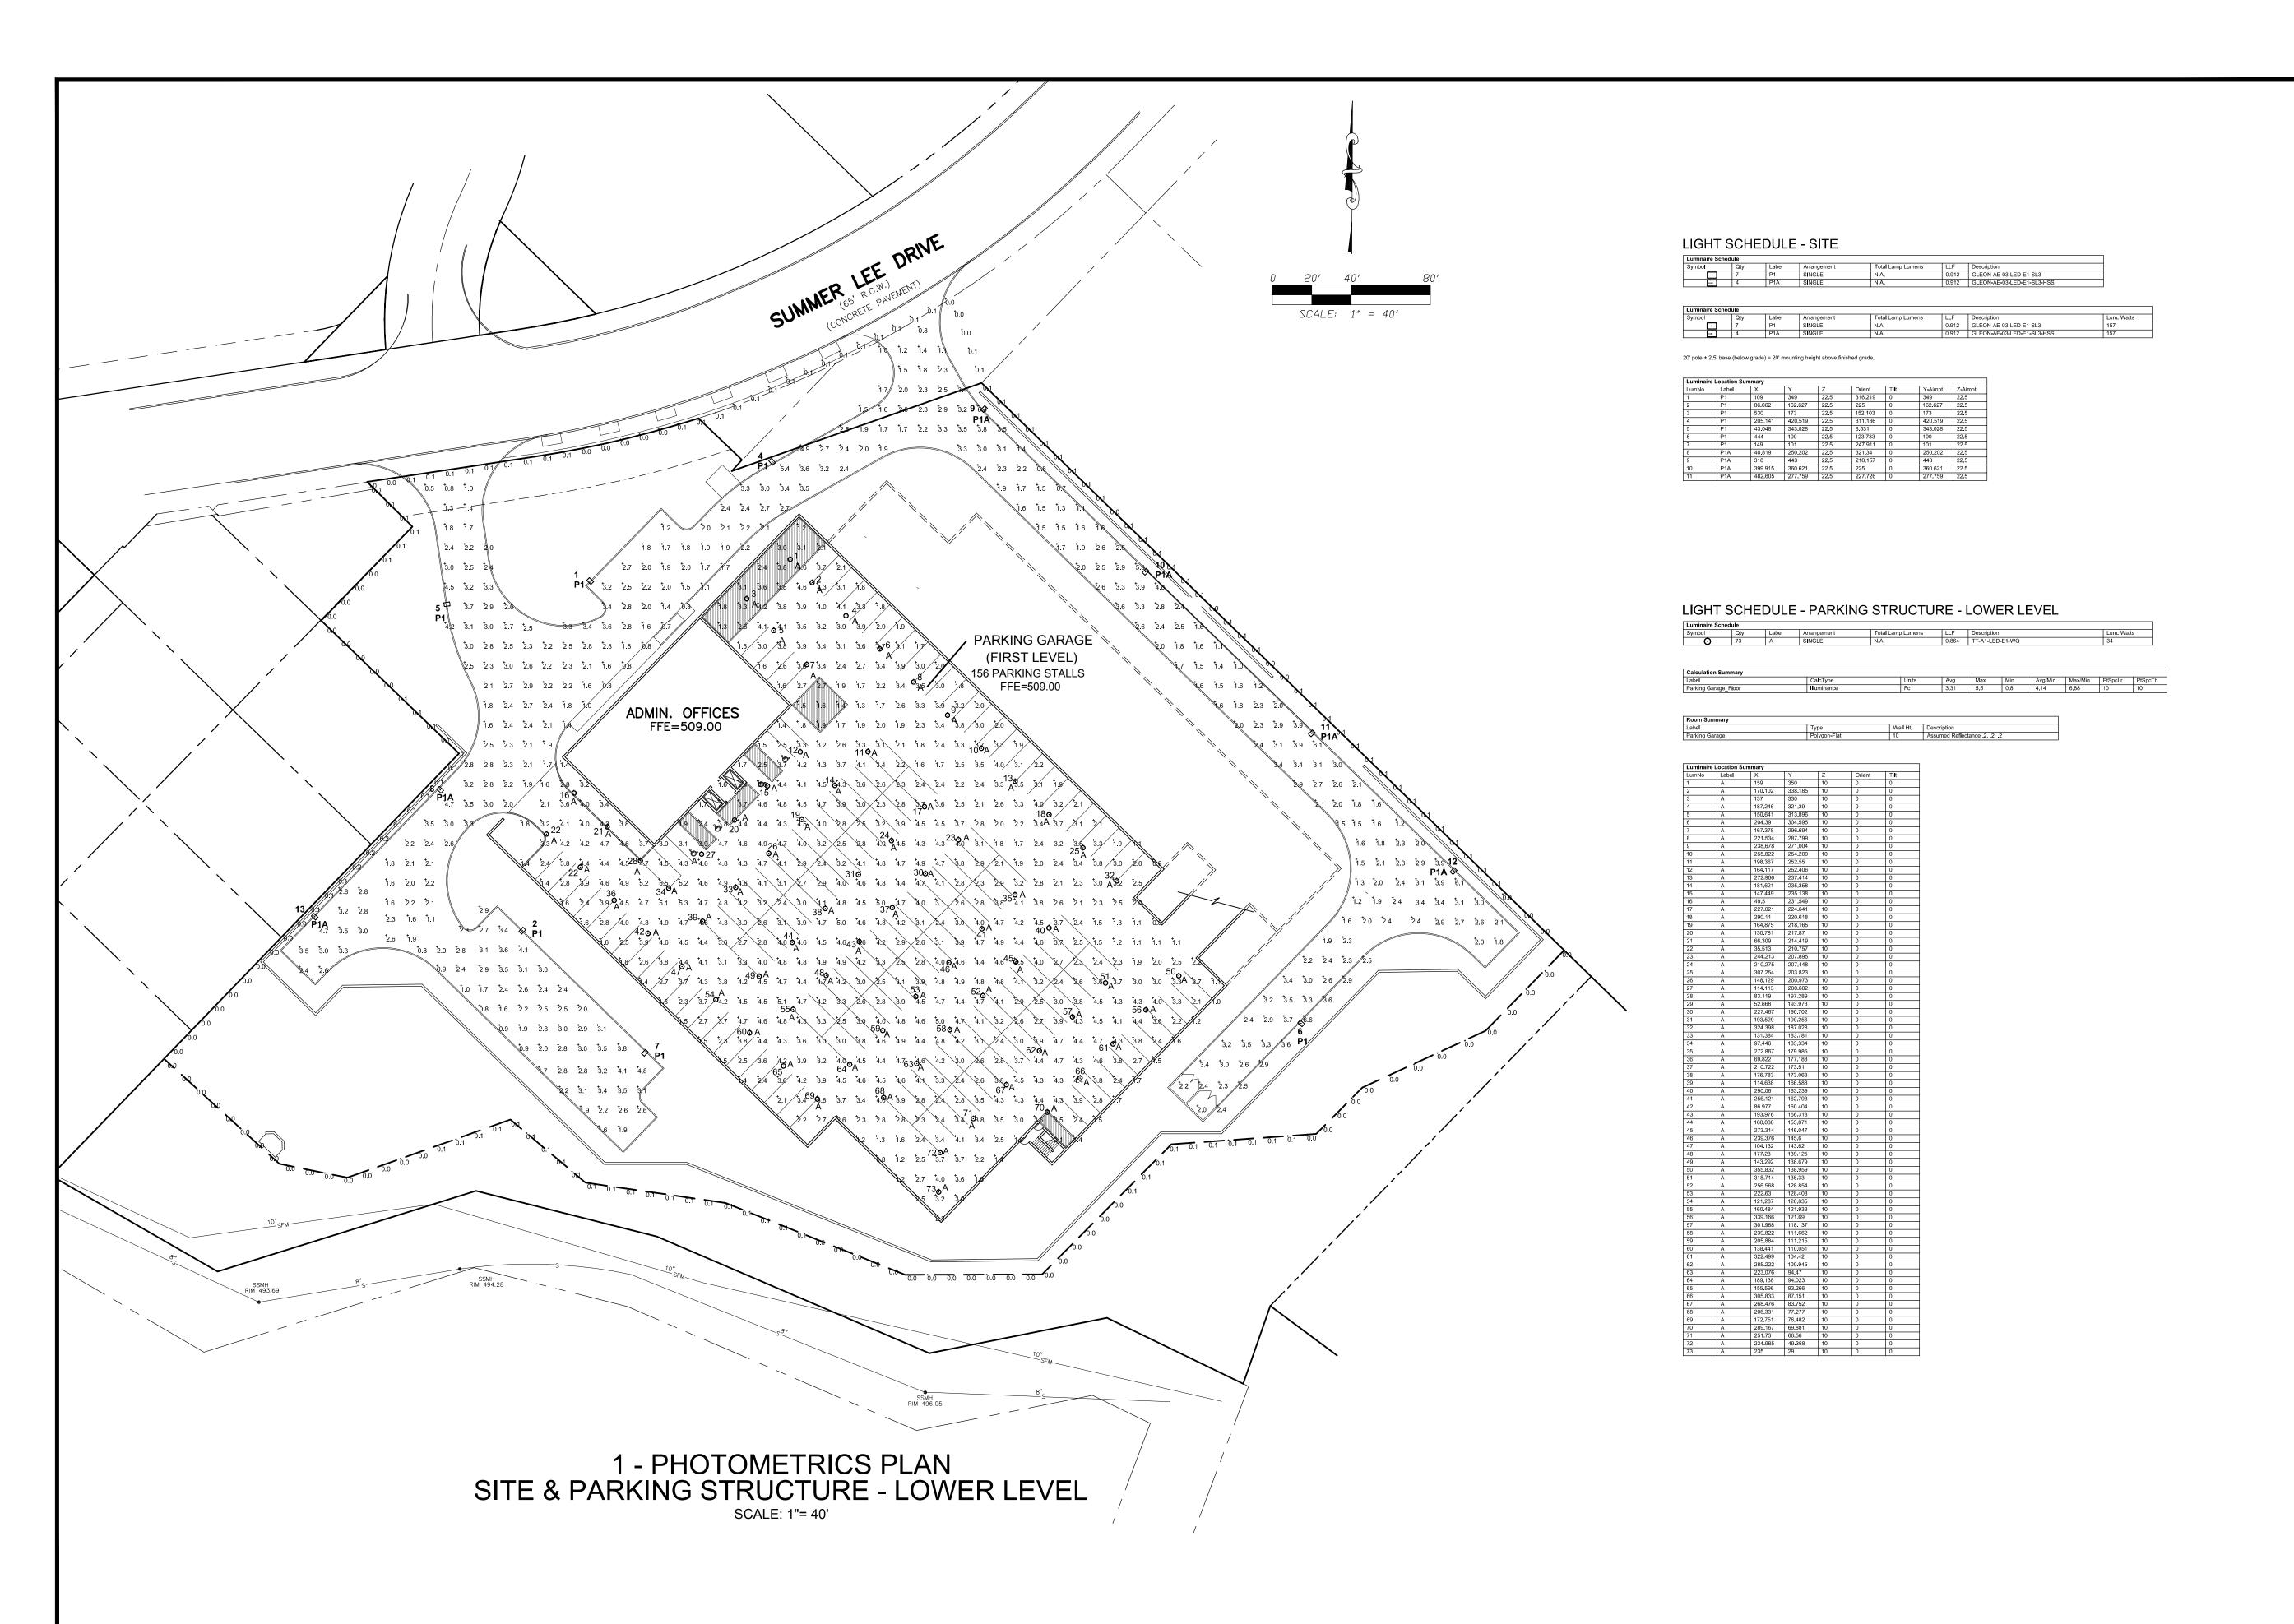




Nassif Engineering & Architecture, LLC

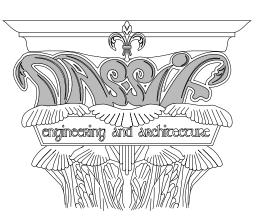

TXBPE Registration No.: F-16335
TBAE Registration No.: BR400

Copyright 2015 Nassif Engineering & Architecture, LLC

ISSUED FOR DEVELOPMENT REVIEW

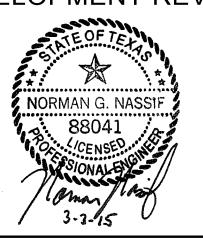

STERLING MANAGEMENT GROUP, LLC

SUMMER LEE CONDOMINIUMS

ROCKWALL, TX 75032

Project Number: Drawing Date:

umber: 15-118 Date: 2/13/2015

AS SHOWN

Checked: Scale:

ACAD File:

Copyright 2015 Strohmeyer Architects, Inc.


Revisions:

3/3/2015 - Revisions per Rockwall Development Review (2/16/2015)

Sheet Ti


PHOTOMETRICS PLAN
SITE & PARKING STRUCTURE
LOWER LEVEL

PH-101

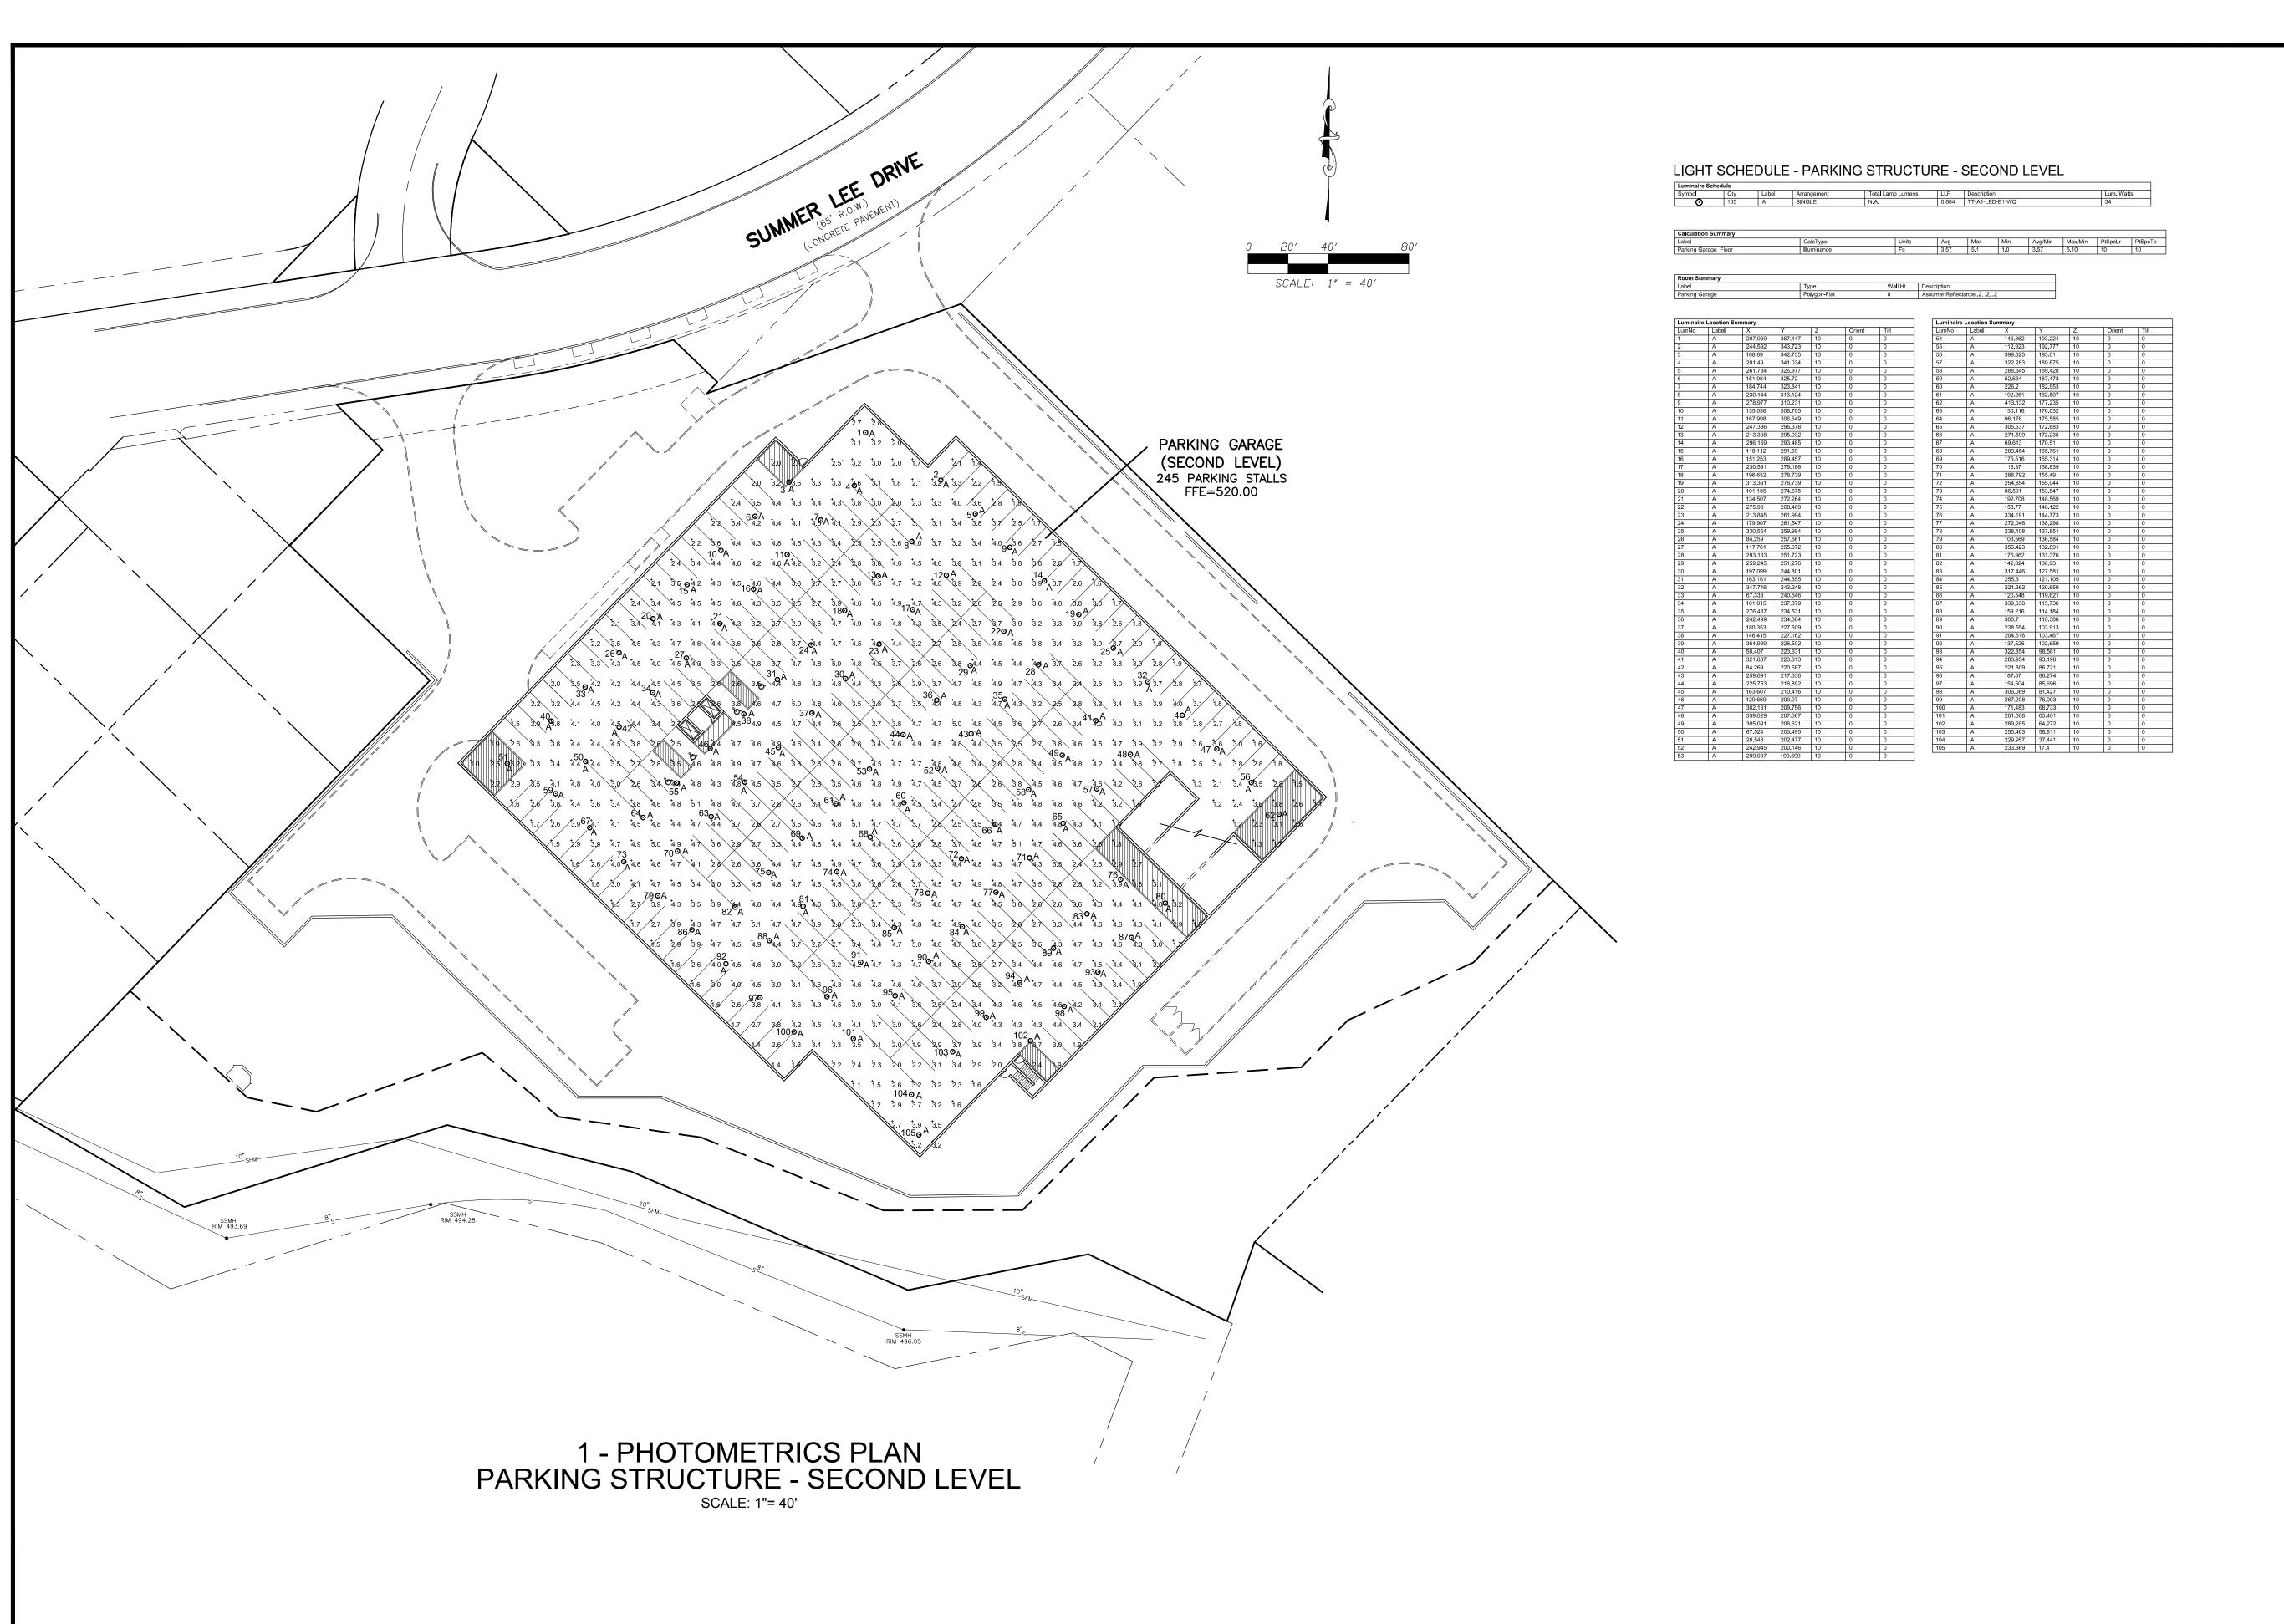



Nassif Engineering & Architecture, LLC

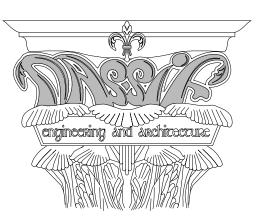

TXBPE Registration No.: F-16335
TBAE Registration No.: BR400

Copyright 2015 Nassif Engineering & Architecture, LLC

I S S U E D F O R DEVELOPMENT REVIEW



STERLING MANAGEMENT GROUP, LLC

SUMMER LEE CONDOMINIUMS

ROCKWALL, TX 75032

15-118

2/13/2015

AS SHOWN

Project Number:
Drawing Date:

Drawn:

Scale: ACAD File:

Copyright 2015 Strohmeyer Architects, Inc.

Revisions:

Checked:

3/3/2015 - Revisions per Rockwall Development Review (2/16/2015)

Sheet Title

PHOTOMETRICS PLAN PARKING STRUCTURE SECOND LEVEL

PH-102



800.364.0098

Fax: 281.997.5441 •

Description

This contemporary styled D154-TS20 Series combines a cast aluminum housing, a spun aluminum shade and segmented reflector to create an efficient luminaire with Type III(HR3) or Type V(HR5) light distribution. Some of the most popular brackets for use with this fixture are shown below, however there are others available in the "Brackets & Wall Luminaires" section of this catalog.

Installation

The luminaire will mount to the bracket as shown on the reverse page. Post top luminaire brackets will mount to a 3" OD post or tenon with (6) 5/16" stainless steel set screws. Wall bracket models have four 3/8" holes for mounting (wall mount hardware is not included).

Electrical

- · High power factor ballast (HPF), core and coil type, pre-wired and tested
- · Easy ballast pod access
- · 4KV pulse rated porcelain socket
- · Suitable for wet location

Lens


Clear smooth flat tempered glass (GL)

Finish

Premium quality thermoset polyester powdercoat (see Finish Selection)



WBR03/D154-TS20

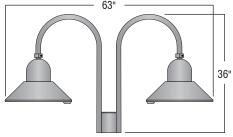

EPA: 2.58 light combinations.







PT01/D154-TS20

EPA: 1.23

Ordering Guide							
Bracket	Luminaire	Light Distribution	Lens	Light Source	Voltage	Finish	Option
PIO1 / I	0154-TS20	/ HR5 /	GL/	100HPS	- 120v	/ BLK /	PCL
		HR3		50MH,70MH	208v	CLB,GRN	
				100MH,50HPS	240v	WHT,TBK	
				70HPS	277v	ATC,GTG	
Additional light sources, voltages, and custom colors are available. Contact factory for details.							

Light Sources	
Wattage	Socket Type
50МН, 70МН,100МН,150МН	Medium
50HPS,70HPS,100HPS,150HPS	Medium
PL-13	2-pin
CFL 26, 32, or 42	4-pin

