

VICINITY MAP NOT TO SCALE

LEGEND	
PROPERTY LINE	
EXISTING INFRASTRUCTURE	
PROPOSED SIDEWALK (BROOM FINISH)	
EXISTING LIGHT POLE	\$
DRIVE-THRU STACKING SPACE	
NEW CONCRETE PAVEMENT	


SITE AREA = 0.182 ACRES (7,939 SF)
IMPERVIOUS AREA PROPOSED = 6,109 SF (77% OF SITE)
IMPERVIOUS AREA ALLOWED = 6,748 SF (85% OF SITE)

SITE ZONING - C (COMMERCIAL) AND IH-30 OV (IH-30 OVERLAY)
PROPOSED USE - RESTAURANT WITH DRIVE-THRU WINDOW
(NO SEATING)

BUILDING AREA = ±519 SF (18' TALL)
THERE ARE NO EXISTING BUILDINGS WITHIN 100 FEET OF
THE PROPOSED LEASE SITE

PARKING REQUIRED = 1 SPACE/100 SF = 6 SPACES
PARKING PROVIDED = 6 SPACES + 1 VAN ACCESSIBLE SPACE

NO FREESTANDING LIGHT FIXTURES ARE PROPOSED.
EXISTING WALMART LIGHTS ARE ADJACENT TO SITE. REFER TO BUILDING
PLANS FOR BUILDING LIGHTS / SIGNS.

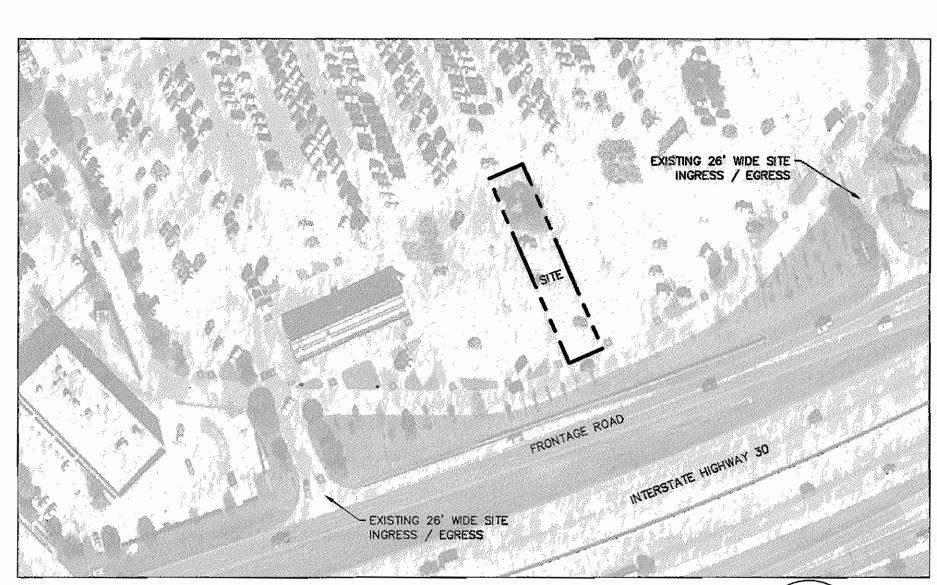

AREA SURROUNDING PROJECT SITE




wenue • Suite 400 th, Texas 76107 17.335.7437 EG. F-1114) No. DATE REVISION DESCRIPTION

DUNAW

tle's Best Coffeer the NEC of IH 30 Frontage and White Hills Drive

SITE



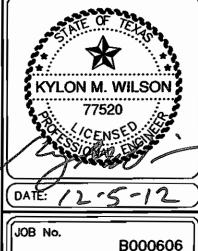

DRAWN BY:

DDP

DESIGNED BY:

CHECKED BY:

DATE:

NOVEMBER 16, 2012

DATE: NOVEMBER 16, 2012 SCALE: 1"=20'

SHEET:


EXHIBIT "A"





right front

Elevations

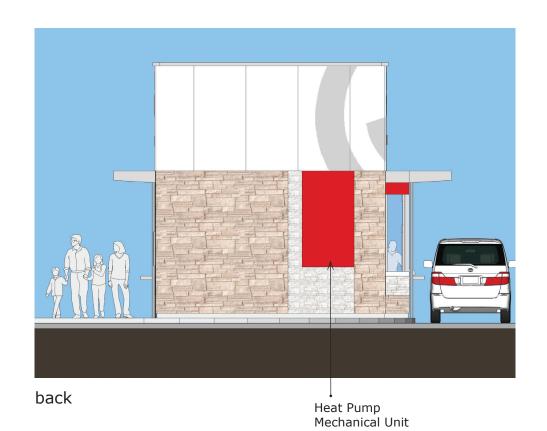



left





walk-up window view

drive-thru window view


Exterior Building Material Area Calculation:

Glazing & Entry Door: 13% of total area

Fiber-Concrete Masonry Panel: 45% of non-glazing area

Stone Material: 53% of non-glazing area


33% cast Ledge Stone, 20% natural Austin Limestone

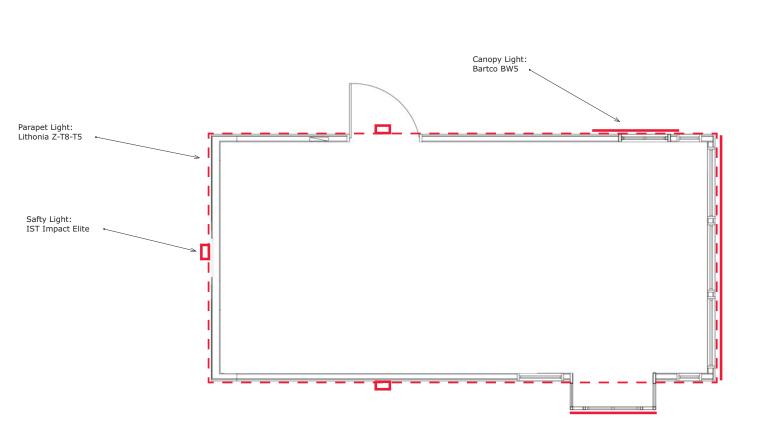





Exterior Lighting

night time view

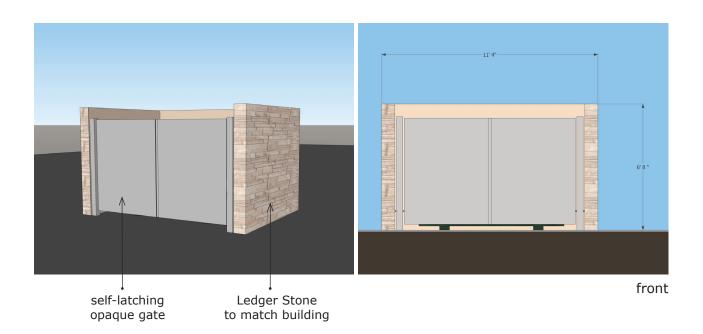

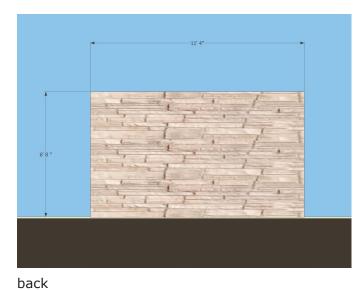

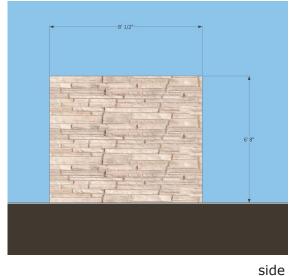

Trash Enclosure



paint colors




natural Austin Limestone




cast Ledger Stone


November 5, 2012

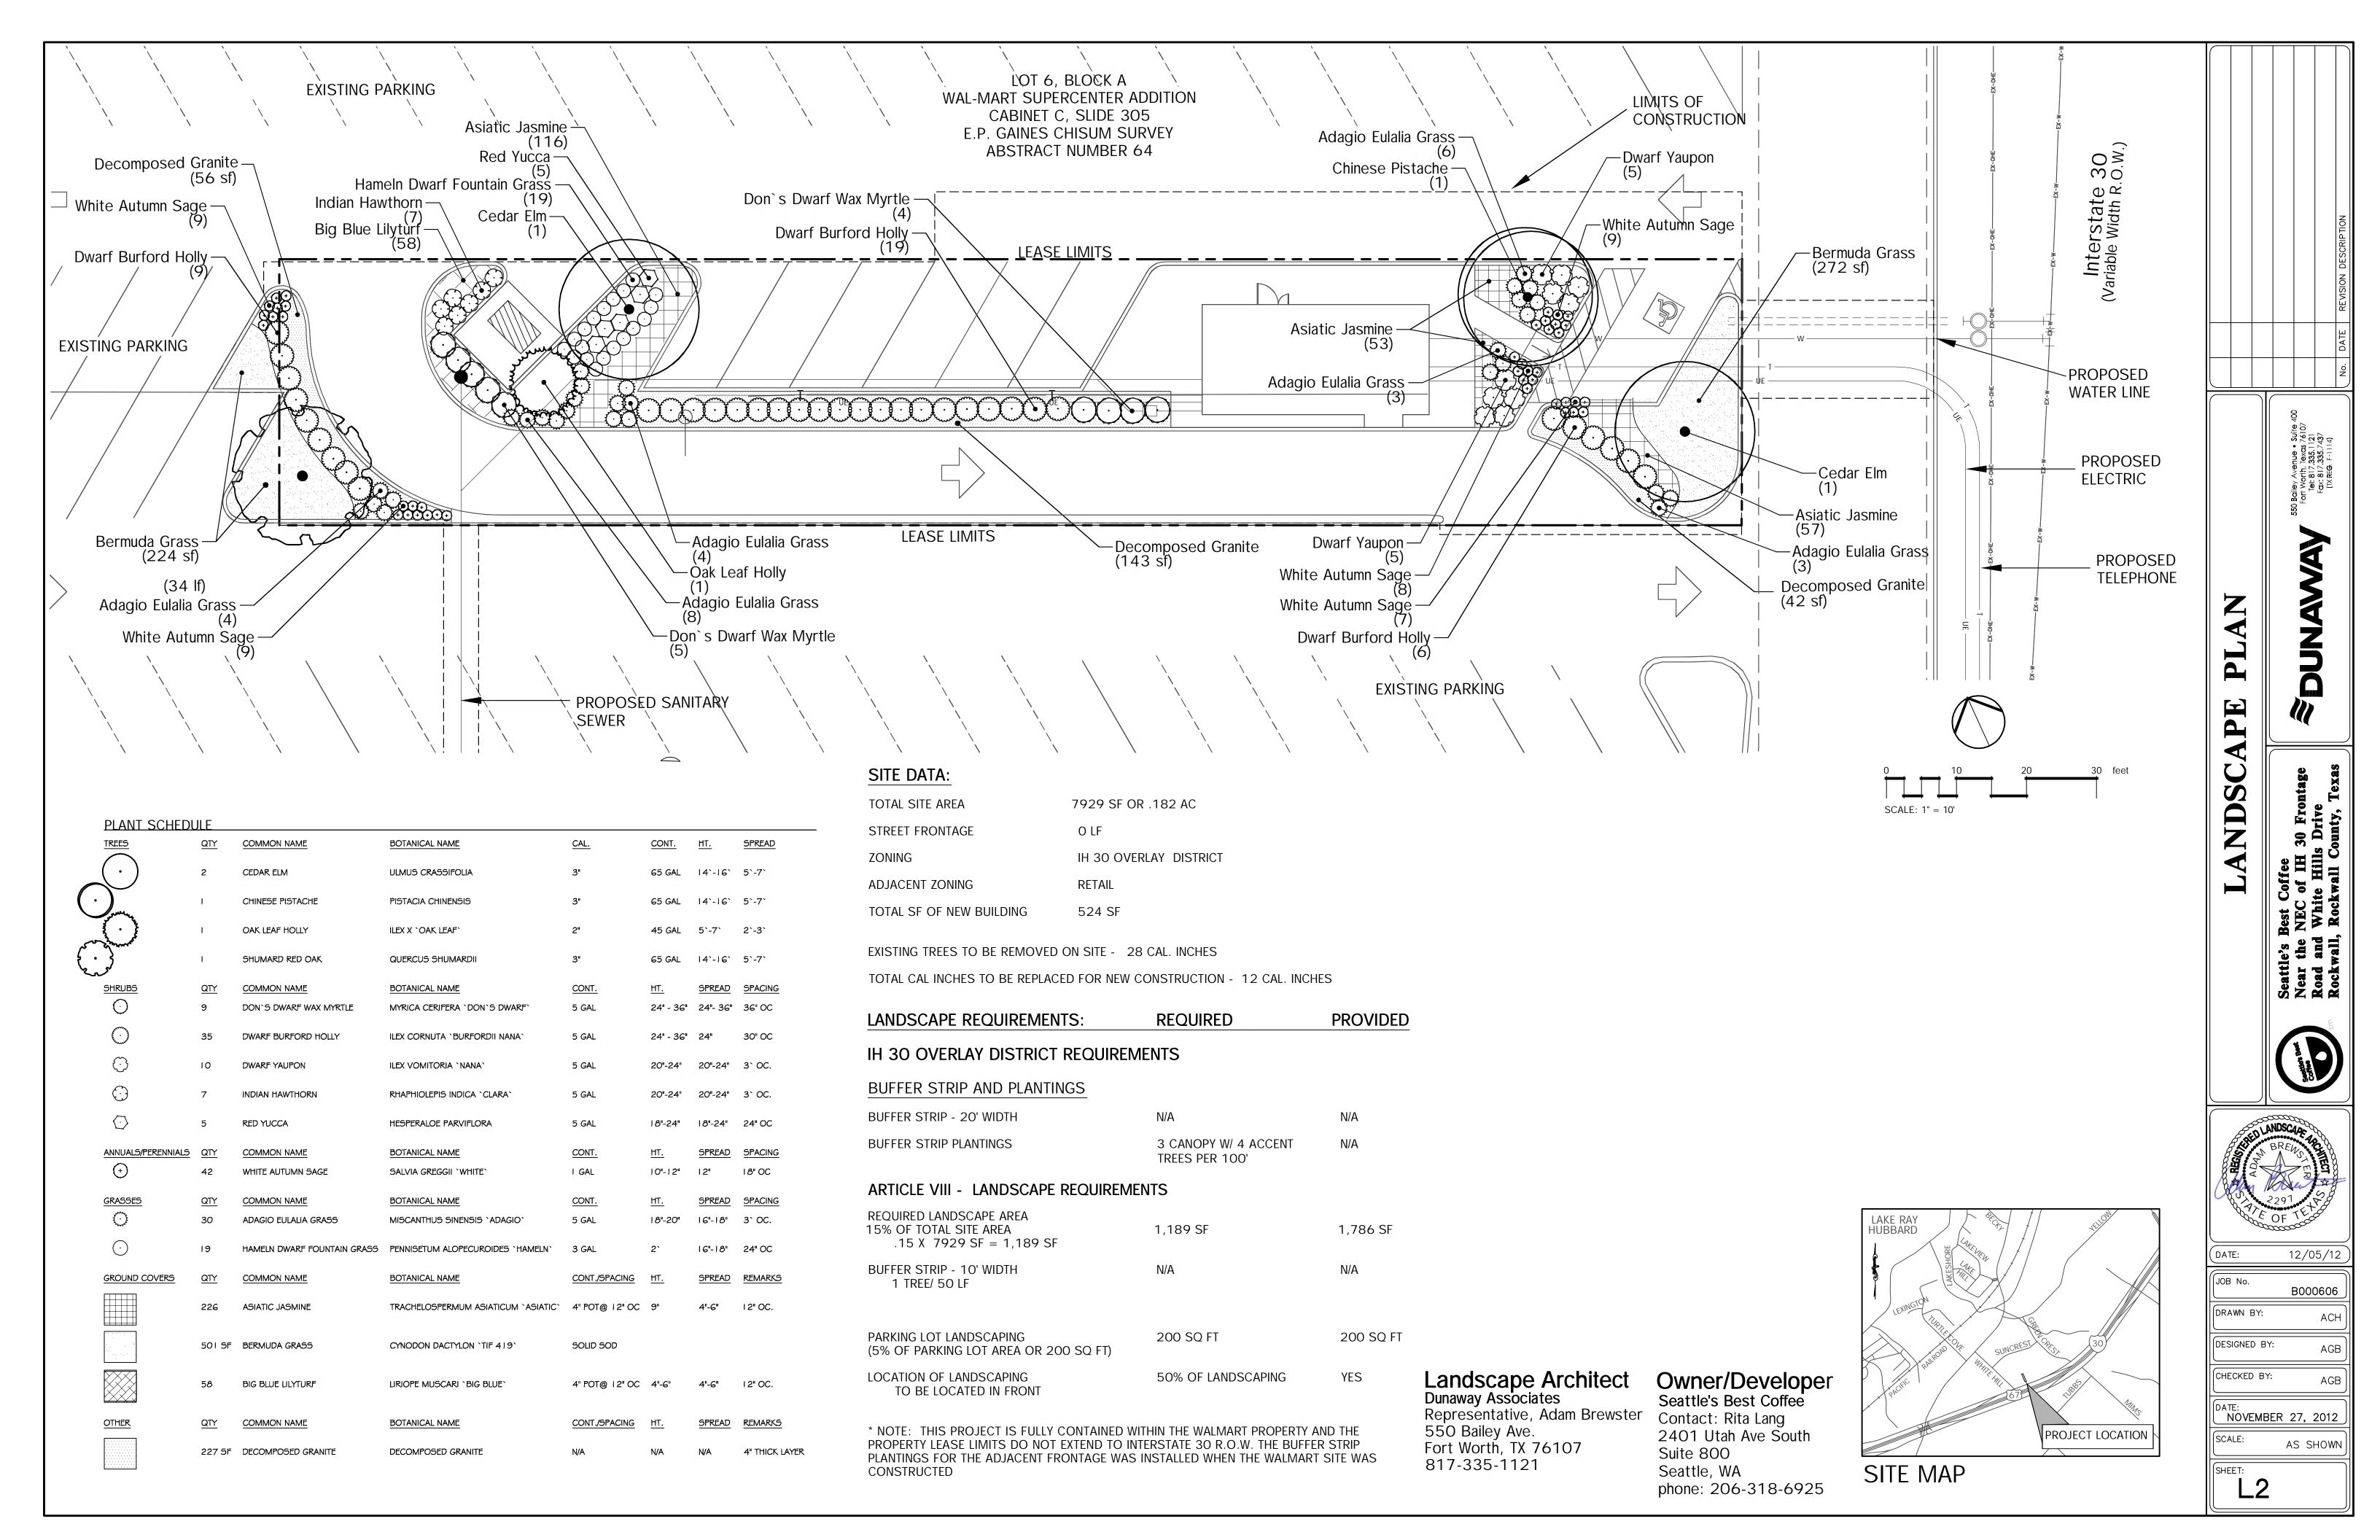


TREE PLANTING & STAKING DETAIL

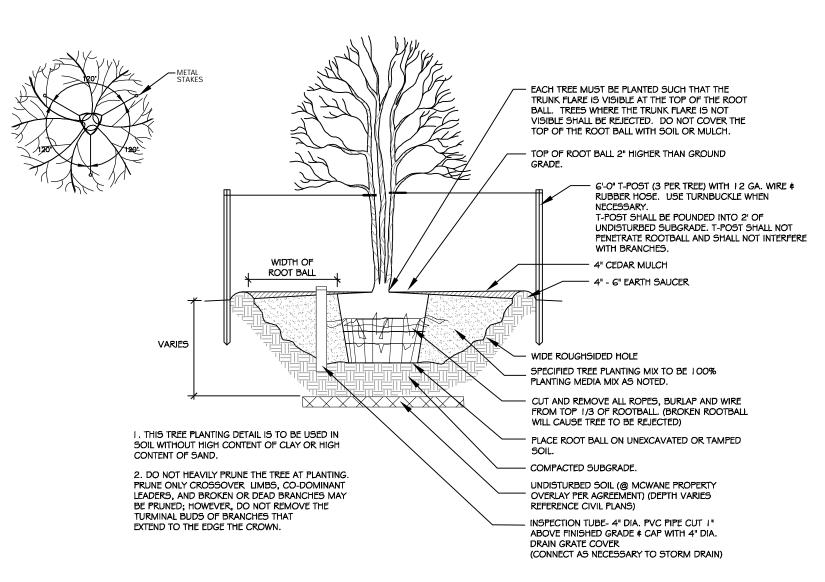


MULTI-TRUNK TREE PLANTING & STAKING DETAIL

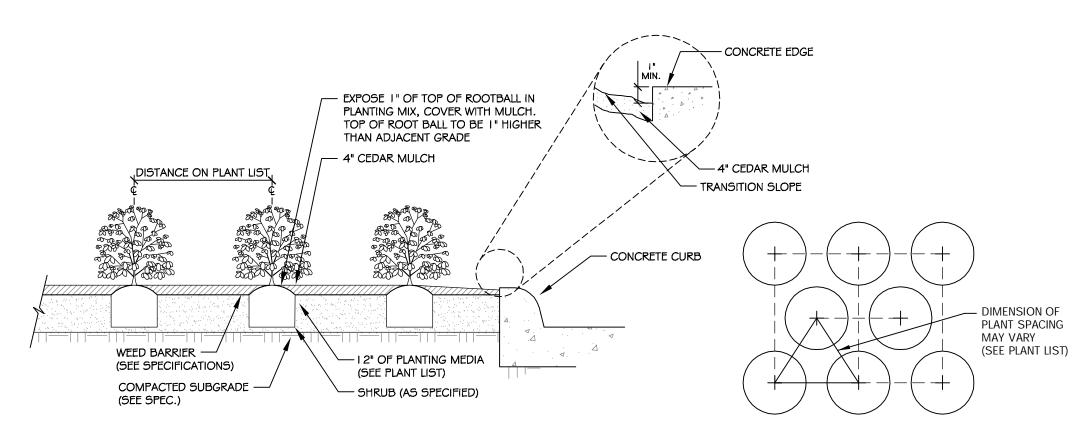

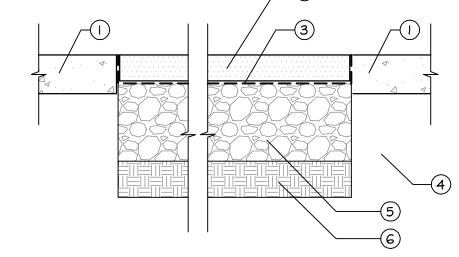


DECOMPOSED GRANITE

SHRUB PLANTING DETAIL AND SPACING DIAGRAM

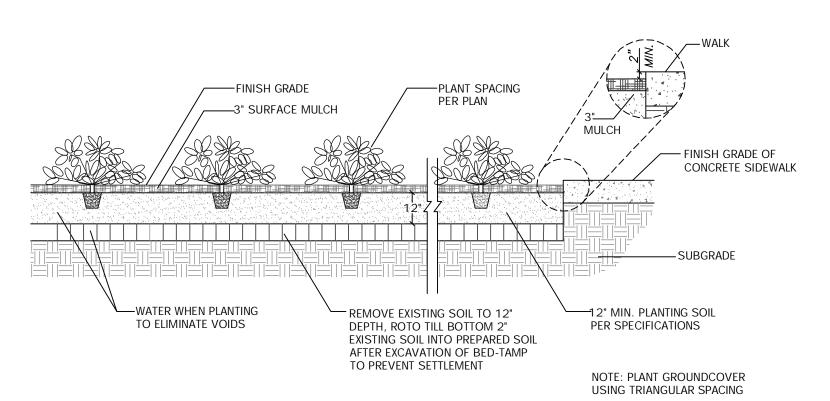

NOT TO SCALE GROUNDCOVER PLANTING DETAIL

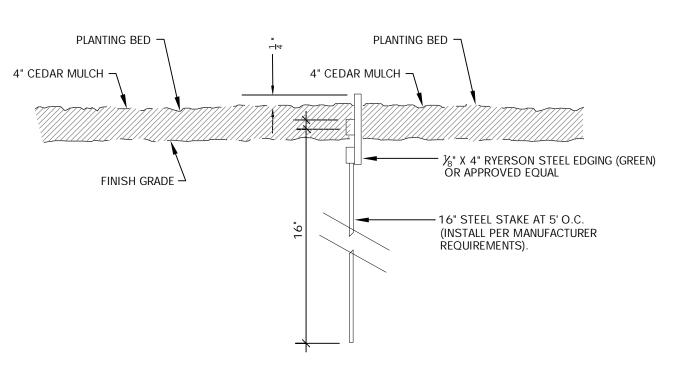

STEEL EDGING DETAIL NOT TO SCALE

LANDSCAPE NOTES:

1. ALL PLANTS MUST BE HEALTHY, VIGOROUS MATERIAL, FREE OF PESTS AND DISEASE

- 2. ALL PLANTS MUST BE CONTAINER GROWN AS INDICATED IN THE PLANT LIST.
- 3. ALL TREES MUST BE STRAIGHT TRUNKED, FULL HEADED AND MEET ALL REQUIREMENTS SPECIFIED.
- 4. ALL PLANTS ARE SUBJECT TO THE APPROVAL OF THE OWNER'S REPRESENTATIVE BEFORE, DURING AND AFTER
- 5. ALL TREES MUST BE GUYED OR STAKED AS SHOWN IN THE DETAILS
- 6. ALL PLANTING AREAS MUST BE COMPLETELY MULCHED AS
- SPECIFIED.
- 7. LOCATIONS OF EXISTING BURIED UTILITY LINES SHOWN ON THE PLANS ARE BASED UPON BEST AVAILABLE INFORMATION AND ARE TO BE CONSIDERED APPROXIMATE.
- 8. PRIOR TO CONSTRUCTION, THE CONTRACTOR SHALL BE RESPONSIBLE FOR LOCATING ALL UNDERGROUND UTILITIES AND SHALL AVOID DAMAGE TO ALL UTILITIES DURING THE COURSE OF THE WORK. THE CONTRACTOR IS RESPONSIBLE FOR REPAIRING ANY AND ALL DAMAGE TO THE UTILITIES, STRUCTURES, SITE APPURTENANCES, ETC., WHICH OCCURS AS A RESULT OF THE LANDSCAPE CONSTRUCTION.
- 9. ALL PLANT MATERIAL QUANTITIES SHOWN ARE APPROXIMATE. CONTRACTOR SHALL BE RESPONSIBLE FOR COMPLETE COVERAGE OF ALL PLANTING BEDS AT SPACING SHOWN.
- 10. THE CONTRACTOR IS RESPONSIBLE FOR VERIFYING ALL QUANTITIES SHOWN ON THESE PLANS BEFORE PRICING THE
- 11. THE CONTRACTOR IS RESPONSIBLE FOR FULLY MAINTAINING ALL PLANTING, INCLUDING BUT NOT LIMITED TO: WATERING, MOWING, EDGING, SPRAYING, MULCHING, WEEDING, FERTILIZING, ETC. OF THE PLANTING AREAS AND LAWN UNTIL THE WORK IS ACCEPTED IN TOTAL BY THE OWNER, AND AS STATED MAINTENANCE PERIOD.
- 12. THE CONTRACTOR SHALL COMPLETELY GUARANTEE ALL PLANT MATERIAL FOR A PERIOD OF TWO (2) YEARS FROM DATE OF ACCEPTANCE OF PROJECT. THE CONTRACTOR SHALL PROMPTLY MAKE ALL REPLACEMENTS BEFORE OR AT THE END OF THE GUARANTEE PERIOD.
- 13. THE CONTRACTOR SHALL STAKE THE PROPOSED LOCATION OF ALL TREES AND PLANTING BEDS AND RECEIVE APPROVAL OF THE OWNER PRIOR TO INSTALLATION.
- 14. AFTER BEING DUG AT THE NURSERY SOURCE, ALL TREES IN LEAF SHALL BE ACCLIMATED FOR TWO WEEKS UNDER A MIST SYSTEM PRIOR TO INSTALLATION.
- 15. ANY PLANT MATERIAL WHICH DIES, TURNS BROWN, OR DEFOLIATES PRIOR TO TOTAL ACCEPTANCE OF THE WORK SHALL BE PROMPTLY REMOVED FROM THE SITE AND REPLACED WITH MATERIAL OF THE SAME SPECIES, QUAINTLY, AND SIZE. THE REPLACEMENT MATERIAL SHALL MEET ALL PLANT LIST SPECIFICATIONS.
- 16. STANDARDS SET FORTH IN THE "AMERICAN STANDARD FOR NURSERY STOCK" REPRESENT GUIDELINE SPECIFICATIONS ONLY AND SHALL CONSTITUTE MINIMUM QUALITY REQUIREMENTS FOR PLANT MATERIAL.
- 17. SAFE, CLEARLY MARKED PEDESTRIAN AND VEHICULAR ACCESS TO ALL ADJACENT PROPERTIES MUST BE MAINTAINED THROUGHOUT THE CONSTRUCTION PROCESS.
- 18. THE CONTRACTOR IS CAUTIONED THAT LOCAL CITY STANDARDS MAY DIFFER FROM THOSE SHOWN HEREIN. CONSTRUCTION IS TO BE PERFORMED IN ACCORDANCE WITH LOCAL, CITY, STATE OR FEDERAL SPECIFICATIONS AND DETAILS SHOULD BE MORE STRINGENT THAN THOSE REPRESENTED HEREIN.
- 19. ALL SHRUB, GROUND COVER AND PLANTING BEDS ARE TO BE COMPLETELY COVERED WITH MULCH TO A MINIMUM DEPTH OF FOUR INCHES.
- 20. IF LANDSCAPE CONTRACTOR DEMONSTRATES THAT ALL KNOWN RESOURCES HAVE BEEN EXHAUSTED FOR SPECIFIED PLANT MATERIAL AND AVAILABILITY OR QUALITY DOES NOT MEET OR EXCEED CRITERIA, CONTACT OWNER'S REPRESENTATIVE FOR ALTERNATIVE PLANT MATERIAL POSSIBILITIES.
- 21. PLANT MATERIALS -PLANTING MEDIA MIX:

(I) CONCRETE EDGE SEE CIVIL

(2) 4" STABILIZED DECOMPOSED

TURN UP FABRIC AT EDGE

COMPACT SUBGRADE PER CIVIL PAVING PLANS

(5) 12" COMPACTED AGGREGATE

(6) COMPACT SUBGRADE TO 95%

PROCTOR DENSITY

GRANITE PER SPECIFICATIONS

DRAWINGS

(3) GEOTEXTILE FABRIC;

"VEGETABLE MIX" AS SUPPLIED BY LIVING EARTH

OR AN APPROVED EQUAL.

CONTACT: PAUL TOMASO, LIVING EARTH, 1902 CALIFORNIA CROSSING, DALLAS, TEXAS 75220, 972-869-4332.

-MYCORRHIZAL SUPPLEMENT:

"DIEHARD-TRANSPLANT," BY HORTICULTURAL ALLIANCE, INC. (800)628-6373, WWW.HORTICULTURALALLIANCE.COM. APPLY TO ALL PLANTINGS DURING THE PLANTING OPERATION AT THE RATES SPECIFIED BY THE MANUFACTURER. THE CONTRACTOR SHALL CALCULATE THE REQUIRED AMOUNT OF "DIEHARD TRANSPLANT," FOR THE PROJECT USING THE MANUFACTURER'S SPREADSHEET AND SUBMIT THE SPREADSHEET WITH THE PROJECT SUBMITTALS. THE CONTRACTOR SHALL SUBMIT RECEIPTS OF THE ACTUAL PURCHASE OF THE "DIEHARD TRANSPLANT," MATERIAL AT TIME OF PROJECT PURCHASE.

"CEDAR MULCH" AS SUPPLIED BY LIVING EARTH

OR AN APPROVED EQUAL. CONTACT: PAUL TOMASO, LIVING EARTH, 1902 CALIFORNIA CROSSING, DALLAS, TEXAS 75220,

972-869-4332.

GRASS SODDING/SEEDING NOTES:


1. TURF AREAS NOTED SHALL BE SOLID SOD, CERTIFIED TIFWAY 419 BERMUDA, (CYNODON DACTYLON TIFWAY 419').

- 2. OVERSEEDING FOR ANY SOD LAID BETWEEN SEPT. 15 THRU APRIL 15, HAND OVERSEED ANNUAL RYE AT 10 LBS./1000 S.F. FOR ALL SODDED AREAS SHOWN ON PLAN.
- 3. BID SHOULD INCLUDE BOTH STEPS (SODDING AND OVERSEEDING) IF PROJECT POSSESSION DATE OCCURS BETWEEN SEPT.15 AND APRIL 15.
- 4. ALL UNSURFACED AREAS ARE TO RECEIVE TWELVE INCHES OF TOPSOIL, SOD/SEED, MULCH, AND WATERED UNTIL HEALTHY STAND OF GRASS IS OBTAINED.
- 5. PROVIDE TEMPORARY IRRIGATION AS NEEDED UNTIL A HEALTHY STAND OF GRASS IS ESTABLISHED OR UNTIL PERMANENT IRRIGATION IS FUNCTIONAL.
- 6. ALL SEEDING (NATIVE LAWN MIX) TO BE APPLIED USING FLEXTERRA HIGH PERFORMANCE-FLEXIBLE GROWTH MEDIUM OR AN APPROVED EQUAL.
- AS SUPPLIED BY PROFILE PRODUCTS LLC, 800-508-8681

IRRIGATION NOTES:

1. ALL PLANTED AREAS SHALL BE WATERED WITH AN UNDERGROUND IRRIGATION SYSTEM. THE IRRIGATION SYSTEM SHALL BE AUTOMATICALLY CONTROLLED WITH A FULLY PROGRAMMABLE ET BASED CONTROLLER WITH RAIN AND FREEZE SENSORS.

2. THE IRRIGATION SYSTEM AND INSTALLATION SHALL MEET ALL OF THE APPROPRIATE REQUIREMENTS OF THE LOCAL MUNICIPALITY.

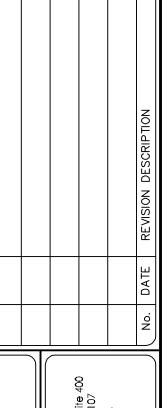



12/05/12 JOB No. B000606 DRAWN BY:

DESIGNED BY:

CHECKED BY:

NOVEMBER 27, 2012

SCALE:

SHEET: