



TOP NORTHEAST CORNER OF CONCRETE WYE INLET LOCATED IN SOUTHWEST CORNER OF HOME DEPOT.

ELEV. = 540.69

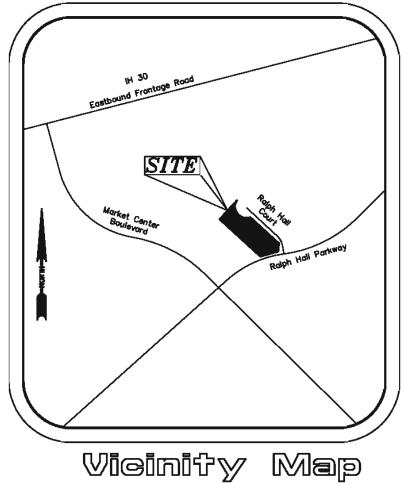

ACCORDANCE WITH ADA STANDARDS LIGHTING FOR THE SITE SHALL MEET CITY

THERE ARE NO TREES ON THIS SITE.

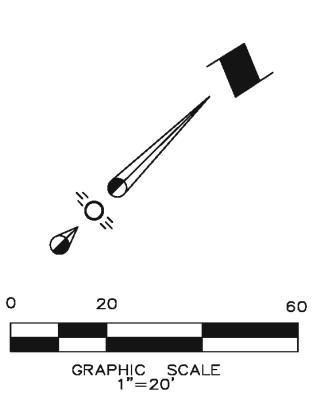

LEGEND

	Proposed Firelane
	Proposed Sidewalk
-ф- О ssмн Т ⊗	Existing Fire Hydrant Existing Sanitary Sewer Manhole Existing Water Valve Proposed Water Meter
Ø _{PP}	Existing Power Pole
ss	Existing Sanitary Sewer Line
w	Existing Water Line
OHP	Existing Overhead Power Line
GAS	Existing Gas Line
— т —	Existing Telephone Line

SYNOPSIS

Zoning	C (S 81)
Proposed Use	Light Automotive Repair
Lot Area	0.702 Ac. (30,560 s.f.)
Building Area:	4,968 s.f.
Lot Coverage:	16.25%
Floor Area Ratio:	0.16:1

Impervious Area: 21,737 s.f. 24' (To The Ridge), 1 Story Building Height:

Parking Required: (18 Spaces) (2 per service bay)

(25 Spaces) Total Parking Provided: (2 Spaces) Handicap Parking Provided:

Lot 2, Block 1, Rockwall Market Center South Addition Legal Description:

> STOP! **CALL BEFORE YOU DIG**



SURVEYOR

AJ Bedford Group, Inc.
301 N. Alamo Road
Rockwall, Texas 75087 Phone (972) 722-0225 Fax (972) 722-0361 Contact: Jay Bedford

McKinney, Texas 75069 Texas P.E. Firm No. F-5935

Scale:

1'' = 20'

106 W. Louisiana Street

Checked By:

J.D.C.

972.562.4409

Drawn By:

C.E.C.I.

Christian Brothers Automotive 15995 N. Barker Landing Suite 145 Houston, Texas 77079 281-870-8900 ext.105 Contact: Curtis Cain

DEVELOPER

ENGINEER Cross Engineering Consultants, Inc. 106 W. Louisiana Street McKinney, Texas 75069 Phone (972) 562-4409 Fax (972) 562-4471 Contact: Jonathan D. Hake, P.E.

(@ least 72 hours prior to digging)

Sheet No.

CHRISTIAN BROTHERS - ROCKWALL

Project No. CITY OF ROCKWALL, TEXAS 11014


SITE PLAN JON DAVID CROSS

82618

CISTER

ONAL BROWN Rockwall Market Center South Addition

SP

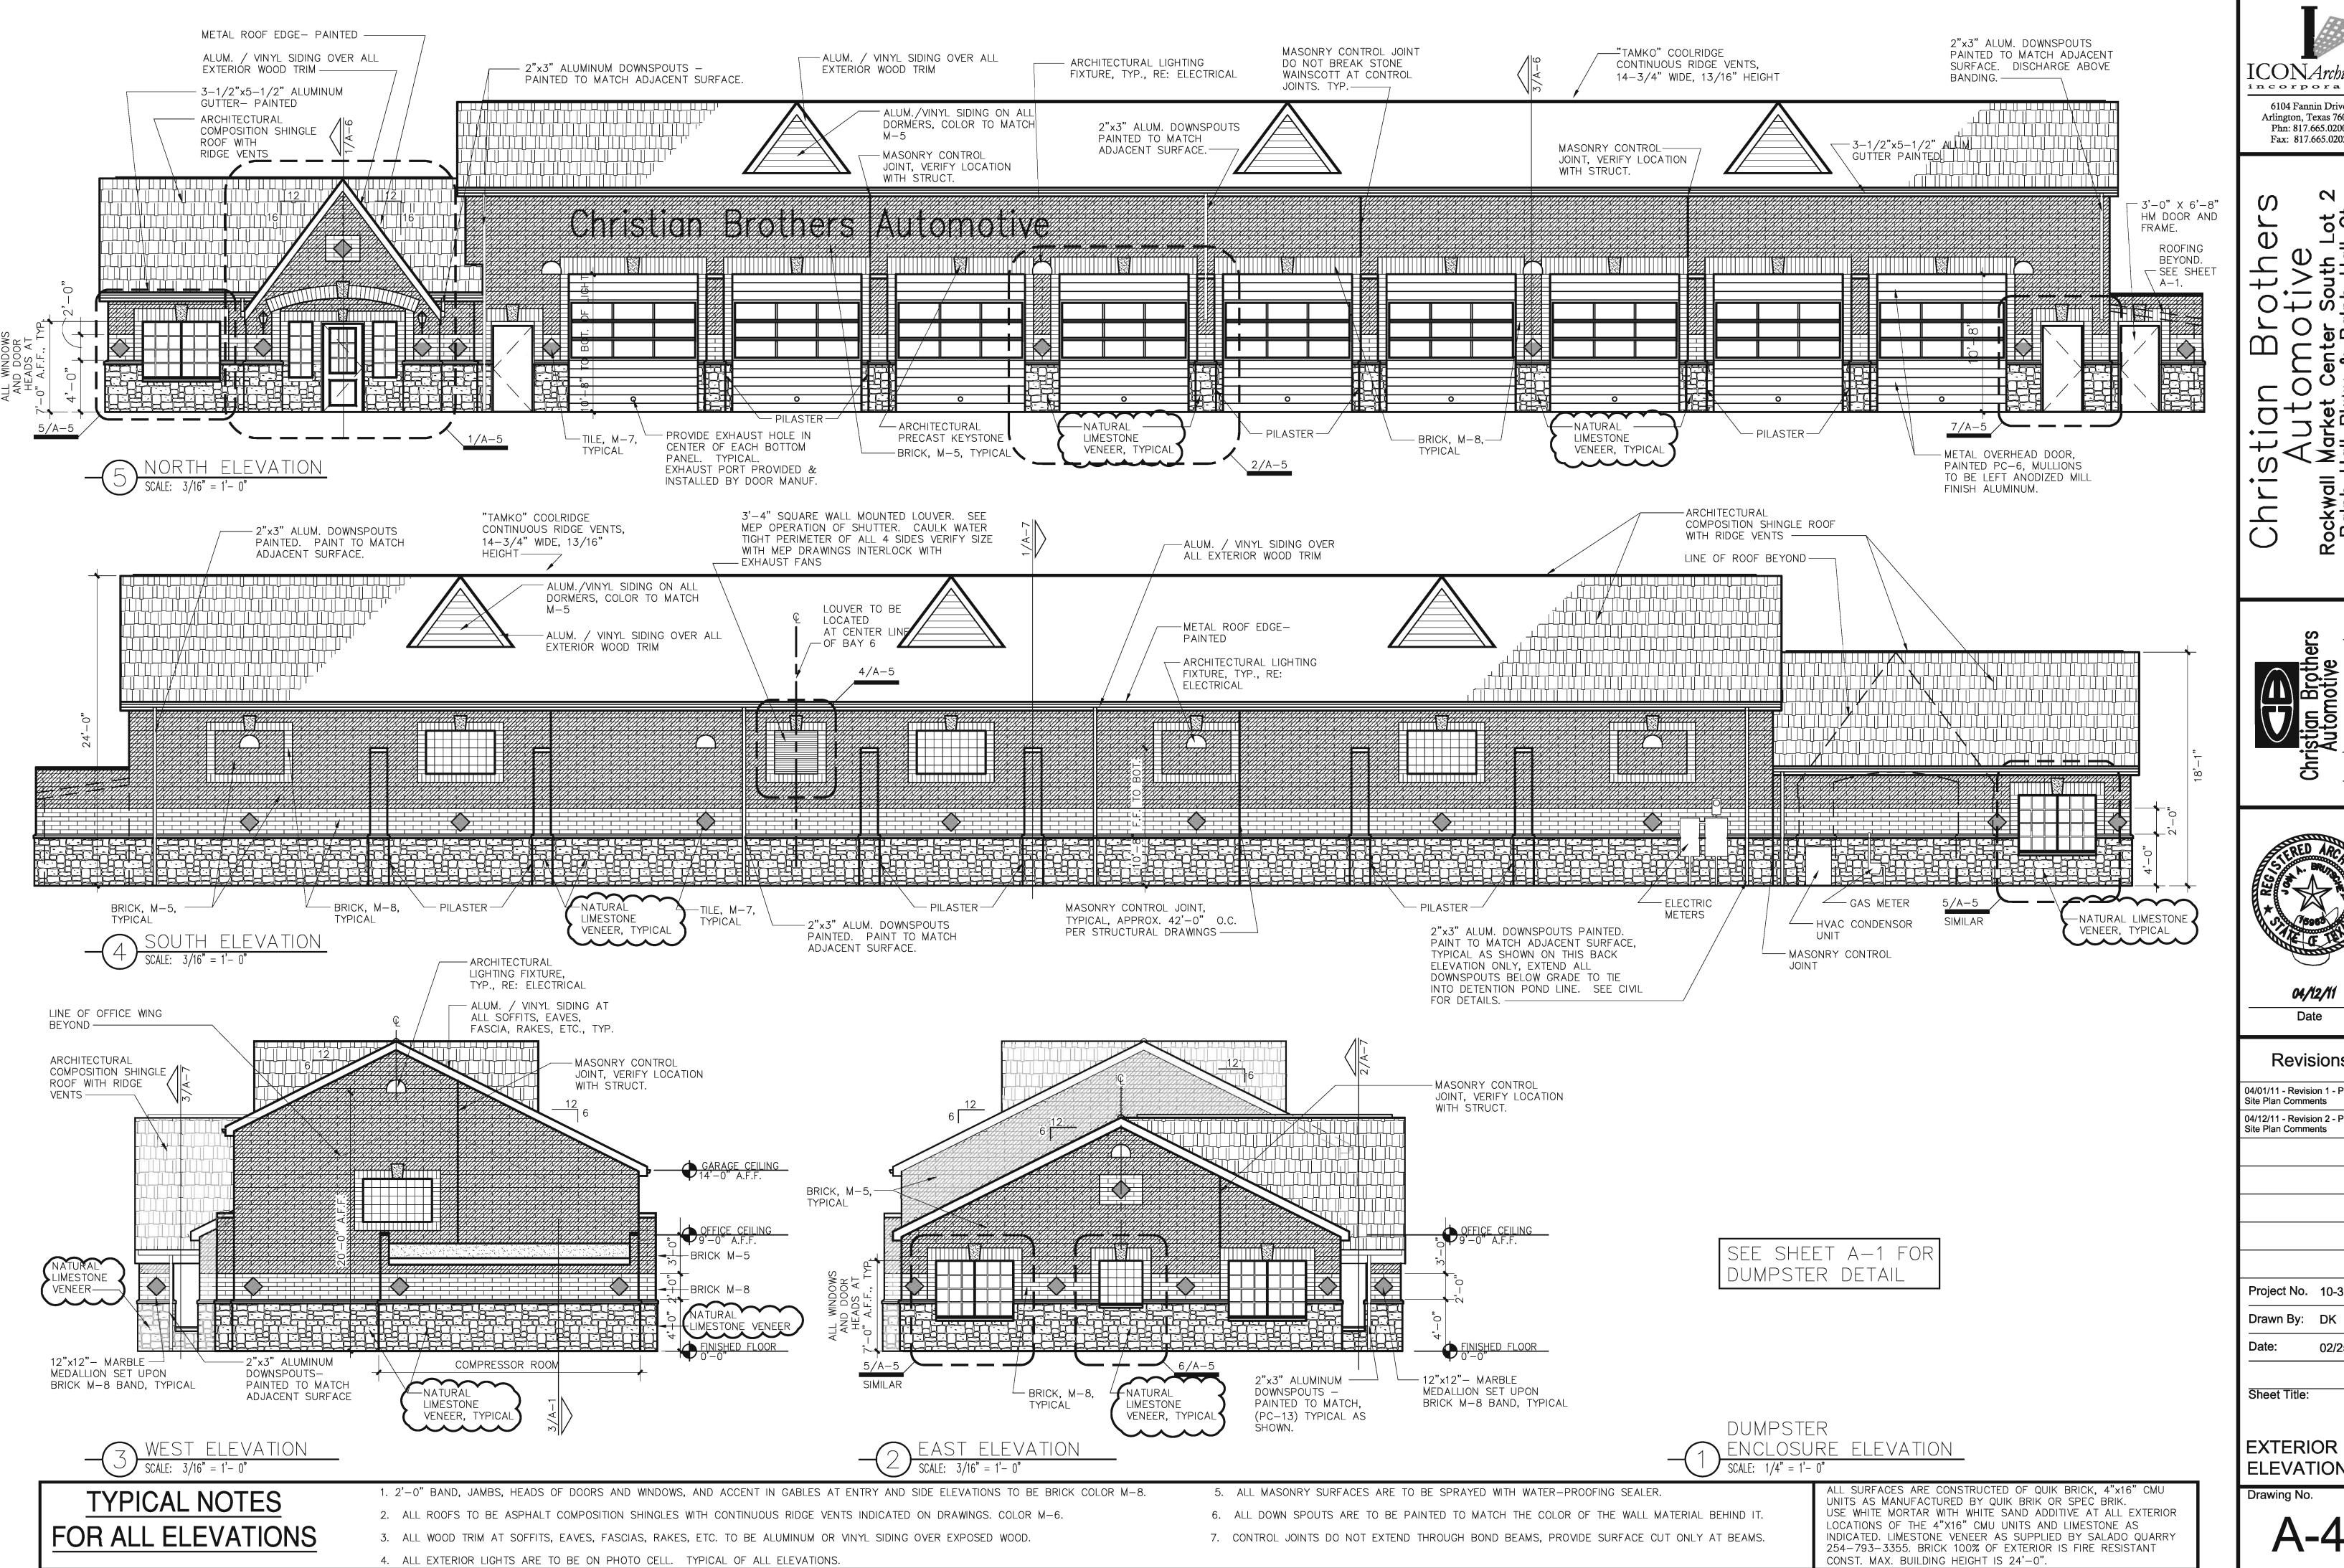

[CON*Architect*: incorporate

6104 Fannin Drive Arlington, Texas 76001 Phn: 817.665.0200 Fax: 817.665.0202

7 なび

Rockwall Ralph 1



04/12/11 Date

Revisions

04/01/11 - Revision 1 - Per City Site Plan Comments 04/12/11 - Revision 2 - Per City Site Plan Comments

Project No. 10-35 Drawn By: DK


Date:

02/25/11

Sheet Title:

ELEVATIONS

Drawing No.

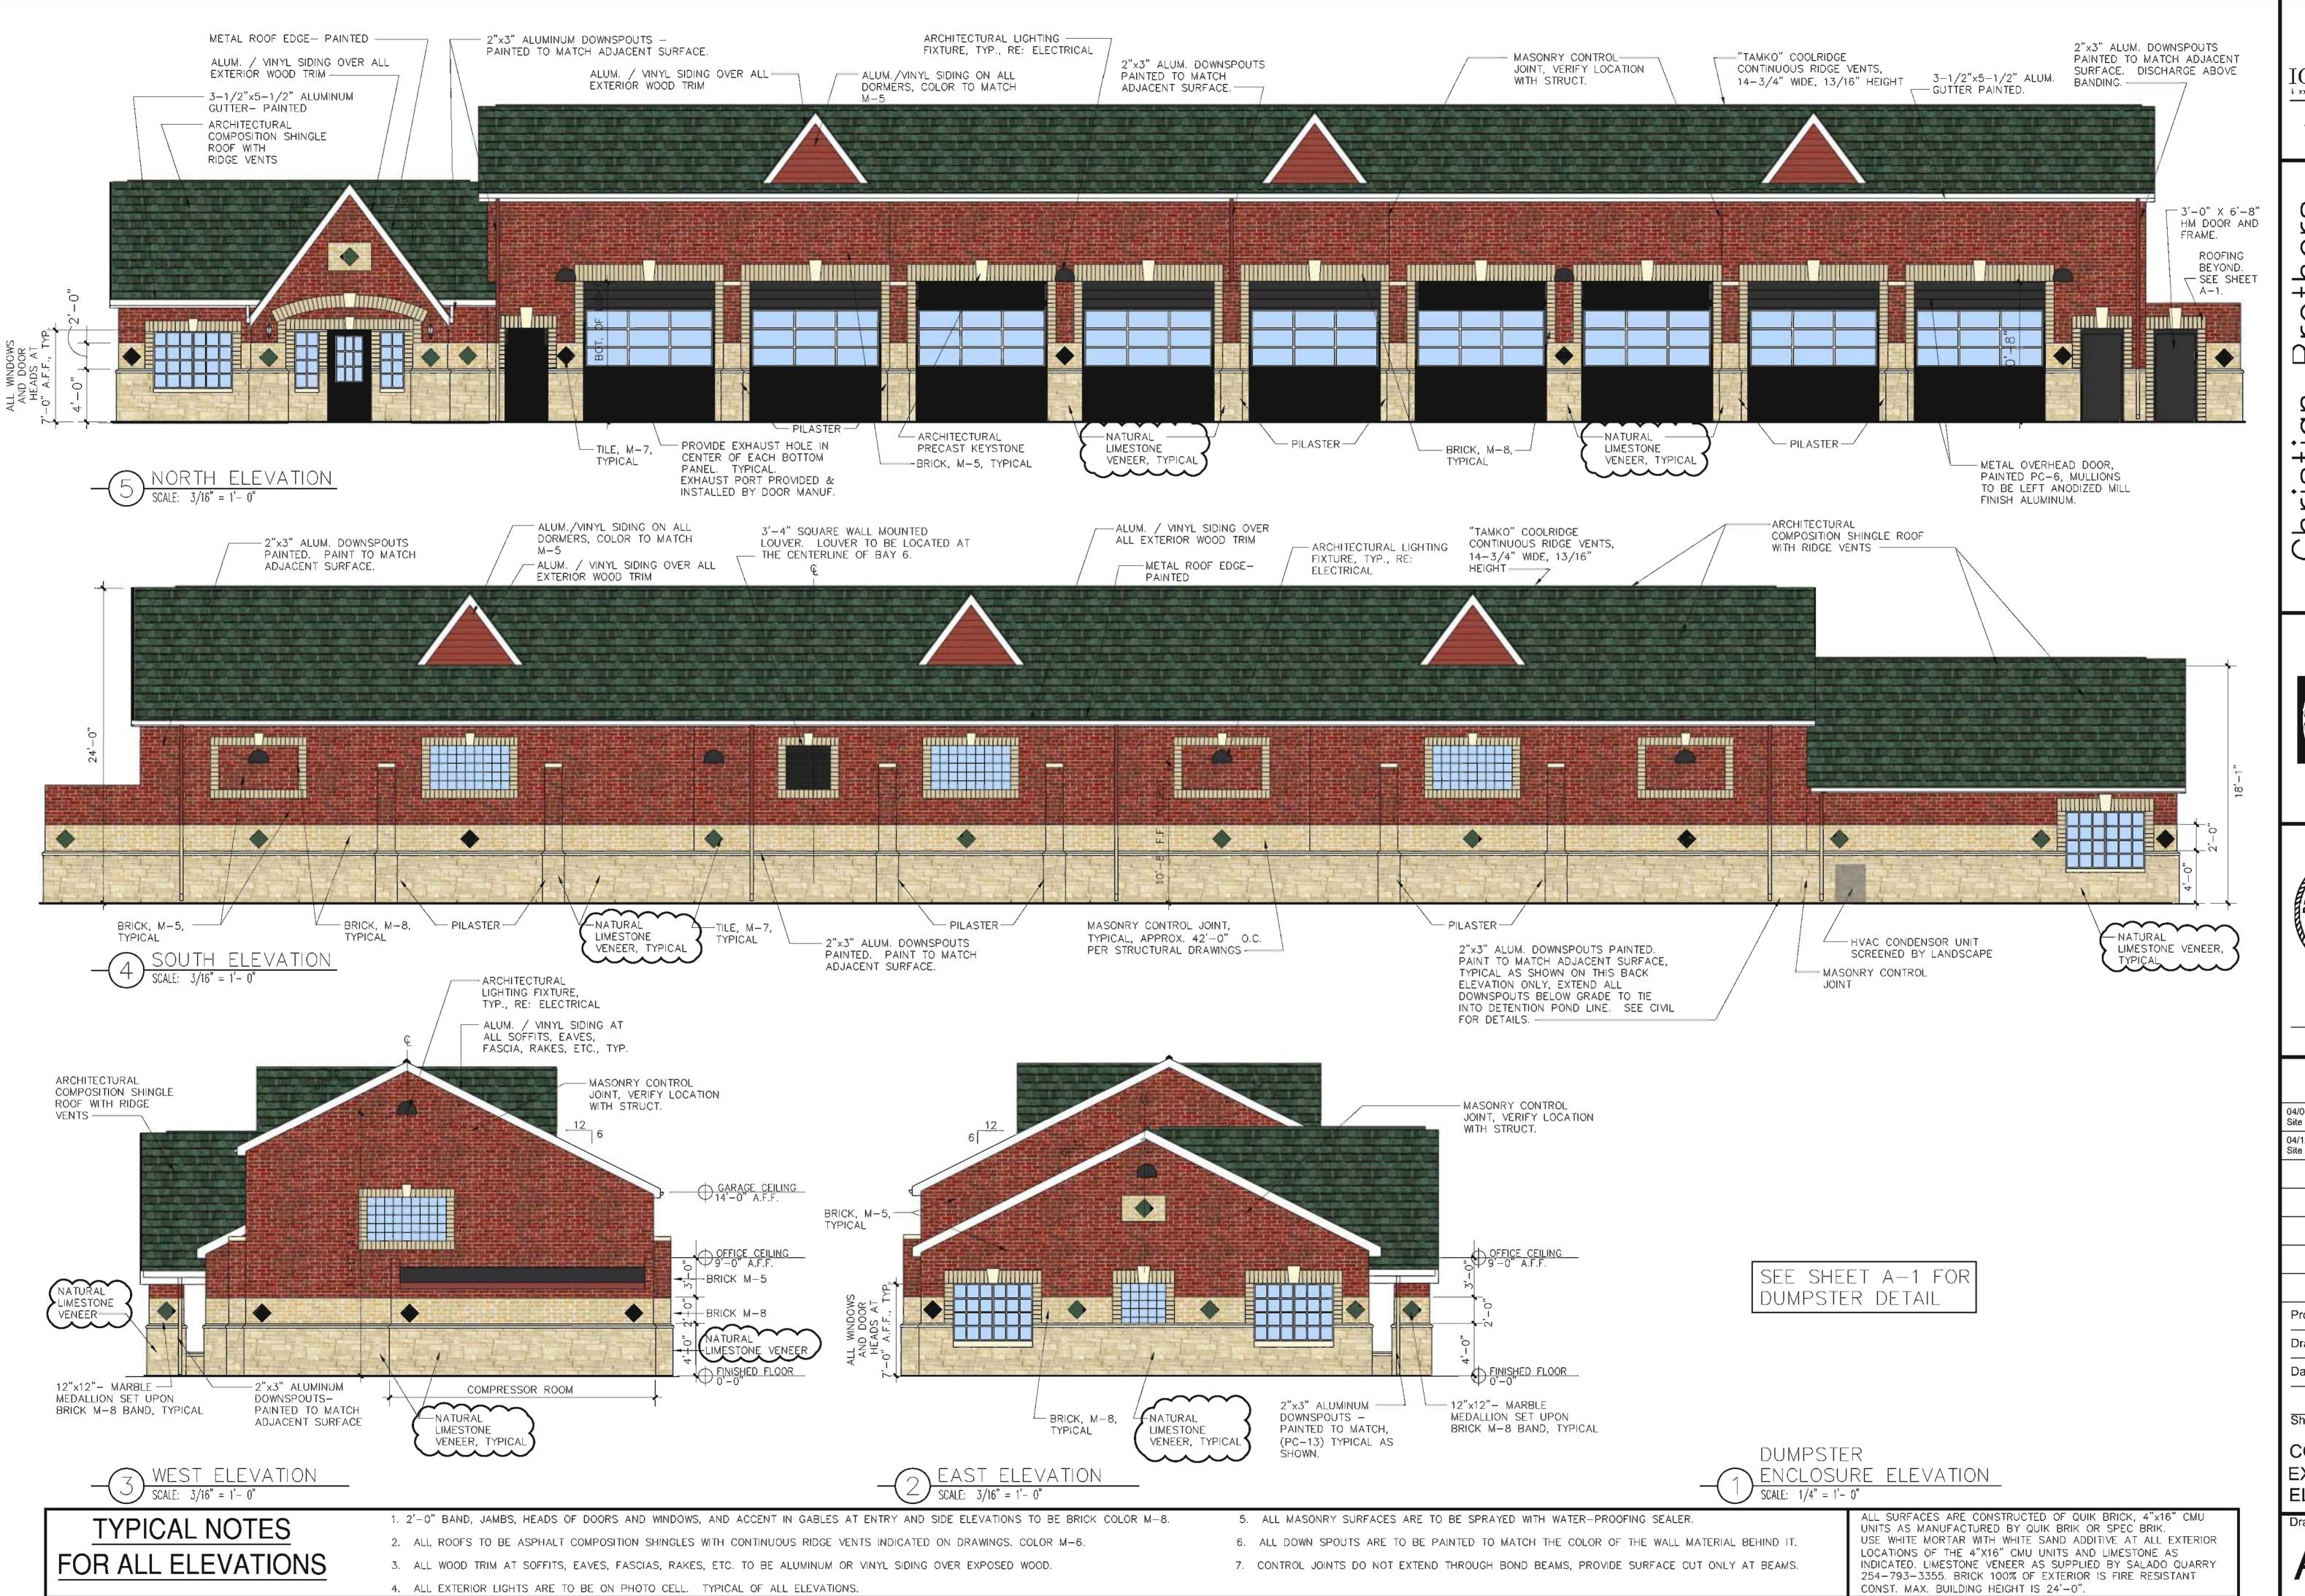

 $\operatorname{ICON}\!$ Architects incorporated

6104 Fannin Drive Arlington, Texas 76001 Phn: 817.665.0200

Fax: 817.665.0202

2 \Box **+** —



04/12/11

Revisions

04/01/11 - Revision 1 - Per City Site Plan Comments 04/12/11 - Revision 2 - Per City

Site Plan Comments

Project No. 10-35

Drawn By: DK


Date: 02/25/11


Sheet Title:

COLOR **EXTERIOR ELEVATIONS**

Drawing No.

A-4.

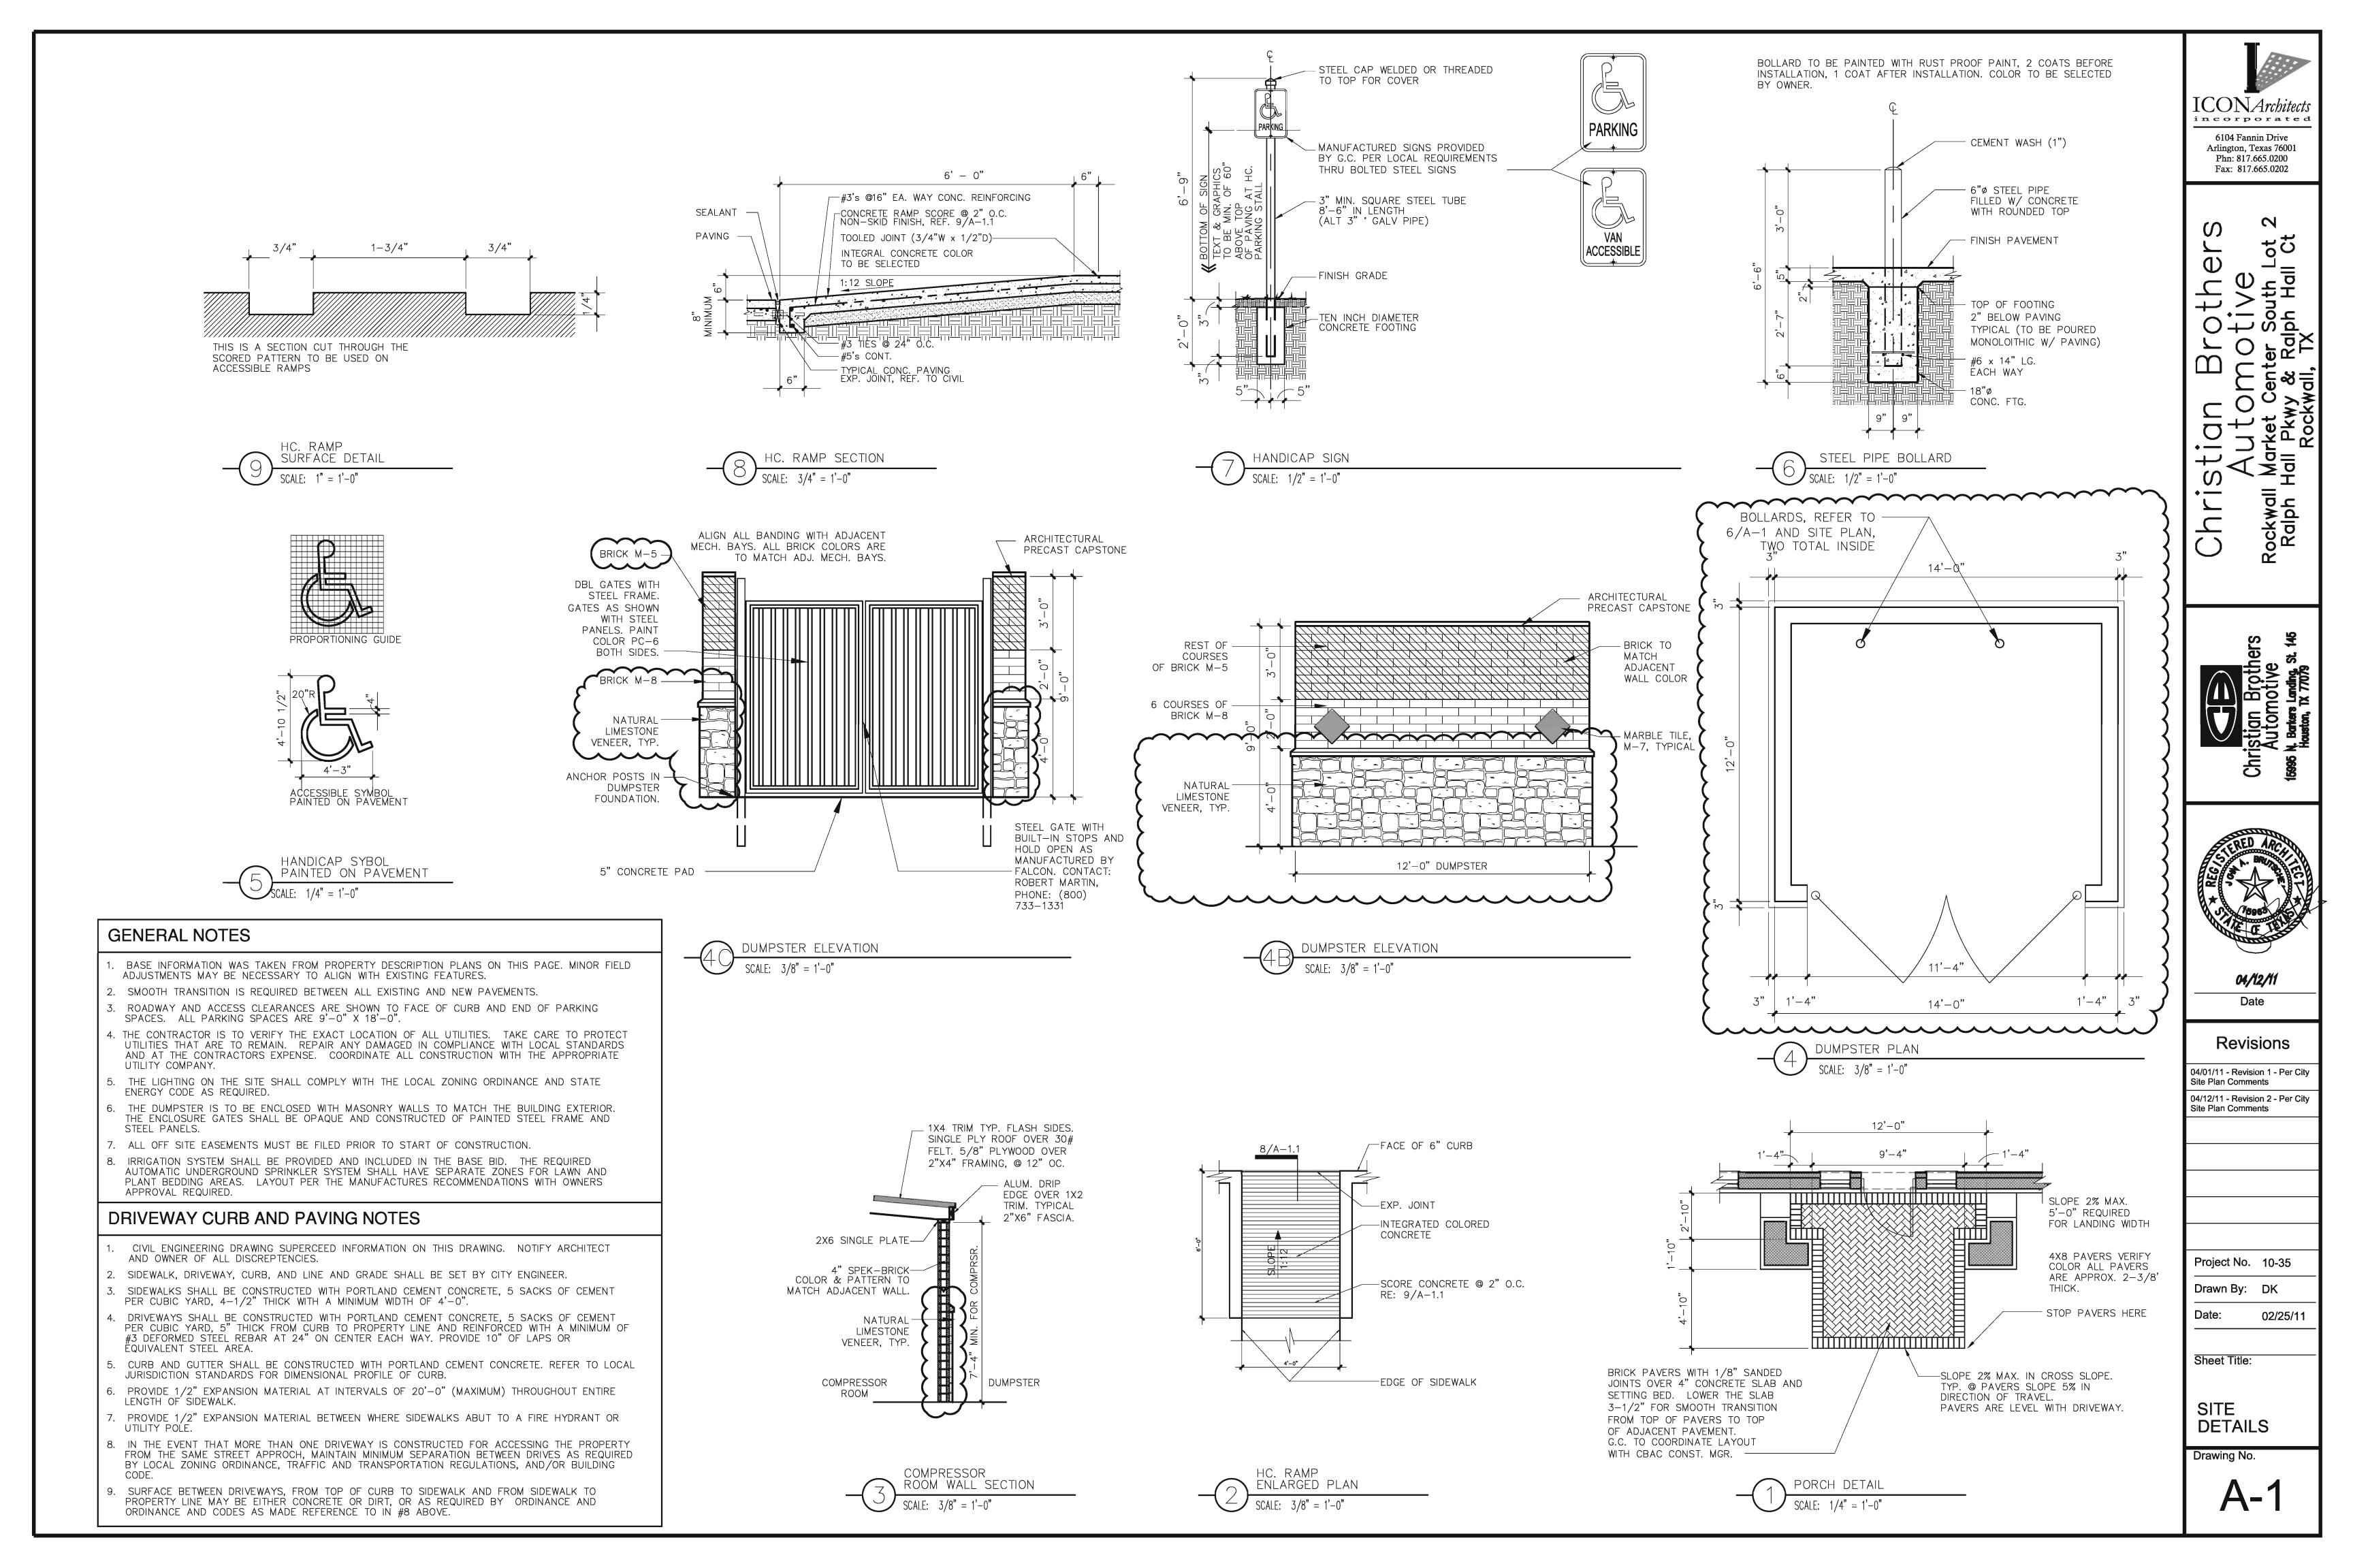

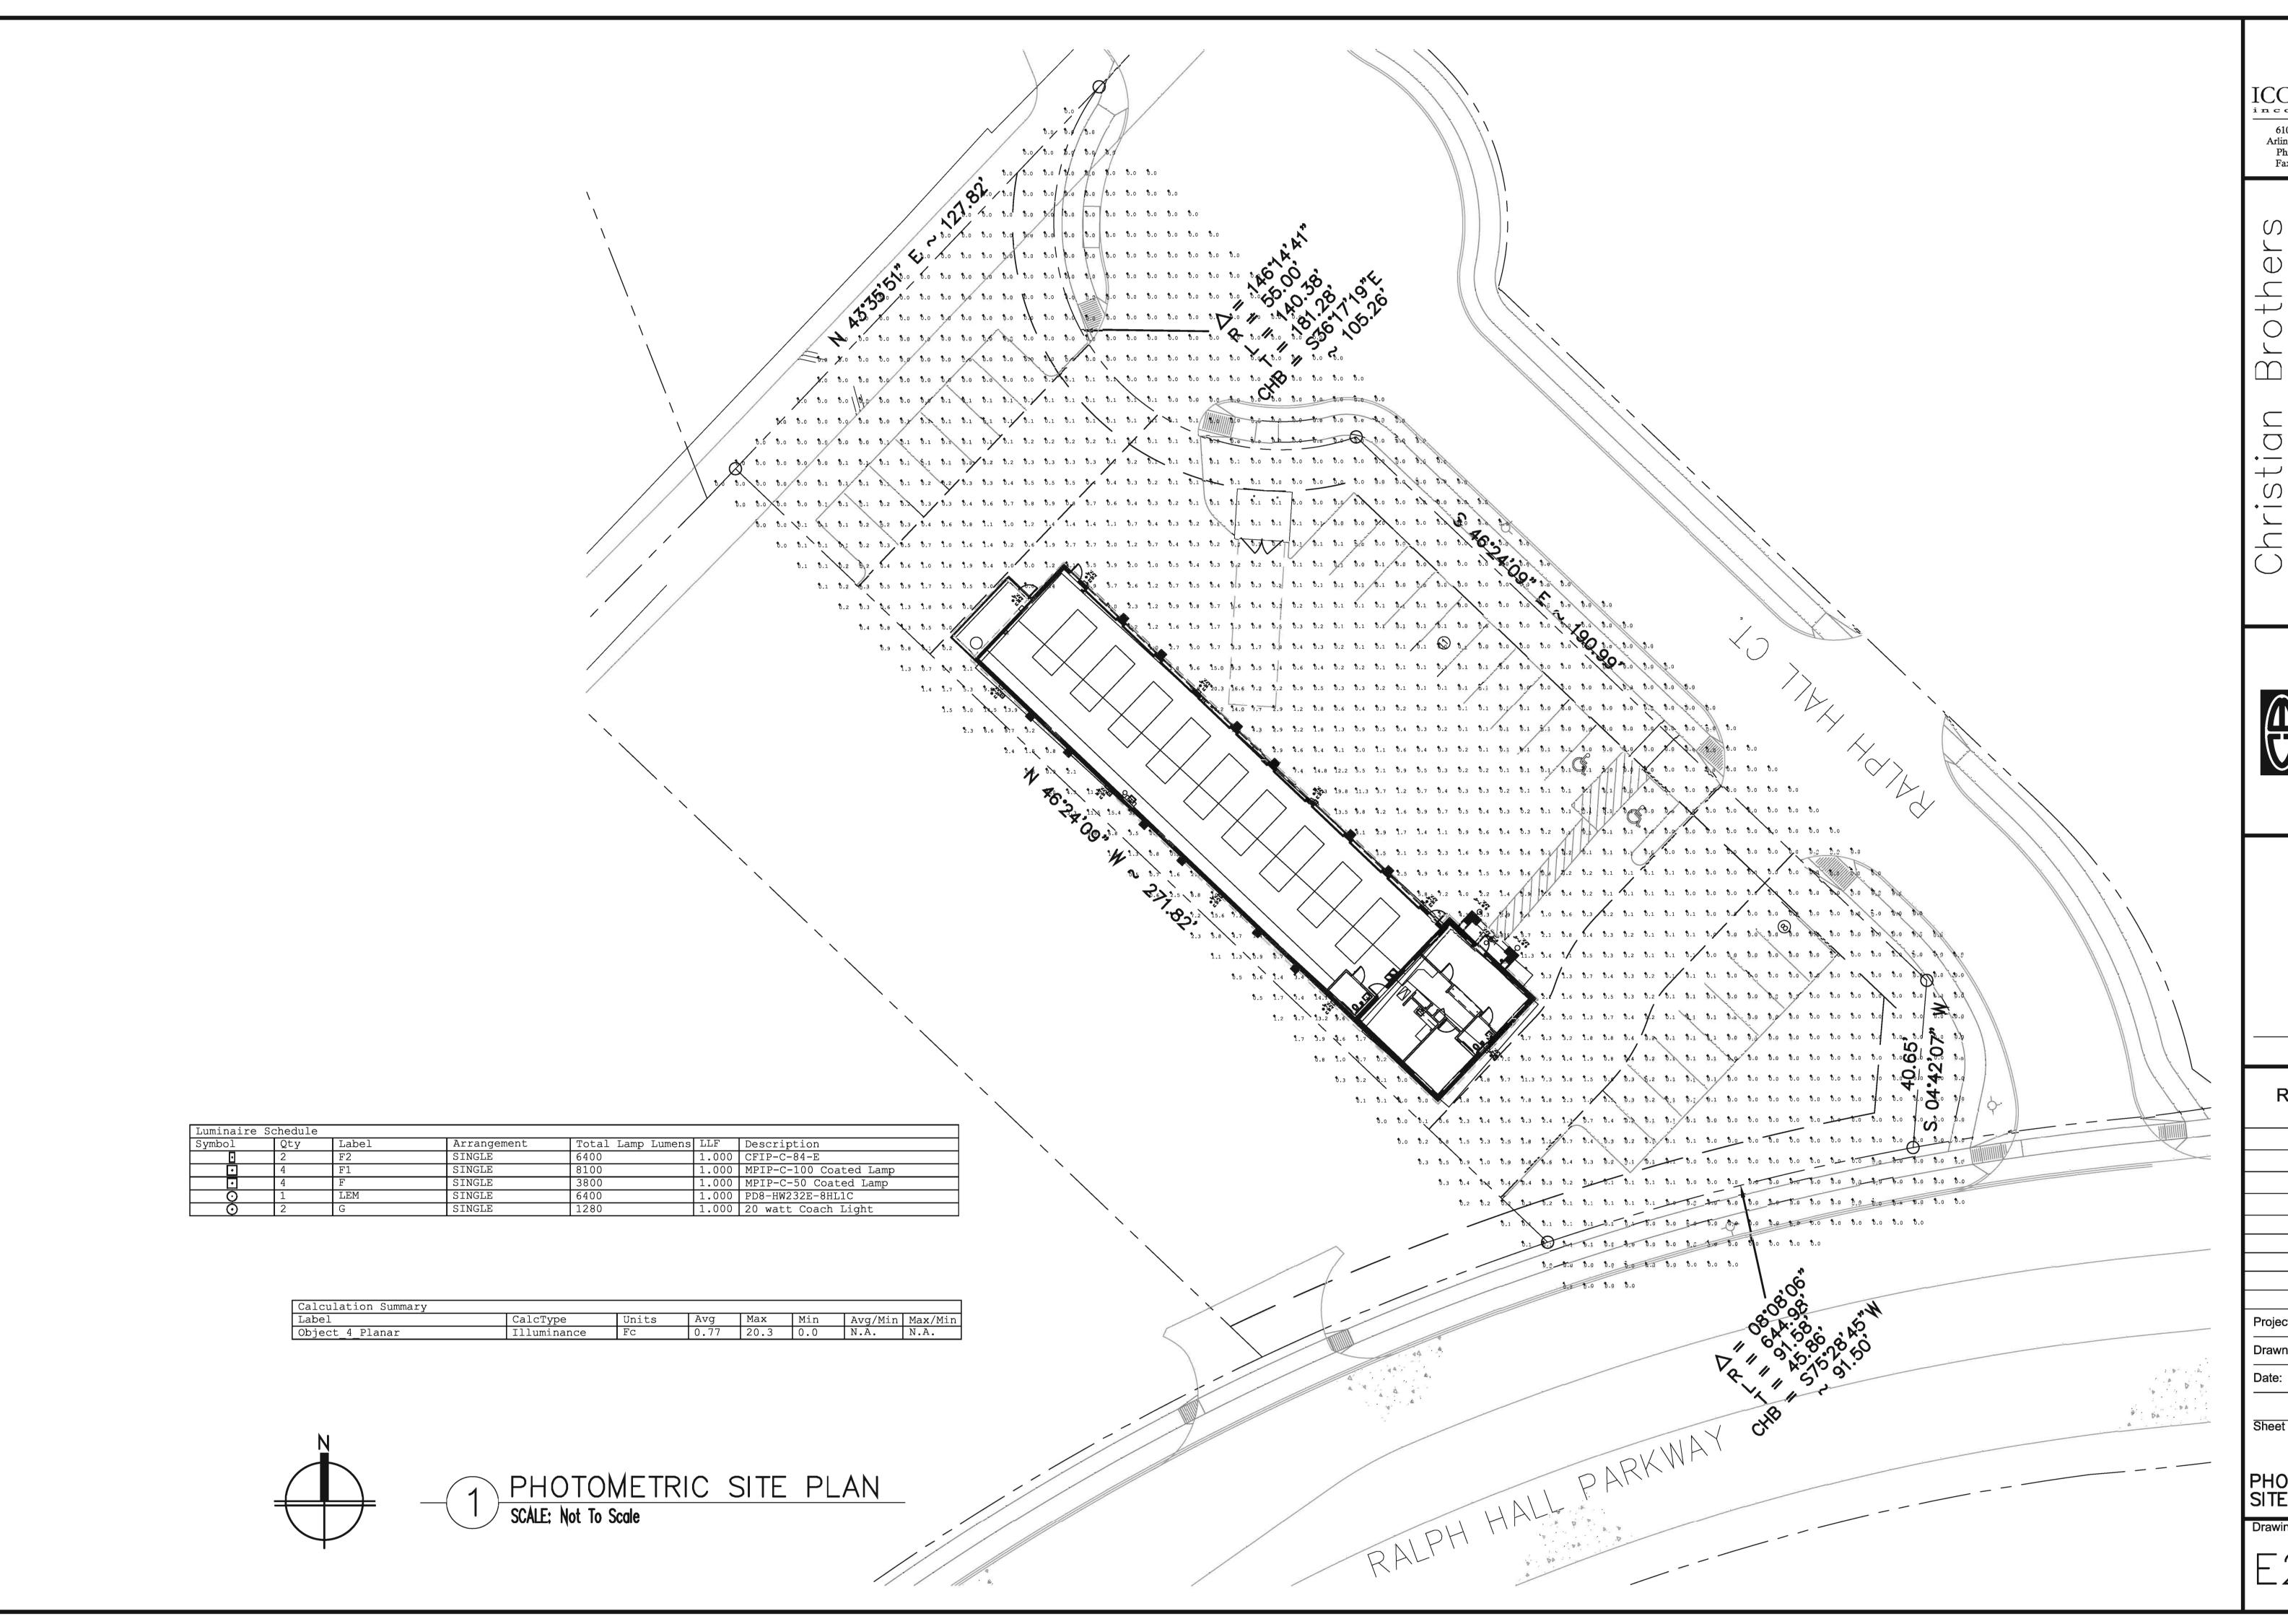

6104 Fannin Drive Arlington, Texas 76001 Phn: 817.665.0200 Fax: 817.665.0202

Date

Revisions

Project No. 10-35

Drawn By: DK

02/25/11

Sheet Title:

PHOTOMETRIC SITE PLAN

Drawing No.

COOPER LIGHTING - LUMARK®

DESCRIPTION

The IMPACT Wedge cutoff wall luminaire makes an ideal complement to site design. U.L. and CUL Listed for wet locations in down mount applications and damp locations in up mounted applications.

Rugged construction and full cutoff classified optics provide facade and security lighting for light restricted zones surrounding schools, office complexes, apartments, and recreational facilities.

Catalog #	Туре	
	F	
Project	F	
Comments	Date	
	_	
Prepared by		

SPECIFICATION FEATURES

A ... Housing

The housing is a two-piece design of die-cast aluminum for precise control of tolerances and repeatability.

B ... Mounting

Gasketed and zinc plated rigid steel mounting attachment fits directly to 4" J-Box or wall with "Hook-N-Lock" mechanism for quick installation. Secured with two (2) captive corrosion resistant black oxide coated allen head set screws concealed but accessible from bottom.

C ... Optical Modules

All optical modules utilize high performance 95% reflective sheet. Strong Type II optical module is standard.

D ... Ballast

HID luminaires supplied with high power factor ballast with Class H insulation. Minimum starting temperatures are -40°C (-40°F) for HPS and -30°C (-22°F) for MP. Compact Fluorescent luminaires feature electronic universal 120-277V high efficient 50/60Hz ballast with -18°C (0°F) minimum starting.

E ... Door

Die-cast door features, 1/8" heatand impact-resistant clear tempered glass lens mounted with internal plated steel clips and sealed with EPDM gasketing. Hinged door secured in place via two (2) captive fasteners.

F ... Finish


Durable polyester powder coat finish. Standard color is Bronze. Optional premium colors include: White, Black, Grey, Graphite Metallic, and Dark Platinum. Other finish colors available. Consult your Cooper Lighting Representative concerning special color requirements.



IP IMPACT WEDGE


50 - 175W High Pressure Sodium Pulse Start Metal Halide Metal Halide 26 - 84W Compact Fluorescent



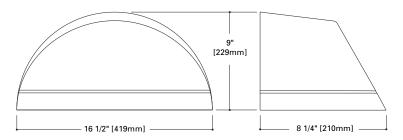

HOOK-N-LOCK MOUNTING

(Mounting attachment included. J-Box not included.)

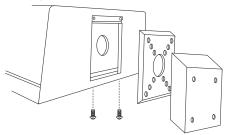





In downlight applications only.

TECHNICAL DATA

UL1598 Listed, CUL Listed 25°C Maximum Ambient Temperature External Supply Wiring 90°C Minimum Down Mounted —Wet Location Up Mounted —Damp Location

ENERGY DATA

High Reactance Ballast Input Watts 50W HPS HPF (66 Watts)

50W MP HPF (72 Watts) 70W HPS HPF (91 Watts) 70W MP HPF (90 Watts) 100W HPS HPF (130 Watts) 100W MP HPF (129 Watts) 150W MP HPF (190 Watts) 150W MP HPF (185 Watts)

CWA Ballast Input Watts 175W MH HPF (210 Watts)

Electronic Ballast Input Watts 26W CE HPF (29 Watts)


32W CF HPF (36 Watts) 42W CF HPF (46 Watts) 52W CF HPF (55 Watts)

SHIPPING DATA Approximate Net Weight:

18 lbs. (8 kgs.)





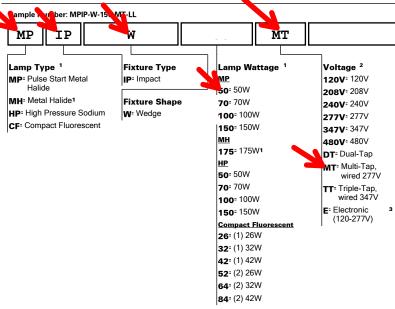

- Lamp type not available in all wattages see wattage table. HID lamps are medium base. 480V not available in 50W or 70W.175W MH is available for non-U.S. markets only. Notes: 1
 - Products also available in non-US voltages and 50HZ for international markets. Consult your Cooper Representative for availabiltiy and ordering information.
 - Available with CF Option only. In cold temperatures, compact fluorescent lamps produce lower illumination
 - PE not available with 480V.
 - Down lighting position only.
 - (1) 120V Lamp, 100W maximum quartz lamp. Utility power may need to cycle to allow HID lamp to cool in warm climates. Not available with CF Option. Lamp supplied by others.
 - Leads out of the back of the unit for auxillary 120V.
 - Not available with CF lamps.
 - (1) or (2) 120V Lamps. GU10 base, 50W maximum each. Lamps supplied by others.
 - Not Available with 52, 64, 84 CF wattages. 10
 - (1) or (2) 12V bi-pin lamp, socket GU5.3 base, 35W maximum. Power supplied by low voltage DC source 11 (supplied by others). Lamps supplied by others
 - Specify 120 or 277V, (-18°C) minimum temperature.
 - Specify 120 or 277V, (0°C) minimum temperature.

Options

F1= Single Fuse, Specify Voltage (120, 277, or 347V)

т.т.

F2= Double Fuse, Specify Voltage (208 or 240V)

PE: Button Photocontrol (Specify Voltage)4

BK: Black

WH= White AP: Grey

GM= Graphite Metallic

DP= Dark Platinum

LL= Lamp Included (Must Specify Wattage on CF)

TR= Tamper Resistant Hardware (2 Door Screws)

HS: House-side Shield Glass3

PL= Polycarbonate Lens3, 5

Q= Quartz Restrike (1)T4 Lamp6

EM= Emergency Quartz Restrike (1) T4 Lamp with Time6

EM/SC= Emergency Separate Circuit (1) T4 Lamp^{6, 7}

QMR= Quartz Restrike (1) MR16 Lamp8, 9 2QMR= Quartz Restrike (2) MR16 Lamps8, 9

2QMR/SC: Quartz Restrike (1) MR16 Lamp and (1) 7, 8, 9

Emergency Separate Circuit MR16 Lamp

EMMR= Emergency Quartz Restrike (1) MR16 Lamp with8, 9 Time Delay Relay

2EMMR⁻ Emergency Quartz Restrike (2) MR16 Lamps^{8, 9} with Time Delay Relay

EM/SC/MR= Emergency Separate Circuit (1) MR167, 9, 10 Lamp

2EM/SC/MR= Emergency Separate Circuit (2) MR167, 9, 10 Lamps

2EMMR/SC= Emergency Quartz Restrike with Time 7, 8, 9 Delay Relay (1) MR16 and (1) MR16 Emergency Separate Circuit Lamp

EM/SC/12V= Emergency Separate Circuit 12V Low7, 11 Voltage (1) MR16 Lamp


2EM/SC/12V= Emergency Separate Circuit 12V Low7, 11

Voltage (2) MR16 Lamps EMI40 - Emergency Cold Temperature (UL924 Listed) 12

Power Pack -18 degrees C/0 degrees F, (1) CF Lamp,(Specify Voltage Below)

CF-EM= Emergency CF Power Pack (UL924 Listed) (1) CF13 Lamp. 0 degrees C/32 degrees F, (Specify Voltage Below)

STOCK SAMPLE NUMBER (Lamp Included)

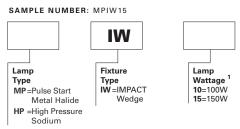


NOTES:

Standard multi-tap and bronze. Refer to In-Stock Guide for availability. Options not available with stock products. Refer to standard order information to add options


LAMP TYPE	WATTAGE	DISTRIBUTION
Pulse Start Metal Halide (MP)	50, 70, 100, 150W	TYPE II
Metal Halide (MH)	175W	TYPE II
High Pressure Sodium (HP)	50, 70, 100, 150W	TYPE II
Compact Fluorescent (CF)	(1) 26, (1) 32, (1) 42, (2) 26, (2) 32, (2) 42W	TYPE II

VOLTAGE CHART	
DT=Dual-Tap	120/277 (wired 277V)
MT=Multi-Tap	120/208/240/277 (wired 277V)
TT=Triple-Tap	120/277/347 (wired 347V)
E=Electronic Ballast (CF only)	120-277V (wired 277V) (50/60 HZ)


PHOTOMETRICS (Complete IES files available at www.cooperlighting.com)

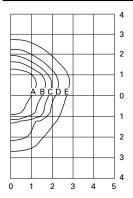



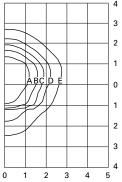

HPIP-W-150 150-Watt HP 16,000-Lumen Clear Lamp

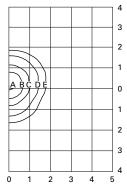

CFIP-W-42-E 42-Watt CF 3,200-Lumen Lamp

Footcandle Table
Select mounting height and read across for footcandle values of each isofootcandle line. Distance in units of mounting height.

iviounting	Footca	Footcangle values for			
Height	Isofoot	Isofootcandle Lines			
	Α	В	С	D	E
MPIP-W-15	0 / HPIP-	W-150			
10'	7.20	2.88	1.44	0.72	0.29
12'	5.00	2.00	1.00	0.50	0.20
14'	3.65	1.46	0.73	0.37	0.07
CFIP-W-42-	E				
18'	2.46	1.23	0.62	0.25	0.12
20'	2.00	1.00	0.50	0.20	0.10
25'	1.28	0.64	0.32	0.13	0.06



COOPER LIGHTING - LUMARK®

DESCRIPTION

The IMPACT Wedge cutoff wall luminaire makes an ideal complement to site design. U.L. and CUL Listed for wet locations in down mount applications and damp locations in up mounted applications.

Rugged construction and full cutoff classified optics provide facade and security lighting for light restricted zones surrounding schools, office complexes, apartments, and recreational facilities.

Catalog #	Туре
Project	F1
Comments	Date
Prepared by	

SPECIFICATION FEATURES

A ... Housing

The housing is a two-piece design of die-cast aluminum for precise control of tolerances and repeatability.

B ... Mounting

Gasketed and zinc plated rigid steel mounting attachment fits directly to 4" J-Box or wall with "Hook-N-Lock" mechanism for quick installation. Secured with two (2) captive corrosion resistant black oxide coated allen head set screws concealed but accessible from bottom.

C ... Optical Modules

All optical modules utilize high performance 95% reflective sheet. Strong Type II optical module is standard.

D ... Ballast

HID luminaires supplied with high power factor ballast with Class H insulation. Minimum starting temperatures are -40°C (-40°F) for HPS and -30°C (-22°F) for MP. Compact Fluorescent luminaires feature electronic universal 120-277V high efficient 50/60Hz ballast with -18°C (0°F) minimum starting.

E ... Door

Die-cast door features, 1/8" heatand impact-resistant clear tempered glass lens mounted with internal plated steel clips and sealed with EPDM gasketing. Hinged door secured in place via two (2) captive fasteners.

F ... Finish


Durable polyester powder coat finish. Standard color is Bronze. Optional premium colors include: White, Black, Grey, Graphite Metallic, and Dark Platinum. Other finish colors available. Consult your Cooper Lighting Representative concerning special color requirements.



IMPACT WEDGE

50 - 175W **High Pressure Sodium Pulse Start Metal Halide** Metal Halide 26 - 84W **Compact Fluorescent**



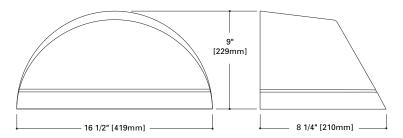

TECHNICAL DATA

UL1598 Listed, CUL Listed 25°C Maximum Ambient Temperature External Supply Wiring 90°C Minimum Down Mounted - Wet Location Up Mounted - Damp Location

ENERGY DATA

High Reactance Ballast Input Watts

50W HPS HPF (66 Watts) 50W MP HPF (72 Watts) 70W HPS HPF (91 Watts) 70W MP HPF (90 Watts) 100W HPS HPF (130 Watts) 100W MP HPF (129 Watts) 150W HPS HPF (190 Watts) 150W MP HPF (185 Watts)

CWA Ballast Input Watts 175W MH HPF (210 Watts)

Electronic Ballast Input Watts

26W CF HPF (29 Watts) 32W CF HPF (36 Watts) 42W CF HPF (46 Watts) 52W CF HPF (55 Watts)


SHIPPING DATA Approximate Net Weight:

18 lbs. (8 kgs.)



HOOK-N-LOCK MOUNTING


(Mounting attachment included. J-Box not included.)

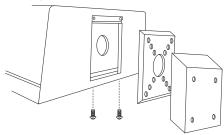







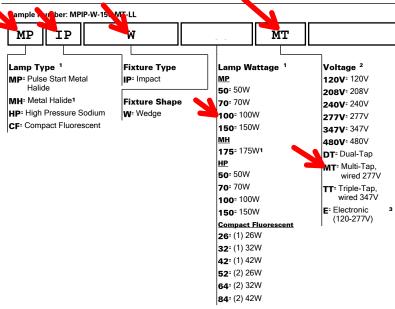

- Lamp type not available in all wattages see wattage table. HID lamps are medium base. 480V not available in 50W or 70W.175W MH is available for non-U.S. markets only. Notes: 1
 - Products also available in non-US voltages and 50HZ for international markets. Consult your Cooper Representative for availabiltiy and ordering information.
 - Available with CF Option only. In cold temperatures, compact fluorescent lamps produce lower illumination
 - PE not available with 480V.
 - Down lighting position only.
 - (1) 120V Lamp, 100W maximum quartz lamp. Utility power may need to cycle to allow HID lamp to cool in warm climates. Not available with CF Option. Lamp supplied by others.
 - Leads out of the back of the unit for auxillary 120V.
 - Not available with CF lamps.
 - (1) or (2) 120V Lamps. GU10 base, 50W maximum each. Lamps supplied by others.
 - Not Available with 52, 64, 84 CF wattages. 10
 - (1) or (2) 12V bi-pin lamp, socket GU5.3 base, 35W maximum. Power supplied by low voltage DC source 11 (supplied by others). Lamps supplied by others
 - Specify 120 or 277V, (-18°C) minimum temperature.
 - Specify 120 or 277V, (0°C) minimum temperature.

Options

F1= Single Fuse, Specify Voltage (120, 277, or 347V)

т.т.

F2: Double Fuse, Specify Voltage (208 or 240V)

PE: Button Photocontrol (Specify Voltage)4

BK: Black WH= White

AP: Grey

GM= Graphite Metallic

DP= Dark Platinum

LL= Lamp Included (Must Specify Wattage on CF)

TR= Tamper Resistant Hardware (2 Door Screws)

HS: House-side Shield Glass3

PL= Polycarbonate Lens3, 5

Q= Quartz Restrike (1)T4 Lamp6

EM= Emergency Quartz Restrike (1) T4 Lamp with Time6

EM/SC= Emergency Separate Circuit (1) T4 Lamp^{6, 7}

QMR= Quartz Restrike (1) MR16 Lamp8, 9

2QMR= Quartz Restrike (2) MR16 Lamps8, 9

2QMR/SC: Quartz Restrike (1) MR16 Lamp and (1) 7, 8, 9 Emergency Separate Circuit MR16 Lamp

EMMR= Emergency Quartz Restrike (1) MR16 Lamp with8, 9 Time Delay Relay

2EMMR⁻ Emergency Quartz Restrike (2) MR16 Lamps^{8, 9} with Time Delay Relay

EM/SC/MR= Emergency Separate Circuit (1) MR167, 9, 10

Lamp 2EM/SC/MR= Emergency Separate Circuit (2) MR167, 9, 10

Lamps

2EMMR/SC= Emergency Quartz Restrike with Time 7, 8, 9 Delay Relay (1) MR16 and (1) MR16 Emergency Separate Circuit Lamp

EM/SC/12V= Emergency Separate Circuit 12V Low7, 11 Voltage (1) MR16 Lamp


2EM/SC/12V= Emergency Separate Circuit 12V Low7, 11 Voltage (2) MR16 Lamps

EMI40 - Emergency Cold Temperature (UL924 Listed) 12

Power Pack -18 degrees C/0 degrees F, (1) CF Lamp,(Specify Voltage Below)

CF-EM= Emergency CF Power Pack (UL924 Listed) (1) CF13 Lamp. 0 degrees C/32 degrees F, (Specify Voltage Below)

STOCK SAMPLE NUMBER (Lamp Included)

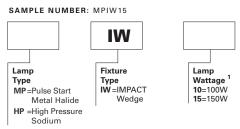


NOTES:

Standard multi-tap and bronze. Refer to In-Stock Guide for availability. Options not available with stock products. Refer to standard order information to add options


LAMP TYPE	WATTAGE	DISTRIBUTION
Pulse Start Metal Halide (MP)	50, 70, 100, 150W	TYPE II
Metal Halide (MH)	175W	TYPE II
High Pressure Sodium (HP)	50, 70, 100, 150W	TYPE II
Compact Fluorescent (CF)	(1) 26, (1) 32, (1) 42, (2) 26, (2) 32, (2) 42W	TYPE II

VOLTAGE CHART	
DT=Dual-Tap	120/277 (wired 277V)
MT=Multi-Tap	120/208/240/277 (wired 277V)
TT=Triple-Tap	120/277/347 (wired 347V)
E=Electronic Ballast (CF only)	120-277V (wired 277V) (50/60 HZ)


PHOTOMETRICS (Complete IES files available at www.cooperlighting.com)

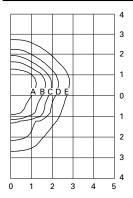



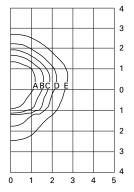

HPIP-W-150 150-Watt HP 16,000-Lumen Clear Lamp

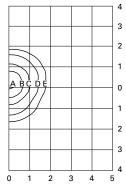

CFIP-W-42-E 42-Watt CF 3,200-Lumen Lamp

Footcandle Table
Select mounting height and read across for footcandle values of each isofootcandle line.
Distance in units of mounting height.
Mounting Footcandle Values for

Mounting	Footca	Footcandle Values for			
Height	Isofoot	Isofootcandle Lines			
	Α	В	С	D	E
MPIP-W-15	0 / HPIP-	W-150			
10'	7.20	2.88	1.44	0.72	0.29
12'	5.00	2.00	1.00	0.50	0.20
14'	3.65	1.46	0.73	0.37	0.07
CFIP-W-42-	E				
18'	2.46	1.23	0.62	0.25	0.12
20'	2.00	1.00	0.50	0.20	0.10
25'	1.28	0.64	0.32	0.13	0.06



COOPER LIGHTING - LUMARK®

DESCRIPTION

The IMPACT Wedge cutoff wall luminaire makes an ideal complement to site design. U.L. and CUL Listed for wet locations in down mount applications and damp locations in up mounted applications.

Rugged construction and full cutoff classified optics provide facade and security lighting for light restricted zones surrounding schools, office complexes, apartments, and recreational facilities.

Catalog #	Туре
	F2
Project	
Comments	Date
Prepared by	

SPECIFICATION FEATURES

A ... Housing

The housing is a two-piece design of die-cast aluminum for precise control of tolerances and repeatability.

B ... Mounting

Gasketed and zinc plated rigid steel mounting attachment fits directly to 4" J-Box or wall with "Hook-N-Lock" mechanism for quick installation. Secured with two (2) captive corrosion resistant black oxide coated allen head set screws concealed but accessible from bottom.

C ... Optical Modules

All optical modules utilize high performance 95% reflective sheet. Strong Type II optical module is standard.

D ... Ballast

HID luminaires supplied with high power factor ballast with Class H insulation. Minimum starting temperatures are -40°C (-40°F) for HPS and -30°C (-22°F) for MP. Compact Fluorescent luminaires feature electronic universal 120-277V high efficient 50/60Hz ballast with -18°C (0°F) minimum starting.

E ... Door

Die-cast door features, 1/8" heatand impact-resistant clear tempered glass lens mounted with internal plated steel clips and sealed with EPDM gasketing. Hinged door secured in place via two (2) captive fasteners.

F ... Finish


Durable polyester powder coat finish. Standard color is Bronze. Optional premium colors include: White, Black, Grey, Graphite Metallic, and Dark Platinum. Other finish colors available. Consult your Cooper Lighting Representative concerning special color requirements.



IP IMPACT WEDGE


50 - 175W High Pressure Sodium Pulse Start Metal Halide Metal Halide 26 - 84W Compact Fluorescent

FULL CUTOFF
WALL MOUNT LUMINAIRE

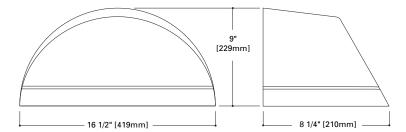

HOOK-N-LOCK MOUNTING

(Mounting attachment included. J-Box not included.)

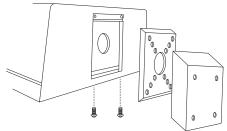





In downlight applications only.

TECHNICAL DATA

UL1598 Listed, CUL Listed 25°C Maximum Ambient Temperature External Supply Wiring 90°C Minimum Down Mounted –Wet Location Up Mounted – Damp Location

ENERGY DATA

High Reactance Ballast Input Watts

50W HPS HPF (66 Watts) 50W MP HPF (72 Watts) 70W HPS HPF (91 Watts) 70W MP HPF (90 Watts) 100W HPS HPF (130 Watts) 100W MP HPF (129 Watts) 150W HPS HPF (190 Watts)

CWA Ballast Input Watts 175W MH HPF (210 Watts)

Electronic Ballast Input Watts

26W CF HPF (29 Watts) 32W CF HPF (36 Watts) 42W CF HPF (46 Watts) 52W CF HPF (55 Watts)


SHIPPING DATA Approximate Net Weight:

18 lbs. (8 kgs.)





Sample Number: MPIP-W-150-MT-LL

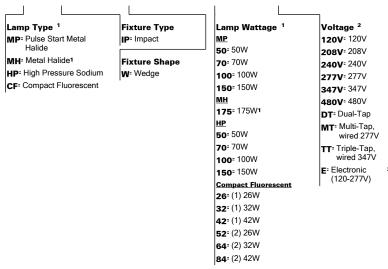

- Lamp type not available in all wattages see wattage table. HID lamps are medium base. 480V not available in 50W or 70W.175W MH is available for non-U.S. markets only. Notes: 1
 - Products also available in non-US voltages and 50HZ for international markets. Consult your Cooper Representative for availabiltiy and ordering information.
 - Available with CF Option only. In cold temperatures, compact fluorescent lamps produce lower illumination
 - PE not available with 480V.
 - Down lighting position only.
 - (1) 120V Lamp, 100W maximum quartz lamp. Utility power may need to cycle to allow HID lamp to cool in warm climates. Not available with CF Option. Lamp supplied by others.
 - Leads out of the back of the unit for auxillary 120V.
 - Not available with CF lamps.
 - (1) or (2) 120V Lamps. GU10 base, 50W maximum each. Lamps supplied by others.
 - Not Available with 52, 64, 84 CF wattages. 10
 - (1) or (2) 12V bi-pin lamp, socket GU5.3 base, 35W maximum. Power supplied by low voltage DC source 11 (supplied by others). Lamps supplied by others
 - Specify 120 or 277V, (-18°C) minimum temperature
 - Specify 120 or 277V, (0°C) minimum temperature.

Options

F1= Single Fuse, Specify Voltage (120, 277, or 347V)

F2= Double Fuse, Specify Voltage (208 or 240V)

PE: Button Photocontrol (Specify Voltage)4

BK: Black WH= White

AP: Grey

GM= Graphite Metallic

DP= Dark Platinum

LL= Lamp Included (Must Specify Wattage on CF)

TR= Tamper Resistant Hardware (2 Door Screws)

HS: House-side Shield Glass3

PL= Polycarbonate Lens3, 5

Q= Quartz Restrike (1)T4 Lamp6

EM= Emergency Quartz Restrike (1) T4 Lamp with Time6

EM/SC= Emergency Separate Circuit (1) T4 Lamp^{6, 7}

QMR= Quartz Restrike (1) MR16 Lamp8, 9 2QMR= Quartz Restrike (2) MR16 Lamps8, 9

2QMR/SC: Quartz Restrike (1) MR16 Lamp and (1) 7, 8, 9 Emergency Separate Circuit MR16 Lamp

EMMR= Emergency Quartz Restrike (1) MR16 Lamp with8, 9 Time Delay Relay

2EMMR⁻ Emergency Quartz Restrike (2) MR16 Lamps^{8, 9} with Time Delay Relay

EM/SC/MR= Emergency Separate Circuit (1) MR167, 9, 10 Lamp

2EM/SC/MR= Emergency Separate Circuit (2) MR167, 9, 10 Lamps

2EMMR/SC= Emergency Quartz Restrike with Time 7, 8, 9

Delay Relay (1) MR16 and (1) MR16 Emergency Separate Circuit Lamp


EM/SC/12V= Emergency Separate Circuit 12V Low7, 11 Voltage (1) MR16 Lamp

2EM/SC/12V Emergency Separate Circuit 12V Low7, 11 Voltage (2) MR16 Lamps

EMI40 - Emergency Cold Temperature (UL924 Listed) 12 Power Pack -18 degrees C/0 degrees F, (1) CF Lamp,(Specify Voltage Below)

CF-EM= Emergency CF Power Pack (UL924 Listed) (1) CF13 Lamp. 0 degrees C/32 degrees F, (Specify Voltage Below)

STOCK SAMPLE NUMBER (Lamp Included)

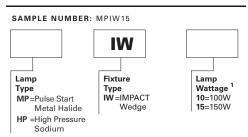

NOTES:


Standard multi-tap and bronze. Refer to In-Stock Guide for availability. Options not available with stock products. Refer to standard order information to add options

LAMP TYPE	WATTAGE	DISTRIBUTION
Pulse Start Metal Halide (MP)	50, 70, 100, 150W	TYPE II
Metal Halide (MH)	175W	TYPE II
High Pressure Sodium (HP)	50, 70, 100, 150W	TYPE II
Compact Fluorescent (CF)	(1) 26, (1) 32, (1) 42, (2) 26, (2) 32, (2) 42W	TYPE II


VOLTAGE CHART	
DT=Dual-Tap	120/277 (wired 277V)
MT=Multi-Tap	120/208/240/277 (wired 277V)
TT=Triple-Tap	120/277/347 (wired 347V)
E=Electronic Ballast (CF only)	120-277V (wired 277V) (50/60 HZ)




PHOTOMETRICS (Complete IES files available at www.cooperlighting.com)

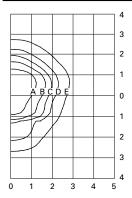



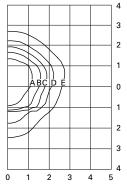

HPIP-W-150 150-Watt HP 16,000-Lumen Clear Lamp

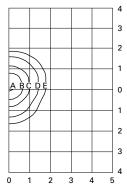

CFIP-W-42-E 42-Watt CF 3,200-Lumen Lamp

Footcandle Table
Select mounting height and read across for footcandle values of each isofootcandle line. Distance in units of mounting height.


Mounting Footcandle Values for

wounting	rootcandle values for						
Height	Isofootcandle Lines						
	Α	В	С	D	E		
MPIP-W-15	0 / HPIP-	W-150					
10'	7.20	2.88	1.44	0.72	0.29		
12'	5.00	2.00	1.00	0.50	0.20		
14'	3.65	1.46	0.73	0.37	0.07		
CFIP-W-42-	E						
18'	2.46	1.23	0.62	0.25	0.12		
20'	2.00	1.00	0.50	0.20	0.10		
25'	1.28	0.64	0.32	0.13	0.06		



6900 / 6600 / 66 HERITAGE

SPECIFICATIONS

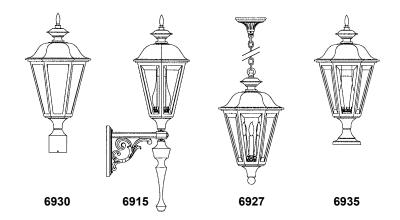

Cat. No.	W	Н	Ext.*	Top to Outlet	Max.** INC	Max. HID	Max. CF
6930	13"	27"			200W	100W†	42W†
6915	13"	38"	161/2"	261/2"	200W	100W††	42W††
6913	13"	301/2"	161/2"	27	200W	100W††	32W††
6912	13"	321/2"	16 ¹ /2"	26 ¹ /2"	200W	100W ^{††}	42W††
6918	13"	30"	161/2"	5"	200W	100W ^{††}	32W††
6927	13"	65" w/	36" cha	in	200W	100W [†]	32W [†]
6935	13"	251/2"			200W	100W ^{††}	42W††
6630†	10"	19"			100W	50W†	26W†
6615	10"	30"	101/2"	15"	100W	50W††	32W††
6616	10"	19"	10 ¹ /2"	15"	100W	50W††	32W††
6617	10"	191/2"	101/2"	71/2"	100W	50W††	32W††
6627	10"	57" w /	'36" cha	iin	100W	50W††	26W
6635	10"	19"			100W	50W††	26W††
66BU	7"	14"	8"	9"	60W		
66LF	7"	20"	8"	9"	60W		




^{*} Add 2" to 4" depending on Ballast Box requirement.


** 3 Light Cluster is 25 watt max lamp per socket. 66 Series not available with 3 Light Cluster.

† Remote Ballast required if HID or CF. †† Ballast Box required.

66 & 6600 Series not available with Frosted Chimney or Refractor.



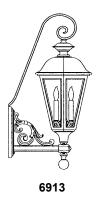

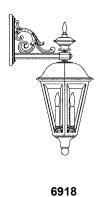

















66BU

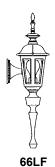

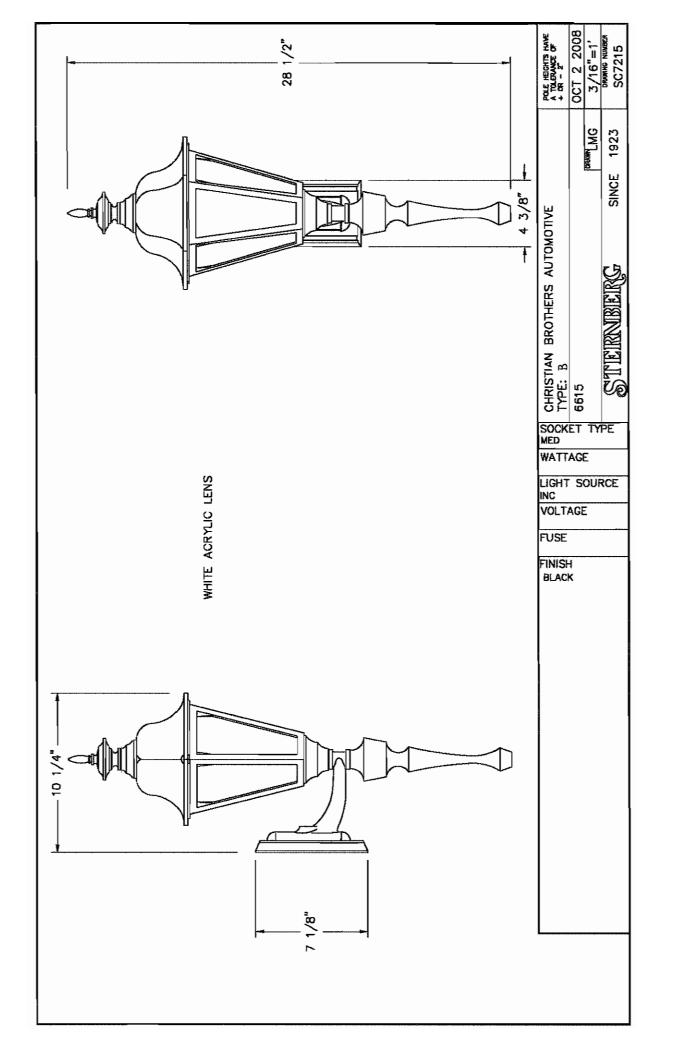

PD8-HLW242EEM/8HL1EMC

TYPE:

_-EM

DESCRIPTION

SPECIFICATION FEATURES

Lamp CF42DTEIN841eco

The PDS emergency fixtures create an architecturally neutral appearance via an internally mounted test switch/indicator light. The elimination of the traditional test switch and separate indicator light mounted externally in a separate junction box, allows for easier installation as well.

The "EM" frame, socket adapter, and battery pack are pre-assembled at the factory and utilize our No Fuss Bar HangersTM to speed installation and minimize labor costs at the job site.

PDS EM reflectors boast equal 55° cutoff to lamp and lamp image. Low-iridescent clear refector with white painted self-flange is standard. Lamp positions lock in place ensuring photometric performance. EM reflectors are punched for test switch/indicator light and are keyed for proper alignment.

A...Clear upper reflector for maximum light output. Choice of prismatic acrylic lens or clear low iridescent radial louver affixed to lower reflector. Louver is .050" thick aluminimum.

B.-Socket Cap

One-piece folded metal cap. Positive connection between cap and reflector is provided by a twistand-lock mechanism. Multiple slots allow for precise lamp positions.

C. Socket and Socket Adapter

4-pin G24q base with stainless steel spring for positive retention. Guide post inserts rejects twopin bases to ensure proper lamping. Multi-voltage electronic ballast accommodates 120V thru 277V.

D...Frame

Galvanized steel frame with 1/2" plaster lip is standard. Accommodates ceilings up to 2" (50mm) thick.

E-No Fuss Bar Hanger

Bar hanger locks to T-bar with a screwdriver or pliers. Centering mechanism allows consistent centering of fixtures, 2 1/2" vertical adjustment and can be used with 1/2" EMT

F-Junction Box

Galvanized with (6) 1/2" and (2) 3/4" KOs. Listed for twelve #12g 90° conductors and feed through wiring.

G.-Internal test switch/indicator light is visible and accessible without removing trim. Adjusts after installation for ceilings up to 2" thick.


H. Sealed Ni-Cad battery powers compact flourescent lamp for 90 minutes of emergency illumination. Galvanized with (6) 1/2" and (2) 3/4" KOs.

Insulation Detector

Thermal protection deactivates unit if improper lamp type or wattage is used, or if insulation is placed too close to the fixture.

Labels

CUL listed, damp location, wet location with lens only,IBEW union made.

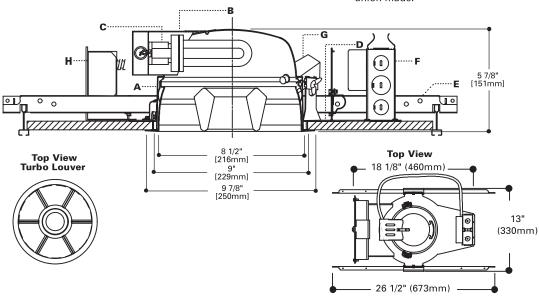

ORDERING INFORMATION

SAMPLE NUMBER: PD8HWL232EEM-8HL1EMC

Order frame and reflector separately for a complete unit.

Frame (Includes socket adapter and battery pack)


PD8HWL2³3ÆEM (2) 42 32, or 26W Quad

Reflector

8HL1EMC=8" Horizontal Prismatic Acrylic lens, Clear

8HL1EMBB=8" Horizontal Prismatic Acrylic Iens, Black Baffle 8HL1EMWB=8" Horizontal Prismatic Acrylic Iens, White Baffle 8HL2EMC=8" Horizontal Prismatic Glass Iens, Clear 8HL2EMB=8" Horizontal Prismatic Glass Iens, Black Baffle 8HL2EMWB=8" Horizontal Prismatic Glass Iens, White Baffle 8HREMC=8" Radial Louver, Clear p d s

by Portfolio™

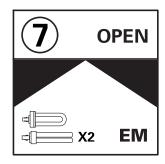

PD8HWL232EEM

(2)42W MAX TRIPLE

Compact Fluorescent

8" EMERGENCY LENSED OR LOUVERED HORIZONTAL DOWNLIGHT

PD8HWL232EEM

Lamp System Open
Voltage wattage: wattage circuit
Input 120V, 42W: 93.0W, 0.78A
277V, 42W: 93.0W, 0.33A
Power Factor: >.95

THD: <10%: Sound Rating: A

Min Starting Temp.: -20°C (-5°F)


COOPER LIGHTING


PHOTOMETRICS

PD8HW232EEM-8HL1EMC Candela

Test No. H23370

Lamp=(2)42W Triple Compact Fluorescent Lumens=3200 each Prismatic Lens, Clear Spacing Criteria 0°=1 90°=1.2 Efficiency=42.5%

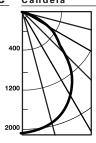

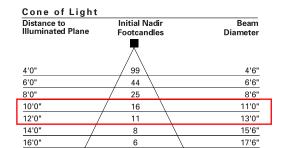

Beam diameter is to 50% of maximum footcandles, rounded to the nearest half-foot. Footcandle values are initial, apply appropriate light loss factors where necessary.


Beam

Diameter

PD8HWL232EEM-8HREMC

Test No. H23363

Lamp=(2)42W Quad Compact Fluorescent Lumens=3200 each Radial Louver, Clear Spacing Criteria 0°-180=1.2 90°-270°=1.4 Efficiency=47.6%

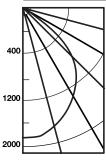

Candela

Deg.		CD
	0°	90°
90	0	0
85	1	1
75	8	7
65	49	46
55	338	353
45	727	927
35	974	1262
25	1197	1594
15	1356	1752
5	1401	1465
0	1395	1395

Distance to Initial Nadir Footcandles

Cone of Light

2'0"	,	349	\	2'6"		
4'0"		87		5'6"		
6'0"		39		8'0"		
8'0"		22		10'6"		
10'0"		14		13'6"		
12'0"		10		16'0"		
14'0"	/	7		19'0"		
16'0"		5	\	21'6"		
Beam diameter is to 50% of maximum footcandles, rounded to the nearest half-foot. Footcandle values are initial, apply appropriate light loss factors where necessary.						

NOTE: Lamps operate at the following percentages of rated output in Emergency mode.

Lamp AC Mode Emergency Mode 375 13W 900 18W 1200 500 26W 1800 625 2300 650 32W 42W 3200 775

