



DEVELOPMENT APPLICATION

City of Rockwall
Planning and Zoning Department
385 S. Goliad Street
Rockwall, Texas 75087

STAFF USE ONLY

PLANNING & ZONING CASE NO. _____

NOTE: THE APPLICATION IS NOT CONSIDERED ACCEPTED BY THE CITY UNTIL THE PLANNING DIRECTOR AND CITY ENGINEER HAVE SIGNED BELOW.

DIRECTOR OF PLANNING: _____

CITY ENGINEER: _____

Please check the appropriate box below to indicate the type of development request [SELECT ONLY ONE BOX]:

Platting Application Fees:

- Master Plat (\$100.00 + \$15.00 Acre) ¹
- Preliminary Plat (\$200.00 + \$15.00 Acre) ¹
- Final Plat (\$300.00 + \$20.00 Acre) ¹
- Replat (\$300.00 + \$20.00 Acre) ¹
- Amending or Minor Plat (\$150.00)
- Plat Reinstatement Request (\$100.00)

Site Plan Application Fees:

- Site Plan (\$250.00 + \$20.00 Acre) ¹
- Amended Site Plan/Elevations/Landscaping Plan (\$100.00)

Zoning Application Fees:

- Zoning Change (\$200.00 + \$15.00 Acre) ¹
- Specific Use Permit (\$200.00 + \$15.00 Acre) ¹
- PD Development Plans (\$200.00 + \$15.00 Acre) ¹

Other Application Fees:

- Tree Removal (\$75.00)
- Variance Request (\$100.00)

Notes:

¹: In determining the fee, please use the exact acreage when multiplying by the per acre amount. For requests on less than one acre, round up to one (1) acre.

PROPERTY INFORMATION [PLEASE PRINT]

Address _____

Subdivision Stone Creek Retail Addition

Lot

12

Block

A

General Location North East Corner of N. Goliad St and Bordeaux Dr.

ZONING, SITE PLAN AND PLATTING INFORMATION [PLEASE PRINT]

Current Zoning PD-070

Current Use

Undeveloped

Proposed Zoning PD-070

Proposed Use

Retail

Acreage 0.93

Lots [Current] 1

Lots [Proposed] 2

SITE PLANS AND PLATS: By checking this box you acknowledge that due to the passage of HB3167 the City no longer has flexibility with regard to its approval process, and failure to address any of staff's comments by the date provided on the Development Calendar will result in the denial of your case.

OWNER/APPLICANT/AGENT INFORMATION [PLEASE PRINT/CHECK THE PRIMARY CONTACT/ORIGINAL SIGNATURES ARE REQUIRED]

Owner Metroplex Acquisition Fund, LP

Applicant ClayMoore Engineering

Contact Person Staci Bowen

Contact Person Clay Cristy

Address 1717 Woodstead Ct.

Address 1903 Central Dr.

Ste. 207

Ste. 406

City, State & Zip The Woodlands, TX 77380

City, State & Zip Bedford, Texas 76021

Phone 214.343.4477

Phone 817.281.0572

E-Mail sbowen@crestviewcompanies.com

E-Mail Clay@claymooreeng.com

NOTARY VERIFICATION [REQUIRED]

Billy J. Brice III, President of
Metroplex Acquisition Fund, LP


Before me, the undersigned authority, on this day personally appeared _____ [Owner] the undersigned, who stated the information on this application to be true and certified the following:

"I hereby certify that I am the owner for the purpose of this application; all information submitted herein is true and correct; and the application fee of \$ 268.60, to cover the cost of this application, has been paid to the City of Rockwall on this the 14 day of September, 20 23. By signing this application, I agree that the City of Rockwall (i.e. "City") is authorized and permitted to provide information contained within this application to the public. The City is also authorized and permitted to reproduce any copyrighted information submitted in conjunction with this application, if such reproduction is associated or in response to a request for public information.

_____ under my hand and seal of office on this the 14th day of September, 20 23

Owner's Signature

My Commission Expires 1-27-2025

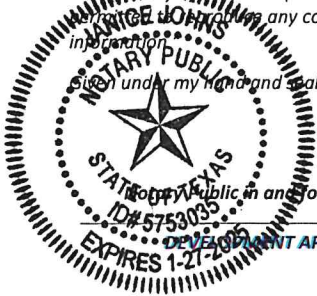

Notary Public in and for the State of Texas

SP2023-038: Site Plan for a Restaurant with a Drive-Through



PD-37

205

N GOLIAD ST

SF-16

PD-70

BORDEAUX DR

MIRAMOR DR

AG

Case Location Map =






City of Rockwall

Planning & Zoning Department
385 S. Goliad Street
Rockwall, Texas 75087
(P): (972) 771-7745
(W): www.rockwall.com

The City of Rockwall GIS maps are continually under development and therefore subject to change without notice. While we endeavor to provide timely and accurate information, we make no guarantees. The City of Rockwall makes no warranty, express or implied, including warranties of merchantability and fitness for a particular purpose. Use of the information is the sole responsibility of the user.



PLOTTED BY: MAX LANTANO
 PLOT DATE: 10/17/2023 2:33 PM
 LOCATION: Z:\PROJECTS\PROJECTS\2023-110 APPJ MGMT - HTEAO ROCKWALL\CADD\SHEETS\SP-1 SITE PLAN.DWG
 LAST SAVED: 10/17/2023 2:07 PM

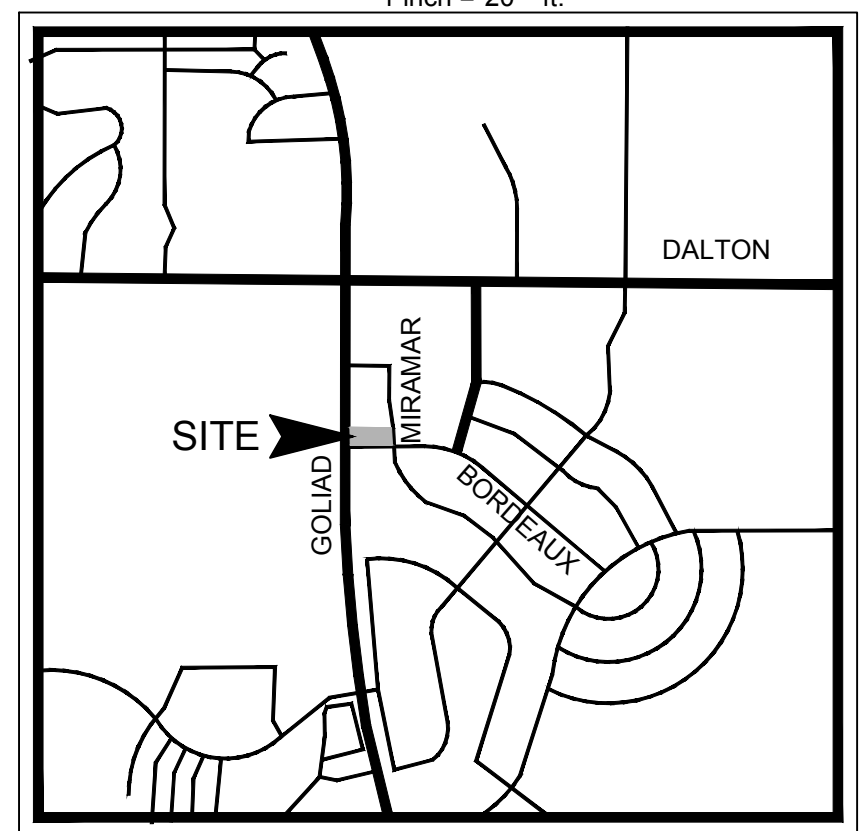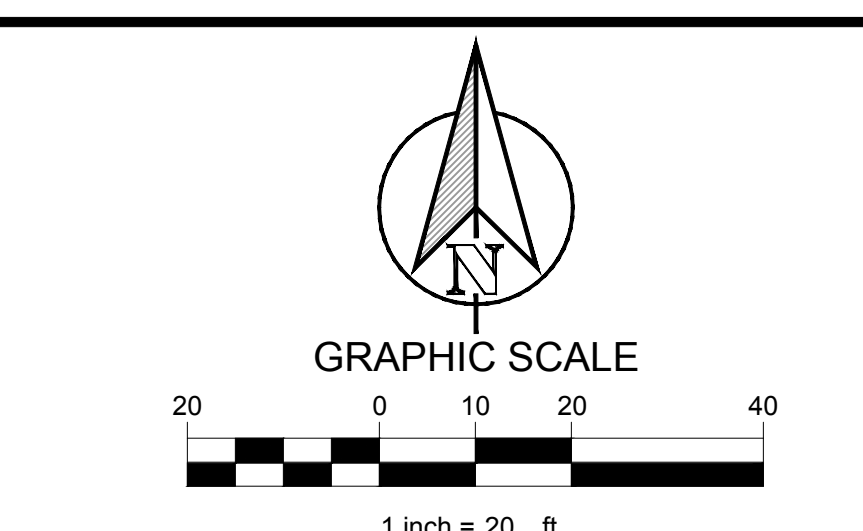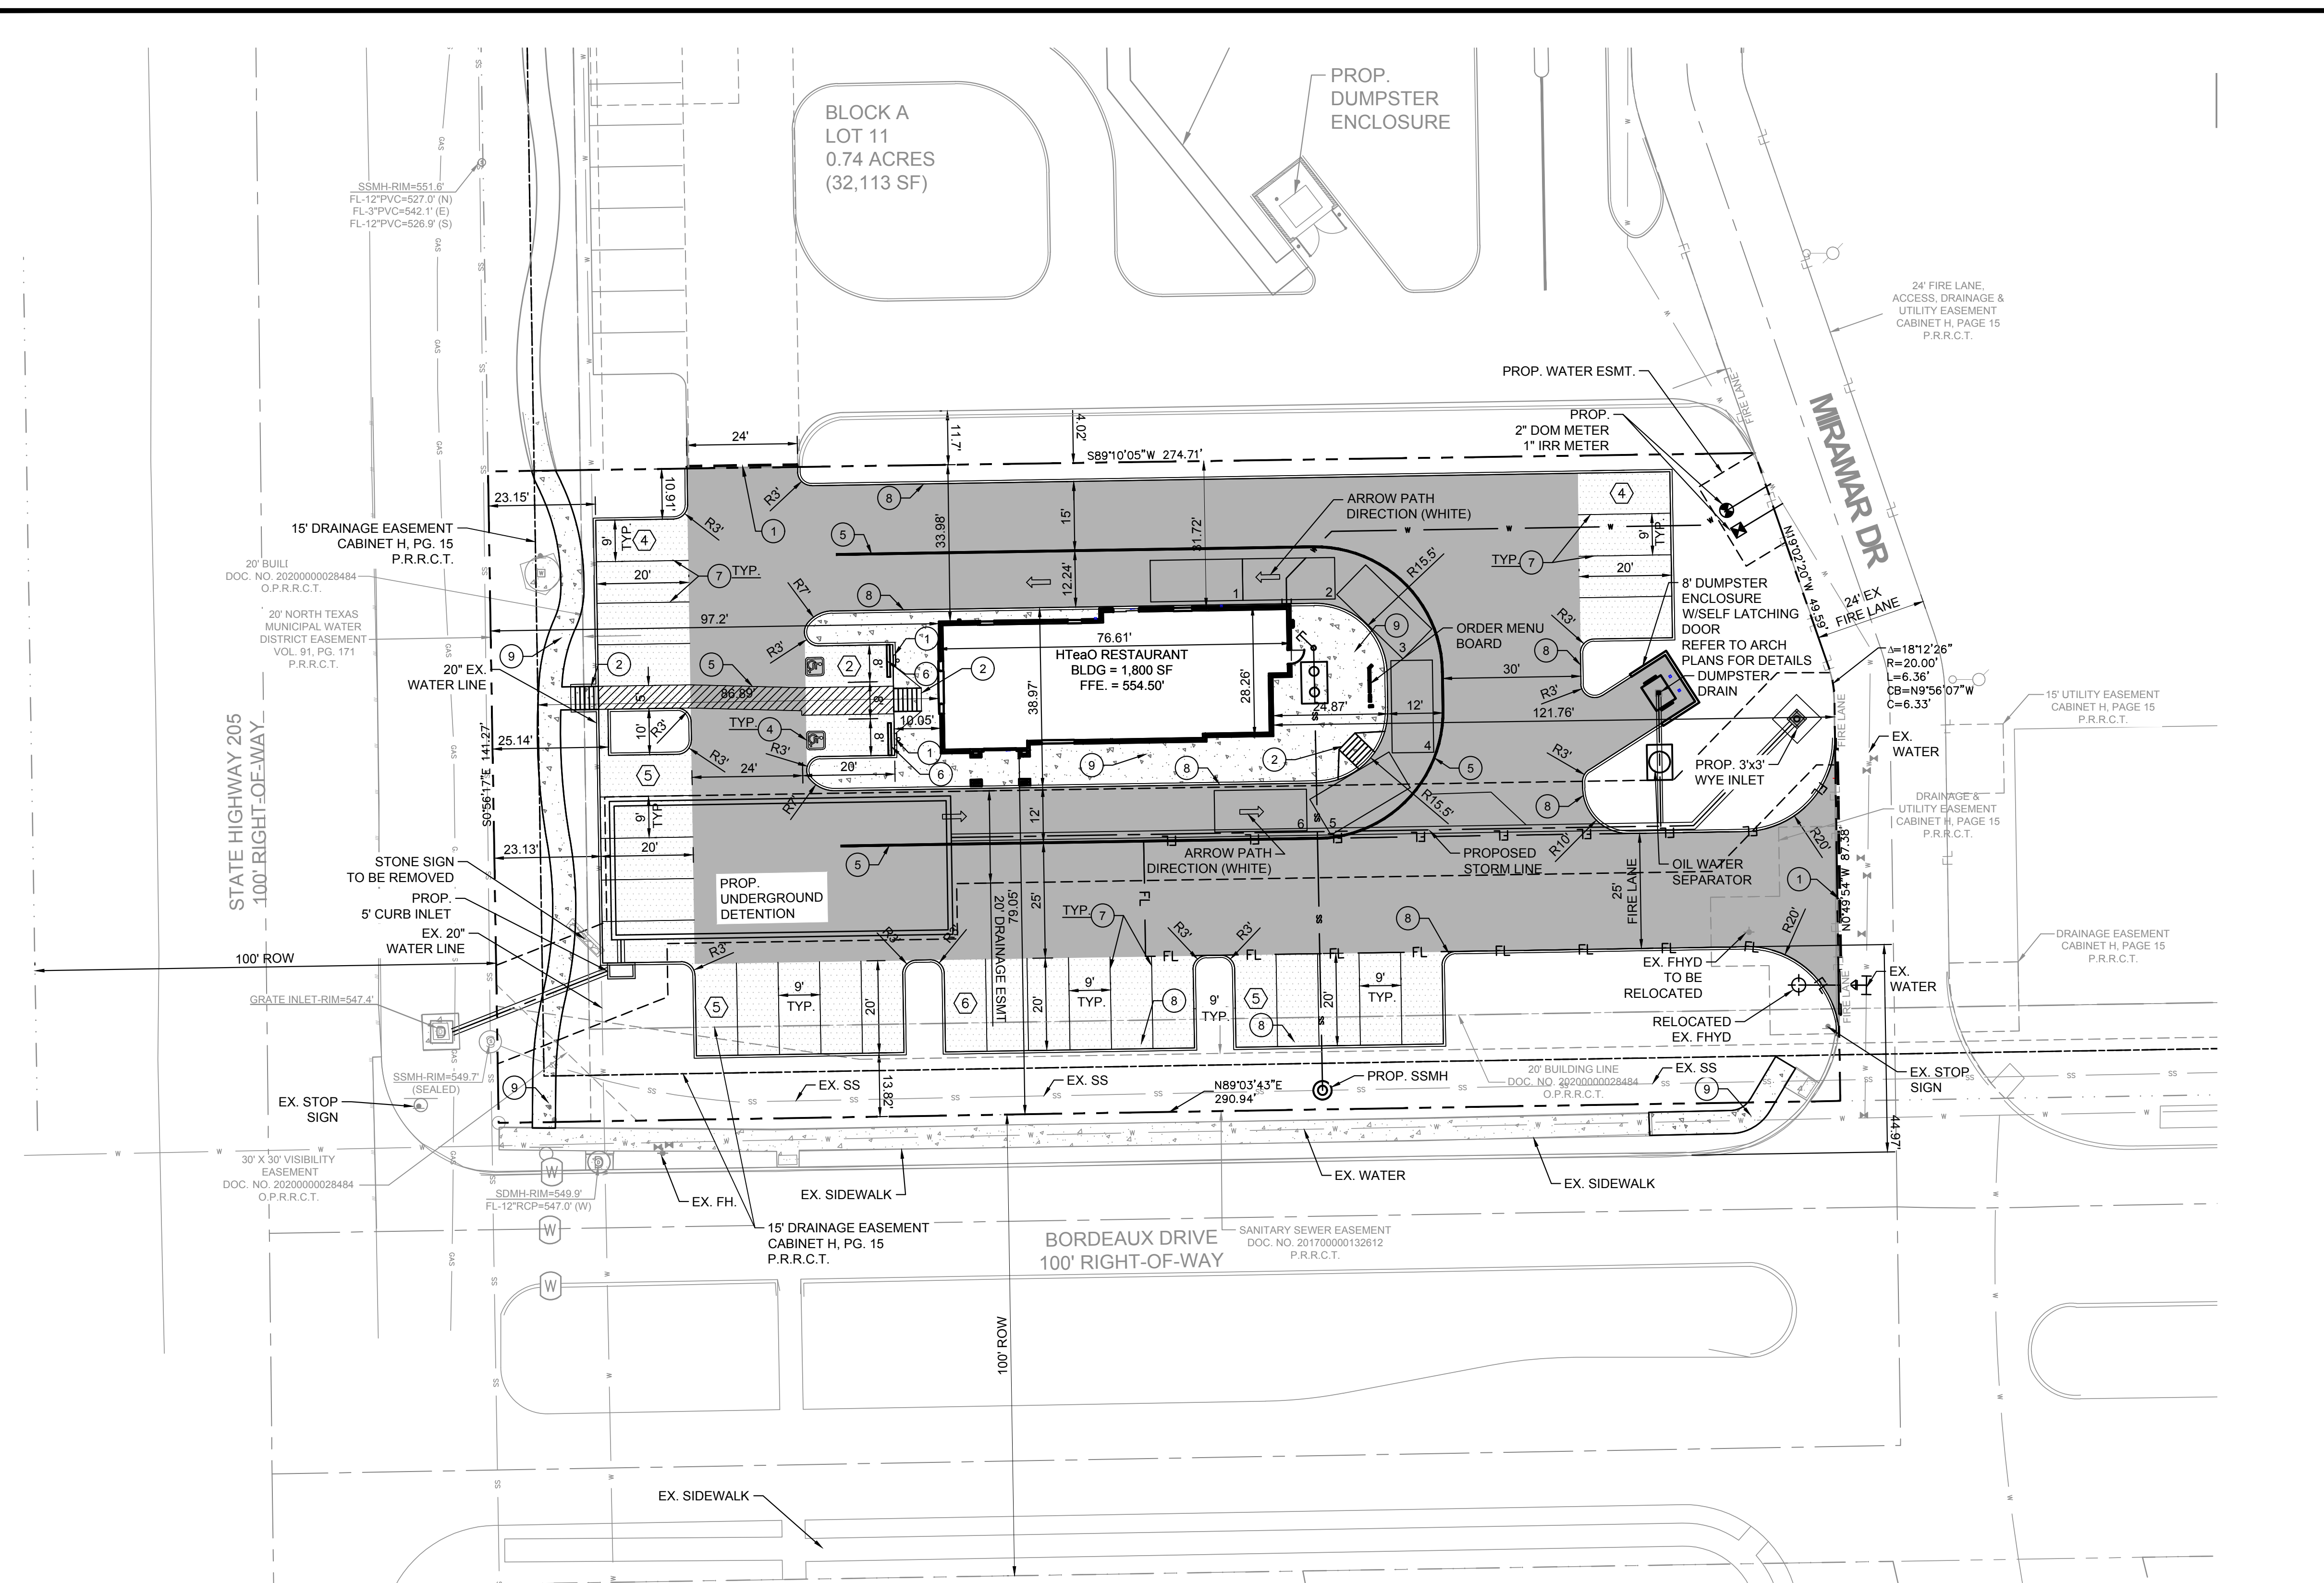

VICINITY MAP
N.T.S.

CONSTRUCTION SCHEDULE	
[Symbol]	PROPOSED 5" LIME STABILIZED STANDARD DUTY CONCRETE PAVEMENT
[Symbol]	PROPOSED 6" LIME STABILIZED HEAVY DUTY CONCRETE PAVEMENT
[Symbol]	PROPOSED 5" LIME STABILIZED SIDEWALK CONCRETE PAVEMENT
[Symbol]	PROPERTY LINE
[Symbol]	PROPOSED CONCRETE CURB AND GUTTER
[Symbol]	PROPOSED FIRE LANE, PUBLIC ACCESS AND UTILITY EASEMENT
[Symbol]	PROPOSED SAWCUT
[Symbol]	PARKING COUNT

- NOTES:
- A SEPARATE SIGNAGE PERMIT IS REQUIRED BY THE CITY OF ROCKWALL.
 - ALL WALLS 3' IN HEIGHT OR GREATER SHALL BE DESIGNED BY AN ENGINEER, LICENSED IN THE STATE OF TEXAS.
 - ALL WALLS MUST BE ROCK OR STONE FACE. NO WALLS SHALL BE SMOOTH CONCRETE.
 - NO TREES SHALL BE PLANTED WITHIN 10' OF NON-STEEL ENCASED PUBLIC UTILITIES.
 - SOD MUST BE LAID WITHIN ALL DISTURBED R.O.W. BEFORE ACCEPTANCE OF PROJECT.
 - PROPERTY OWNER WILL BE RESPONSIBLE FOR MAINTAINING, REPAIR, AND REPLACEMENT OF THE DETENTION/DRAINAGE SYSTEMS

PARKING DATA TABLE	
PARKING REQ.	
DRIVE-THRU RESTAURANT (1,800 SF) 1/ 100 SF	18 SPACES
PARKING PROVIDED	
STANDARD PARKING	29 SPACES
ADA PARKING	2 SPACES
TOTAL	31 SPACES (2 ADA)
TYP. PARKING DIMENSIONS	9'X20'

SITE DATA TABLE	
SITE AREA	0.933 AC (40,627 SF)
ZONING	PD-70
PROPOSED USE	DRIVE-THRU RESTAURANT
BUILDING SIZE	1,800 SF
BUILDING STORIES	1 STORY
TOTAL IMPERVIOUS	28,117 SF (69)

CONSTRUCTION SCHEDULE	
①	HANDICAP SIGN
②	ADA RAMP, 12:1 MAX. SLOPE
③	SAWCUT FULL DEPTH EXISTING PAVEMENT
④	HANDICAP SYMBOL
⑤	PAVEMENT STRIPING
⑥	CURB STOP
⑦	4" PARKING STALL STRIPING COLOR: WHITE
⑧	CURB & GUTTER
⑨	PROPOSED SIDEWALK

ALL RESPONSIBILITY FOR ADEQUACY OF DESIGN REMAINS WITH THE DESIGN ENGINEER. THE CITY OF ROCKWALL, IN REVIEWING AND RELEASING PLANS FOR CONSTRUCTION, ASSUMES NO RESPONSIBILITY FOR ADEQUACY OR ACCURACY OF DESIGN.

OWNER:
 METROPLEX ACQUISITIONS FUND, LP
 1717 WOODSTEAD CT. SUITE 207
 THE WOODLANDS, TX 77380
 CONTACT: STACI BOWEN
 PH: 214.343.447

DEVELOPER:
 APPPJ MANAGEMENT
 740 AVALON DR
 HEATH, TX 75032
 CONTACT: JEFF IVY
 PH: 214-272-4350

HTEAO RESTAURANT
 LEGAL DESCRIPTION AND OR ADDRESS:
 HWY 205 & BORDEAUX DRIVE
 ROCKWALL, TX 75087
 0.933 AC (40,627 SF)

APPLICANT:
 CLAYMOORE ENGINEERING, INC.
 1903 CENTRAL DRIVE, SUITE #406
 BEDFORD, TX 76021
 CONTACT: CLAY CRISTY
 PH: 817.281.0572

CASE NUMBER:
 Z2023-046

I HEREBY CERTIFY THAT THE ABOVE AND FOREGOING SITE PLAN FOR A DEVELOPMENT IN THE CITY OF ROCKWALL, TEXAS, WAS APPROVED BY THE PLANNING AND ZONING COMMISSION OF THE CITY OF ROCKWALL ON THE ____ DAY OF ____.

WITNESS OUR HANDS THIS ____ DAY OF ____.

PLANNING AND ZONING COMMISSION, CHAIRMAN

DIRECTOR OF PLANNING AND ZONING

TEXAS REGISTRATION #14199
CLAYMOORE ENGINEERING
 1903 CENTRAL DRIVE, SUITE #406
 BEDFORD, TX 76021
 WWW.CLAYMOORE.COM

PRELIMINARY
 FOR REVIEW ONLY
 Not for construction purposes.
CLAYMOORE ENGINEERING
 ENGINEERING AND PLANNING
 CONSULTANTS
 CLAY CRISTY
 Engineer No. 10980 Date 10/17/2023

**HTEAO RESTAURANT
 HWY 205 & BORDEAUX DR
 ROCKWALL, TX 75087**

No.	DATE	REVISION	BY
1	12/07/2020	STORM REVISION	LRR
2	09/13/2021	STORM REVISION	LRR

SITE PLAN

DESIGN: LRR
 DRAWN: LRR
 CHECKED: CLC
 DATE: 10/17/2023


SHEET
SP-1

GENERAL NOTES

1. CONTRACTOR TO VERIFY ALL FINISHES WITH OWNER BEFORE ORDERING.
2. CONTRACTOR TO VERIFY ALL OPENINGS FOR DOORS AND WINDOWS BEFORE ORDERING
3. THE GENERAL CONTRACTOR SHALL BE RESPONSIBLE FOR PROPER PREPARATION OF ALL SURFACES IN SATISFACTORY MANNER. TOUCH-UP AND/OR REFINISH OF SURFACES DAMAGED BY SUBSEQUENT WORK SHALL BE THE RESPONSIBILITY OF THE GENERAL CONTRACTOR. ALL WORK SHALL BE PERFORMED IN CONFORMANCE WITH THE MANUFACTURER'S RECOMMENDED INSTALLATION METHODS.
4. ALL GLASS SUBJECT TO HUMAN IMPACT SHALL CONFORM TO THE STANDARDS SET FORTH BY CHAPTER 24 OF THE I.B.C.



HTEAO ROCKWALL ADDRESS LOCATION

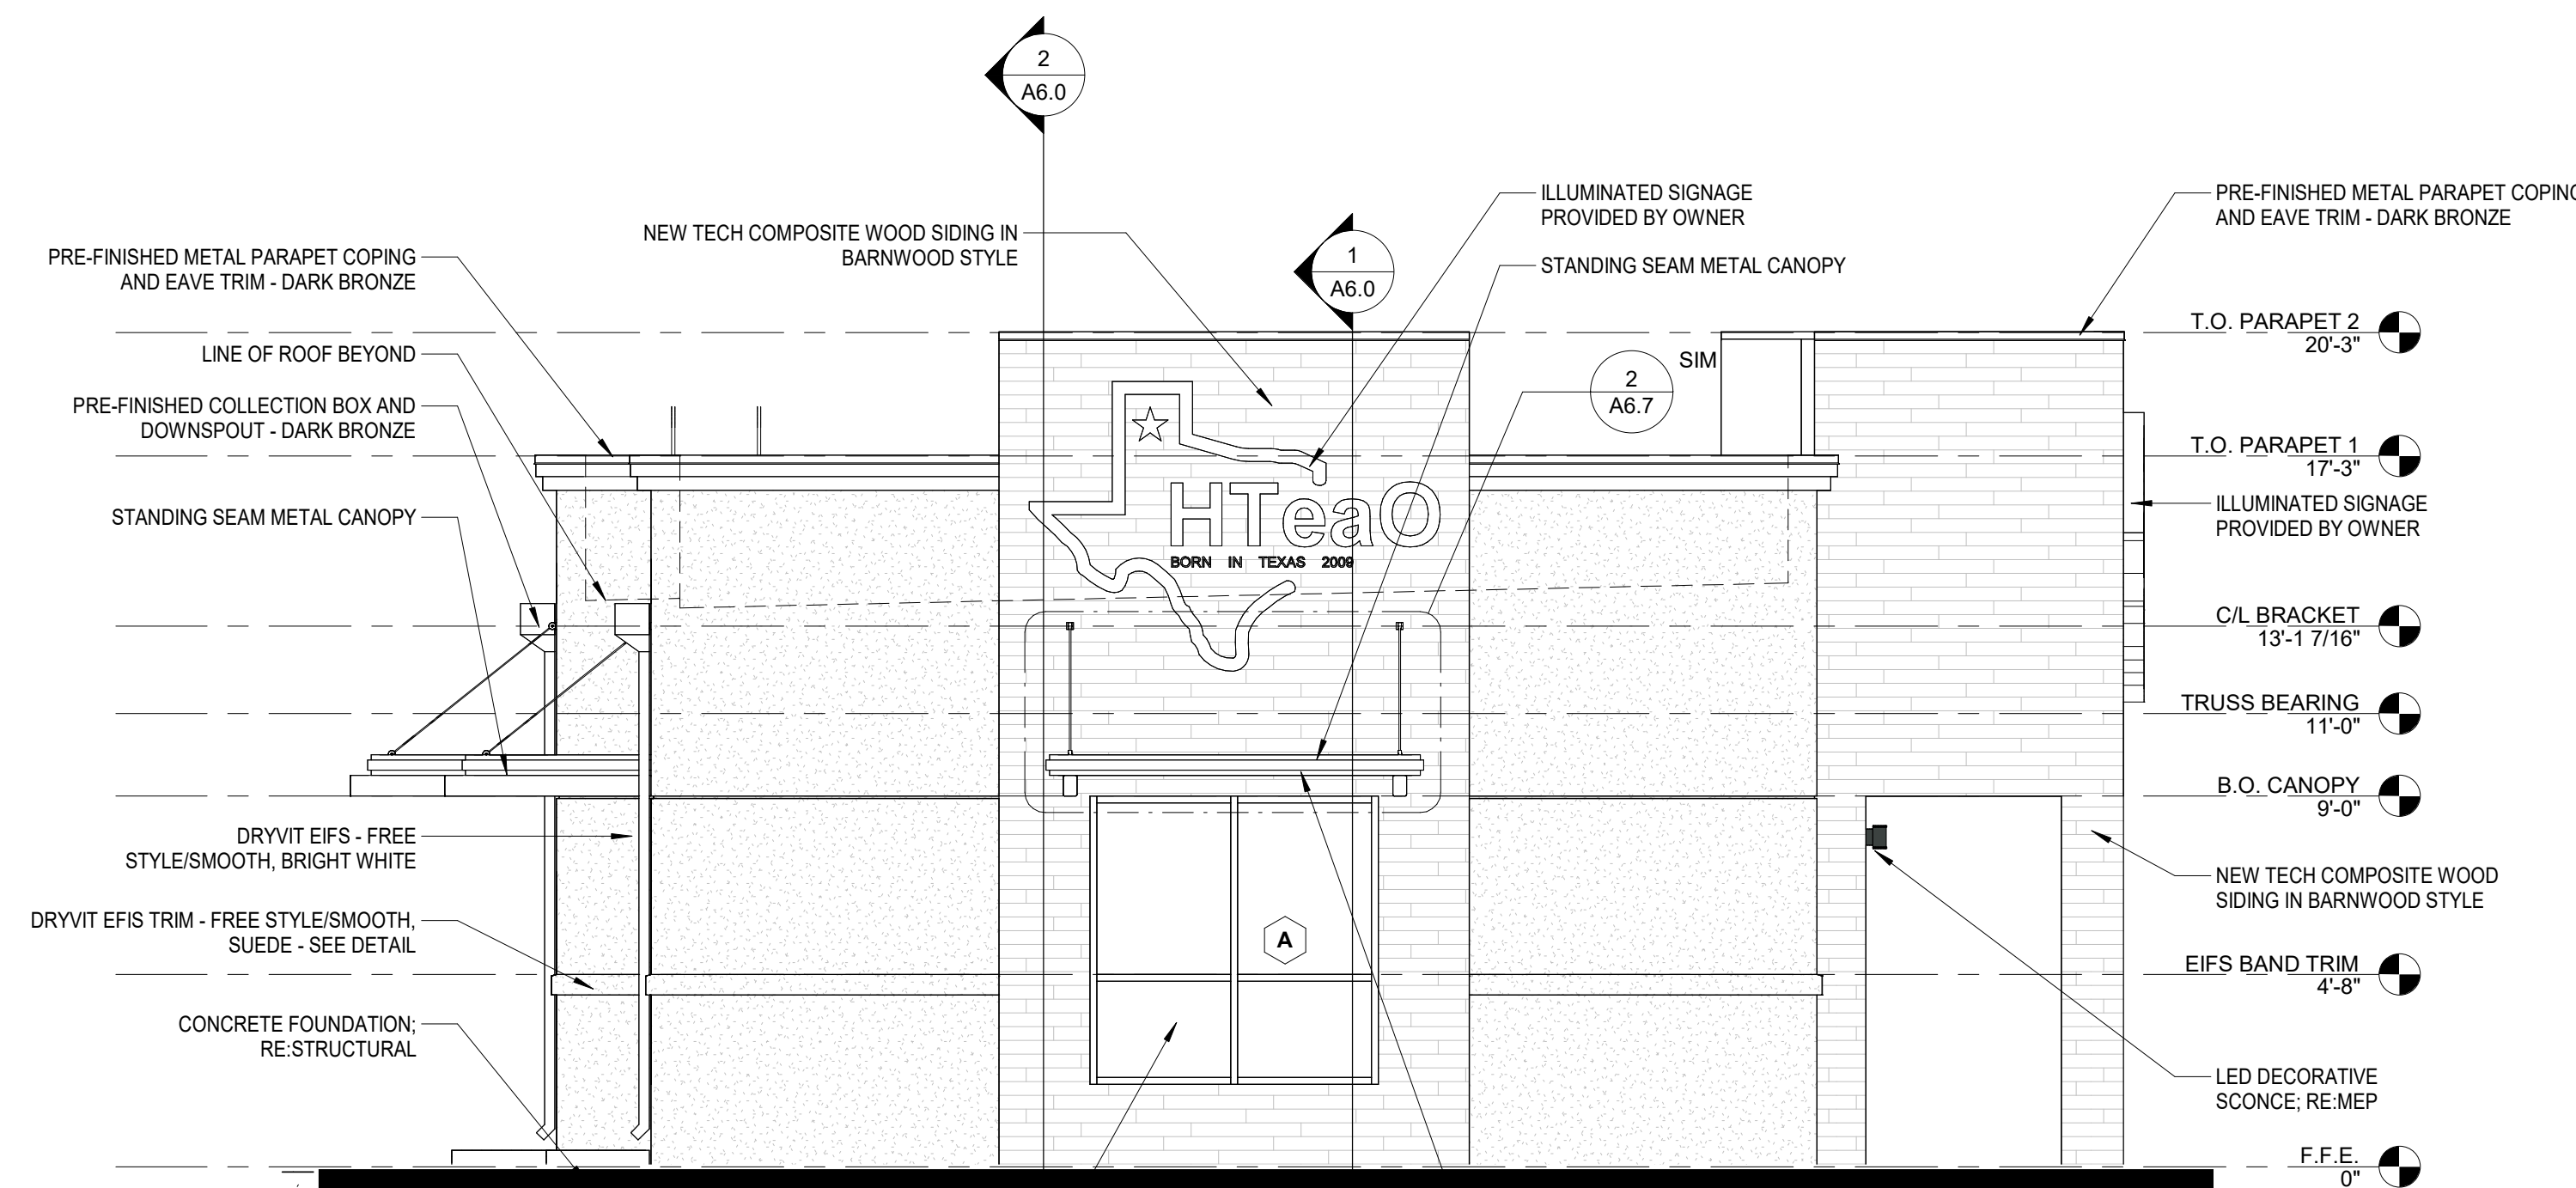


2 FRONT (NORTH)

SCALE: 1/4" = 1'-0"



3 3D View 2

SCALE:

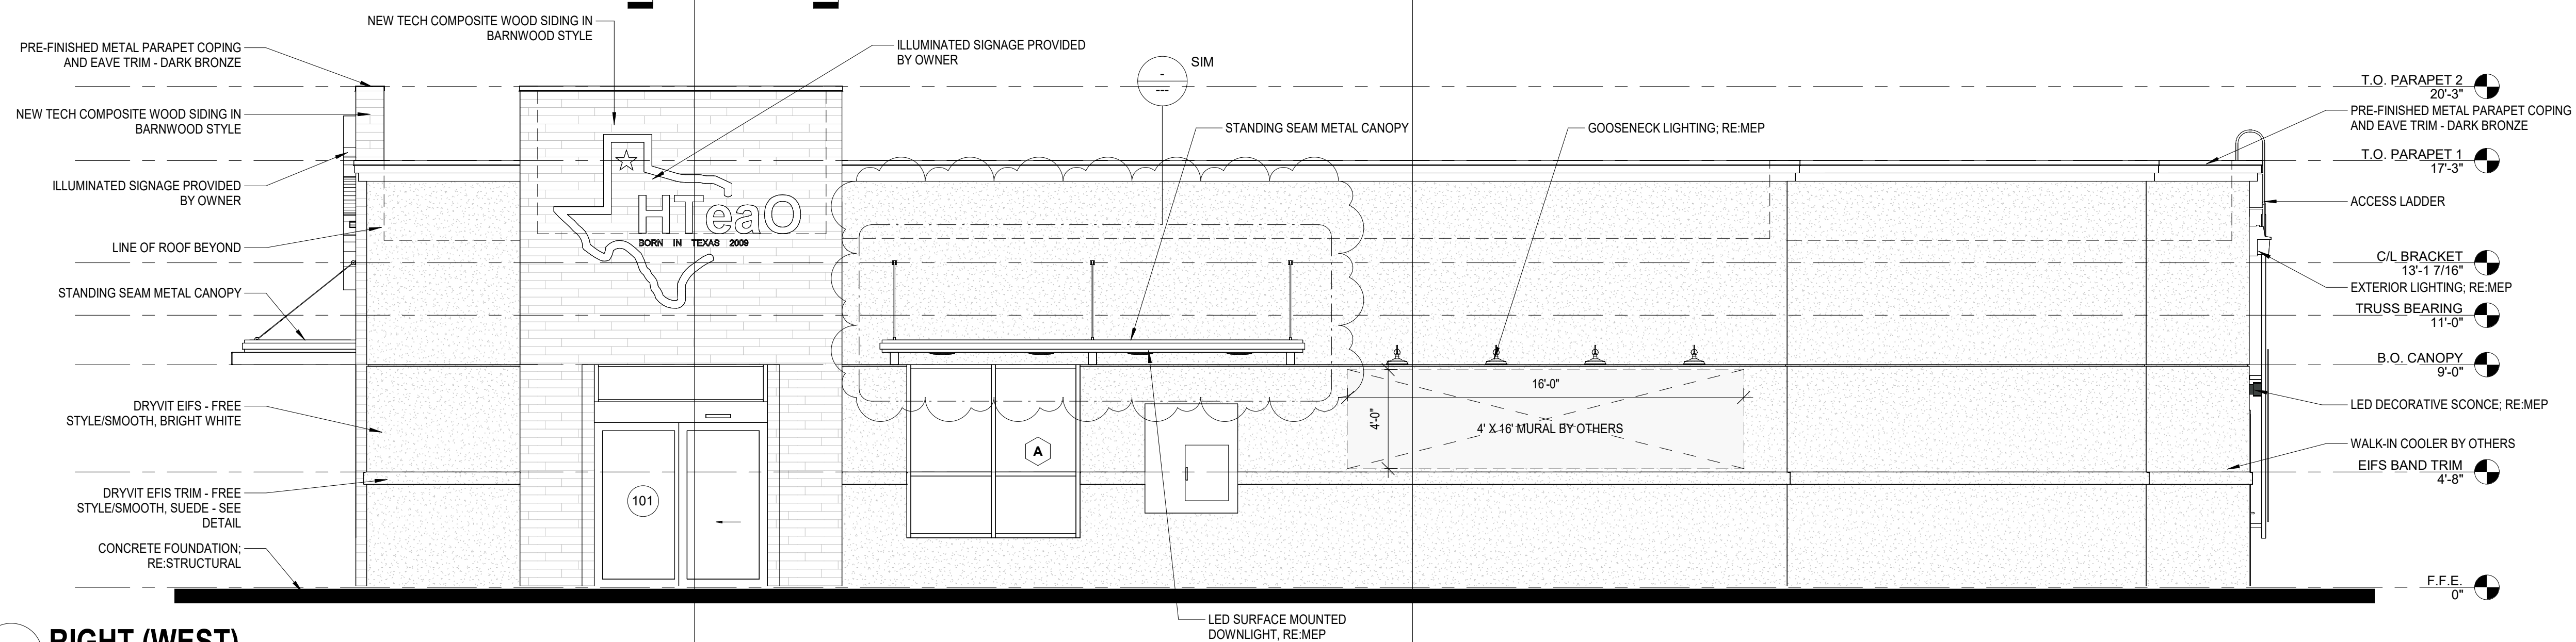

1 RIGHT (WEST)

SCALE: 1/4" = 1'-0"



Date: 7-24-2023
 Dwn: BRZ Chk: SJK
 Project No.: 2348
 Issue:

1	Revision 1	Date 1
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Sheet Name:
EXTERIOR ELEVATIONS


A5.0

GENERAL NOTES


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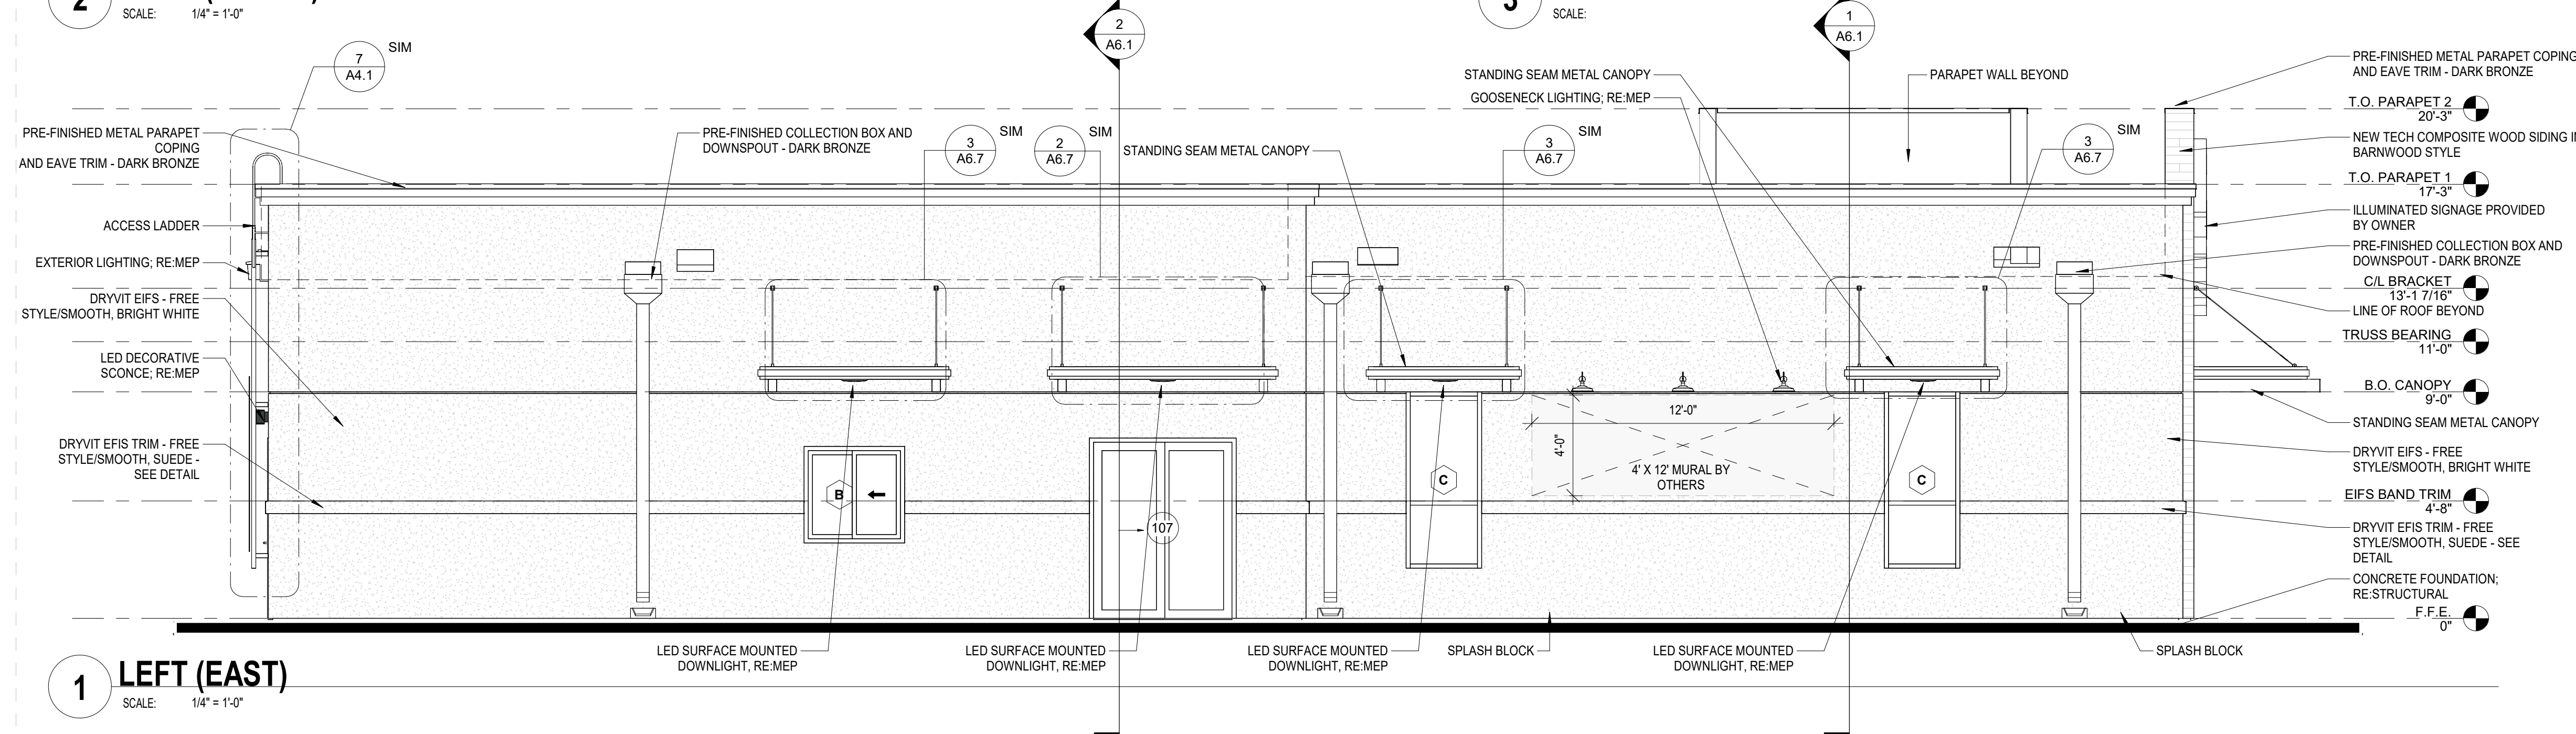
**HTEAO ROCKWALL
ADDRESS
LOCATION**



2 REAR (SOUTH)
SCALE: 1/4" = 1'-0"

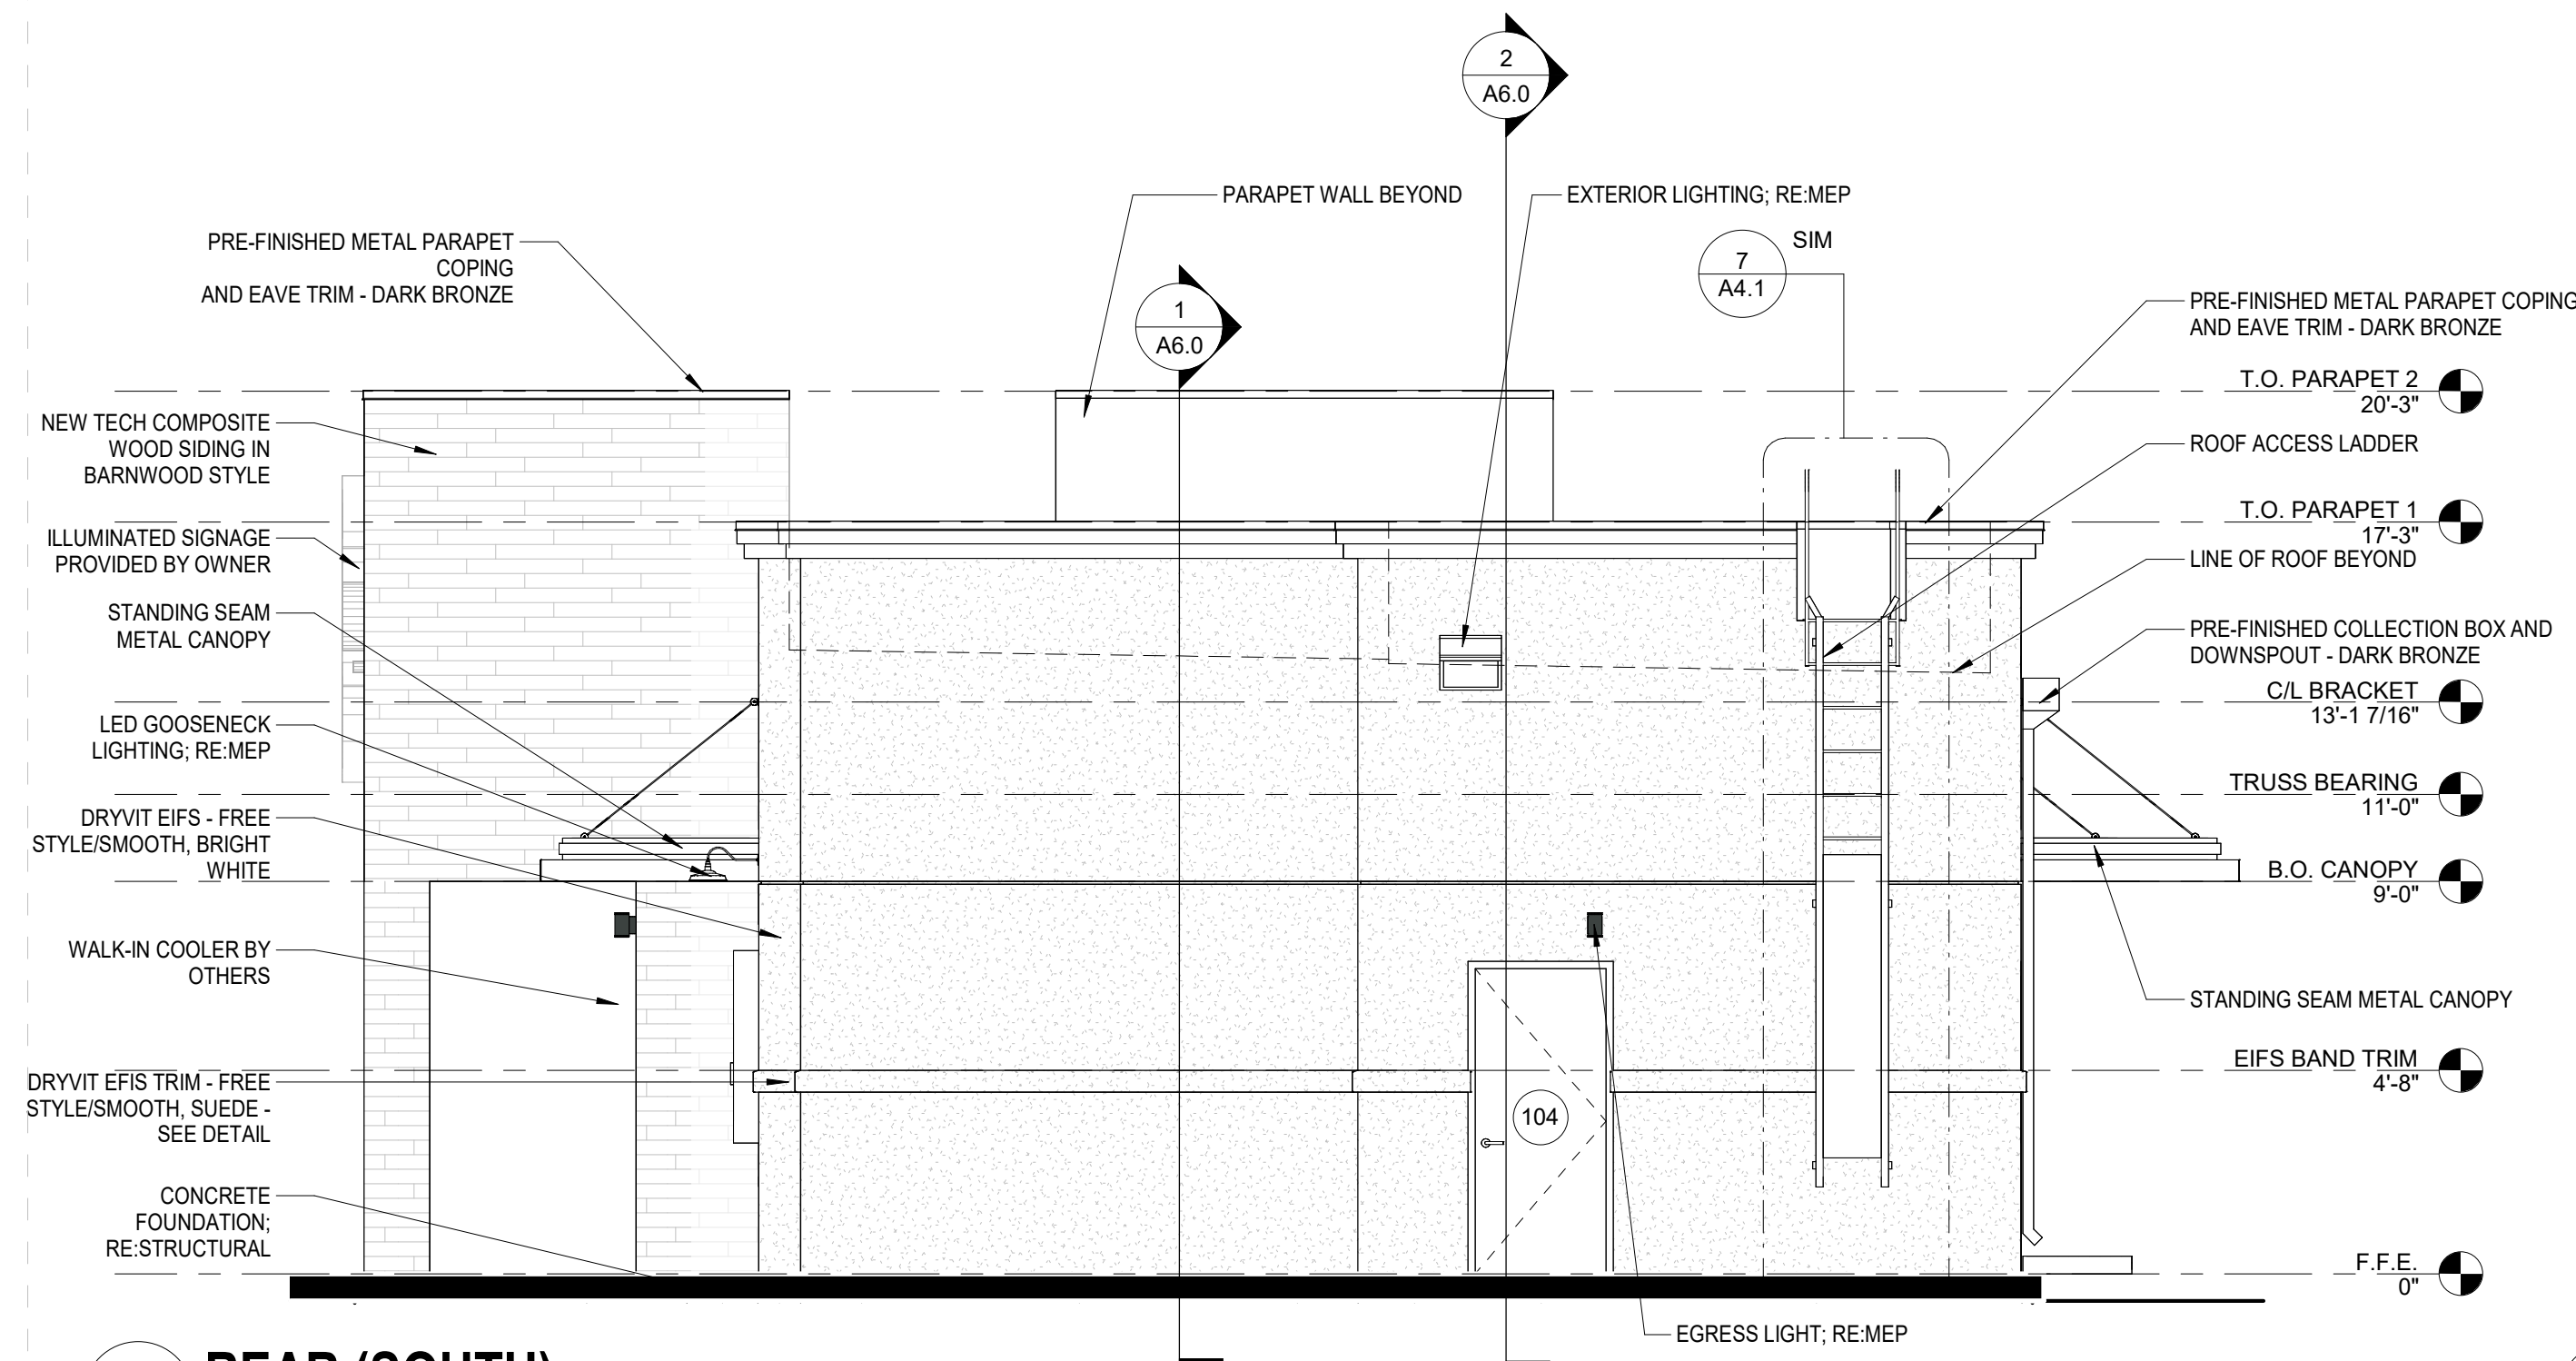

3 3D View 1
SCALE:

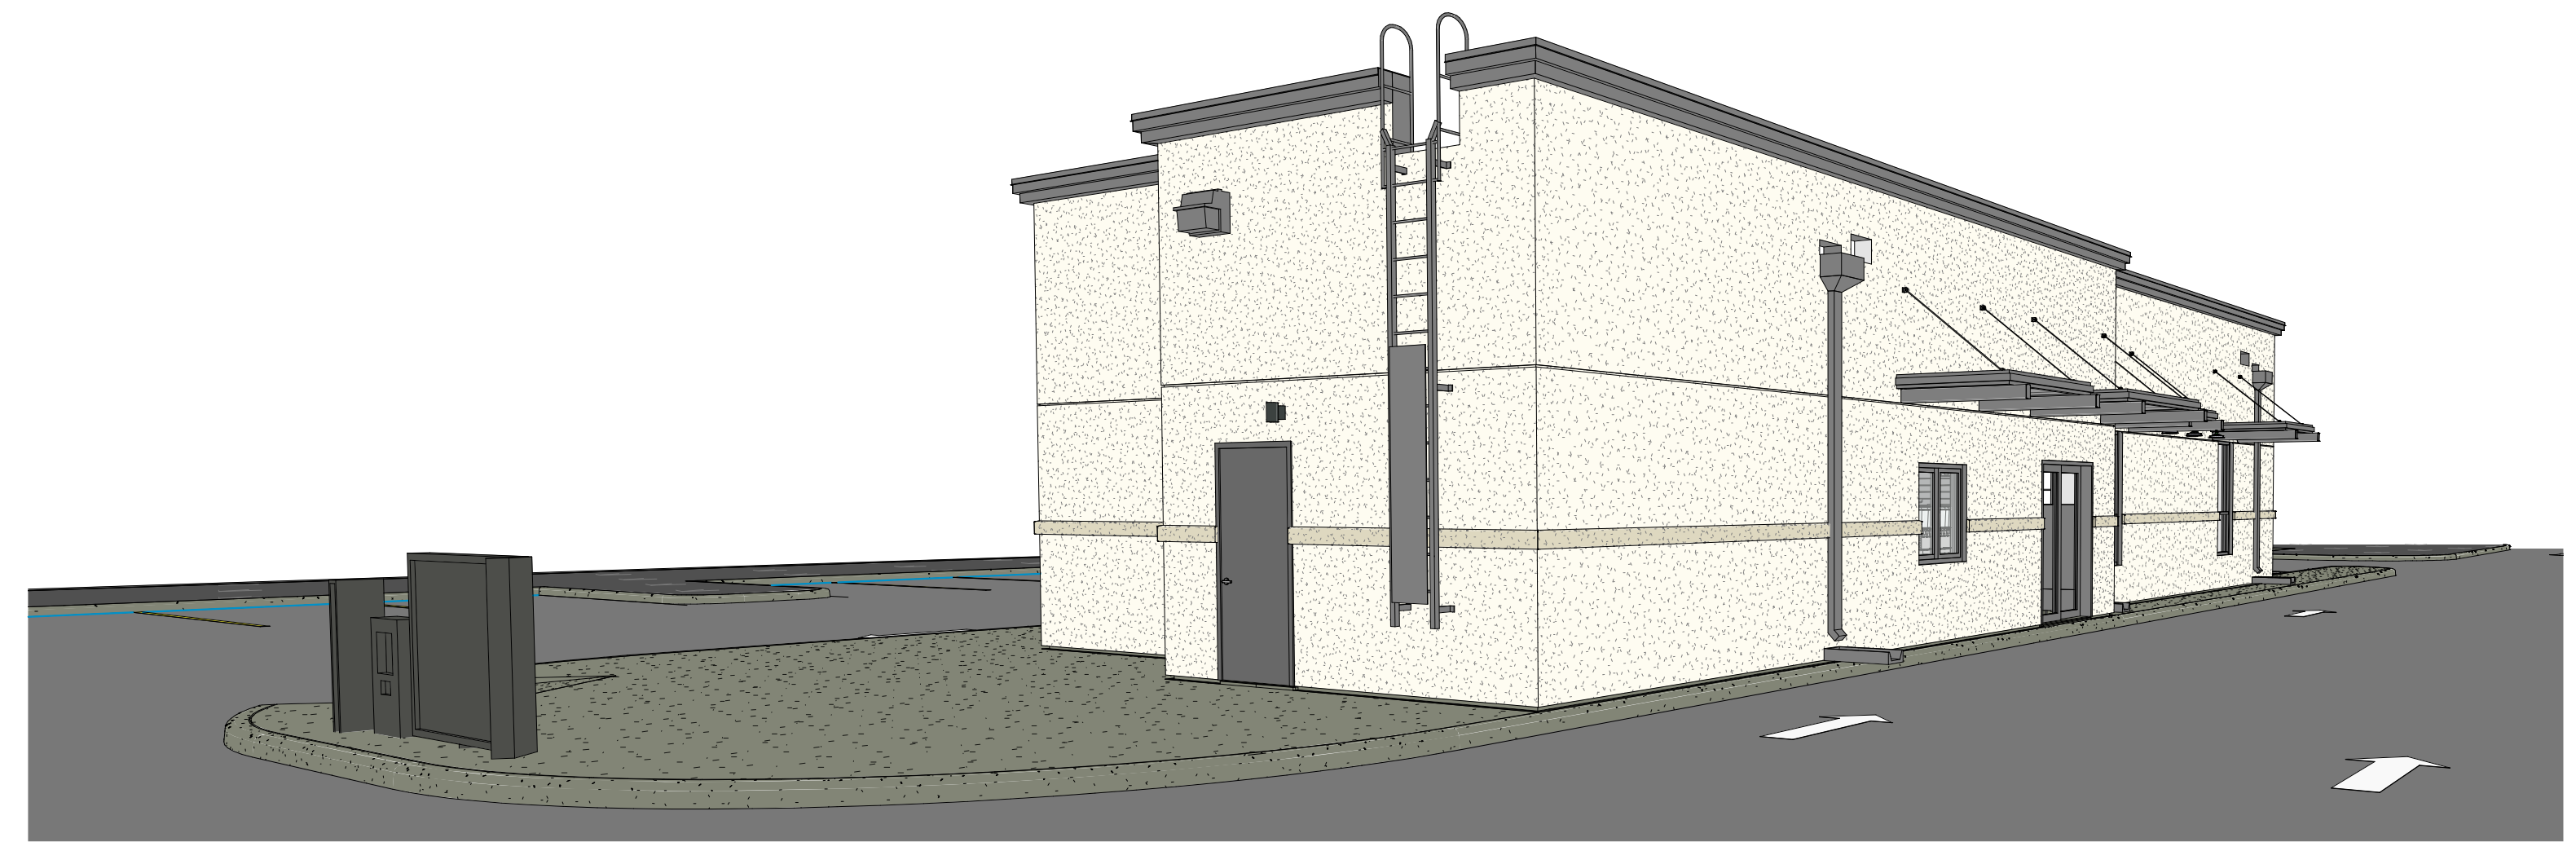

1 LEFT (EAST)
SCALE: 1/4" = 1'-0"




Date: 7-24-2023
Dwn: BRZ Chk: SJK
Project No.: 2348
Issue:

Sheet Name:
**EXTERIOR
ELEVATIONS**

A5.1

STATE HIGHWAY 205
CONCRETE ROADWAY
100' R.O.W.

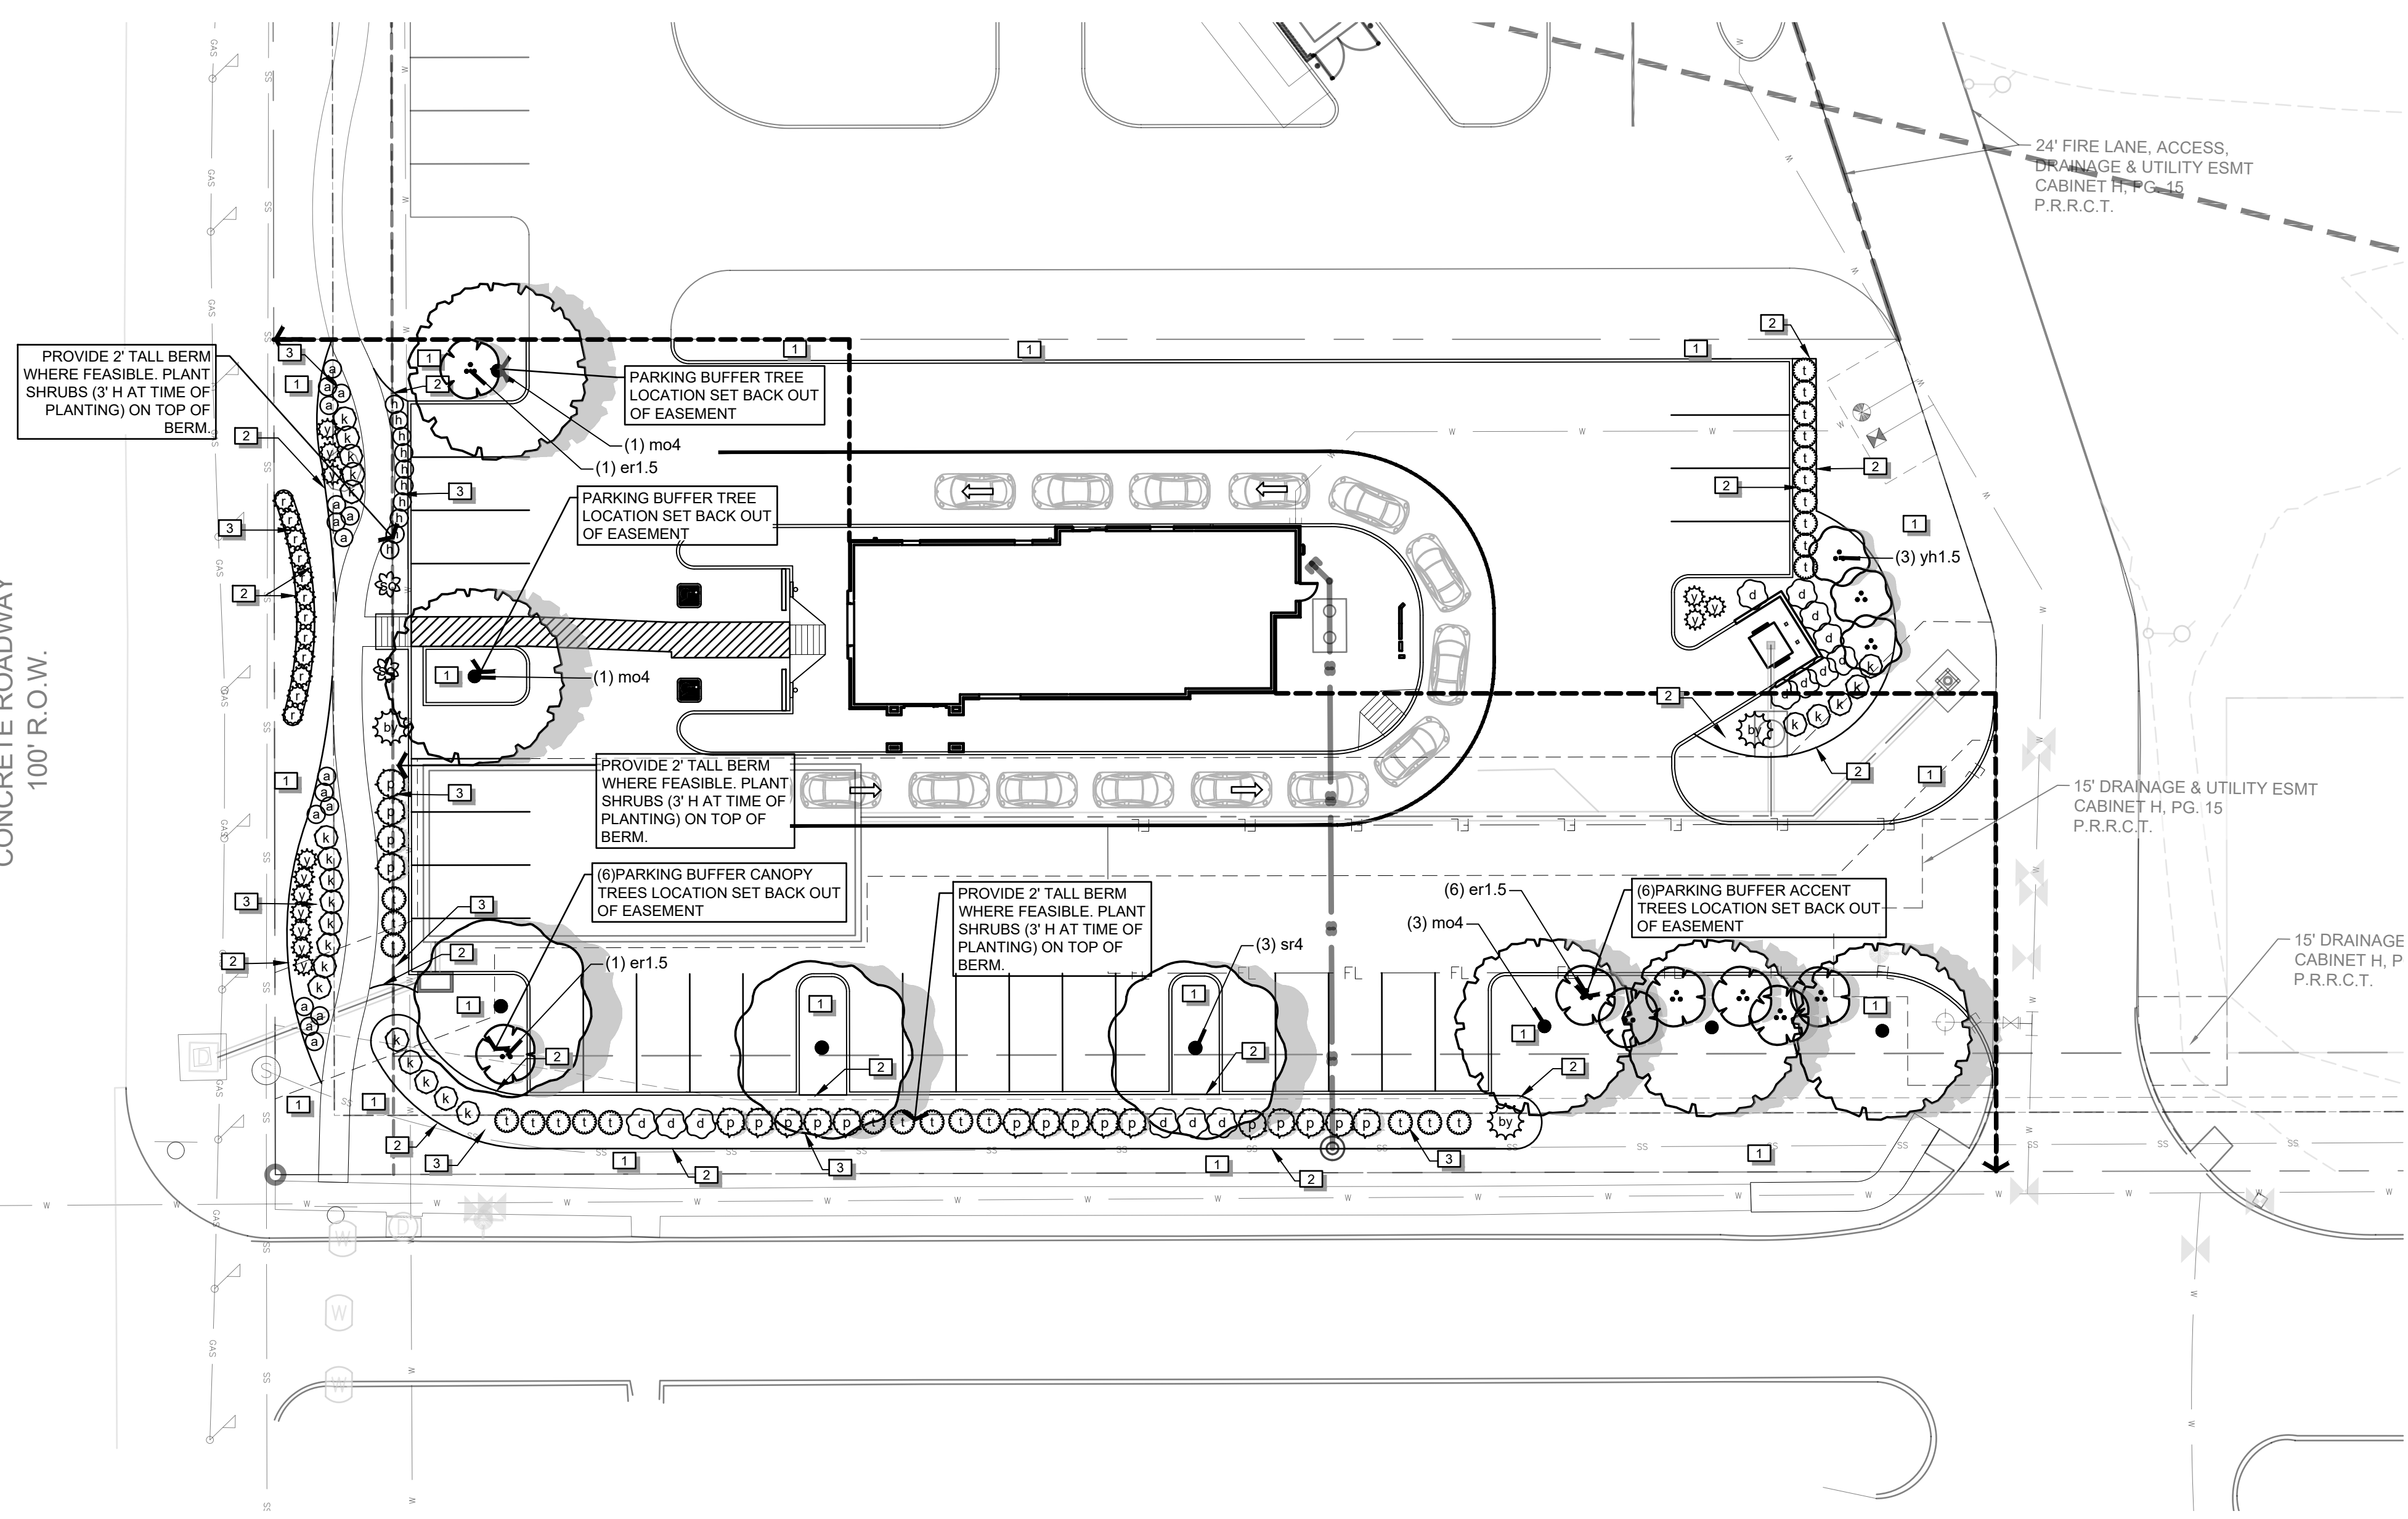


LANDSCAPE CALCULATIONS

	REQUIRED	PROVIDED
LANDSCAPE BUFFER		
• N Goliad Dr. (110 lf)		
•• Shade trees (1 per 50 lf)	2	2
•• Accent trees (1 per 50 lf)	2	2
• Bordeaux Dr. (291 lf)		
•• Shade trees (1 per 50 lf)	6	6
•• Accent trees (1 per 50 lf)	6	6
LANDSCAPE SCREENING		
• Headlight Screening (shrubs and 2' tall berm)		
•• N Goliad Dr.	73 lf	75 lf
•• Bordeaux Dr.	182 lf	184 lf
LANDSCAPE REQUIREMENTS		
• Total Site Area	8,524sf	42,619sf
• Amount of Landscaping (20% Total Site)	1,705sf	12,702sf
•• Location of Landscaping (50% in Streetyard)	4,262sf	9,163sf

REFERENCE NOTES SCHEDULE

SYMBOL	DESCRIPTION
1	Lawn, Sod
2	Steel Edge
3	Mulch

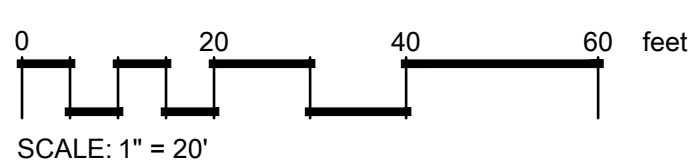

PLANT SCHEDULE



TREES	CODE	COMMON NAME	BOTANICAL NAME	CONT	CAL	SIZE	QTY
	mo4	Monterey Oak	Quercus polymorpha 'Monterey'	-	4"Cal	6' H min	5
	sr4	Shumard Red Oak	Quercus shumardii	-	4"Cal	6' H min	3
ORNAMENTAL TREES							
	er1.5	Eastern Redbud	Cercis canadensis	-	1.5"Cal	6' H min	8
	yh1.5	Yaupon Holly	Ilex vomitoria	-	1.5"Cal	6' H min	3
SHRUBS							
	a	Powis Castle Artemisia	Artemisia x 'Powis Castle'	5 gal			16
	by	Beaked Yucca, 'Blue Velvet'	Yucca rostrata 'Blue Velvet'	5 gal			3
	d	Dwarf Palmetto	Sabal minor	5 gal			14
	h	Dwarf Burford Holly	Ilex cornuta 'Burfordii Nana'	5 gal			10
	k	Knock Out Rose	Rosa acicularis 'Knock Out'	5 gal			23
	p	Pineapple Guava	Feijoa sellowiana	5 gal			19
	r	Red Yucca	Hesperaloe parviflora	3 gal			12
	so	Sotol	Dasylirion texanum	5 gal			2
	t	Texas Sage 'Silverado'	Leucophyllum frutescens 'Silverado'	5 gal			26
	y	Soft Leaf Yucca	Yucca pendula	5 gal			13

Rev	Description	Date

Consultant Seal

Company Name and Address
William S. Blair
(512) 522-8979
info@blairla.com
www.blairla.com
100 Congress Ave.
Ste 2000
Austin, TX 78701

BLAIR LANDSCAPE ARCHITECTURE, LLC
QUALITY. INTEGRITY. RELIABILITY.

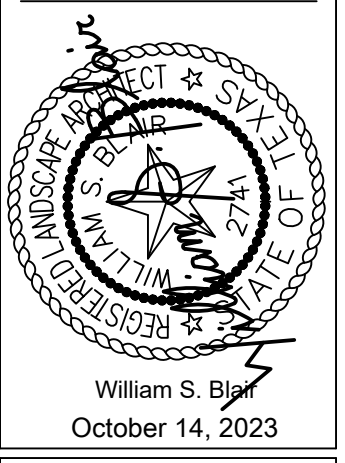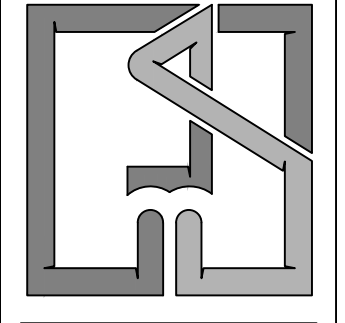

Project Name and Address
William S. Blair
October 14, 2023

HteaO | Rockwall
N Goliad Dr. and Bordeaux Dr.
Rockwall, Texas

Sheet Title
Landscape Plan

Design By: Will Blair
Checked By: xxxx
Issue Date: 09/15/2023
Project Number: Z3062-LP

L1
OF 2



Know what's below.
Call before you dig.

Contractors:
email info@blairla.com with RFIs, submittals, & inspection scheduling
Schedule inspections at least 2 weeks in advance

LANDSCAPE PLANTING SPECIFICATIONS

- 1) Guarantee - All labor, materials and plants will be guaranteed for a period of twelve (12) months after the final acceptance of work by Owner. All plants that have died or are unhealthy shall be replaced no later than 30 days from the anniversary date of the final acceptance. This guarantee does not apply to plant material that dies due to abnormal freezes, hail, abnormal high winds, or other acts of God, vandalism or lack of normal maintenance and watering. This guarantee does not apply to annual plantings.
- 2) Contractor is to verify all site dimensions and layout prior to the commencement of landscape construction. Any discrepancies between the drawings and the actual site conditions shall be brought to the attention of the owner's representative immediately.
- 3) Contractor is responsible for verification of the location of all underground utilities, repair to said utilities as a result of the work of the contractor shall be the responsibility of the contractor. Refer to the drawing for any additional information.
- 4) Contractor is responsible for maintaining positive drainage in all shrub and turf planting areas.
- 5) Tree pits are to be the same depth as the root ball and 24" wider. Prior to planting the tree pit should be filled with water to check for good drainage. If water does not drain the Contractor should check with the Landscape Architect to relocate the tree.
- 6) Trees should be positioned in the center of the tree pits, back filled with soil that was excavated from the pit until the surface is level with the surrounding area and the crown of the plant is at the finished grade. Build a water basin around the tree (36" dia.). Water until planting pit is soaked and soil has settled. Add soil necessary to bring soil level flush with surrounding ground. Fill the basin with three (3) inches of compost.
- 7) All plant material shall conform to the standards of the latest edition of "American Standard for Nursery Stock" by The American Association of Nurserymen and "Grades and Standards" by The Texas Association of Nurserymen. A plant shall be dimensioned as it stands in its natural position. All plants shall be at least the minimum size indicated. Larger stock is acceptable at no additional cost, and providing that the larger plants will not be cut back to size indicated.
- 8) It is the landscape contractor's responsibility to provide plants free of disease or pests.
- 9) Space specified quantity of plant materials to evenly fill designated areas, adjusting spacing indicated on the drawings as required. Landscape architect or owner to have final approval of locations of all trees, shrubs and groundcover beds.
- 10) Contractor is responsible for removing all clods, rocks, concrete, trash and any other debris from beds prior to adding soil or plant material.
- 11) All planting beds should have three (3) inches of compost tilled into them to a depth of six (6) inches. A three (3) inch layer of shredded hardwood bark mulch should be applied to all beds after planting is completed. Four (4) inch pots and ground cover may be planted through the mulch.
- 12) Contractor is responsible for removal of trash and repair of hazardous conditions (tools, open holes, et.) on a daily basis by the end of the work day.
- 13) Water all plantings in bed areas thoroughly on a daily basis until final acceptance.

- 14) To prepare turf areas treat them with a selective herbicide two weeks prior to sodding or seeding. Then rake area to remove stones, sticks and other debris. Add two (2) inches of topsoil to the turf area. Rake area to a finish grade (1" below walkways and curbs).
- 15) If sodding is to take place the sod should be gathered and planted within a 48 hour period. Lay the sod to form a solid mass with tight fitting joints. Butt ends and sides of sod and offset joints in adjacent courses. Roll sod to ensure good contact with soil. If planting on a slope be sure to lay courses parallel to the contours and secure sod with pins if necessary. Site preparation and maintenance will be the same for hydromulching.
- 16) Water sod daily so as to not allow turf blades to wilt. If necessary water twice per day.
- 17) Apply slow release fertilizer 15-15-15 or equal at a rate of 2 lbs. per 100 s.f. to all turf or planted areas.

REFERENCE NOTE SPECIFICATIONS

- LAWN AREAS - SOD / HYDROMULCH / SEED MIX
1. Lawn, Bermuda "Tif 419" Sod. Provide spray irrigation. Temporary irrigation only within septic fields or Right of Way (R.O.W.). Pre emergent weed treatment recommended.

- STEEL EDGE
2. Steel edge, 3/16" x 4" landscape edging as manufactured by Ryerson, or equal, dark green and furnished with steel stakes. Install edging in smooth curves free of kinks. Final height of edging to be 1" above height of soil mat of sod.

- MULCHES / GRAVELS / RIVER ROCK / BOULDERS
3. Mulch, Native Hardwood. 3" deep with drip irrigation. Ensure that drip line is placed above rootballs.

- 19) Contractor shall keep all construction areas and public streets free from accumulation of waste material. Upon completion of construction and prior to final approval contractor shall thoroughly clean the site of all trash, spilled soil, and litter, etc. that has resulted from landscape construction operations. Repair all damage to finish grade including tailings from excavations, wheel ruts, etc. caused from construction. All debris, trash and excess materials and equipment shall be removed from the site prior to final acceptance.
- 20) Remove all tags, ribbons and wires from all newly installed plant material.



LANDSCAPE MAINTENANCE REQUIREMENTS

- The owner shall be responsible for:
- 1) Regular maintenance of all required landscape areas and plant materials in a vigorous and healthy condition, free from diseases, pests, weeds, and litter. This maintenance shall include weeding, watering, fertilization, pruning, mowing, edging, mulching or other needed maintenance, in accordance with generally accepted horticultural practice.
 - 2) The repair or replacement of required landscape structures (walls, fences, etc.) to a structurally sound condition.
 - 3) The regular maintenance, repair, or replacement, where necessary, of any required screening or buffering.
 - 4) All open space areas that are to be preserved as natural plant communities shall be trimmed, at least once a year, of all exotic vegetation, lawn grasses, trash, or other debris. Natural area should be mulched, pruned and otherwise maintained so that plants are vigorous.


IRRIGATION SPECIFICATIONS

- 1) Irrigation contractor will provide pipes for sleeves and specify locations for placement of sleeves by general contractor prior to pouring concrete or laying asphalt.
- 2) Irrigation contractor will install all backflow prevention devices and all piping between the point of connection and the backflow preventer as per local governing authorities.
- 3) Find location of backflow preventer, and automatic controller location shall be approved by the owner's authorized representative.

- 4) 120 VAC electrical power source at controller location shall be provided by others. The irrigation contractor shall make the final connection from the electrical source to the controller.
- 5) All sprinkler heads shall be set perpendicular to finish grade unless otherwise specified.
- 6) The irrigation contractor shall flush and adjust all sprinkler heads and valves for optimum coverage with minimal overspray onto walks, streets, walls, etc.
- 7) Head location is the responsibility of the irrigation contractor, with the understanding that all landscape areas will receive adequate water to provide for vigorous growth of vegetation.
- 8) Irrigation contractor will replace or repair all items damaged by his work.
- 9) All work shall be installed in accordance with applicable codes and ordinances for the City of Rockwall, Texas and the National Electrical Code and all governing authorities.
- 10) The irrigation contractor is responsible for reporting any deficiency in water pressure that would affect the operation of the irrigation system.
- 11) The irrigation contractor shall be a Registered Licensed Irrigator in the State of Texas. Contractor must conform to all codes as stated in section 34 of the Texas Water Code and TNRCC.
- 12) All remote control valves, gate valves, quick couplers and control wire and computer cable pull pints shall be installed in approved valve boxes.
- 13) Irrigation Contractor shall procure all permits, licenses, and pay all charges and fees and give all necessary notices for the completion of work.
- 14) Contractor shall not disturb roots of existing trees. There shall be no machine trenching below the dripline of existing trees.
- 15) Extreme care shall be exercised in excavating and working near utilities. Contractor shall verify the location and condition of all utilities and be responsible for damage to any utilities.
- 16) Contractor shall clearly mark all exposed excavations, materials, and equipment. Cover or barricade trenches when the contractor is not on the site. Take all necessary precautions to protect and prevent injury to any persons on the site.
- 17) All automatic irrigation systems shall be equipped with a controller of dual or multiple programming. Controllers shall have multiple cycle start capacity and a flexible calendar program, including the capacity of being set to water every five days. All automatic irrigation systems shall be equipped with a rain sensor shutoff device.
- 18) Irrigation in Texas is regulated by the Texas Commission on Environmental Quality, www.tceq.texas.gov, (512) 239-1000

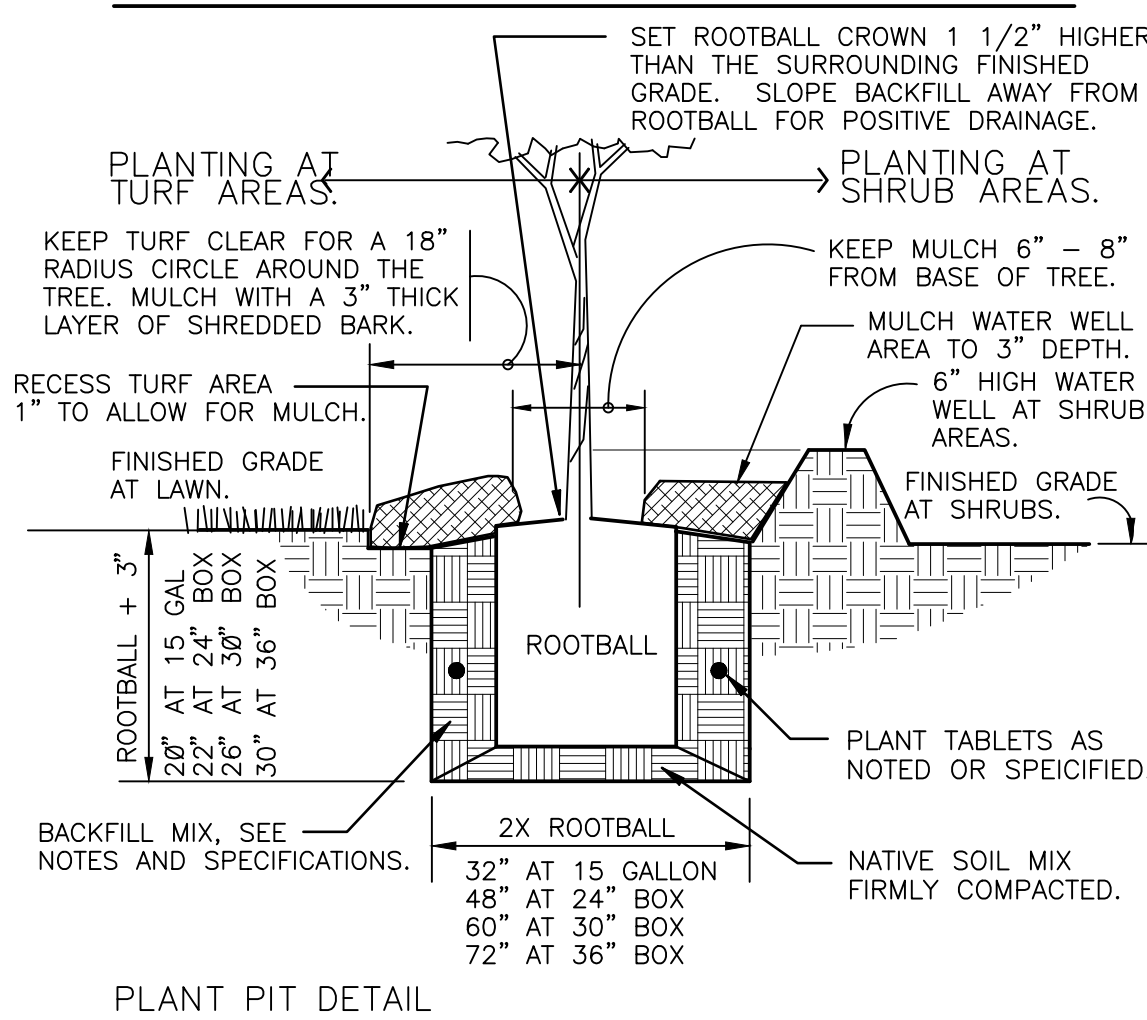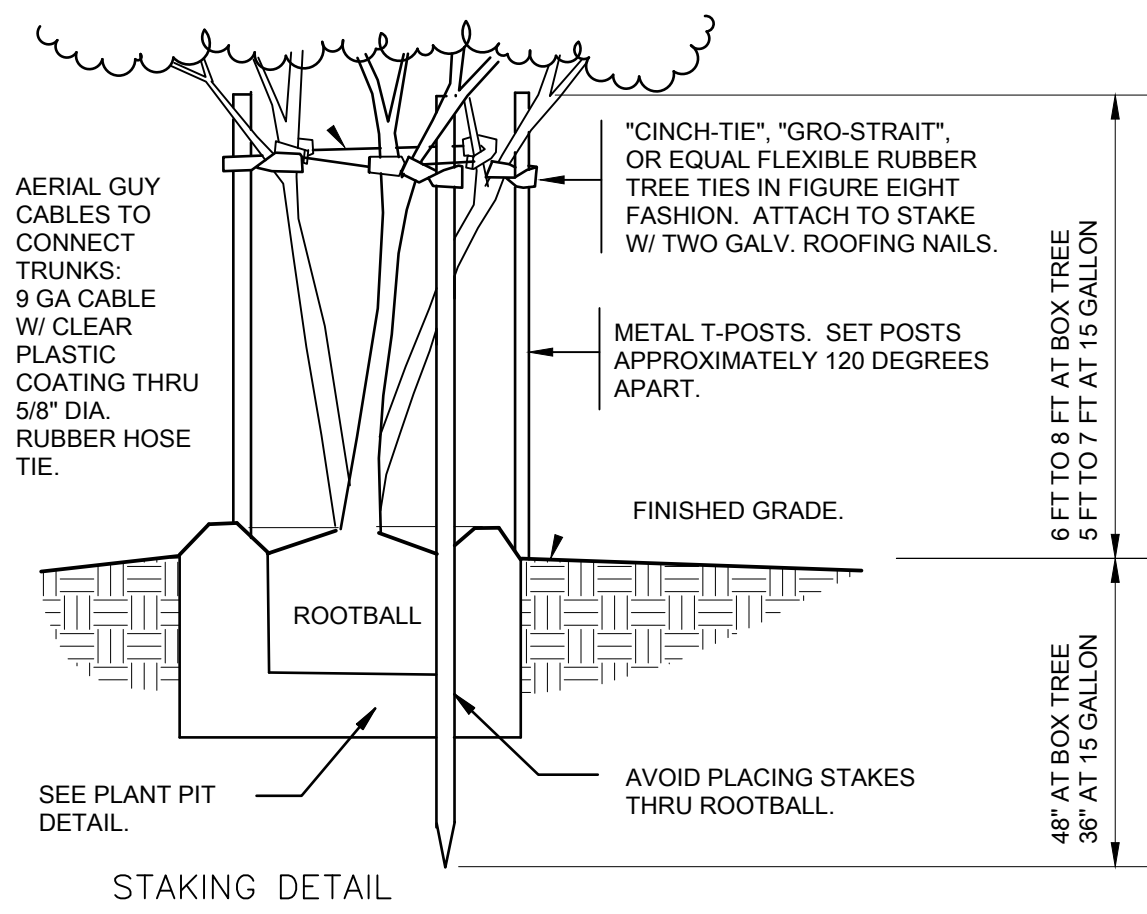

1 TREE PLANTING MULTI-STAKE
1" = 1'-0"

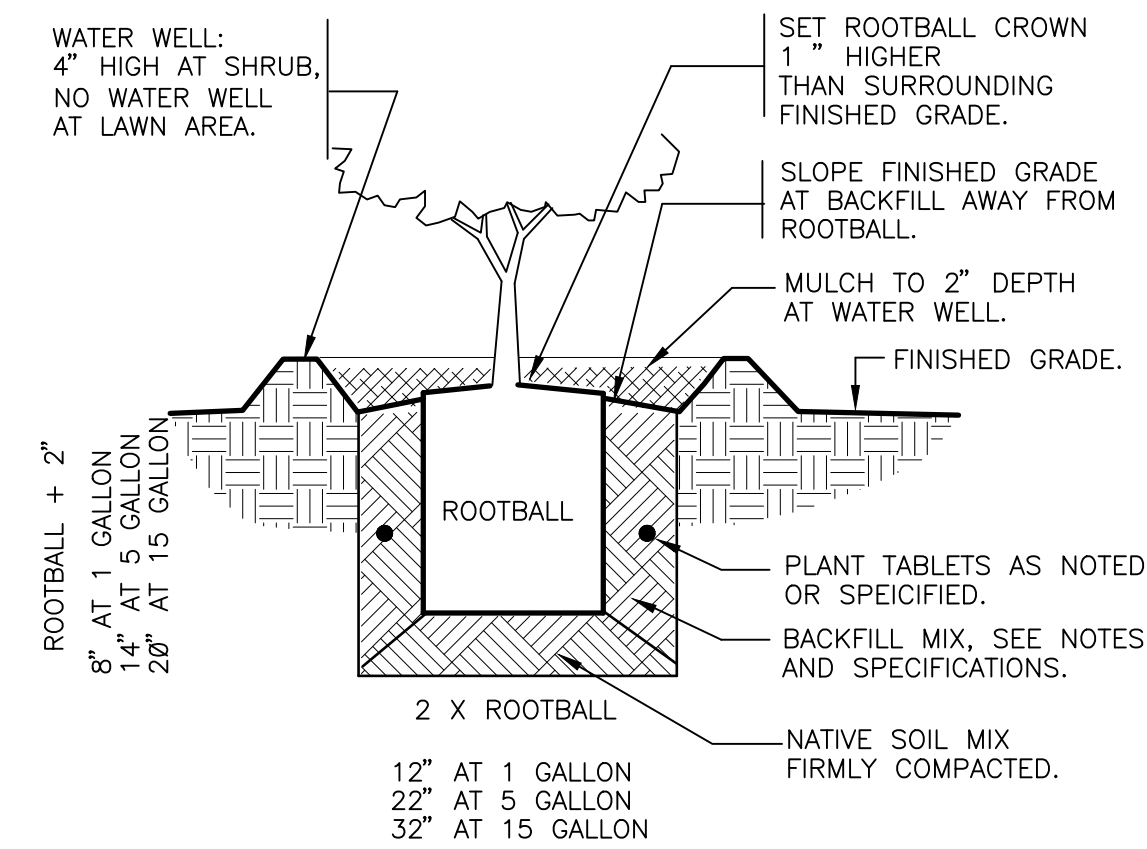

2 SHRUB PLANTING
1" = 1'-0"

will


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will blair

Contractors:
email info@blairla.com with RFIs, submittals, & inspection scheduling
Schedule inspections at least 2 weeks in advance

Date							
Description							
Rev							
Consultant Seal							
Company Name and Address							
William S. Blair (512) 522-8979 info@blairla.com www.blairla.com 100 Congress Ave. Ste 2000 Austin, TX 78701							
William S. Blair October 14, 2023							
Project Name and Address							
Hteo Rockwall N Gollad Dr. and Bordeaux Dr. Rockwall, Texas							
Sheet Title							
Landscape Details & Specifications							
Design By: Will Blair							
Checked By: xxxx							
Issue Date: 09/15/2023							
Project Number: Z3062-LP							

TYPE G1 NLS LIGHTING NV-1-T3-32L-1-40K8-DPS3-BLK-HSS 116W

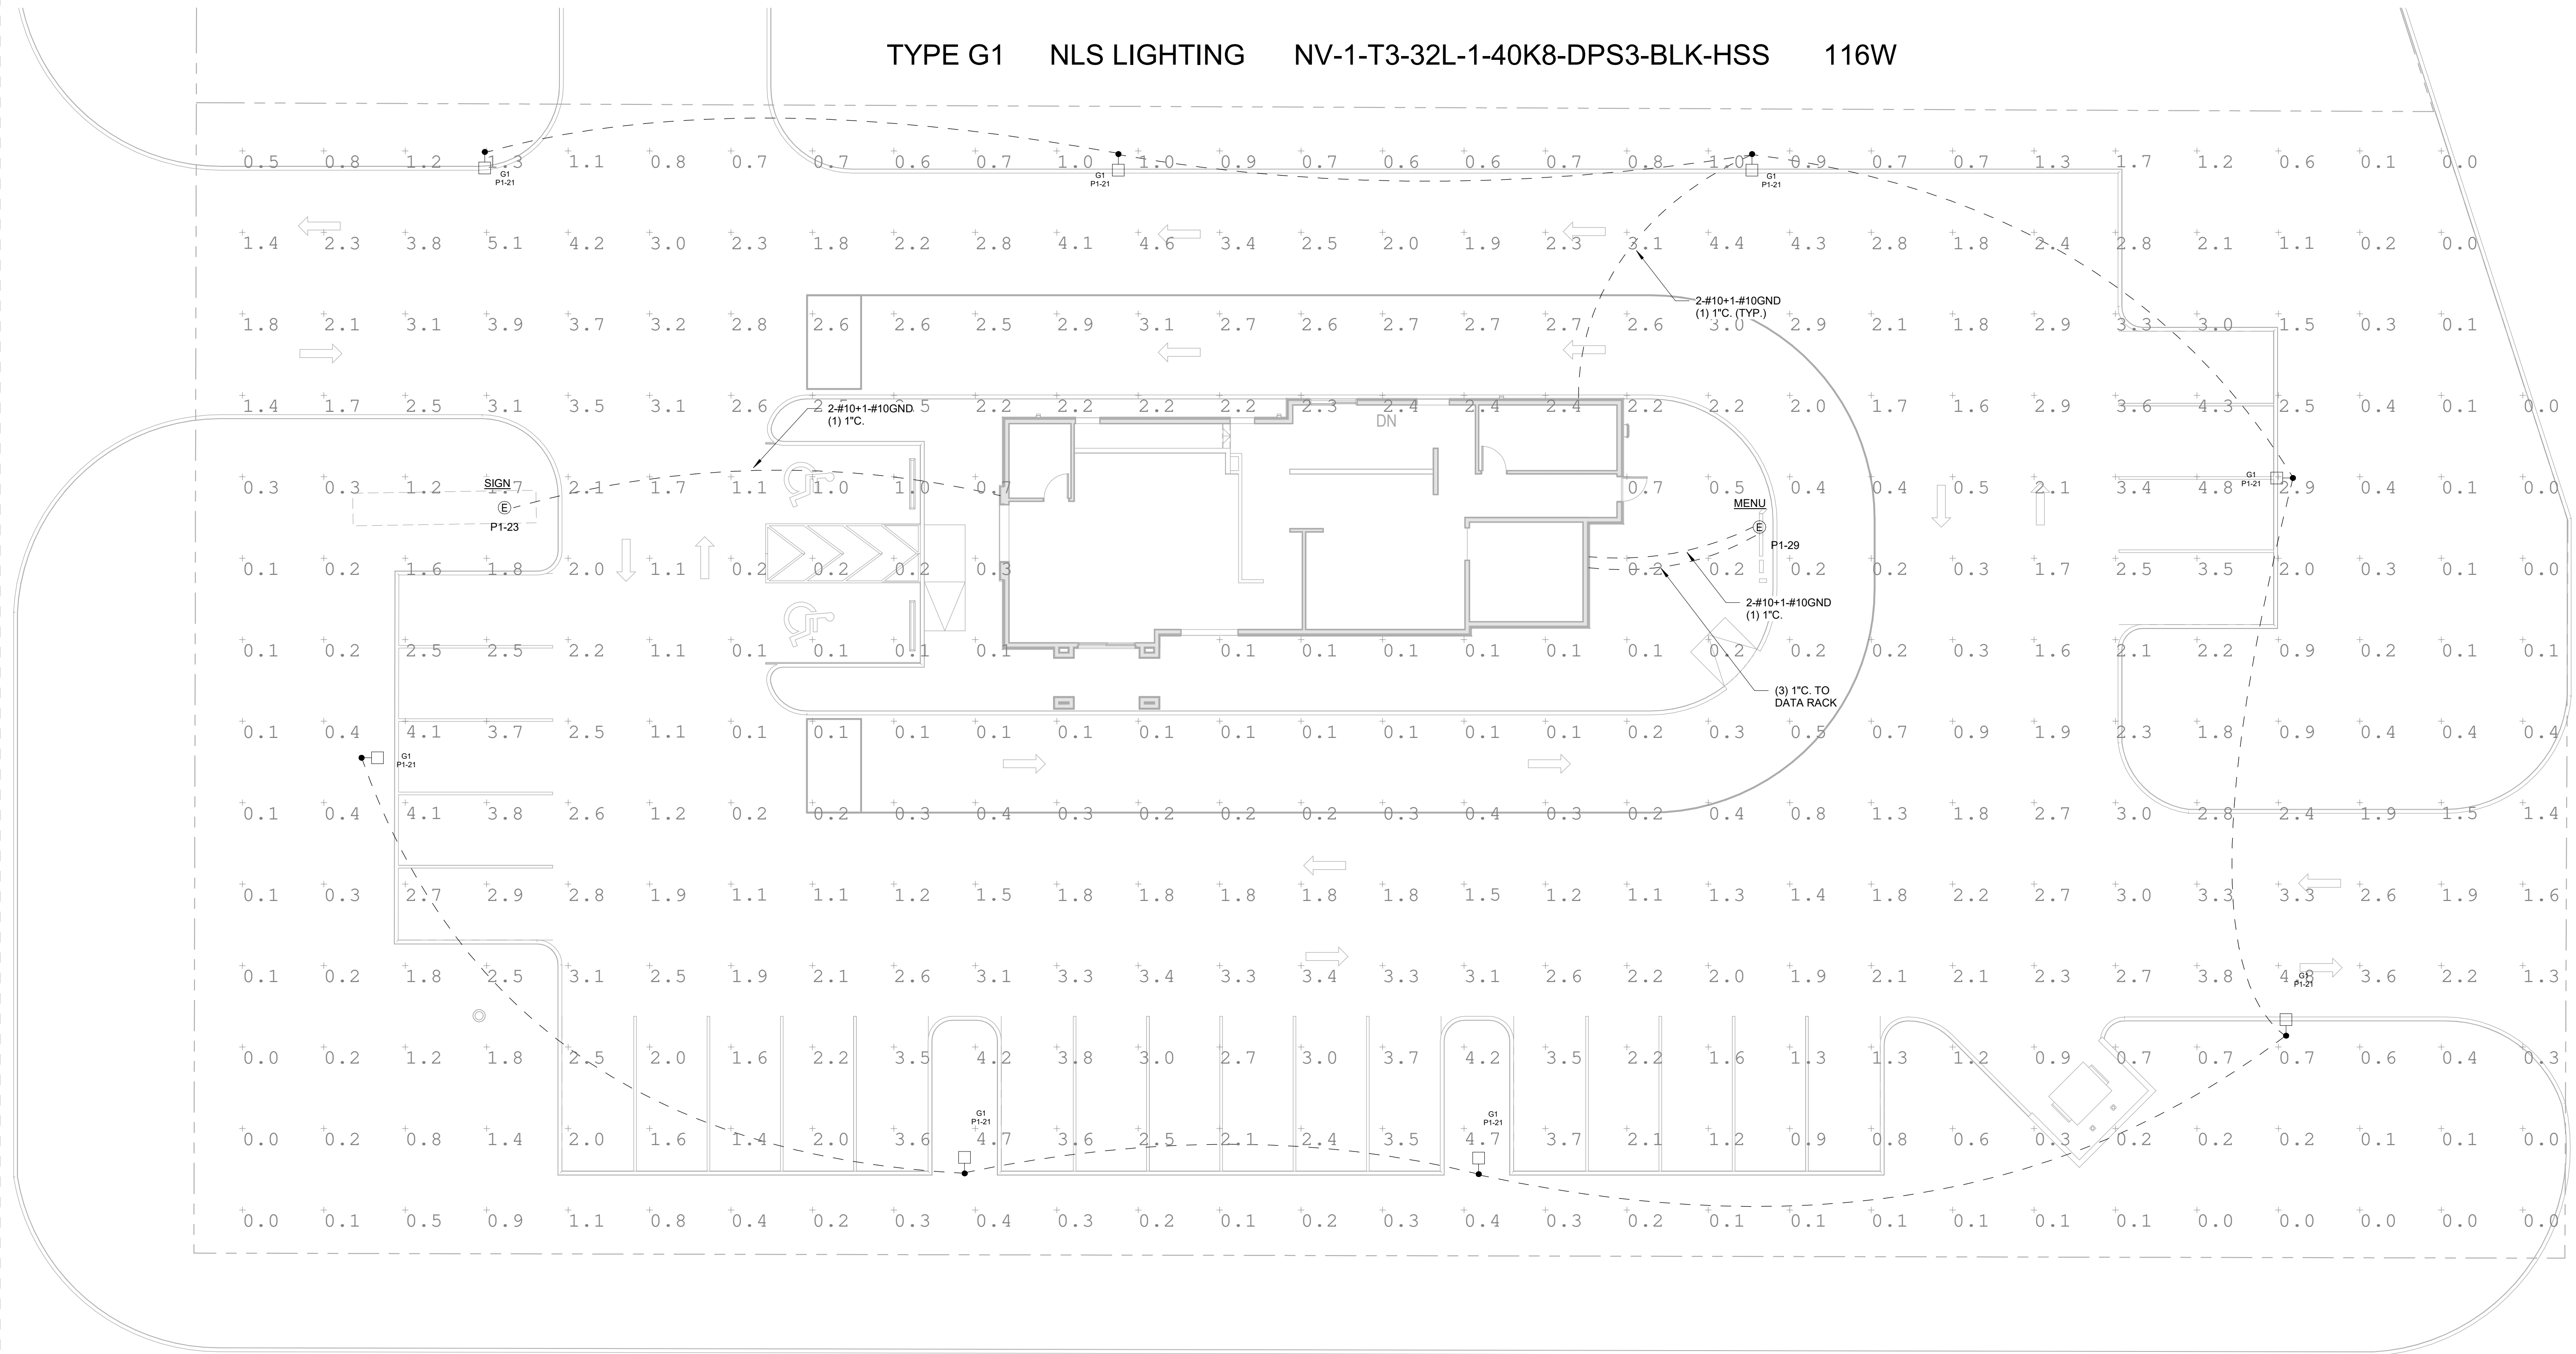

1 ELECTRICAL SITE PHOTOMETRIC PLAN
SCALE: 1"=10'-0"



HTEAO ROCKWALL
HWY 205 & BORDEAUX DR.
ROCKWALL, TX 75087



Date: 09/29/2023
Dwn: KSF Chk: CG
Project No.: 2348
Issue: PERMIT

Sheet Name:
ELECTRICAL
SITE
PHOTOMETRIC
PLAN

E0.2

