

## **DEVELOPMENT APPLICATION**

City of Rockwall
Planning and Zoning Department
385 S. Goliad Street
Rockwall, Texas 75087

Ì	PLANNING & ZONING CASE NO.
	<u>NOTE:</u> THE APPLICATION IS NOT CONSIDERED ACCEPTED BY THE CITY UNTIL THE PLANNING DIRECTOR AND CITY ENGINEER HAVE SIGNED BELOW.
	DIRECTOR OF PLANNING:
	CITY ENGINEER:

	Rockwall, Texas 75007	CITYE	NGINEER:	
PLEASE CHECK THE AF	PPROPRIATE BOX BELOW TO INDICATE THE TYPE OF	DEVELOPMENT REQU	UEST [SELECT ONLY ONE BOX]:	-
☐ MASTER PLAT (\$ ☐ PRELIMINARY PL ☐ FINAL PLAT (\$300.00 ☐ REPLAT (\$300.00 ☐ AMENDING OR M ☐ PLAT REINSTATE  SITE PLAN APPLICA ☐ SITE PLAN (\$250.	100.00 + \$15.00 ACRE) 1 LAT (\$200.00 + \$15.00 ACRE) 1 0.00 + \$20.00 ACRE) 1 1 + \$20.00 ACRE) 1 IINOR PLAT (\$150.00) EMENT REQUEST (\$100.00) ATION FEES: .00 + \$20.00 ACRE) 1	☐ ZONING CHAN☐ SPECIFIC USE☐ PD DEVELOPM  OTHER APPLICA☐ TREE REMOV.☐ VARIANCE RE  NOTES:  :: IN DETERMINING THE PER ACRE AMOUNT. FO  :: A \$1,000.00 FEE WI	NGE (\$200.00 + \$15.00 ACRE) 1 E PERMIT (\$200.00 + \$15.00 ACRE) 1 8 2 MENT PLANS (\$200.00 + \$15.00 ACRE) 1 ATION FEES: AL (\$75.00) EQUEST/SPECIAL EXCEPTIONS (\$100.00) 2  E FEE, PLEASE USE THE EXACT ACREAGE WHEN MULTIPLYING BY THE OR REQUESTS ON LESS THAN ONE ACRE, ROUND UP TO ONE (1) ACRE. LL BE ADDED TO THE APPLICATION FEE FOR ANY REQUEST THAT	
PROPERTY INFOR	RMATION [PLEASE PRINT]			
ADDRESS	BUILDING 2, 2014-A, PORT	TOFINO DR	, ROCKWALL TX 75032	
SUBDIVISION				
GENERAL LOCATION	SUMMER LEE AND POP	RTOFINO S	RIVE	
ONING, SITE PL	AN AND PLATTING INFORMATION [PLEASE	E PRINT]		
CURRENT ZONING	PD -22	CURRENT USE	CONDOMINIUMS	
PROPOSED ZONING		PROPOSED USE	COMBOMINIUMS.	
ACREAGE	6.5995 LOTS [CURRENT]	85	LOTS [PROPOSED] 85	
REGARD TO ITS AF	PPROVAL PROCESS, AND FAILURE TO ADDRESS ANY OF S	NAT DUE TO THE PASSA STAFF'S COMMENTS BY T	GE OF <u>HB3167</u> THE CITY NO LONGER HAS FLEXIBILITY WITI THE DATE PROVIDED ON THE DEVELOPMENT CALENDAR WIL	4
OWNER/APPLICA	NT/AGENT INFORMATION [PLEASE PRINT/CHE	ECK THE PRIMARY CONTA	ACT/ORIGINAL SIGNATURES ARE REQUIRED]	
<b>☑</b> OWNER	PLUTUS 21 DEUELOPMENT	✓ □ APPLICANT		
CONTACT PERSON	DANIYAL AWAN	CONTACT PERSON		
_		ADDRESS		WITH WILL
		CITY, STATE & ZIP		
		PHONE		
		E-MAIL		
EFORE ME, THE UNDERS	SIGNED AUTHORITY, ON THIS DAY PERSONALLY APPEARED	Daniyal A	wan [OWNER] THE UNDERSIGNED, WHO	)
AUGU T NFORMATION CONTAINED SUBMITTED IN CONJUNCTION	TO COVER THE COST OF THIS APPLICATION, HAS 20 23 BY SIGNING THIS APPLICATION, I AGRE. WITHIN THIS APPLICATION TO THE PUBLIC. THE CITY IS ON WITH THIS APPLICATION, IF SUCH REPRODUCTION IS ASSOCIATED.	S BEEN PAID TO THE CITY ( E THAT THE CITY OF ROC ALSO AUTHORIZED AND	OF ROCKWALL ON THIS THE <b>10 M.</b> DAY OF CHARLES OF THE PROVIDE OF THE PROVIDE OF THE PROVIDE OF THE PROVIDE OF THE PROPERTY OF	F E
IVEN UNDER MY HAND A	ND SEAL OF OFFICE ON THIS THE 18+ DAY OF AUG	just 2023.	Comm. Expires 03-02-2026	1 1 1
	OWNER'S SIGNATURE		William.	
IOTARY PUBLIC IN AND F	OR THE STATE OF TEXAS Blo	112 Cheistine gen	mings MY COMMISSION EXPIRES 3.2-2626	
	PLATTING APPLICA  MASTER PLAT (\$ PRELIMINARY PL FINAL PLAT (\$300.00 REPLAT (\$300.00 AMENDING OR M PLAT REINSTATE SITE PLAN APPLICA SITE PLAN (\$250 AMENDED SITE F  PROPERTY INFO! ADDRESS SUBDIVISION GENERAL LOCATION CONING, SITE PLAN CURRENT ZONING ACREAGE  SITE PLANS AND REGARD TO ITS AIR RESULT IN THE DE  OWNER CONTACT PERSON ADDRESS CITY, STATE & ZIP PHONE E-MAIL  OTARY VERIFIC EFORE ME, THE UNDERS INTERPLATED THE INFORMATION CONTACT PERSON ADDRESS  CITY STATE & ZIP PHONE E-MAIL  OTARY VERIFIC EFORE ME, THE UNDERS INTERPLATED THE INFORMATION CONJUNCTION INTERPLATED IN CONJUNCTION INTERPLATED INTERPLATED INTERPLATED INTERPLATED INTERPLATED INTERPLATED INTERPLA	LEASE CHECK THE APPROPRIATE BOX BELOW TO INDICATE THE TYPE OF  PLATTING APPLICATION FEES:    MASTER PLAT (\$100.00 + \$15.00 ACRE)     PRELIMINARY PLAT (\$200.00 + \$15.00 ACRE)     FINAL PLAT (\$300.00 + \$20.00 ACRE)     AMENDING OR MINOR PLAT (\$150.00)   PLAT REINSTATEMENT REQUEST (\$100.00)  SITE PLAN (\$250.00 + \$20.00 ACRE)     AMENDING OR MINOR PLAT (\$150.00)   PLAT REINSTATEMENT REQUEST (\$100.00)  SITE PLAN (\$250.00 + \$20.00 ACRE)     AMENDED SITE PLAN/ELEVATIONS/LANDSCAPING PLAN (\$100.00)  PROPERTY INFORMATION [PLEASE PRINT]  ADDRESS  SUBDIVISION  WATERS ED AE AT LAKE  SUBDIVISION  WATERS ED AE AT LAKE  CURRENT ZONING  PD -22  PROPOSED ZONING  ACREAGE  6.5995  LOTS [CURRENT]  SITE PLANS AND PLATS: BY CHECKING THIS BOX YOU ACKNOWLEDGE THE REGARD TO ITS APPROVAL PROCESS, AND FAILURE TO ADDRESS ANY OF SESULT IN THE DENIAL OF YOUR CASE.  DWNER/APPLICANT/AGENT INFORMATION [PLEASE PRINTICHE  OWNER PLUTUS 21 DEUELOPMENT OF YOUR CASE.  CONTACT PERSON  ADDRESS  INSTED ALAS TX 75229  PHONE YOU SO THIS APPLICATION TO THE DUBLIC THE ITY IS TO COVER THE COST OF THIS APPLICATION; ALL  OTARY VERIFICATION ON THIS APPLICATION TO THE PUBLIC. THE CITY IS DEMITTED IN CONTAINED WITHIN THIS APPLICATION TO THE PUBLIC. THE CITY IS DEMITTED IN CONTAINED WITHIN THIS APPLICATION, I ARE  FORMATION CONTAINED WITHIN THIS APPLICATION TO THE PUBLIC. THE CITY IS DEMITTED IN CONJUNCTION WITH THIS APPLICATION, I SUCH REPRODUCTION IS ASSO  OWNER'S SIGNATURE	MASTER PLAT (\$100.00 + \$15.00 ACRE)   PRERLIMMARY LLT (\$200.00 + \$15.00 ACRE)   PRERLIMMARY LLT (\$200.00 + \$15.00 ACRE)   PREPLAT (\$300.00 + \$20.00 ACRE)   PREPLAT (\$300.00 + \$	







# City of Rockwall Planning & Zoning Department 385 S. Goliad Street Rockwall, Texas 75087 (P): (072) 774 7745

(P): (972) 771-7745 (W): www.rockwall.com

The City of Rockwall GIS maps are continually under development and therefore subject to change without notice. While we endeavor to provide timely and accurate information, we make no guarantees. The City of Rockwall makes no warranty, express or implied, including warranties of merchantability and fitness for a particular purpose. Use of the information is the sole responsibility of the user.



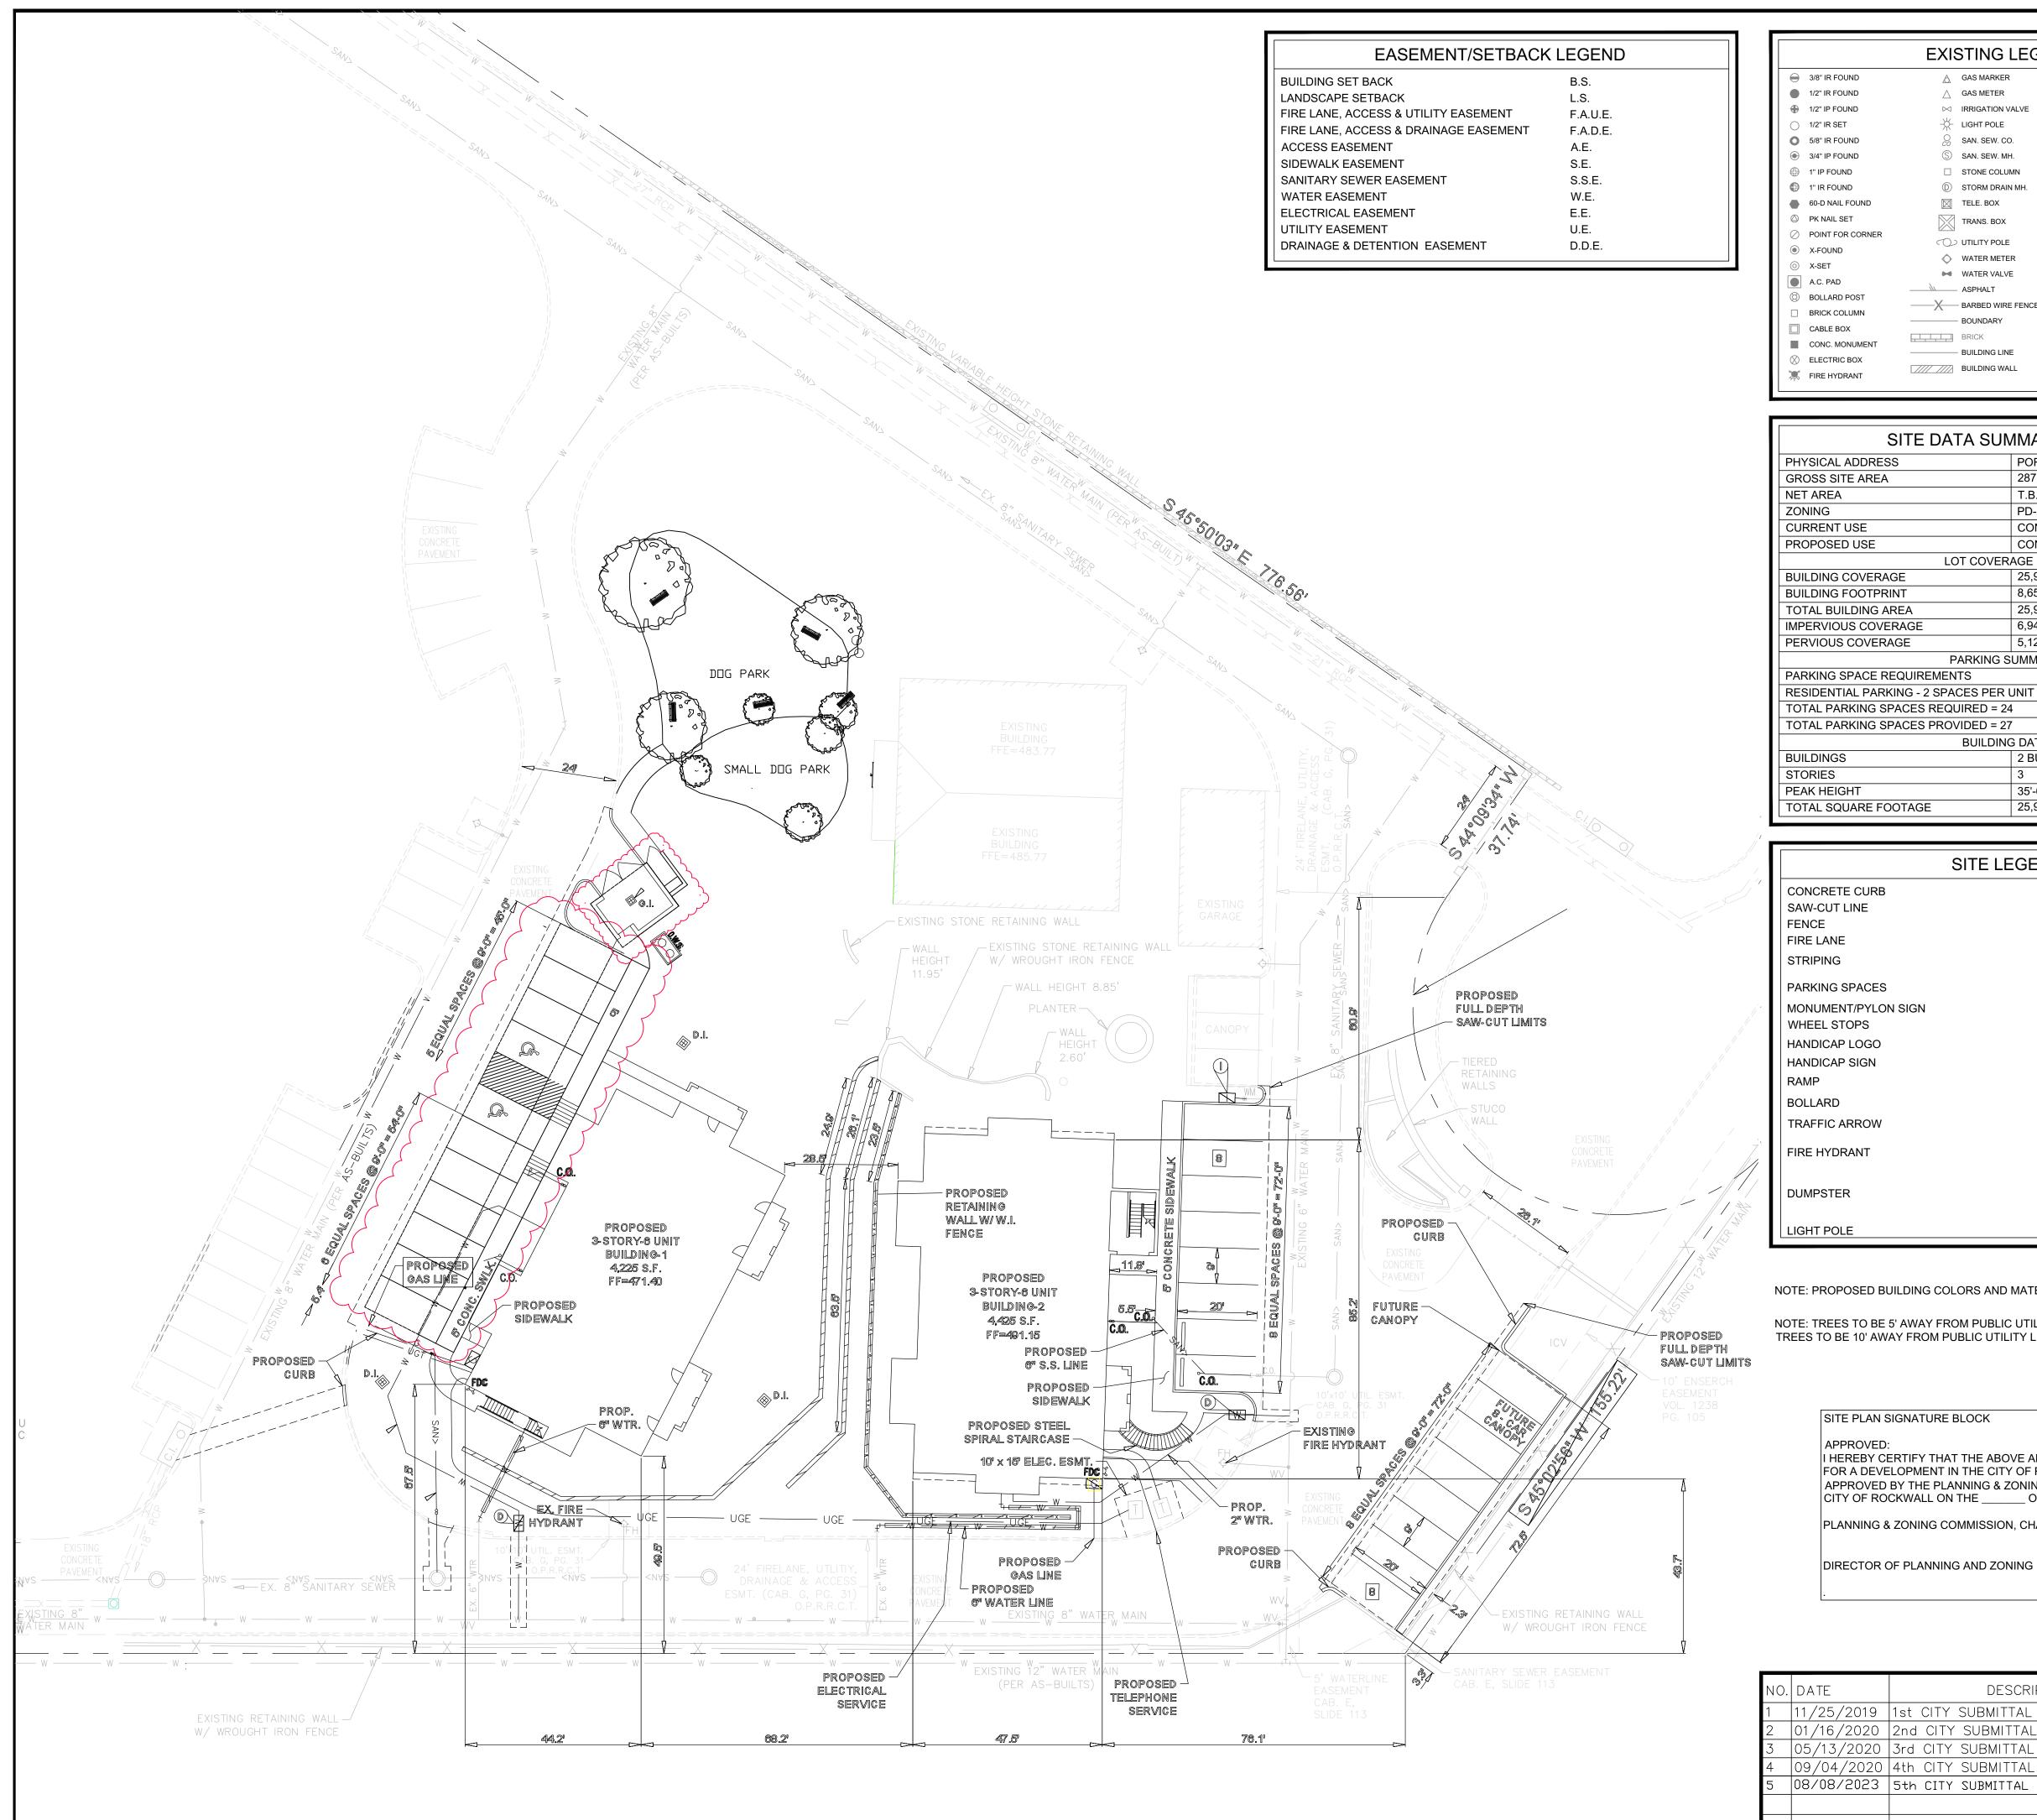

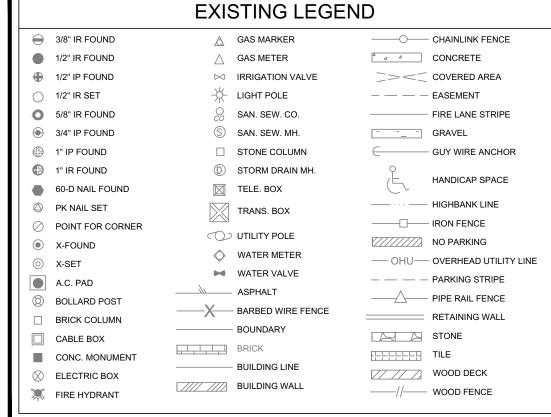

SITE DATA SUMMARY TABLE					
PHYSICAL ADDRESS	PORTOFINO DRIVE				
GROSS SITE AREA	287,476 S.F. / 6.60 ACRES				
NET AREA	T.B.D.				
ZONING	PD-22				
CURRENT USE	CONDOMINIMUMS				
PROPOSED USE	CONDOMINIMUMS				
LOT	COVERAGE DATA				
BUILDING COVERAGE	25,950 S.F.				
BUILDING FOOTPRINT	8,650 S.F.				
TOTAL BUILDING AREA	25,950 S.F.				
IMPERVIOUS COVERAGE	6,946 S.F.				
PERVIOUS COVERAGE	5,127 S.F.				
PAF	RKING SUMMARY				
PARKING SPACE REQUIREMENTS					
RESIDENTIAL PARKING - 2 SPACE	S PER UNIT				
TOTAL PARKING SPACES REQUIR	RED = 24				
TOTAL PARKING SPACES PROVID	DED = 27				
В	UILDING DATA				
BUILDINGS	2 BUILDINGS & 1 GARAGE				
STORIES	3				
PEAK HEIGHT	35'-0"				
TOTAL SQUARE FOOTAGE	25,950 S.F.				

SI	TE LEGEND
CONCRETE CURB	
SAW-CUT LINE	
FENCE	X
FIRE LANE	
STRIPING	
PARKING SPACES	9
MONUMENT/PYLON SIGN	
WHEEL STOPS	
HANDICAP LOGO	<u> E</u>
HANDICAP SIGN	
RAMP	000 000 000 000 000
BOLLARD	•
TRAFFIC ARROW	<b>→</b>
FIRE HYDRANT	
DUMPSTER	
LIGHT POLE	

NOTE: PROPOSED BUILDING COLORS AND MATERIALS TO MATCH EXISTING BUILDINGS.

NOTE: TREES TO BE 5' AWAY FROM PUBLIC UTILITY LINES LESS THAN 10". TREES TO BE 10' AWAY FROM PUBLIC UTILITY LINES THAT ARE 10" OR GREATER.


SITE PLAN SIGNATURE BLOCK I HEREBY CERTIFY THAT THE ABOVE AND FOREGOING SITE PLAN FOR A DEVELOPMENT IN THE CITY OF ROCKWALL, TEXAS, WAS APPROVED BY THE PLANNING & ZONING COMMISSION OF THE CITY OF ROCKWALL ON THE \_\_\_\_\_ OF \_\_\_\_\_, 2020. PLANNING & ZONING COMMISSION, CHAIRMAN


DESCRIPTION


KARTAVYA S. PATEL

97534

DIRECTOR OF PLANNING AND ZONING

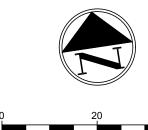

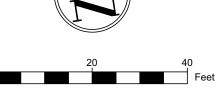

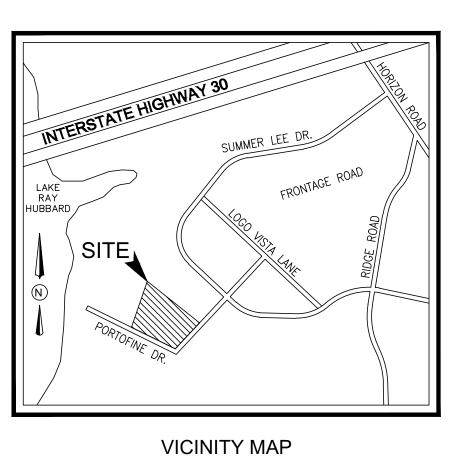

N.T.S.

## GENERAL NOTES

- 1. ALL CONSTRUCTION SHALL BE IN STRICT ACCORDANCE WITH THE STANDARDS OF THE CITY OF ROCKWALL.
- 2. A PERMIT IS REQUIRED TO CUT A CITY STREET OR WORK WITHIN THE RIGHT-OF-WAY. THE PERMIT IS ISSUED BY THE PUBLIC WORKS DEPARTMENT.
- 3. THE LOCATION OF UNDERGROUND UTILITIES INDICATED ON THE PLANS IS TAKEN FROM PUBLIC RECORDS. IT IS THE CONTRACTOR'S RESPONSIBILITY TO MAKE ARRANGEMENTS WITH THE OWNERS OF SUCH UNDERGROUND UTILITIES PRIOR TO WORKING IN THE AREA TO CONFIRM THEIR EXACT LOCATION AND TO DETERMINE WHETHER ANY ADDITIONAL UTILITIES OTHER THAN THOSE SHOWN ON THE PLANS MAY BE PRESENT. THE CONTRACTOR SHALL PRESERVE AND PROTECT ALL UNDERGROUND UTILITIES. IF EXISTING UNDERGROUND UTILITIES ARE DAMAGED, THE CONTRACTOR WILL BE RESPONSIBLE FOR THE COST OF REPAIRING THE UTILITY.
- 4. WHERE EXISTING UTILITIES OR SERVICE LINES ARE CUT, BROKEN OR DAMAGED, THE CONTRACTOR SHALL REPLACE OR REPAIR THE UTILITIES OR SERVICE LINES WITH THE SAME TYPE OF ORIGINAL MATERIAL AND CONSTRUCTION, OR BETTER, UNLESS OTHERWISE SHOWN OR NOTED ON THE PLANS, AT HIS OWN COST AND EXPENSE. THE CONTRACTOR SHALL IMMEDIATELY NOTIFY THE ENGINEER AT ONCE OF ANY CONFLICTS IN GRADES AND ALIGNMENT.
- 5. ALL EXCAVATIONS, TRENCHING AND SHORING OPERATIONS SHALL COMPLY WITH THE REQUIREMENTS OF THE U. S. DEPARTMENT OF LABOR, OSHA, "CONST. SAFETY AND HEALTH REGULATIONS.", VOL. 29, SUBPART P. PG. 128 - 137, AND ANY AMENDMENTS THERETO.
- 6. ADEQUATE MEASURES SHALL BE TAKEN TO PREVENT EROSION. IN THE EVENT THAT SIGNIFICANT EROSION OCCURS AS A RESULT OF CONSTRUCTION THE CONTRACTOR SHALL RESTORE THE ERODED AREA TO ORIGINAL CONDITION OR BETTER.
- 7. THE CONTRACTOR SHALL RESTORE ALL AREAS DISTURBED BY CONSTRUCTION TO ORIGINAL CONDITION OR BETTER. RESTORED AREAS INCLUDE, BUT ARE NOT LIMITED TO TRENCH BACKFILL, SIDE SLOPES, FENCES, CULVERT PIPES, DRAINAGE DITCHES, DRIVEWAYS, PRIVATE YARDS AND ROADWAYS.
- 8. ANY CHANGES NEEDED AFTER CONSTRUCTION PLANS HAVE BEEN RELEASED, SHALL BE APPROVED BY THE CITY ENGINEER. THESE CHANGES MUST BE RECEIVED IN WRITING FROM THE DESIGN ENGINEER. THE DIRECTOR OF PUBLIC WORKS SHALL APPROVE ANY DEVIATIONS FROM STATE REGULATIONS.
- 9. THE CONTRACTOR SHALL PROVIDE "RED LINED" MARKED PRINTS TO THE ENGINEER PRIOR TO FINAL INSPECTION INDICATING ALL CONSTRUCTION WHICH DEVIATED FROM THE PLANS OR WAS CONSTRUCTED IN ADDITION TO THAT INDICATED ON THE PLANS.

WATER METER & SANITARY SEWER SCHEDULE									
ID	ID TYPE SIZE NO. SAN. SEW.								
D DOM. 1 1/2" 2 6"									
1 IRR. 1" 1 N/A									

ı	
	SP2019-049
	SITE PLAN
	WATER'S EDGE AT LAKE RAY HUBBARD
	PORTOFINO DRIVE
	CITY OF ROCKWALL
	ROCKWALL COUNTY, TEXAS
	I FIANGLE



		,			,,		
Plann	Planning   Civil Engineering   Construction N						
DESIGN	DRAWN	DATE	SCALE	PROJECT NO.	SHEET NO.		
KP	MLM	11/7/2019	SEE SCALE BAR	040-19	2		
		TX PE FII	RM #11525	5	S		

STUCCO TO MATCH EXISTING Sheet metal canopy Mediterranean style to match existing cover for electrical supply and meter base

WEST ELEVATION

100% MASONRY 9% STONE 91% STUCCO

STUCCO SILL

- STONE WATER TABLE

- COMPLETE THE SYSTEM.
- 2. IT IS THE SUBCONTRACTOR'S RESPONSIBILITY TO REVIEW THE DOCUMENTS AND INCLUDE ALL NECESSARY ITEMS TO PROVIDE A COMPLETE OPERATIONAL SYSTEM.
- 3. ANY DISCREPANCIES NOTED BY THE SUBCONTRACTOR SHALL BE BROUGHT TO THE ATTENTIONS OF THE ARCHITECT (IN WRITING) BEFORE BIDDING THIS PROJECT.
- 4. AFTER BIDS ARE TURNED IN, THE SUBCONTRACTOR SHALL COMPLETE THE SYSTEMS AT NO ADDITIONAL COST.
- 5. PLUMBING, MECHANICAL, AND ELECTRICAL SUBCONTRACTORS ARE RESPONSIBLE FOR COORDINATING ALL COMPONENTS TO INSURE COMPLETE AND WORKING SYSTEMS EACH SUBCONTRACTOR SHALL REVIEW ALL DRAWINGS FOR COMPLIANCE.
- DETERMINE WHICH TRADE SHALL PROVIDE

**OWNER PLUTUS21 DEVELOPMENT** 6116 N. CENTRAL EXPWY #700 DALLAS, TEXAS 75206

CASE #SP2020-000

© COPYRIGHT 2019 MERSHAWN ARCHITECTS, INC. NO PRINTING OR COPING IS ALLOWED WITHOUT PERMISSION FROM MERSHAWN.

6. THE ARCHITECT WILL BE RESPONSIBLE TO AND INSTALL ANY COMPONENTS MISSED FOR WORKING SYSTEMS AS NEEDED.

Project No.: Designed: GW Drawn: GW Checked: WM SHEET

3/16" = 1'-0"


04/21/2023

Scale:



# SOUTH ELEVATION

100% MASONRY 10% STONE 90% STUCCO

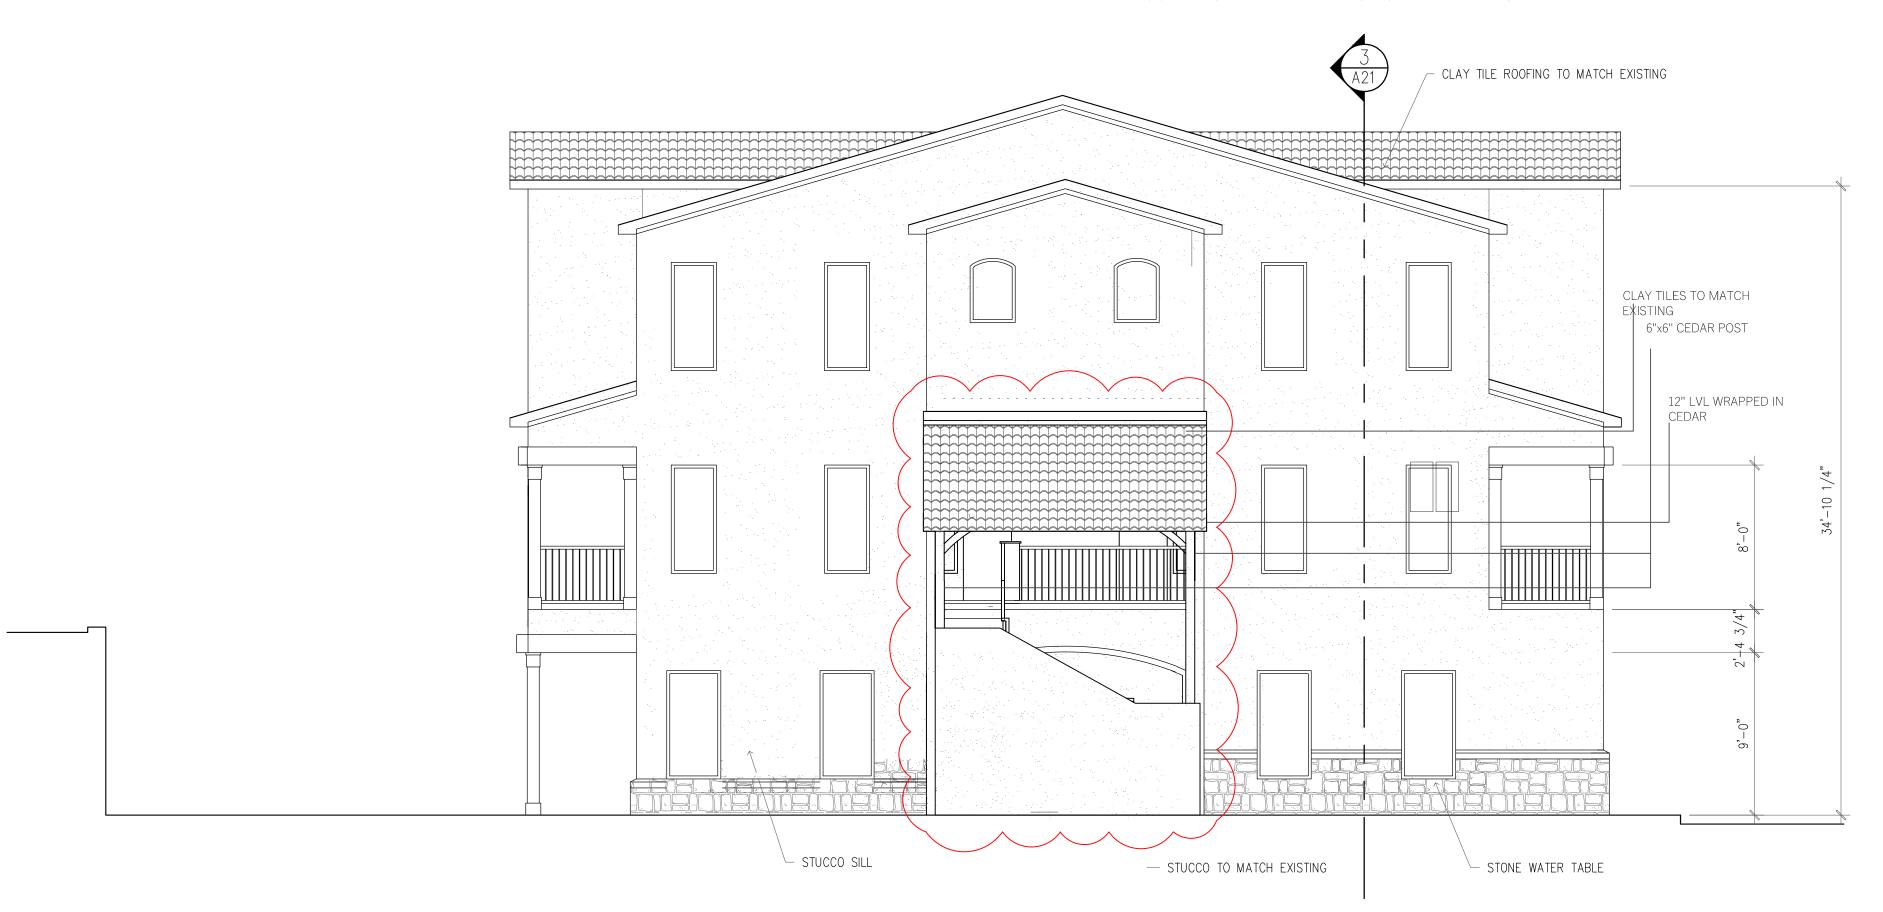

EAST ELEVATION 100% MASONRY 9% STONE 91% STUCCO NOTE: ALL NEW BUILDING ELEVATIONS SHALL MATCH COLORS TO THE EXISTING SURROUNDING BUILDINGS. THIS BUILDING HAS SIX INDIVIDUAL LIVING UNITS.

# PRICING & CONSTRUCTION GENERAL NOTES:

THESE DRAWINGS ARE DIAGRAMMATIC IN NATURE AND ARE NOT INTENDED TO INDICATE EACH AND EVERY FITTING, OFFSET, OR OTHER APPURTENANCE NECESSARY TO

COMPLETE THE SYSTEM.


- 2. IT IS THE SUBCONTRACTOR'S RESPONSIBILITY TO REVIEW THE DOCUMENTS AND INCLUDE ALL NECESSARY ITEMS TO PROVIDE A COMPLETE OPERATIONAL SYSTEM.
- 3. ANY DISCREPANCIES NOTED BY THE SUBCONTRACTOR SHALL BE BROUGHT TO THE ATTENTIONS OF THE ARCHITECT (IN WRITING) BEFORE BIDDING THIS PROJECT.
- 4. AFTER BIDS ARE TURNED IN, THE SUBCONTRACTOR SHALL COMPLETE THE SYSTEMS AT NO ADDITIONAL COST.
- 5. PLUMBING, MECHANICAL, AND ELECTRICAL SUBCONTRACTORS ARE RESPONSIBLE FOR COORDINATING ALL COMPONENTS TO INSURE COMPLETE AND WORKING SYSTEMS EACH SUBCONTRACTOR SHALL REVIEW ALL DRAWINGS FOR COMPLIANCE.
- 6. THE ARCHITECT WILL BE RESPONSIBLE TO DETERMINE WHICH TRADE SHALL PROVIDE AND INSTALL ANY COMPONENTS MISSED FOR WORKING SYSTEMS AS NEEDED.

© COPYRIGHT 2019 MERSHAWN ARCHITECTS, INC. NO PRINTING OR COPING IS ALLOWED

**OWNER PLUTUS21 DEVELOPMENT** 6116 N. CENTRAL EXPWY #700 DALLAS, TEXAS 75206

CASE #SP2020-000

WITHOUT PERMISSION FROM MERSHAWN.

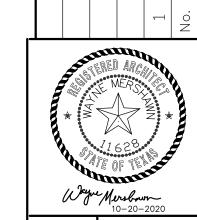

, **T** m ,

3/16" = 1'-0" Scale: 04/21/2023 Project No.: 190602 Designed: GW

Drawn: GW Checked: WM SHEET















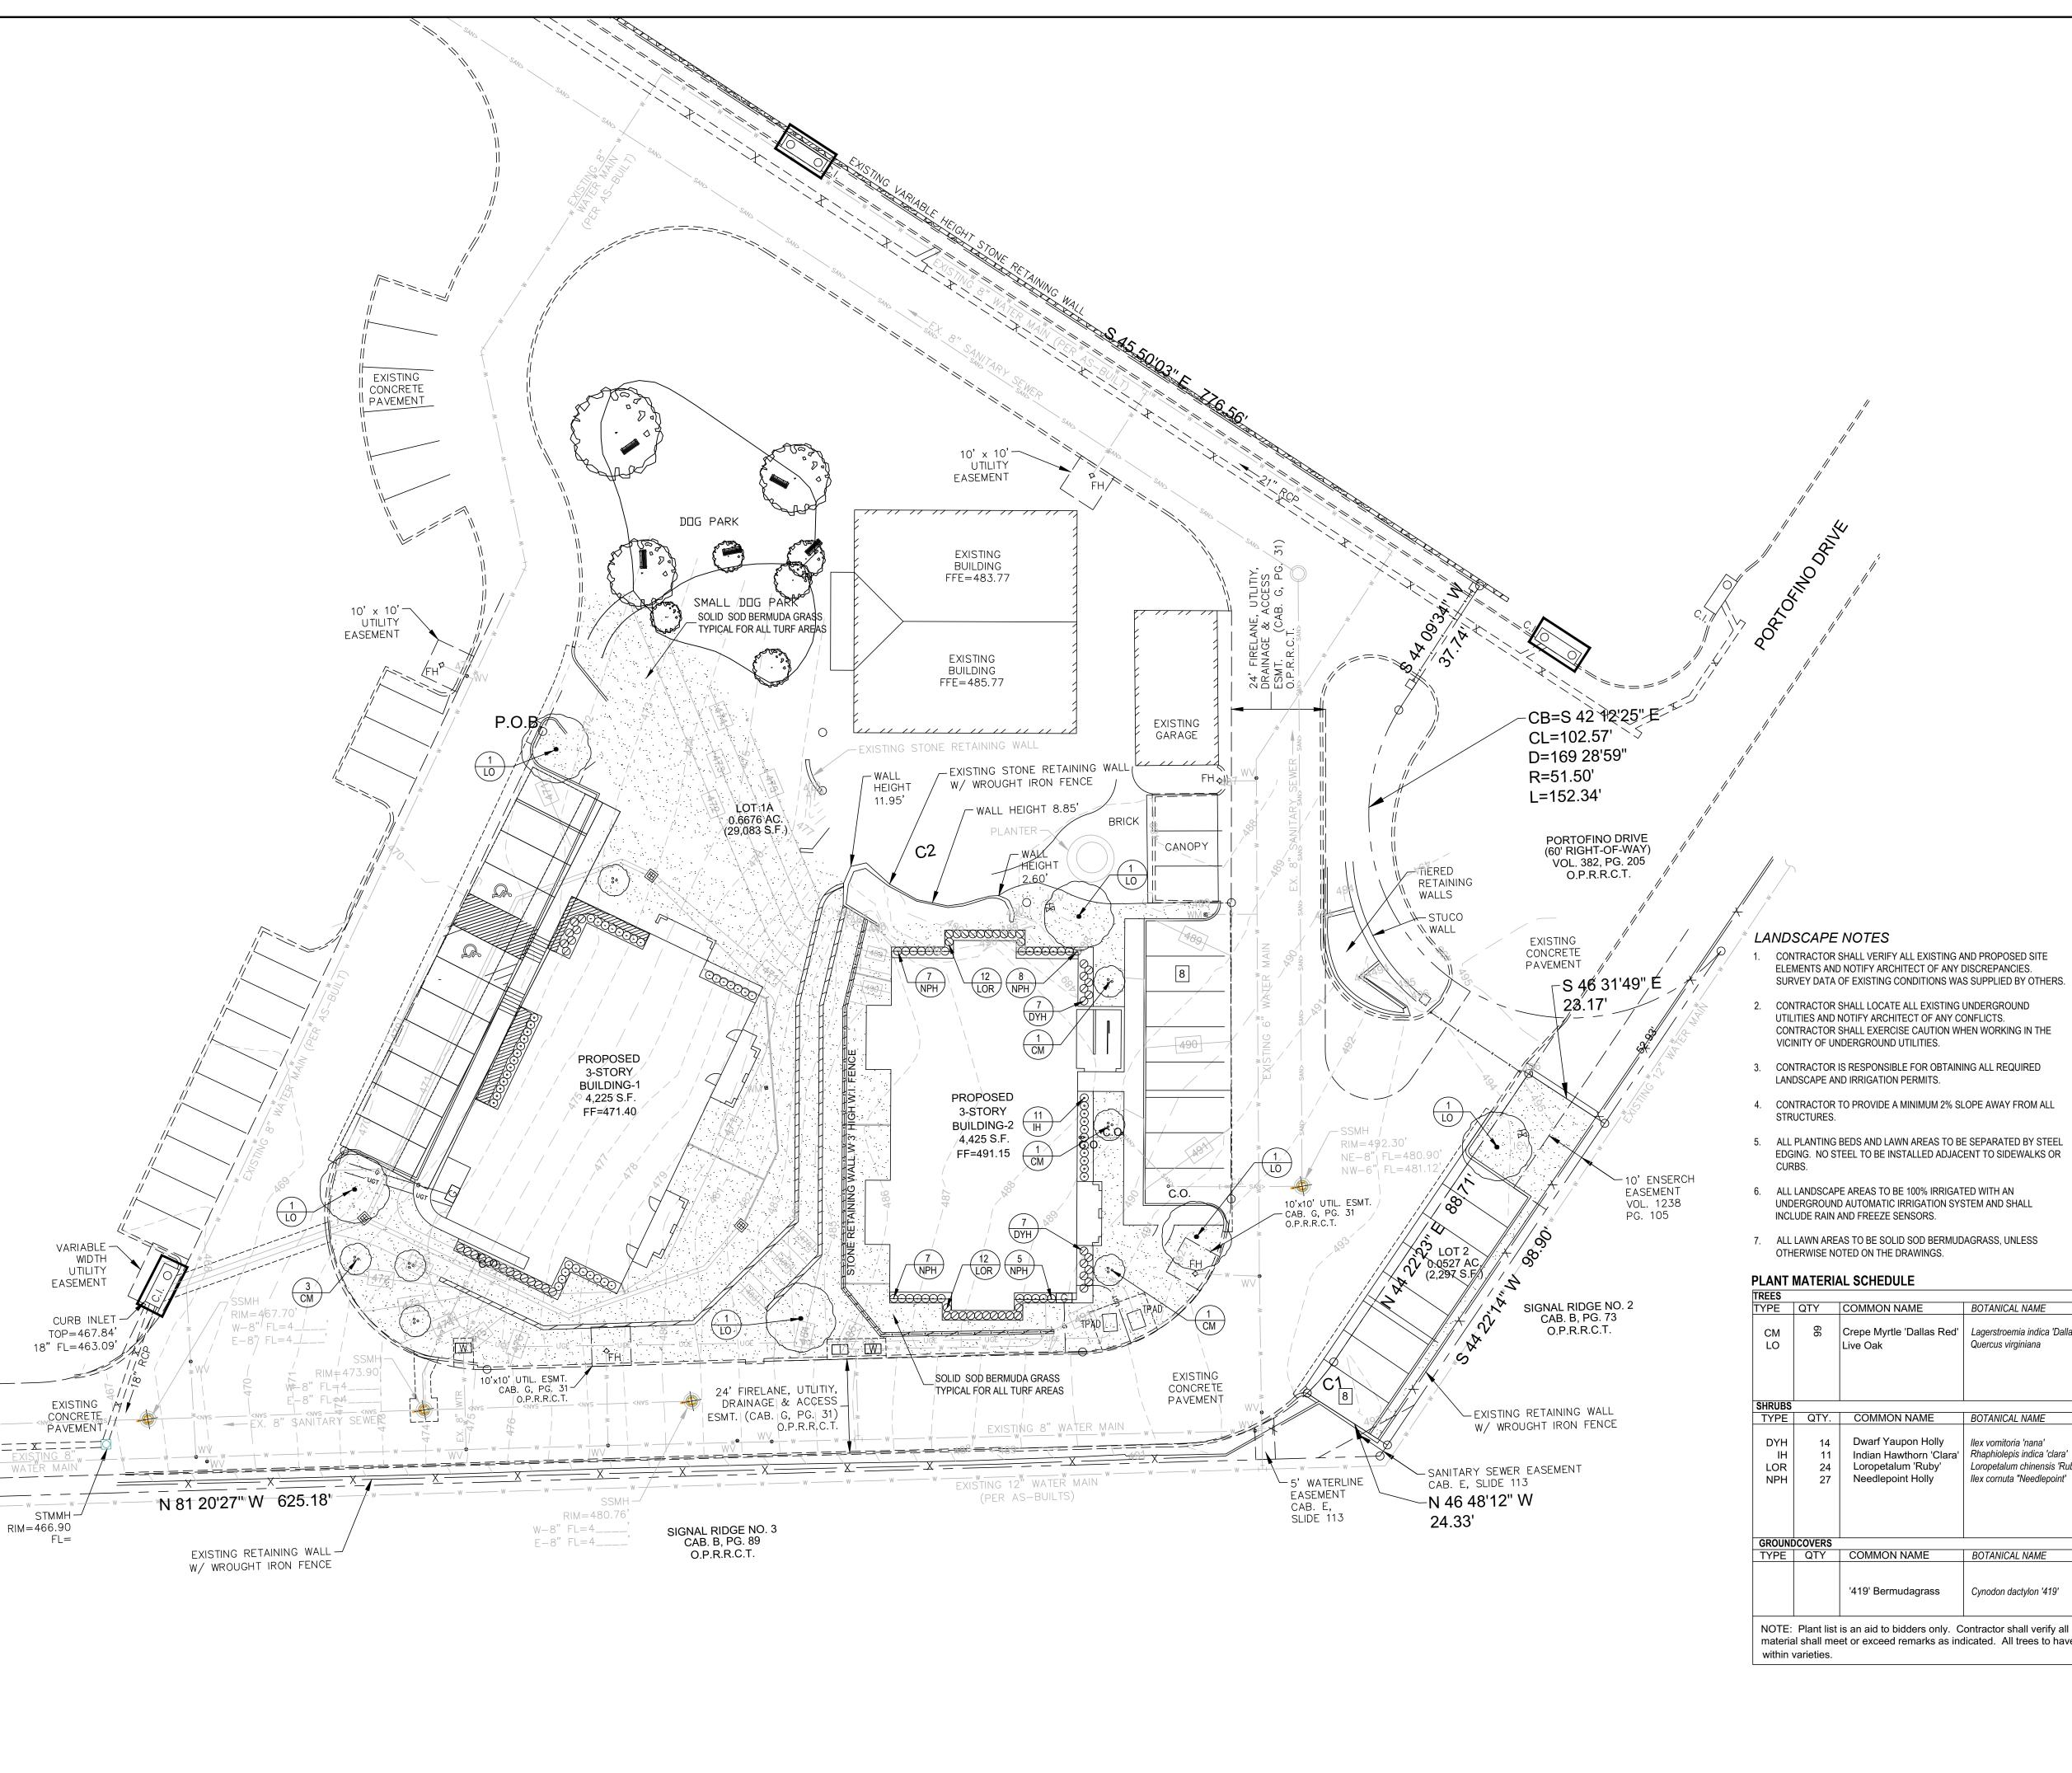

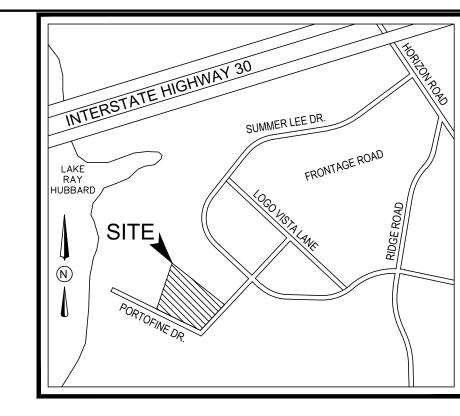

#### **VICINITY MAP**

#### GENERAL LAWN NOTES

- 1. FINE GRADE AREAS TO ACHIEVE FINAL CONTOURS INDICATED ON CIVIL
- ADJUST CONTOURS TO ACHIEVE POSITIVE DRAINAGE AWAY FROM BUILDINGS. PROVIDE UNIFORM ROUNDING AT TOP AND BOTTOM OF SLOPES AND OTHER BREAKS IN GRADE. CORRECT IRREGULARITIES AND AREAS WHERE WATER MAY STAND.
- 3. ALL LAWN AREAS TO RECEIVE SOLID SOD SHALL BE LEFT IN A MAXIMUM OF 1" BELOW FINAL FINISH GRADE. CONTRACTOR TO COORDINATE OPERATIONS WITH ON-SITE CONSTRUCTION MANAGER.
- IMPORTED TOPSOIL SHALL BE NATURAL, FRIABLE SOIL FROM THE REGION, KNOWN AS BOTTOM AND SOIL, FREE FROM LUMPS, CLAY, TOXIC SUBSTANCES, ROOTS, DEBRIS, VEGETATION, STONES, CONTAINING NO SALT AND BLACK TO BROWN IN COLOR.
- ALL LAWN AREAS TO BE FINE GRADED, IRRIGATION TRENCHES COMPLETELY SETTLED, AND FINISH GRADE APPROVED BY THE OWNER'S CONSTRUCTION MANAGER OR ARCHITECT PRIOR TO INSTALLATION.
- ALL ROCKS 3/4" DIAMETER AND LARGER, DIRT CLODS, STICKS, CONCRETE SPOILS, ETC. SHALL BE REMOVED PRIOR TO PLACING TOPSOIL AND ANY LAWN INSTALLATION
- 7. CONTRACTOR SHALL PROVIDE (1") ONE INCH OF IMPORTED TOPSOIL ON ALL AREAS TO RECEIVE LAWN.

#### SOLID SOD NOTES

- FINE GRADE AREAS TO ACHIEVE FINAL CONTOURS INDICATED. LEAVE AREAS TO RECEIVE TOPSOIL 3" BELOW FINAL DESIRED GRADE IN PLANTING AREAS AND 1" BELOW FINAL GRADE IN TURF
- ADJUST CONTOURS TO ACHIEVE POSITIVE DRAINAGE AWAY FROM BUILDINGS. PROVIDE UNIFORM ROUNDING AT TOP AND BOTTOM OF SLOPES AND OTHER BREAKS IN GRADE. CORRECT IRREGULARITIES AND AREAS WHERE WATER MAY STAND.
- 3. ALL LAWN AREAS TO RECEIVE SOLID SOD SHALL BE LEFT IN A MAXIMUM OF 1" BELOW FINAL FINISH GRADE. CONTRACTOR TO COORDINATE OPERATIONS WITH ON-SITE CONSTRUCTION
- CONTRACTOR TO COORDINATE WITH ON-SITE CONSTRUCTION MANAGER FOR AVAILABILITY OF EXISTING TOPSOIL.
- PLANT SOD BY HAND TO COVER INDICATED AREA COMPLETELY. INSURE EDGES OF SOD ARE TOUCHING. TOP DRESS JOINTS BY HAND WITH TOPSOIL TO FILL VOIDS.
- ROLL GRASS AREAS TO ACHIEVE A SMOOTH, EVEN SURFACE, FREE FROM UNNATURAL UNDULATIONS.
- WATER SOD THOROUGHLY AS SOD OPERATION PROGRESSES.
- CONTRACTOR SHALL MAINTAIN ALL LAWN AREAS UNTIL FINAL ACCEPTANCE. THIS SHALL INCLUDE, BUT NOT LIMITED TO: MOWING, WATERING, WEEDING, CULTIVATING, CLEANING AND REPLACING DEAD OR BARE AREAS TO KEEP PLANTS IN A VIGOROUS, HEALTHY CONDITION.
- CONTRACTOR SHALL GUARANTEE ESTABLISHMENT OF AN ACCEPTABLE TURF AREA AND SHALL PROVIDE REPLACEMENT FROM LOCAL SUPPLY IF NECESSARY.
- IF INSTALLATION OCCURS BETWEEN SEPTEMBER 1 AND MARCH 1, ALL SOD AREAS TO BE OVER-SEEDED WITH WINTER RYEGRASS, AT A RATE OF (4) POUNDS PER ONE THOUSAND (1000) SQUARE FEET.

NT	<b>MATERIAL</b>	SCHEDULE

YPE	QTY	COMMON NAME	BOTANICAL NAME	SIZE	REMARKS
CM LO	66	Crepe Myrtle 'Dallas Red' Live Oak	Lagerstroemia indica 'Dallas Red' Quercus virginiana	6' ht. 3" cal.	container, 3 or 5 trunks, 4' spread min.,tree forr container, 13' ht., 5' spread, 5' clear straight tru k
SHRUBS					
TYPE	QTY.	COMMON NAME	BOTANICAL NAME	SIZE	REMARKS
DYH IH LOR NPH	14 11 24 27	Dwarf Yaupon Holly Indian Hawthorn 'Clara' Loropetalum 'Ruby' Needlepoint Holly	llex vomitoria 'nana' Rhaphiolepis indica 'clara' Loropetalum chinensis 'Ruby' llex cornuta "Needlepoint'	5 gal. 5 gal. 5 gal. 5 gal.	container, 18" ht., 18" spread container, 20" ht., 20" spread container, 20" ht., 20" spread container , 24" ht., 20" spread
GROUNE	COVERS				
TYPE	QTY	COMMON NAME	BOTANICAL NAME	SIZE	REMARKS
		'419' Bermudagrass	Cynodon dactylon '419'		Solid Sod refer to notes

LANDSCAPE ARCHITECT STUDIO GREEN SPOT, INC 1784 W. McDERMOTT DR. SUITE 110 ALLEN, TEXAS 75013 (469) 369-4448 CHRIS@STUDIOGREENSPOT



# $\mathbf{\Omega}$ $\mathbf{\Omega}$ AKE GE Ш

'ATER'

DRIVE TEXAS

<u>N</u>

ISSUE: FOR APPROVAL 11.21.2019

DATE: 11.21.2019

SHEET NAME: LANDSCAPE PLAN

SHEET NUMBER:

#### SECTION 02900 - LANDSCAPE

#### PART 1 - GENERAL

#### REFERENCED DOCUMENTS

Refer to bidding requirements, special provisions, and schedules for additional requirements.

#### DESCRIPTION OF WORK

Work included: Furnish all supervision, labor, materials, services, equipment and appliances required to complete the work covered in conjunction with the landscaping covered in these specifications and landscaping plans, including:

- Planting (trees, shrubs, and grass)
- Bed preparation and fertilization Notification of sources
- Water and Maintenance until final acceptance Guarantee

#### REFERENCE STANDARDS

ART 3 - EXECUTION

C. Grass Areas:

INSTALLATION

materials.

**BED PREPARATION & FERTILIZATION** 

All planting areas shall be conditioned as follows:

batter board against the bed areas.

- American Standard for Nursery Stock published by American Association of Nurserymen. 27 October 1980, Edition; by American National Standards Institute, Inc. (Z60.1) – plant
- American Joint Committee on Horticultural Nomenclature: 1942 Edition of Standardized
- Texas Association of Nurserymen, Grades and Standards.
- Hortis Third, 1976 Cornell University

#### NOTIFICATION OF SOURCES AND SUBMITTALS

- The Contractor shall, within ten (10) days following acceptance of bid, notify the Architect/Owner of the sources of plant materials and bed preparation required for the
- Samples: Provide representative quantities of sandy loam soil, mulch, bed mix material, gravel, and crushed stone. Samples shall be approved by Architect before use on
- Product Data: Submit complete product data and specifications on all other specified
- Submit three representative samples of each variety of ornamental trees, shrubs, and groundcover plants for Architect's approval. When approved, tag, install, and maintain as representative samples for final installed plant materials.
- File Certificates of Inspection of plant material by state, county, and federal authorities with Architect, if required

Landscape Contractor to inspect all existing conditions and report any deficiencies to the

Prepare new planting beds by scraping away existing grass and weeds as necessary.

Till existing soil to a depth of six (6") inches prior to placing compost and fertilizer.

compost and till into a depth of six (6") inches of the topsoil. Apply organic fertilizer

such as Sustane or Green Sense at the rate of twenty (20) pounds per one thousand

Apply fertilizer as per manufacturers recommendations. Add six (6") inches of

3. Backfill for tree pits shall be as follows: Use existing top soil on site (use imported

1. Areas to be Solid Sod Bermudagrass: Blocks of sod should be laid joint to joint,

topsoil where they are evidently gaped open, then watered thoroughly.

topsoil as needed) free from large clumps, rocks, debris, caliche, subsoils, etc.,

(staggered joints) after fertilizing the ground first. Roll grass areas to achieve a smooth, even surface. The joints between the blocks of sod should be filled with

2. Areas to be Hydromulch Common Bermudagrass: Hydromulch with bermudagrass

Maintenance of plant materials shall begin immediately after each plant is delivered to the

Plant materials shall be delivered to the site only after the beds are prepared and area

ready for planting. All shipments of nursery materials shall be thoroughly protected from

the drying winds during transit. All plants which cannot be planted at once, after delivery

to the site, shall be well protected against the possibility of drying by wind and sun. Balls

of earth of B & B plants shall be kept covered with soil or other acceptable material. All

Notify the Landscape Architect for inspection and approval of all positioning of plant

Excavate pits with vertical sides and horizontal bottom. Tree pits shall be large enough to

permit handling and planting without injury to balls of earth or roots and shall be of such

depth that, when planted and settled, the crown of the plant shall bear the same

relationship to the finish grade as it did to soil surface in original place of growth.

plants remain the property of the Contractor until final acceptance.

Position the trees and shrubs in their intended location as per plan

site and shall continue until all construction has been satisfactorily accomplished.

seed at a rate of two (2) pounds per one thousand (1,000) square feet. Use a 4' x 8'

All planting areas shall receive a two (2") inch layer of specified mulch.

placed in nine (9") inch layers and watered in thoroughly.

F. Soil Analysis: Provide sandy loam soil analysis if requested by the Architect.

#### JOB CONDITIONS

- General Contractor to complete the following punch list: Prior to Landscape Contractor initiating any portion of landscape installation, General Contractor shall leave planting bed areas three (3") inches below finish grade of sidewalks, drives and curbs as shown on the drawings. All lawn areas to receive solid sod shall be left one (1") inch below the finish grade of sidewalks, drives, and curbs. All construction debris shall be removed prior to Landscape Contractor beginning any work.
- B. General Contractor shall provide topsoil as described in Section 02200 Earthwork.
- Storage of materials and equipment at the job site will be at the risk of the Landscape Contractor. The Owner cannot be held responsible for theft or damage.

#### MAINTENANCE AND GUARANTEE

#### Maintenance:

- 1. The Landscape Contractor will be held responsible for the maintenance of all work from the time of planting until final acceptance by the Owner. No trees, shrubs, groundcover or grass will be accepted unless they show a healthy growth and
- satisfactory foliage conditions. Maintenance shall include watering of trees and plants, cultivation, weeding spraying, edging, pruning of trees, mowing of grass, cleaning up and all other work necessary of maintenance.
- 3. A written notice requesting final inspection and acceptance should be submitted to the Owner at least seven (7) days prior to completion. An on-site inspection by
- Owner and Landscape Contractor will be completed prior to written acceptance. 4. After final acceptance of installation, the Landscape Contractor will not be required to do any of the above listed work.

#### B. Guarantee:

- 1. Trees shall be guaranteed for a twelve (12) month period after acceptance. Shrubs and groundcover shall be guaranteed for twelve (12) months. The Contractor shall replace all dead materials as soon as weather permits and upon notification of the Owner. Plants, including trees, which have partially died so that shape, size, or symmetry has been damaged, shall be considered subject to replacement. In such
- cases, the opinion of the Owner shall be final. a. Plants used for replacement shall be of the same size and kind as those originally planted and shall be planted as originally specified. All work, including materials, labor and equipment used in replacements, shall carry a twelve (12) month guarantee. Any damage, including ruts in lawn or bed areas, incurred as a result of making replacements shall be immediately
- b. At the direction of the Owner, plants may be replaced at the start of the next year's planting season. In such cases, dead plants shall be removed from the
- premises immediately. c. When plant replacements are made, plants, soil mix, fertilizer and mulch are to be utilized as originally specified and reinspected for full compliance with Contract requirements. All replacements are to be included under "Work" of this section.

Shrub and tree pits shall be no less than two (2') feet, twenty-four (24") inches, wider than

the lateral dimension of earth ball and six (6") inches deeper than it's vertical dimension.

Remove and haul from site all rocks and stones over one (1") inch in diameter. Plants

Dig a wide, rough sided hole exactly the same depth as the height of the ball, especially a

Percolation Test: Fill the hole with water. If the water level does not percolate within 24

Backfill only with 5 parts existing soil or sandy loam and 1 part bed preparation. When

the hole is dug in solid rock, topsoil from the same area should not be used. Carefully

as well as all nylon, plastic string and wire mesh. Container trees will usually be pot

settle by watering to prevent air pockets. Remove the burlap from the top 1/3 of the ball.

Mulch the top of the ball. Do not plant grass all the way to the trunk of the tree. Leave the

area above the top of the ball and mulch with at least two (2") inches of specified mulch.

Obstruction below ground: In the event that rock, or underground construction work or

section, alternate locations may be selected by the Owner. Where locations cannot be

properly set at the required grade. The work of this section shall include the removal from

obstructions are encountered in any plant pit excavation work to be done under this

changed, the obstructions shall be removed to a depth of not less than three (3') feet

below grade and no less than six (6") inches below the bottom of ball when plant is

the site of such rock or underground obstructions encountered at the cost of the

Trees and large shrubs shall be staked as site conditions require. Position stakes to

tipping of the branched is not permitted. Do not cut terminal branches.

3. Cut steel edging at 45 degree angle where edging meets sidewalk.

END OF SECTION

areas clean by sweeping or hosing at end of each days work.

Pruning and Mulching: Pruning shall be directed by the Architect and shall be pruned in

accordance with standard horticultural practice following Fine Pruning, Class I pruning

1. Dead wood or suckers and broken badly bruised branches shall be removed. General

Immediately after planting operations are completed, all tree pits shall be covered with

a layer of organic material two (2") inches in depth. This limit of the organic material

1. Curbing shall be aligned as indicated on plans. Stake out limits of steel curbing and

. Stakes are to be installed on the planting bed side of the curbing, as opposed to the

Cleanup: During the work, the premises shall be kept neat and orderly at all times. Storage areas for all materials shall be so organized that they, too, are neat and orderly. All trash and debris shall be removed from the site as work progresses. Keep paved

All plant beds and trees to be mulched with a minimum settled thickness of two (2")

stand pipe per tree planting detail as approved by the Landscape Architect

hours, the tree needs to move to another location or have drainage added. Install a PVC

the surface of the ground. The sides of the hole should be rough and jagged, never slick

should be thoroughly moist before removing containers.

bound, if so follow standard nursery practice of 'root scoring'.

J. Do not wrap trees.

K. Do not over prune.

inches over the entire bed or pit.

secure tree against seasonal prevailing winds.

standards provided by National Arborist Association.

Pruning shall be done with clean, sharp tools.

obtain Owners approval prior to installation. All steel curbing shall be free of kinks and abrupt bends. Top of curbing shall be 3/4" maximum height above grade.

Do not install steel edging along sidewalks.

Steel Curbing Installation:

CLEANUP AND ACCEPTANCE

Landscape Contractor.

- 2. The Owner agrees that for the guarantee to be effective, he will water plants at least twice a week during dry periods and cultivate beds once a month after final
- 3. The above guarantee shall not apply where plants die after acceptance because of injury from storms, hail, freeze, insects, diseases, injury by humans, machines or
- 4. Acceptance for all landscape work shall be given after final inspection by the Owner provided the job is in a completed, undamaged condition, and there is a stand of grass in all lawn areas. At this time, the Owner will assume maintenance on the accepted work.
- Repairs: Any necessary repairs under the Guarantee must be made within ten (10) days after receiving notice, weather permitting, and in the event the Landscape Contractor does not make repairs accordingly, the Owner, without further notice to Contractor, may provide materials and men to make such repairs at the expense of the Landscape

#### QUALITY ASSURANCE

Contractor.

- General: Comply with applicable Federal, State, County and Local regulations governing landscape materials and work
- Personnel: Employ only experienced personnel who are familiar with the required work. Provide full time supervision by a qualified foreman acceptable to Landscape Architect.
- Selection of Plant Material:
- 1. Make contact with suppliers immediately upon obtaining notice of contract acceptance to select and book materials. Develop a program of maintenance (pruning and fertilization) which will insure the purchased materials will meet and/or exceed project specifications
- 2. Landscape Architect will provide a key identifying each tree location on site. Written verification will be required to document material selection, source and delivery schedules to site.
- 3. Owner and/or Architect shall inspect all plant materials when reasonable at place of growth for compliance with requirements for genus, species, cultivar/variety, size and 4. Owner and/or Architect retains the right to further inspect all plant material upon arrival at the site and during installation for size and condition of root balls, limbs,
- branching habit, insects, injuries, and latent defects. 5. Owner and/or Architect may reject unsatisfactory or defective material at any time during the process of work. Remove rejected materials from the site immediately. Plants damaged in transit or at job site shall be rejected.

### PRODUCT DELIVERY, STORAGE AND HANDLING

#### Preparation:

- Balled and Burlapped (B&B) Plants: Dig and prepare shipment in a manner that will not damage roots, branches, shape, and future development.
- 2. Container Grown Plants: Deliver plants in rigid container to hold ball shape and

- 1. Deliver packaged materials in sealed containers showing weight, analysis and name of manufacturer. Protect materials from deterioration during delivery and while stored
- 2. Deliver only plant materials that can be planted in one day unless adequate storage and watering facilities are available on job site.
- 3. Protect root balls by heeling in with sawdust or other approved moisture retaining material if not planted within 24 hours of delivery.
- 4. Protect plants during delivery to prevent damage to root balls or desiccation of leaves. Keep plants moist at all times. Cover all materials during transport.
- 5. Notify Architect of delivery schedule 72 hours in advance so plant material may be observed upon arrival at job site. 6. Remove rejected plant material immediately from site.
- 7. To avoid damage or stress, do not lift, move, adjust to plumb, or otherwise manipulate plants by trunk or stems.

#### PART 2 - PRODUCTS

#### 2.1 PLANTS

- General: Well-formed No. 1 grade or better nursery grown stock. Listed plant heights are from tops of root balls to nominal tops of plants. Plant spread refers to nominal outer width of the plant, not to the outer leaf tips. Plants will be individually approved by the Architect and his decision as to their acceptability shall be final.
- Quantities: The drawings and specifications are complimentary. Anything called for on one and not the other is as binding as if shown and called for on both. The plant schedule is an aid to bidders only. Confirm all quantities on plan.
- C. Quality and size: Plant materials shall conform to the size given on the plan, and shall be healthy, symmetrical, well-shaped, full branched, and well rooted. The plants shall be free from injurious insects, diseases, injuries to the bark or roots, broken branches, objectionable disfigurements, insect eggs and larvae and are to be of specimen quality.
- Approval: All plant materials shall be subject to the approval of the Owner. All plants which are found unsuitable in growth, or in any unhealthy, badly shaped, or undersized condition, will be rejected by the Landscape Architect, either before or after planting, and shall be removed at the expense of the Landscape Contractor and replaced with acceptable plants as specified.
- Trees shall be healthy, full-branched, well-shaped and shall meet the trunk diameter and height requirements of the plant schedule. Balls shall be firm, neat, slightly tapered, and well wrapped in burlap. Any tree loose in the ball or with broken ball at time of planting will be rejected. Balls shall be ten (10") inched in diameter for each one (1") inch of trunk diameter, Measured six (6") inched above ball. Nomenclature conforms to the customary nursery usage: for clarification, the term "multi-trunk" defines a plant having three (3) or more trunks of nearly equal diameter
- Pruning: All pruning of trees and shrubs, as directed by the Landscape Architect, shall be executed by the Landscape Contractor at no additional cost to the Owner

A = ROW SPACING

B = ON CENTER SPACING

INDICATED ON PLANT LIST

MULCH IN BED PRIOR TO

SPACE PLANTS IN A TRIANGULAR

PATTERNAS SHOWN, SPACED EQUALLY FROM EACHOTHER AT SPACING

2" MULCH DOUBLE SHREDDED HARDWOOD

PLANTING GROUNDCOVER/ANNUALS.

PREPARE GROUNDCOVER

BED BY TILLING ENTIRE BED-

AREA. PROVIDE SOIL MIX

AS DEFINED IN THE LANDSCAPE

#### 2.2 SOIL PREPARATION MATERIALS

- A. Sandy Loam:
- 1. Friable, fertile, dark, loamy soil, free of clay lumps, subsoil, stones and other extraneous material and reasonably free of weeds and foreign grasses. Loam
- containing Dallasgrass or Nutgrass shall be rejected. 2. Physical properties as follows: Clay - between 7-27 percent Silt – between 15-25 percent
- Sand less than 52 percent
- Organic matter shall be 3%-10% of total dry weight. 4. If requested, provide a certified soil analysis conducted by an approved soil testing laboratory verifying that sandy loam meets the above requirements.
- Organic Material: Compost with a mixture of 80% vegetative matter and 20% animal
- waste. Ingredients should be a mix of course and fine textured material.


Gro Municipal Mix as supplied by Soil Building Systems, Dallas, Texas or approved equal.


Mulch: Double Shredded Hardwood Mulch, partially decomposed, dark brown. Living


- Premixed Bedding Soil as supplied by Vital Earth Resources, Gladewater, Texas; Professional Bedding Soil as supplied by Living Earth Technology, Dallas, Texas or Acid
- D. Sharp Sand: Sharp sand must be free of seeds, soil particles and weeds.
- Earth Technologies or approved equal.
- Organic Fertilizer: Fertilaid, Sustane, or Green Sense or equal as recommended for required applications. Fertilizer shall be delivered to the site in original unopened containers, each bearing the manufacturer's guaranteed statement of analysis.
- Commercial Fertilizer: 10-20-10 or similar analysis. Nitrogen source to be a minimum 50% slow release organic Nitrogen (SCU or UF) with a minimum 8% sulphur and 4% iron, plus micronutrients.
- B. Peat: Commercial sphagnum peat moss or partially decomposed shredded pine bark or other approved organic material.

#### MISCELLANEOUS MATERIALS

- A. Steel Edging: Shall be Ryerson "Estate Curbing", 1/8" x 4" with stakes 4' on center.
- B. Staking Material for Shade Trees:
- 1. Post: Studded T-Post, #1 Armco with anchor plate; 6'-0" length; paint green. 2. Wire: 12 gauge, single strand, galvanized wire. 3. Rubber hose: 2 ply, fiber reinforced hose, minimum ½ inch inside diameter. Color:
- Gravel: Washed native pea gravel, graded 1 in. to 1-1/2 in.
- Filter Fabric: Mirafi 140N by Celanese Fibers Marketing Company, available at Loftland Co., (214) 631-5250 or approved equal.

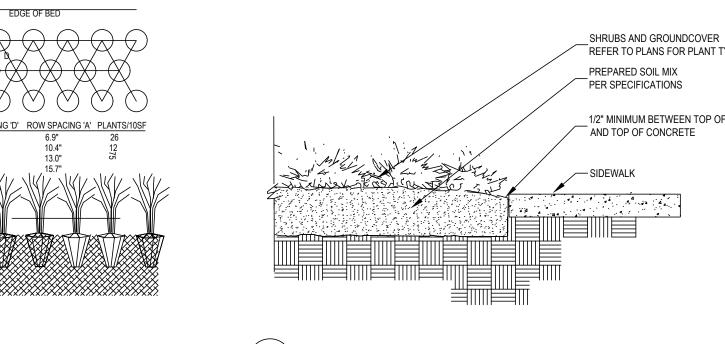

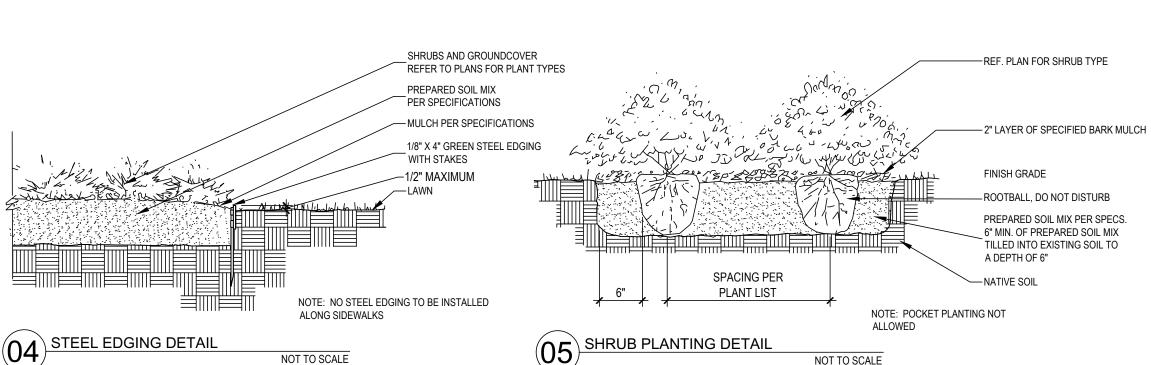

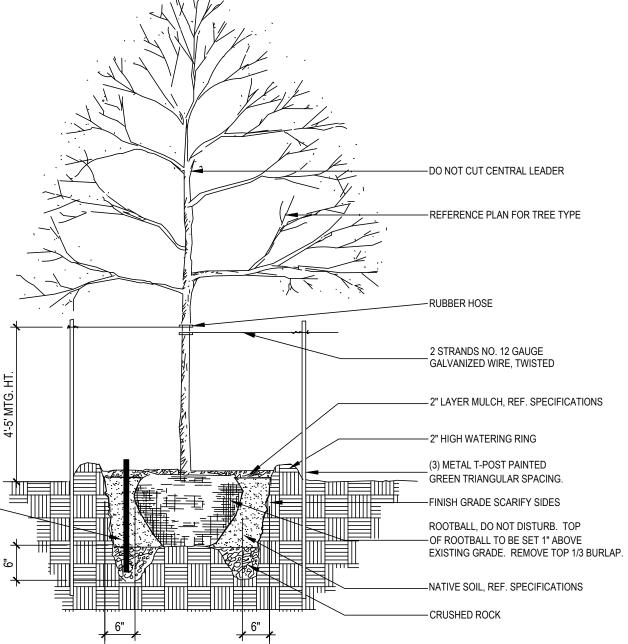

NOTE: LOCATE STAKES OUTSIDE

PREVAILING WINDS.

OF TREE WELL. POSITION STAKES

TO SECURE TREE AGAINST SEASONAL

4" DIA. PERFORATED PVC PIPE W/ CAP -PAINTED BLACK

> OF ROOTBALL TREE PLANTING DETAIL NOT TO SCALE

# SHRUBS AND GROUNDCOVER REFER TO PLANS FOR PLANT TYPES 1/2" MINIMUM BETWEEN TOP OF MULCH 03) SIDEWALK / MULCH DETAIL

NOT TO SCALE

ISSUE:

 $\geq$ 

11.21.2019

LANDSCAPE SPECIFICATIONS

SHEET NUMBER

4  $\mathbf{\Omega}$  $\mathbf{\omega}$ 5 4 C Ш

DRIVI TEXA O O

LANDSCAPE ARCHITECT

STUDIO GREEN SPOT, INC

1784 W. McDERMOTT DR.

SUITE 110

ALLEN, TEXAS 75013


(469) 369-4448

CHRIS@STUDIOGREENSPOT.

**ATE** 

FOR APPROVAL 11.21.2019

SHEET NAME:

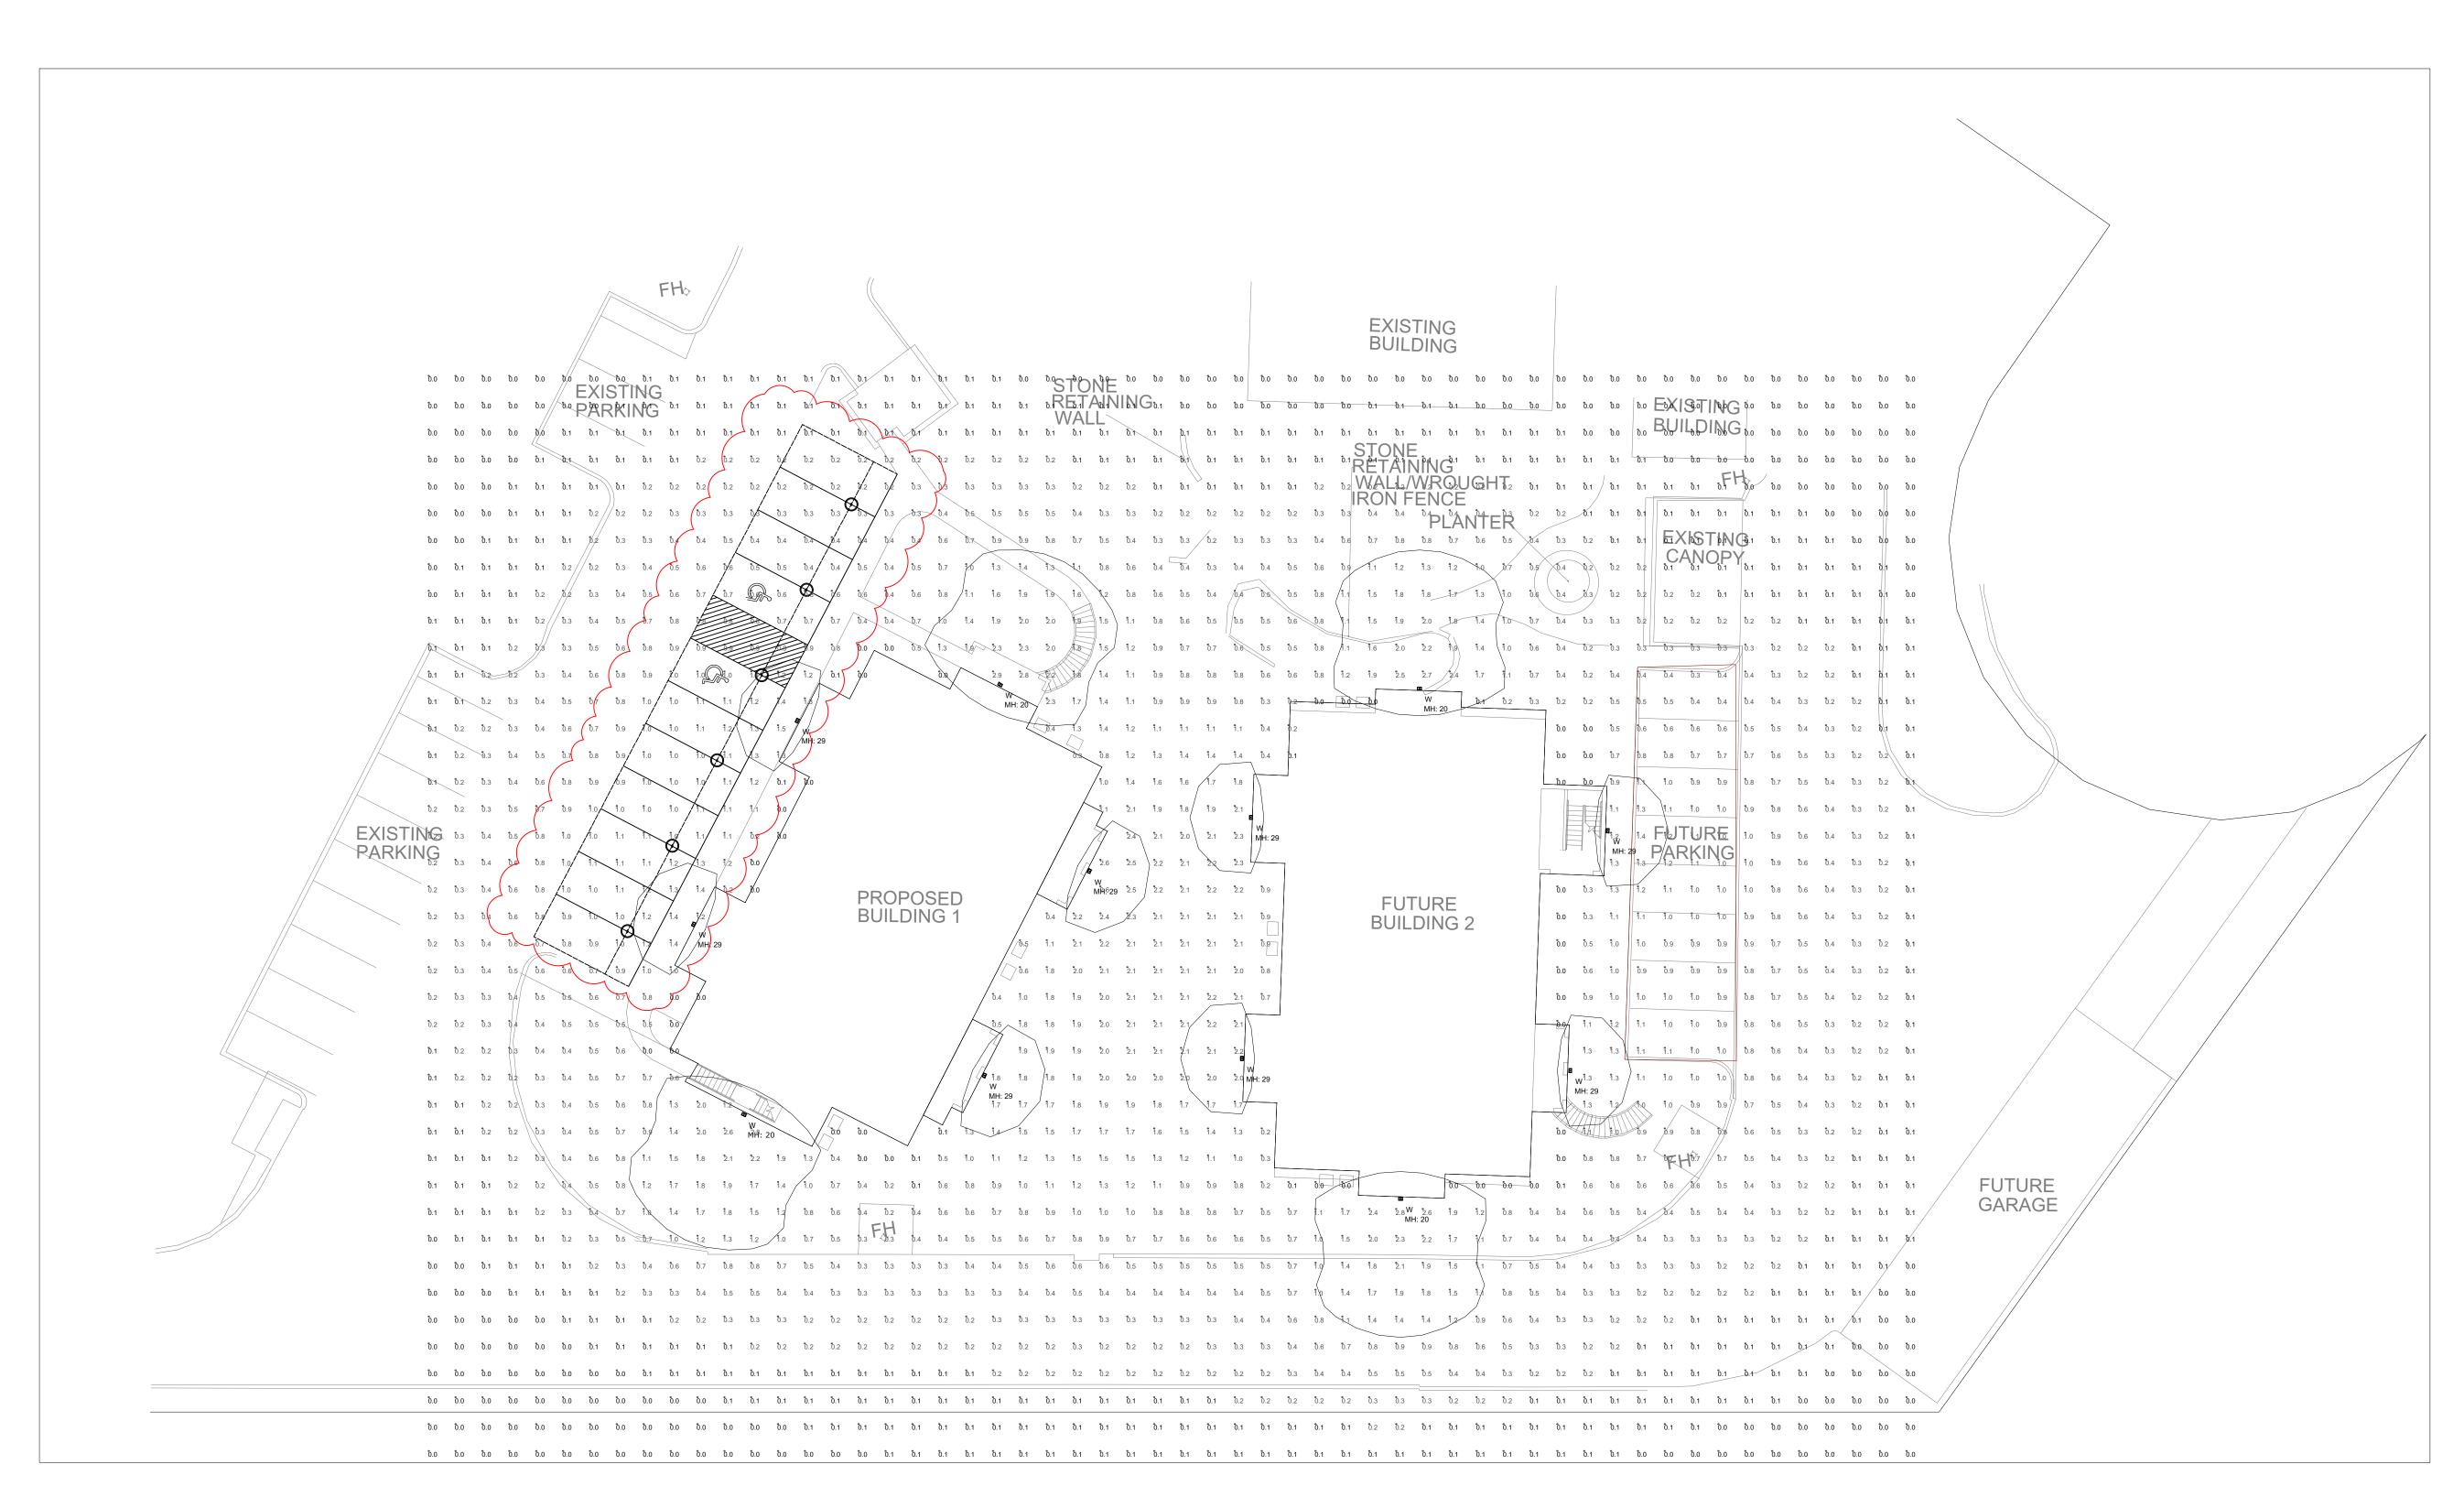

Luminair	inaire Schedule							
Symbol	Type	Qty	Manufacturer / Catalog Number	Total Lumen Output	Total Input Watts	Ballast Factor	Light Lost Factor	User Defined Factor
•	W	12	LITHONIA WDGE2 LED P3 40K 80CRI VW VOLTAGE MOUNTING FINISH	3214	22.55	1.000	0.808	1.000
<b>O</b>		6	LUXRITE LED Canopy Light LED 28W 3CCT 3000K	3360	28		0.70	1.000

Calculation Grid Location	Calc. Height (Ft.)	Units	Avg	Max	Min	Avg/Min
GRADE_Planar	0	Fc	0.53	2.9	0.0	N.A.
PARKING1		Fc	0.83	1.4	0.1	8.30
PARKING2		Fc	0.90	1.4	0.3	3.00

Illuminance (Fc)
Average = 0.83
Maximum = 1.4
Minimum = 0.1
Avg/Min Ratio = 8.30
Max/Min Ratio = 14.00

PARKING1

Illuminance (Fc)
Average = 0.90
Maximum = 1.4
Minimum = 0.3
Avg/Min Ratio = 3.00
Max/Min Ratio = 4.67

PARKING2

