

Platting Application Fees:

[] Master Plat (\$100.00 + \$15.00 Acre) 1

[] Final Plat (\$300.00 + \$20.00 Acre) 1

[] Replat (\$300.00 + \$20.00 Acre) 1

[] Amending or Minor Plat (\$150.00)

Notary Public in and for the State of Texas

[] Preliminary Plat (\$200.00 + \$15.00 Acre) 1(200+36.42*15=\$746.30)

DEVELOPMENT APPLICATION

City of Rockwall Planning and Zoning Department 385 S. Goliad Street Rockwall, Texas 75087

PLANNING & ZONING CASE NO.	SP2023-002
NOTE: THE APPLICATION IS NOT CITY UNTIL THE PLANNING DIRE SIGNED BELOW.	CONSIDERED ACCEPTED BY THE CTOR AND CITY ENGINEER HAVE
DIRECTOR OF PLANNING:	
CITY ENGINEER:	

Zoning Application Fees:

Other Application Fees:

[] Zoning Change (\$200.00 + \$15.00 Acre) 1

[] Specific Use Permit (\$200.00 + \$15.00 Acre) 1


[] PD Development Plans (\$200.00 + \$15.00 Acre) 1

My Commission Expires

Please check the appropriate box below to indicate the type of development request [SELECT ONLY ONE BOX]:

[] Plat Reinstaten Site Plan Application [✓ Site Plan (\$250)	nent Request (\$100.00) on Fees: .00 + \$20.00 Acre) 1 250+20*33.921=\$928. Plan/Elevations/Landscaping Plan (\$100.00)	.42 Notes: 1: In determining t	ral (\$75.00) quest (\$100.00) he fee, please use the exact a For requests on less than one	acreage when mi acre, round up t	ultiplying by the o one (1) acre.
PROPERTY INFO	RMATION [PLEASE PRINT]				
Address	none				
Subdivision	Discovery Lakes, Phase 1		Lot	Block	
General Location	36.42 Acres out of the 307 Acre Tra	ct near the NE corner	of SH 276 and Roch	elle Road	
ZONING, SITE PL	AN AND PLATTING INFORMATION	[PLEASE PRINT]			
Current Zoning	PD-78	Current Use	None		
Proposed Zoning	PD-78	Proposed Use	Single Family	Residential	
Acreage	33.921 Lots [Curr	rent] 1	Lots [Propos	ed]	32
process, and failur OWNER/APPLICA	PLATS: By checking this box you acknowledge that of e to address any of staff's comments by the date prov ANT/AGENT INFORMATION [PLEASE PL SCOVERY Lakes, LLC./Discovery Lakes F	vided on the Development Cale RINT/CHECK THE PRIMARY CO	ndar will result in the denial	of your case. IRES ARE REQUI	
Contact Person	Nick DiGiuseppe	Contact Person	Cameron Slown		
Address	15400 Knoll Trail Drive	Address	825 Watters Cree	ek Blvd.	
	Suite 230		Suite M300		
City, State & Zip	Dallas, Texas 75248	City, State & Zip	Allen, Texas 750	13	
Phone	972-960-9941	Phone	817-889-5050		
E-Mail	southbrookinvestments@outlook.com	n E-Mail	cslown@tnpinc.c	om	
"I hereby certify that I am cover the cost of this appl	ed authority, on this day personally appeared and certified the following: the owner for the purpose of this application; all infolication, has been paid to the City of Rockwall on this (i.e. "City") is authorized and permitted to provide it	ormation submitted herein is tro the 15 day of Janua	ue and correct; and the appl	ication fee of \$_ By signing this g	\$928.42 , to
permitted to reproduce a information."	ny copyrighted information submitted in conjunction	with this application, if such re	production is associated or	in response to a	request for public
Given under my hand and		10 23		ALYSON D Notary Public, Si Comm, Expires	tate of Texas
	Owner's Signature	mour-	William .	Notary ID 13	0589228 (

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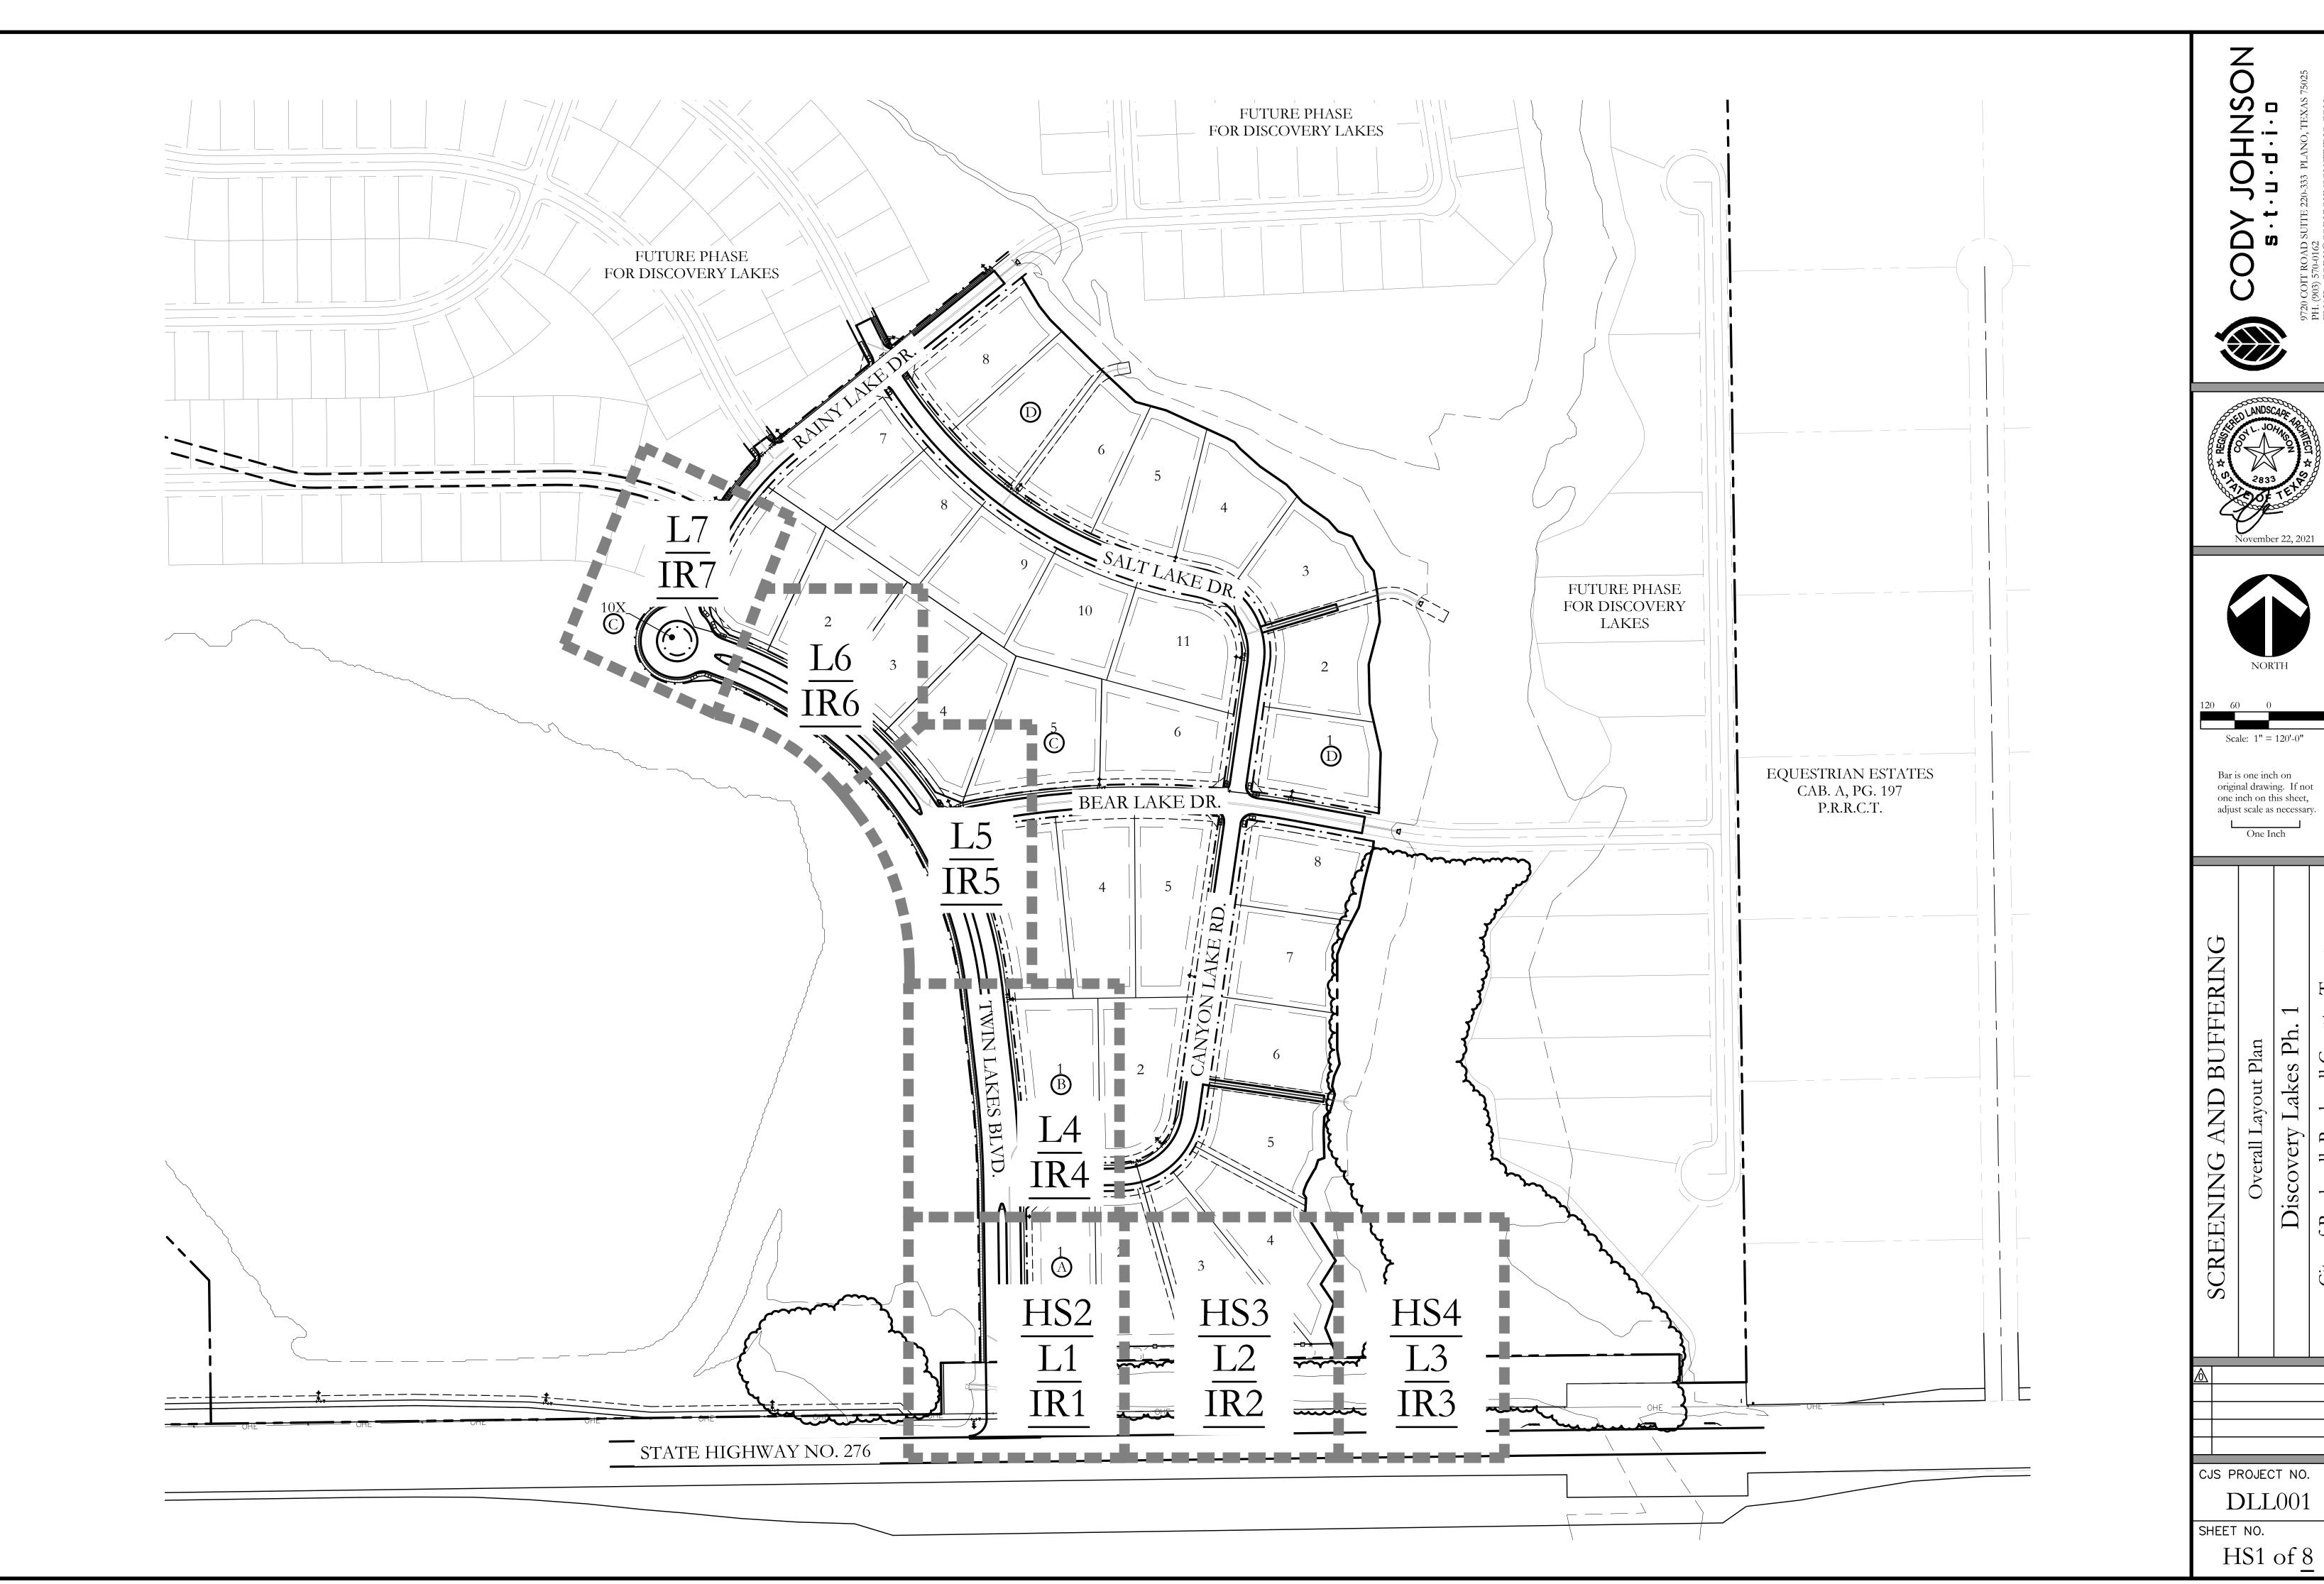


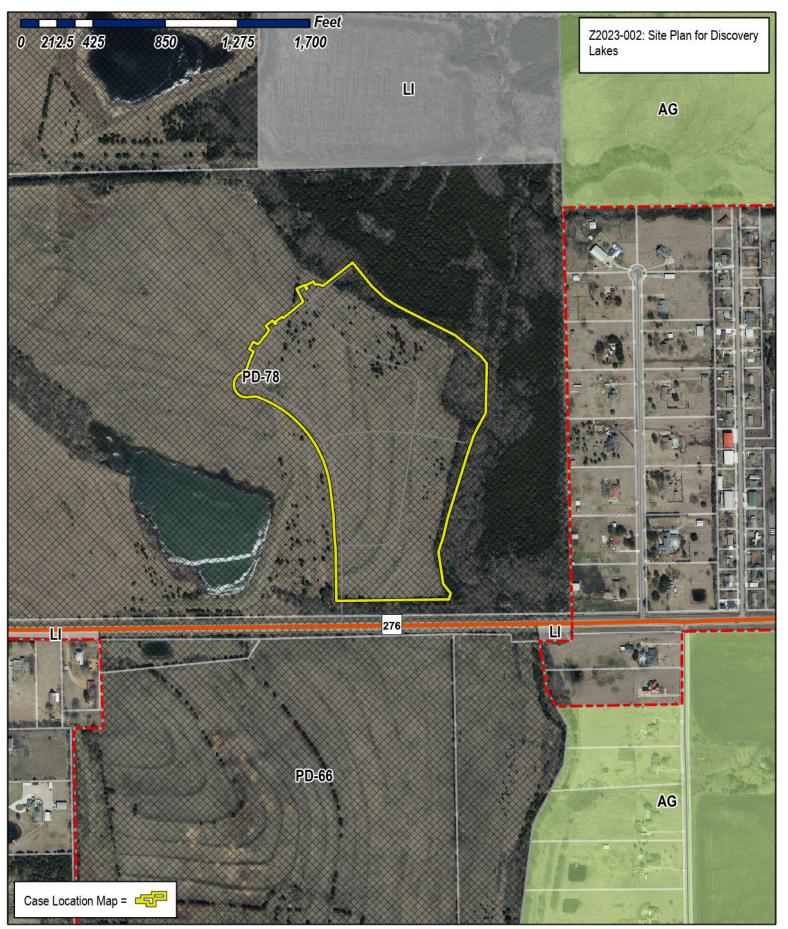


City of Rockwall

Planning & Zoning Department 385 S. Goliad Street Rockwall, Texas 75032 (P): (972) 771-7745 (W): www.rockwall.com The City of Rockwall GIS maps are continually under development and therefore subject to change without notice. While we endeavor to provide timely and accurate information, we make no guarantees. The City of Rockwall makes no warranty, express or implied, including warranties of merchantability and fitness for a particular purpose. Use of the information is the sole responsibility of








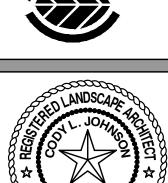






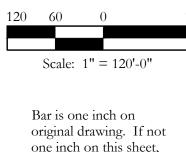


Bar is one inch on original drawing. If not one inch on this sheet, adjust scale as necessary.

Discovery Lakes Ph.

CJS PROJECT NO. DLL001

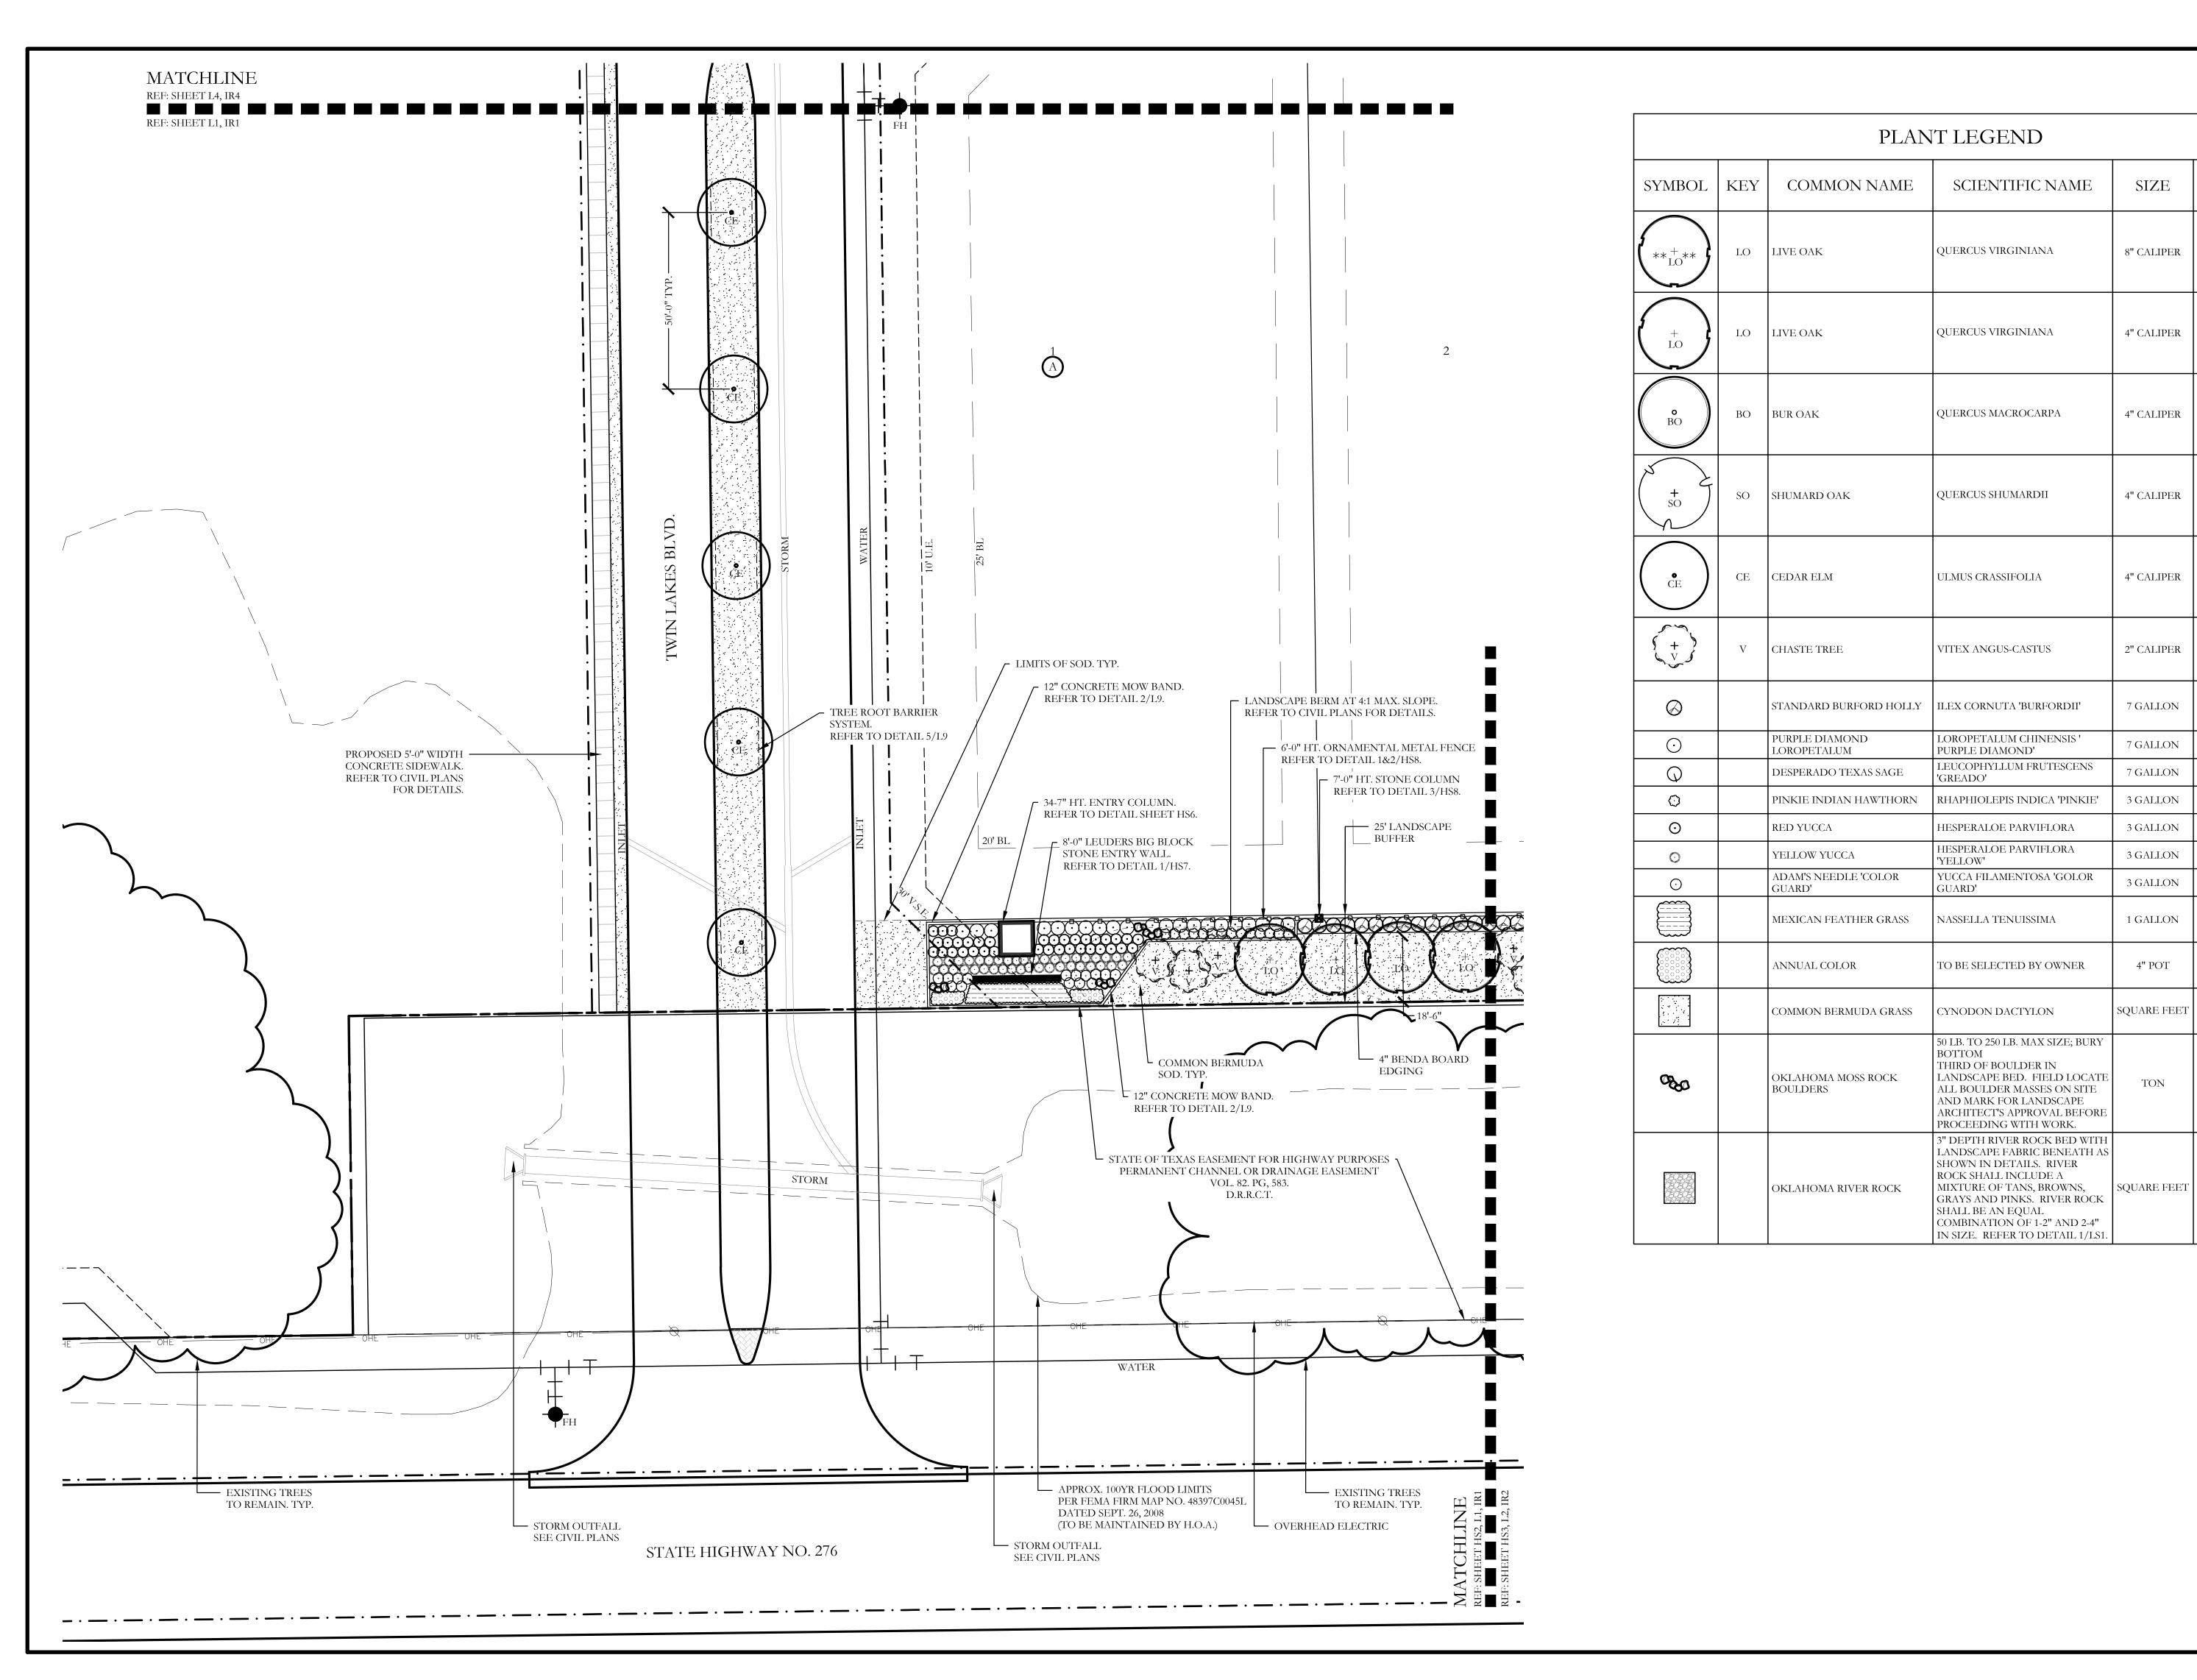

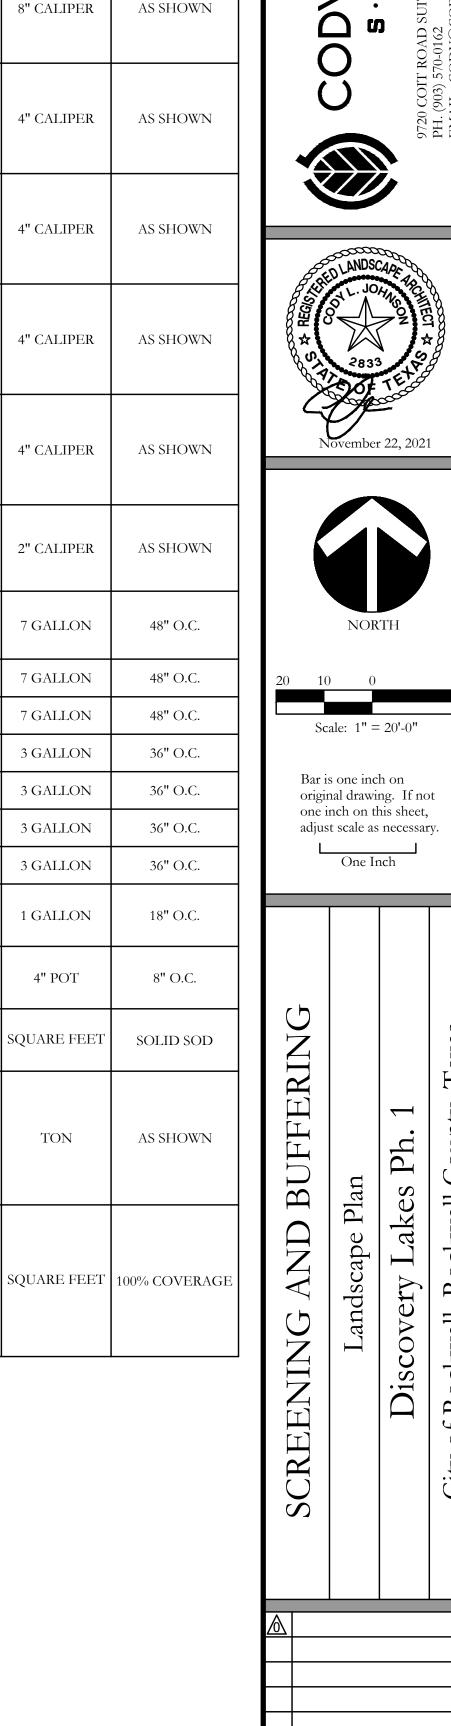


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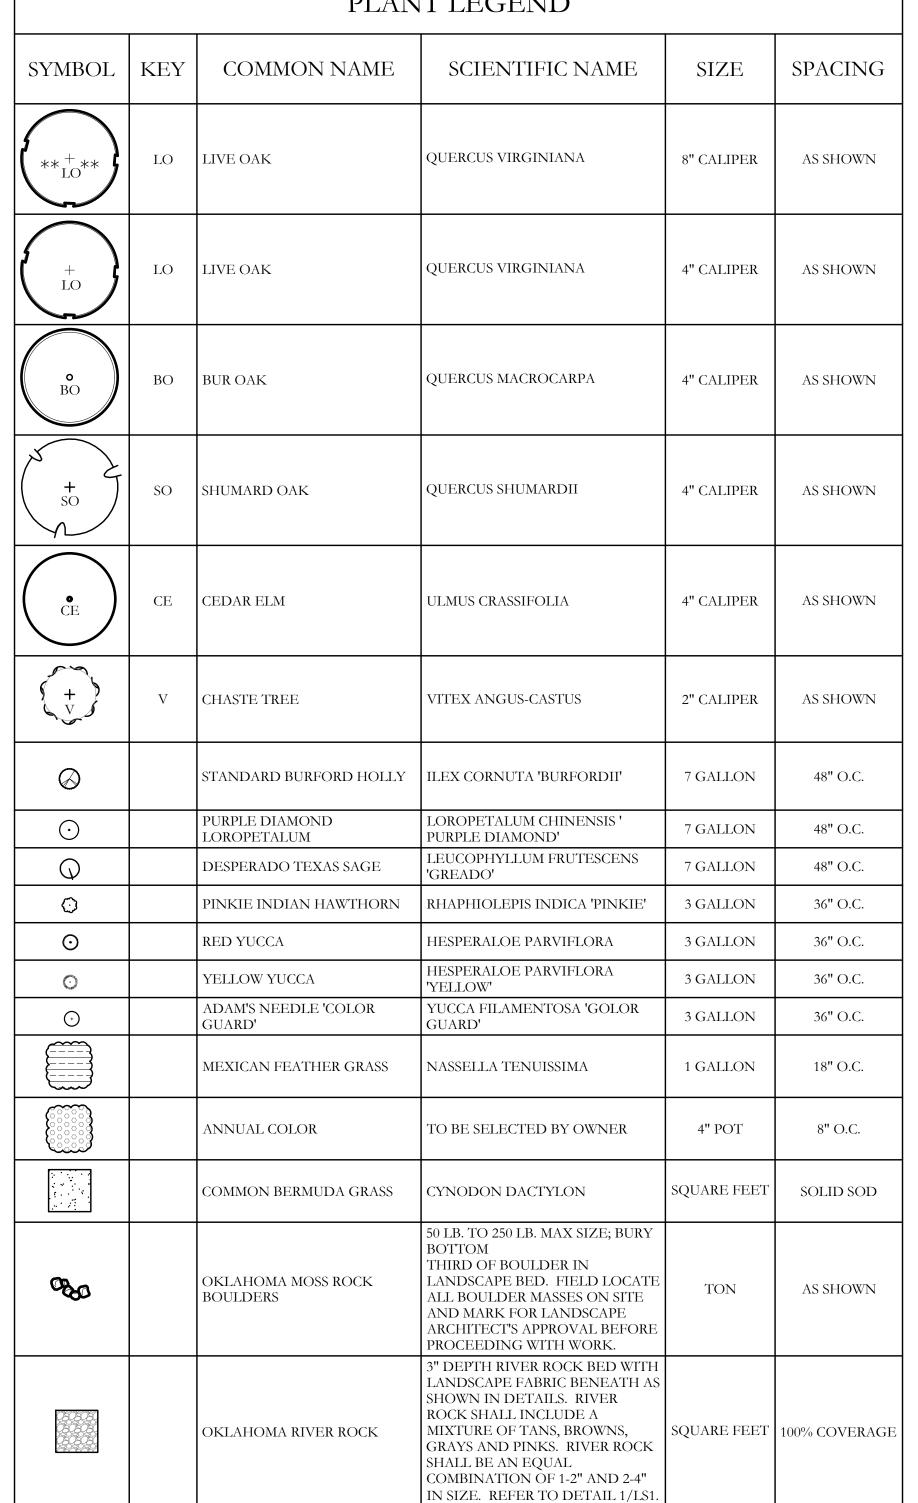
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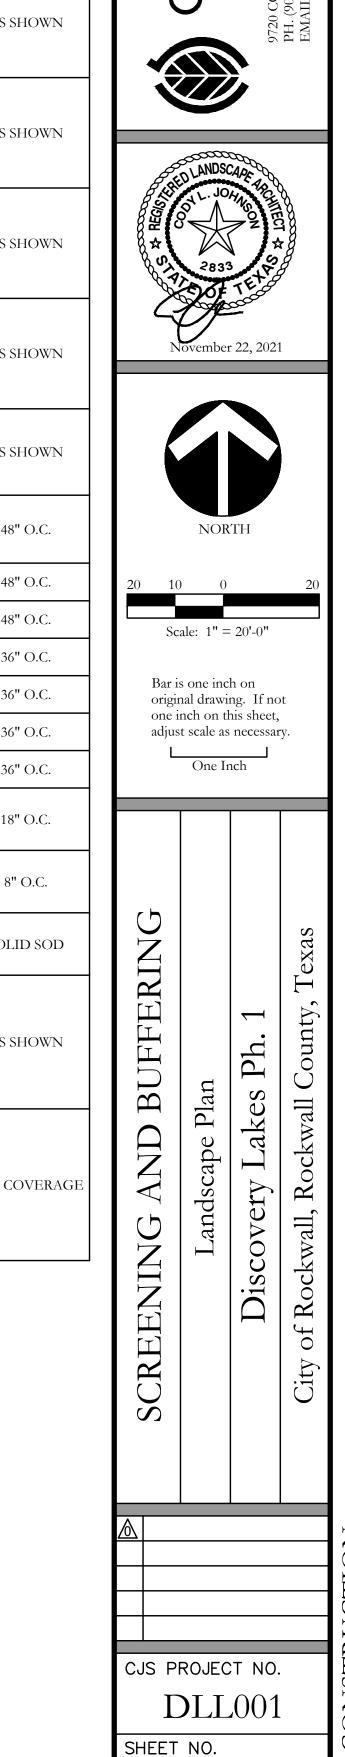
DLL003

L1 of 9


SPACING





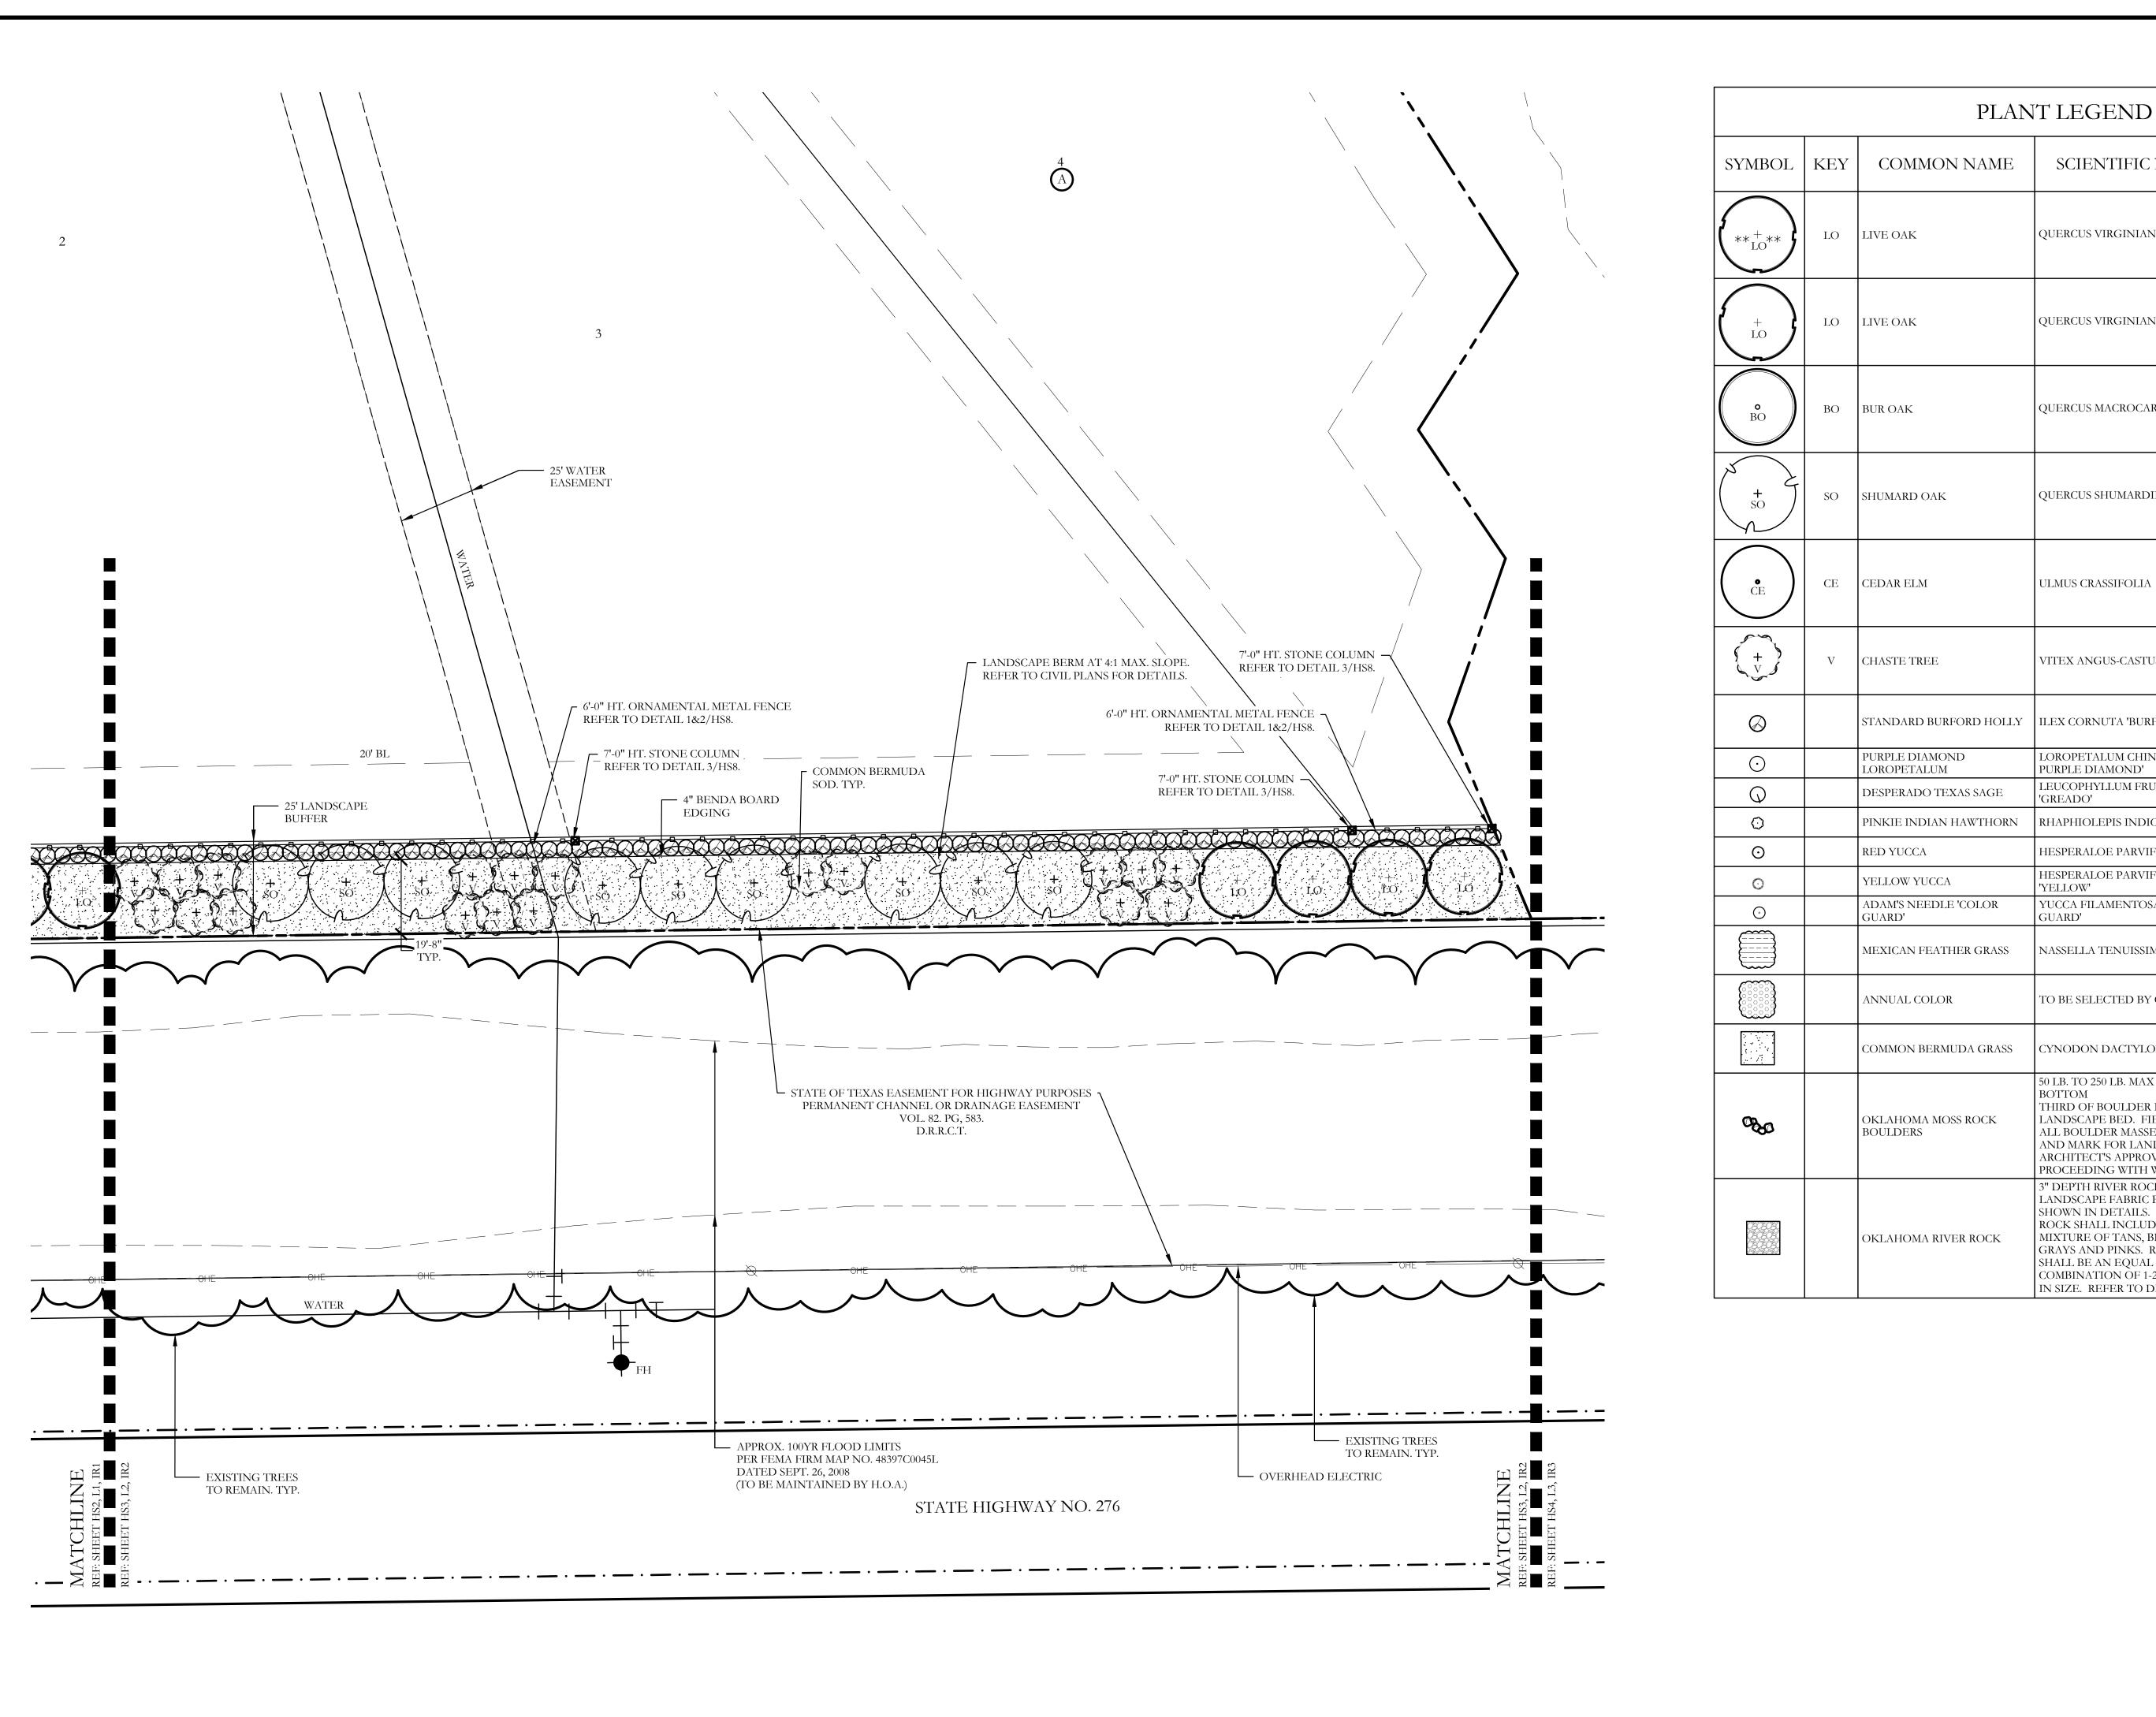



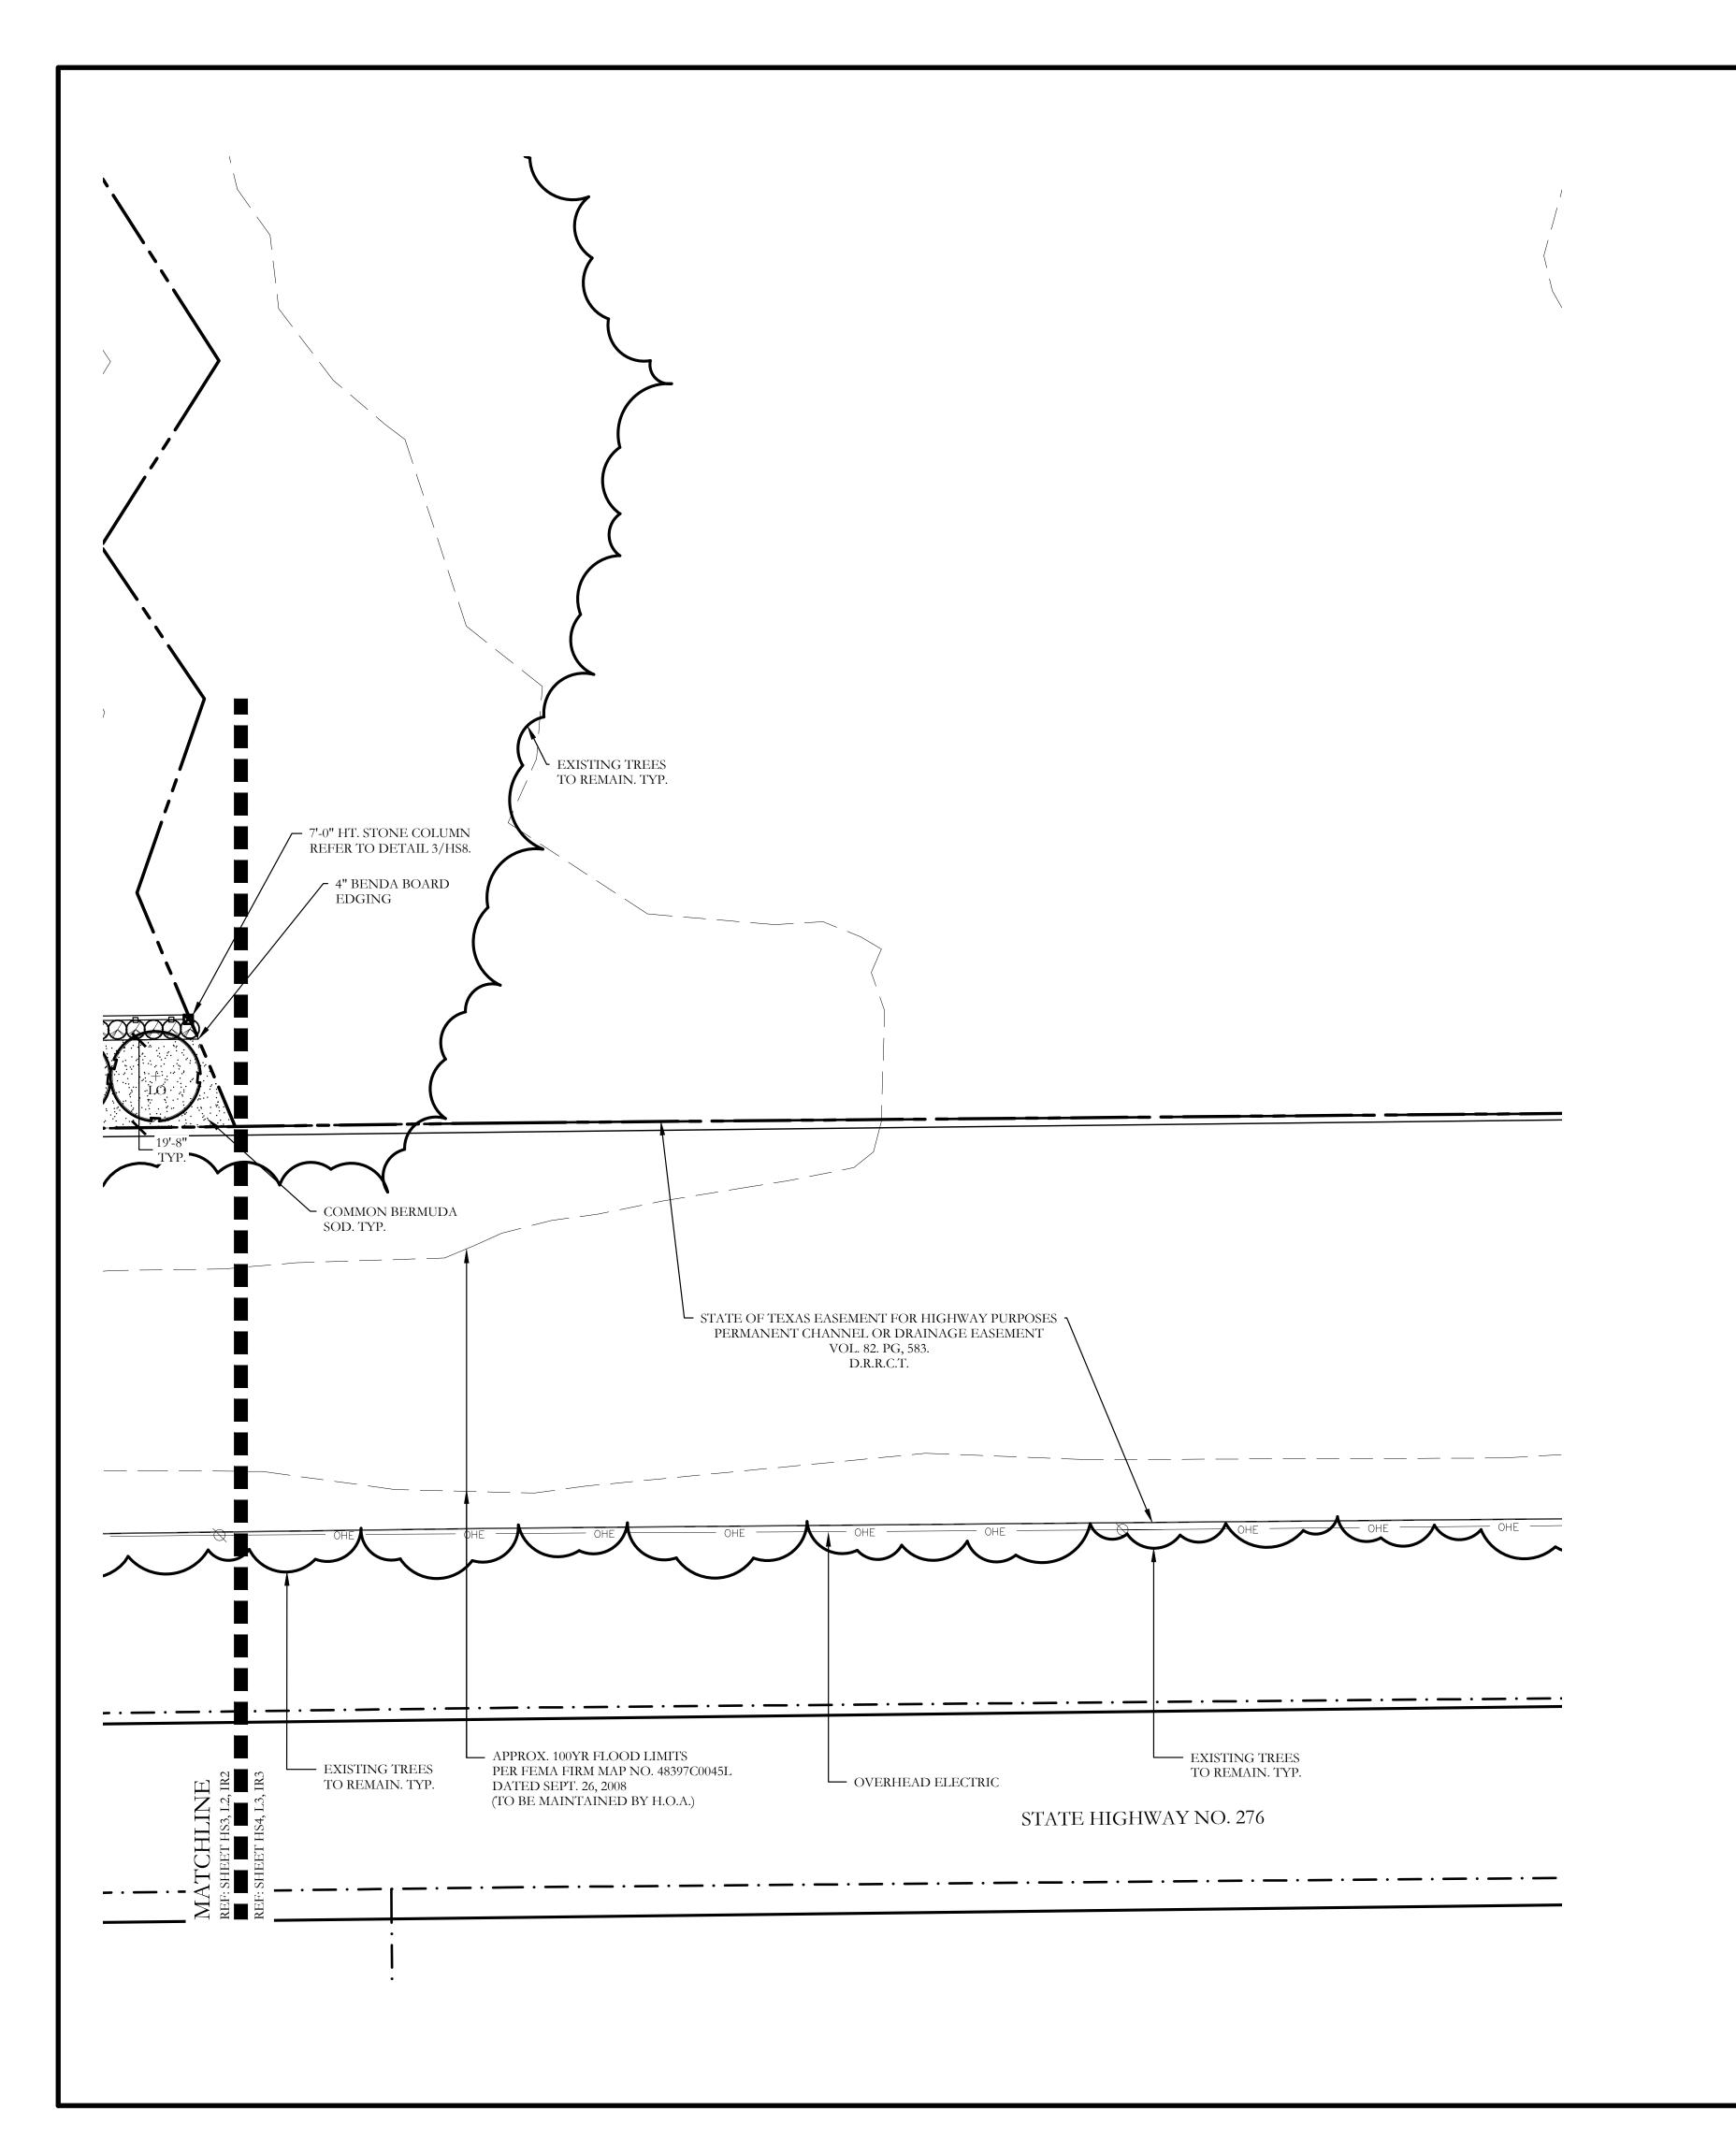


	T		T LEGEND		
SYMBOL	KEY	COMMON NAME	SCIENTIFIC NAME	SIZE	SPACING
** ⁺ **	LO	LIVE OAK	QUERCUS VIRGINIANA	8" CALIPER	AS SHOWN
+ LO	LO	LIVE OAK	QUERCUS VIRGINIANA	4" CALIPER	AS SHOWN
o BO	ВО	BUR OAK	QUERCUS MACROCARPA	4" CALIPER	AS SHOWN
*SO	SO	SHUMARD OAK	QUERCUS SHUMARDII	4" CALIPER	AS SHOWN
Œ CE	CE	CEDAR ELM	ULMUS CRASSIFOLIA	4" CALIPER	AS SHOWN
(+ V	V	CHASTE TREE	VITEX ANGUS-CASTUS	2" CALIPER	AS SHOWN
\oslash		STANDARD BURFORD HOLLY	ILEX CORNUTA 'BURFORDII'	7 GALLON	48" O.C.
\odot		PURPLE DIAMOND LOROPETALUM	LOROPETALUM CHINENSIS ' PURPLE DIAMOND'	7 GALLON	48" O.C.
<i>Q</i>		DESPERADO TEXAS SAGE	LEUCOPHYLLUM FRUTESCENS 'GREADO'	7 GALLON	48" O.C.
0		PINKIE INDIAN HAWTHORN	RHAPHIOLEPIS INDICA 'PINKIE'	3 GALLON	36" O.C.
0		RED YUCCA	HESPERALOE PARVIFLORA	3 GALLON	36" O.C.
		YELLOW YUCCA	HESPERALOE PARVIFLORA 'YELLOW'	3 GALLON	36" O.C.
0		ADAM'S NEEDLE 'COLOR GUARD'	YUCCA FILAMENTOSA 'GOLOR GUARD'	3 GALLON	36" O.C.
		MEXICAN FEATHER GRASS	NASSELLA TENUISSIMA	1 GALLON	18" O.C.
		ANNUAL COLOR	TO BE SELECTED BY OWNER	4" POT	8" O.C.
		COMMON BERMUDA GRASS	CYNODON DACTYLON	SQUARE FEET	SOLID SOD
%		OKLAHOMA MOSS ROCK BOULDERS	50 LB. TO 250 LB. MAX SIZE; BURY BOTTOM THIRD OF BOULDER IN LANDSCAPE BED. FIELD LOCATE ALL BOULDER MASSES ON SITE AND MARK FOR LANDSCAPE ARCHITECT'S APPROVAL BEFORE PROCEEDING WITH WORK.	TON	AS SHOWN
		OKLAHOMA RIVER ROCK	3" DEPTH RIVER ROCK BED WITH LANDSCAPE FABRIC BENEATH AS SHOWN IN DETAILS. RIVER ROCK SHALL INCLUDE A MIXTURE OF TANS, BROWNS, GRAYS AND PINKS. RIVER ROCK SHALL BE AN EQUAL COMBINATION OF 1-2" AND 2-4" IN SIZE. REFER TO DETAIL 1/LS1.	SQUARE FEET	100% COVERAG


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COVERAGE	SCREENING AND BUF	Landscape Plan	Discovery Lakes Pl	City of Rockwall, Rockwall Co		
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	CRE			City o		
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		CJS PROJECT NO. DIJ 001				
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DLL001

SHEET NO. L3 of 9

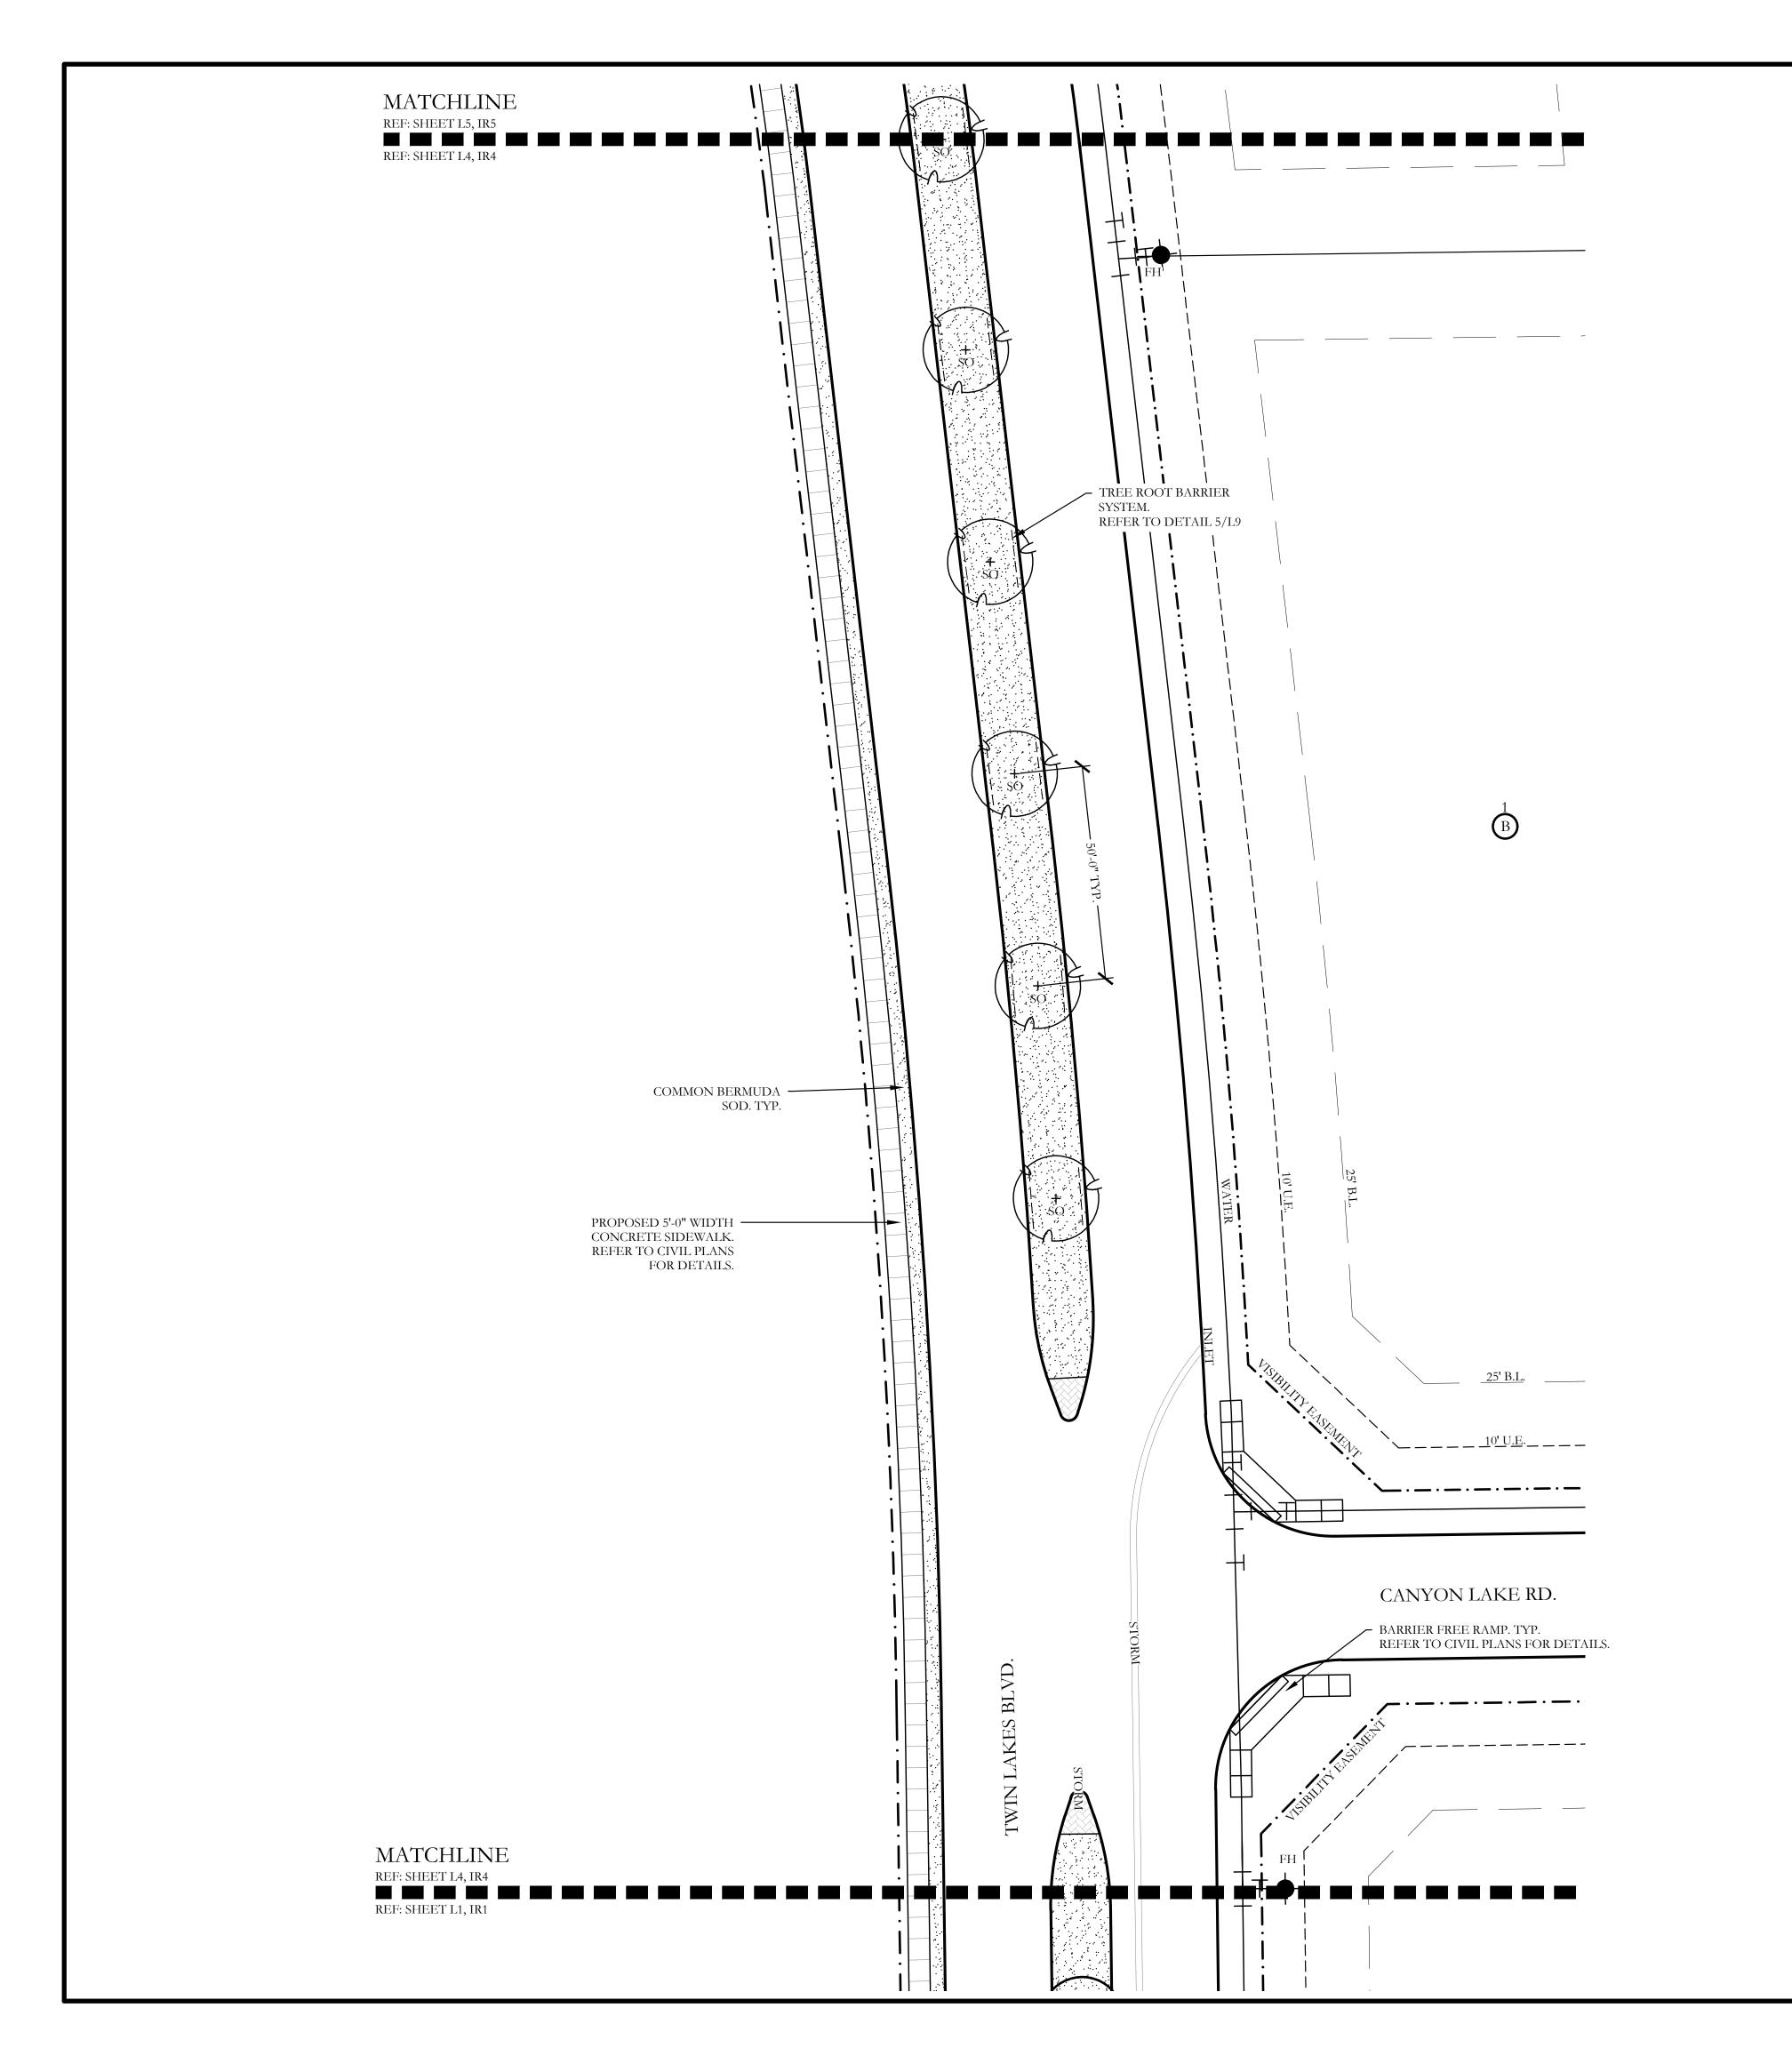

	PLANT LEGEND						
SYMBOL	KEY	COMMON NAME	SCIENTIFIC NAME	SIZE	SPACING		
+ LO	LO	LIVE OAK	QUERCUS VIRGINIANA	4" CALIPER	AS SHOWN		
o BO	ВО	BUR OAK	QUERCUS MACROCARPA	4" CALIPER	AS SHOWN		
**SO	SO	SHUMARD OAK	QUERCUS SHUMARDII	4" CALIPER	AS SHOWN		
		COMMON BERMUDA GRASS	CYNODON DACTYLON	SQUARE FEET	SOLID SOD		

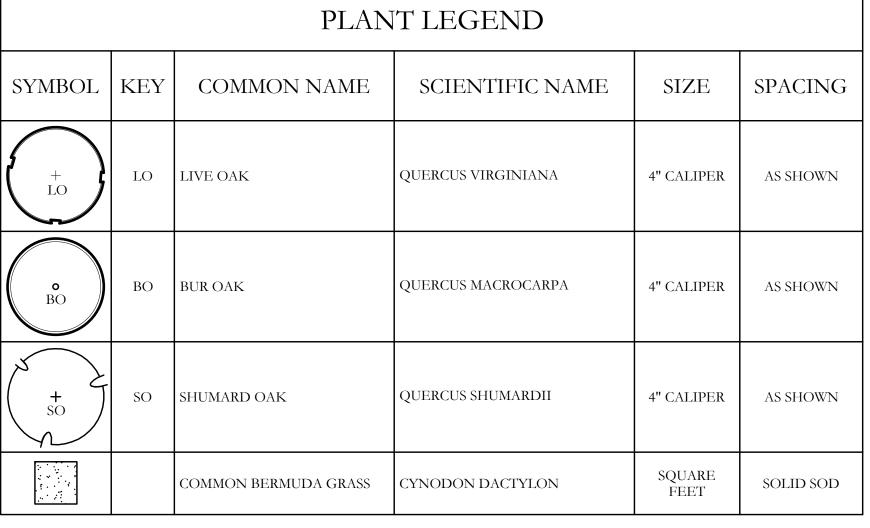

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CODY



Scale: 1'' = 20'-0''

Bar is one inch on original drawing. If not one inch on this sheet, adjust scale as necessary.

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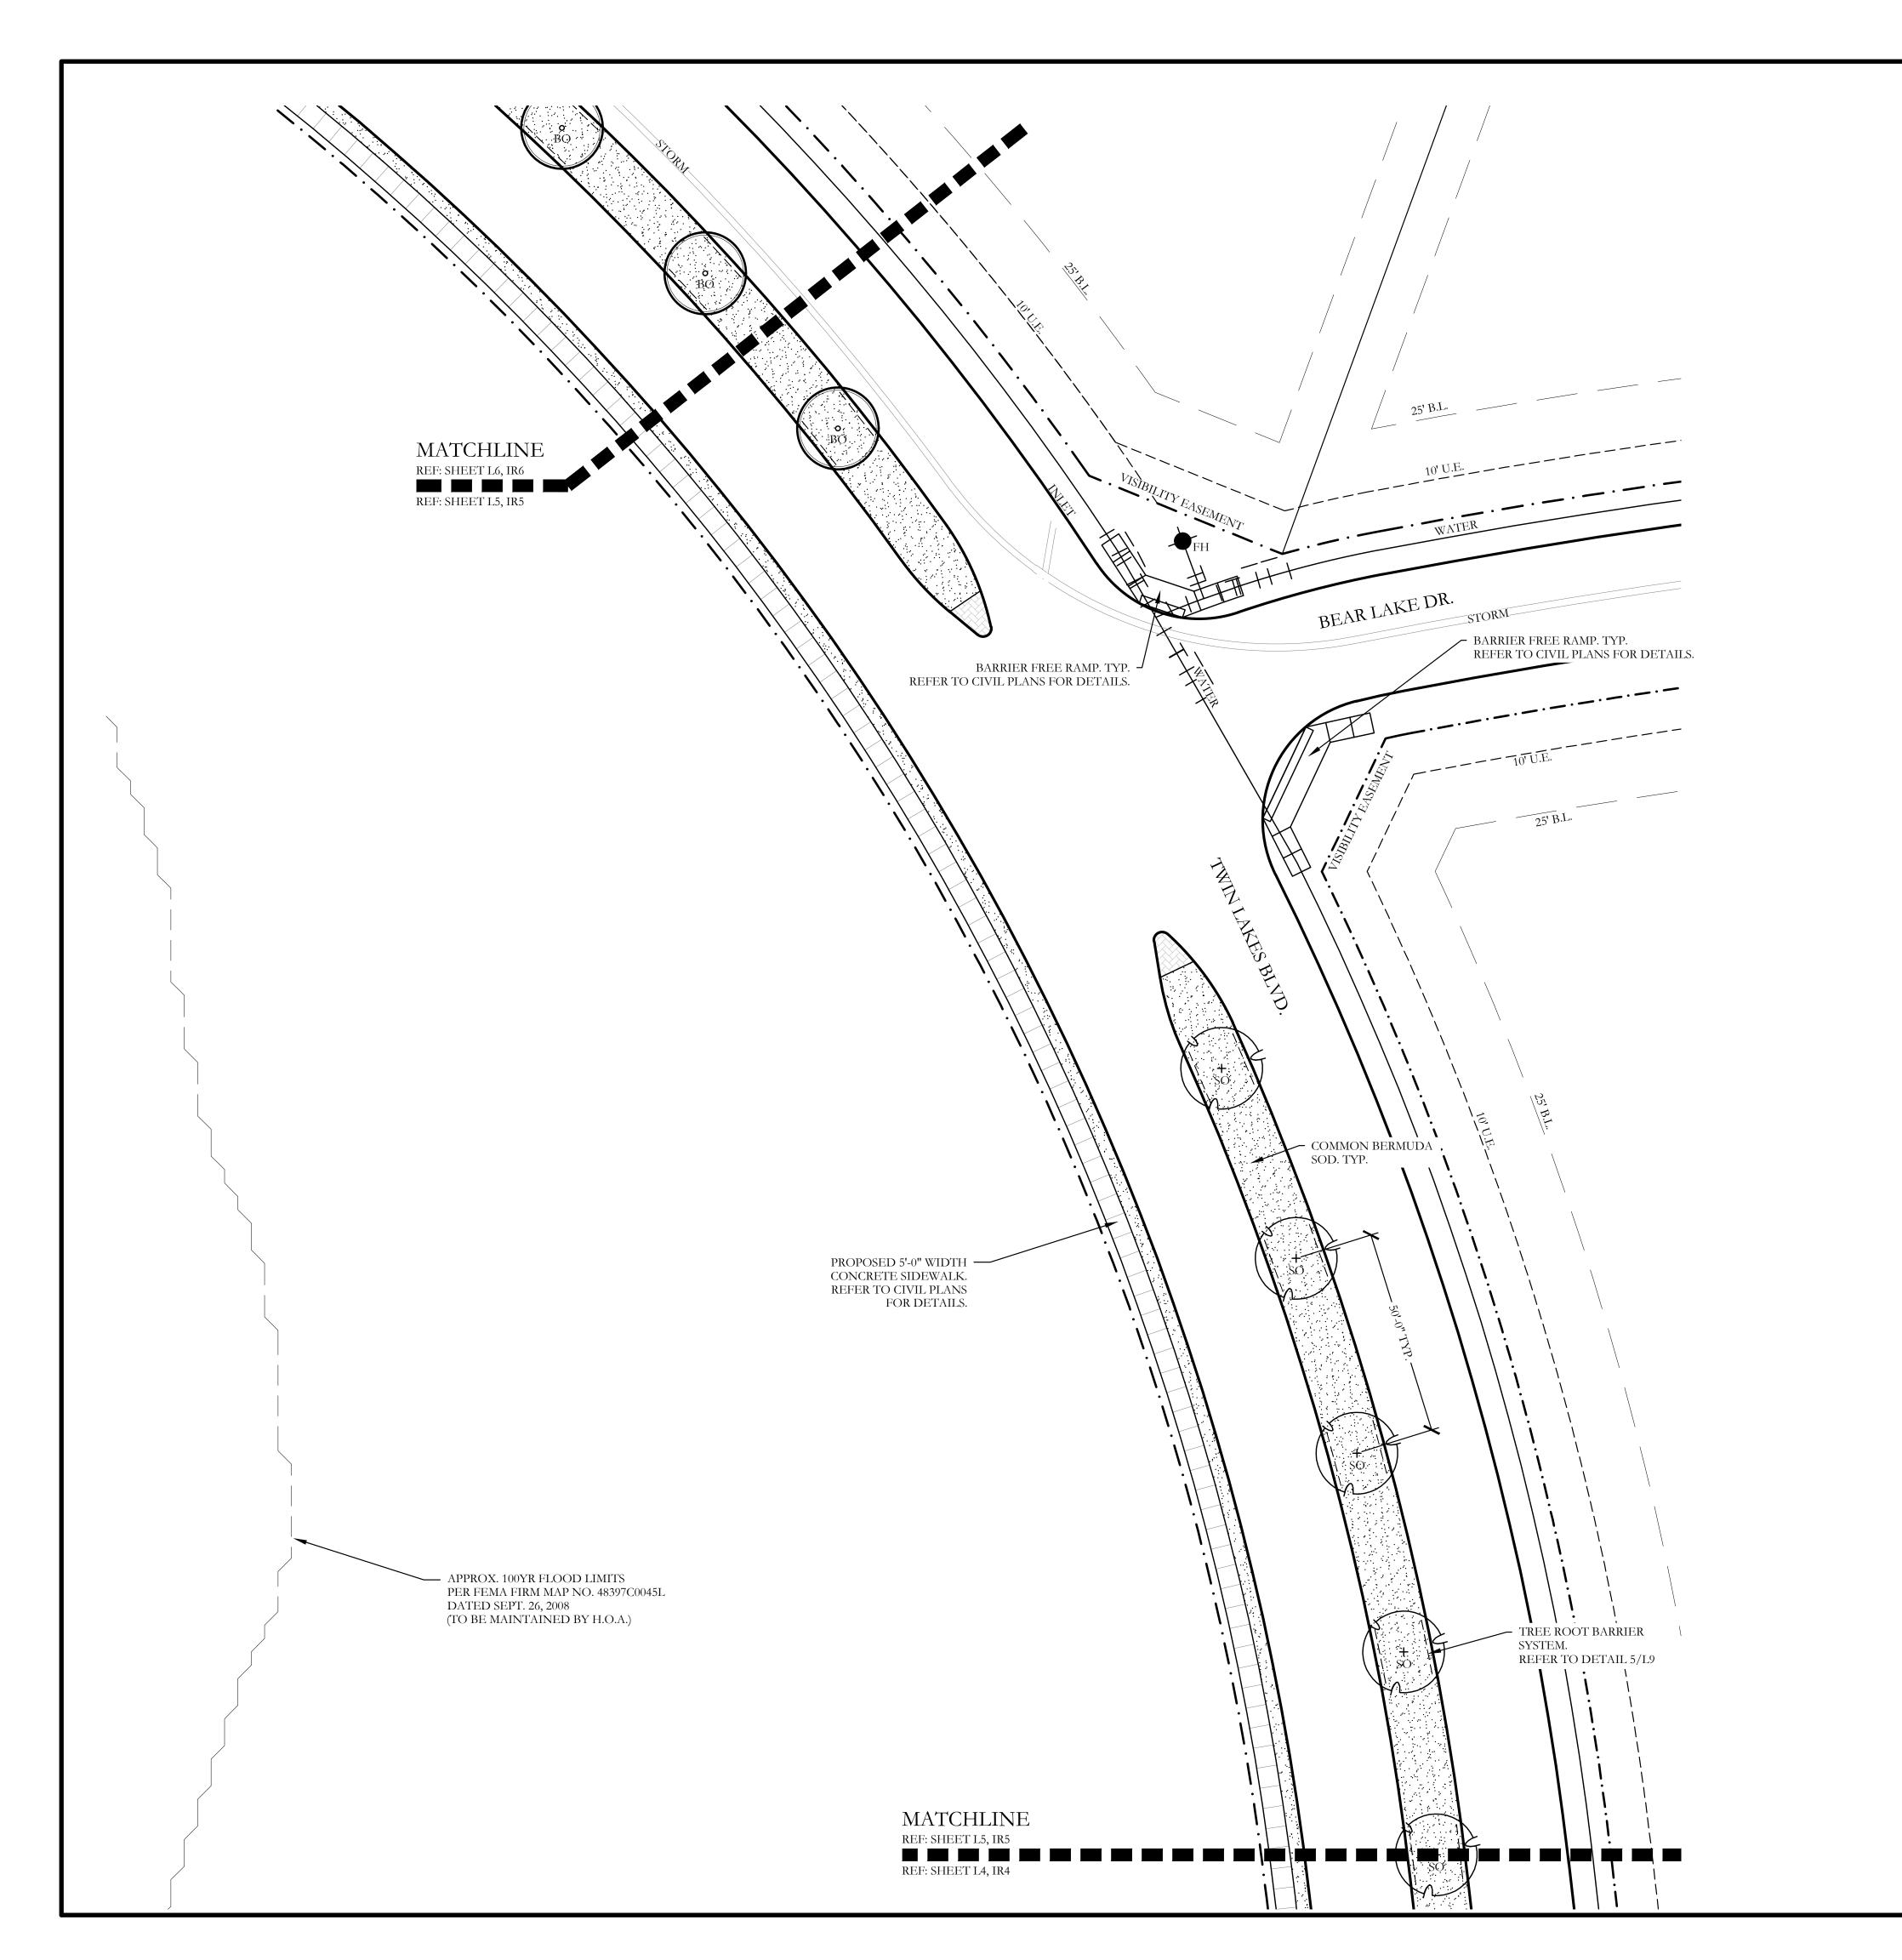
Lakes Ph.

CJS PROJECT NO.


DLL001

SHEET NO.

L4 of <u>9</u>




PLANT LEGEND						
SYMBOL	KEY	COMMON NAME	SCIENTIFIC NAME	SIZE	SPACING	
+ LO	LO	LIVE OAK	QUERCUS VIRGINIANA	4" CALIPER	AS SHOWN	
o BO	ВО	BUR OAK	QUERCUS MACROCARPA	4" CALIPER	AS SHOWN	
+ SO	SO	SHUMARD OAK	QUERCUS SHUMARDII	4" CALIPER	AS SHOWN	
		COMMON BERMUDA GRASS	CYNODON DACTYLON	SQUARE FEET	SOLID SOD	

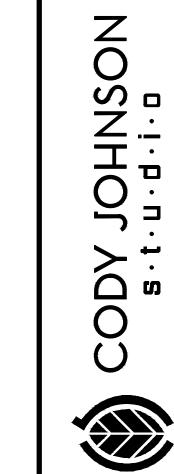







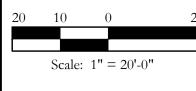

Bar is one inch on original drawing. If not one inch on this sheet, adjust scale as necessary.


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Discovery Lakes Ph. Landscape Plan

SCREENING AND BUFFERING

CJS PROJECT NO.

DLL001 SHEET NO. L5 of <u>9</u>

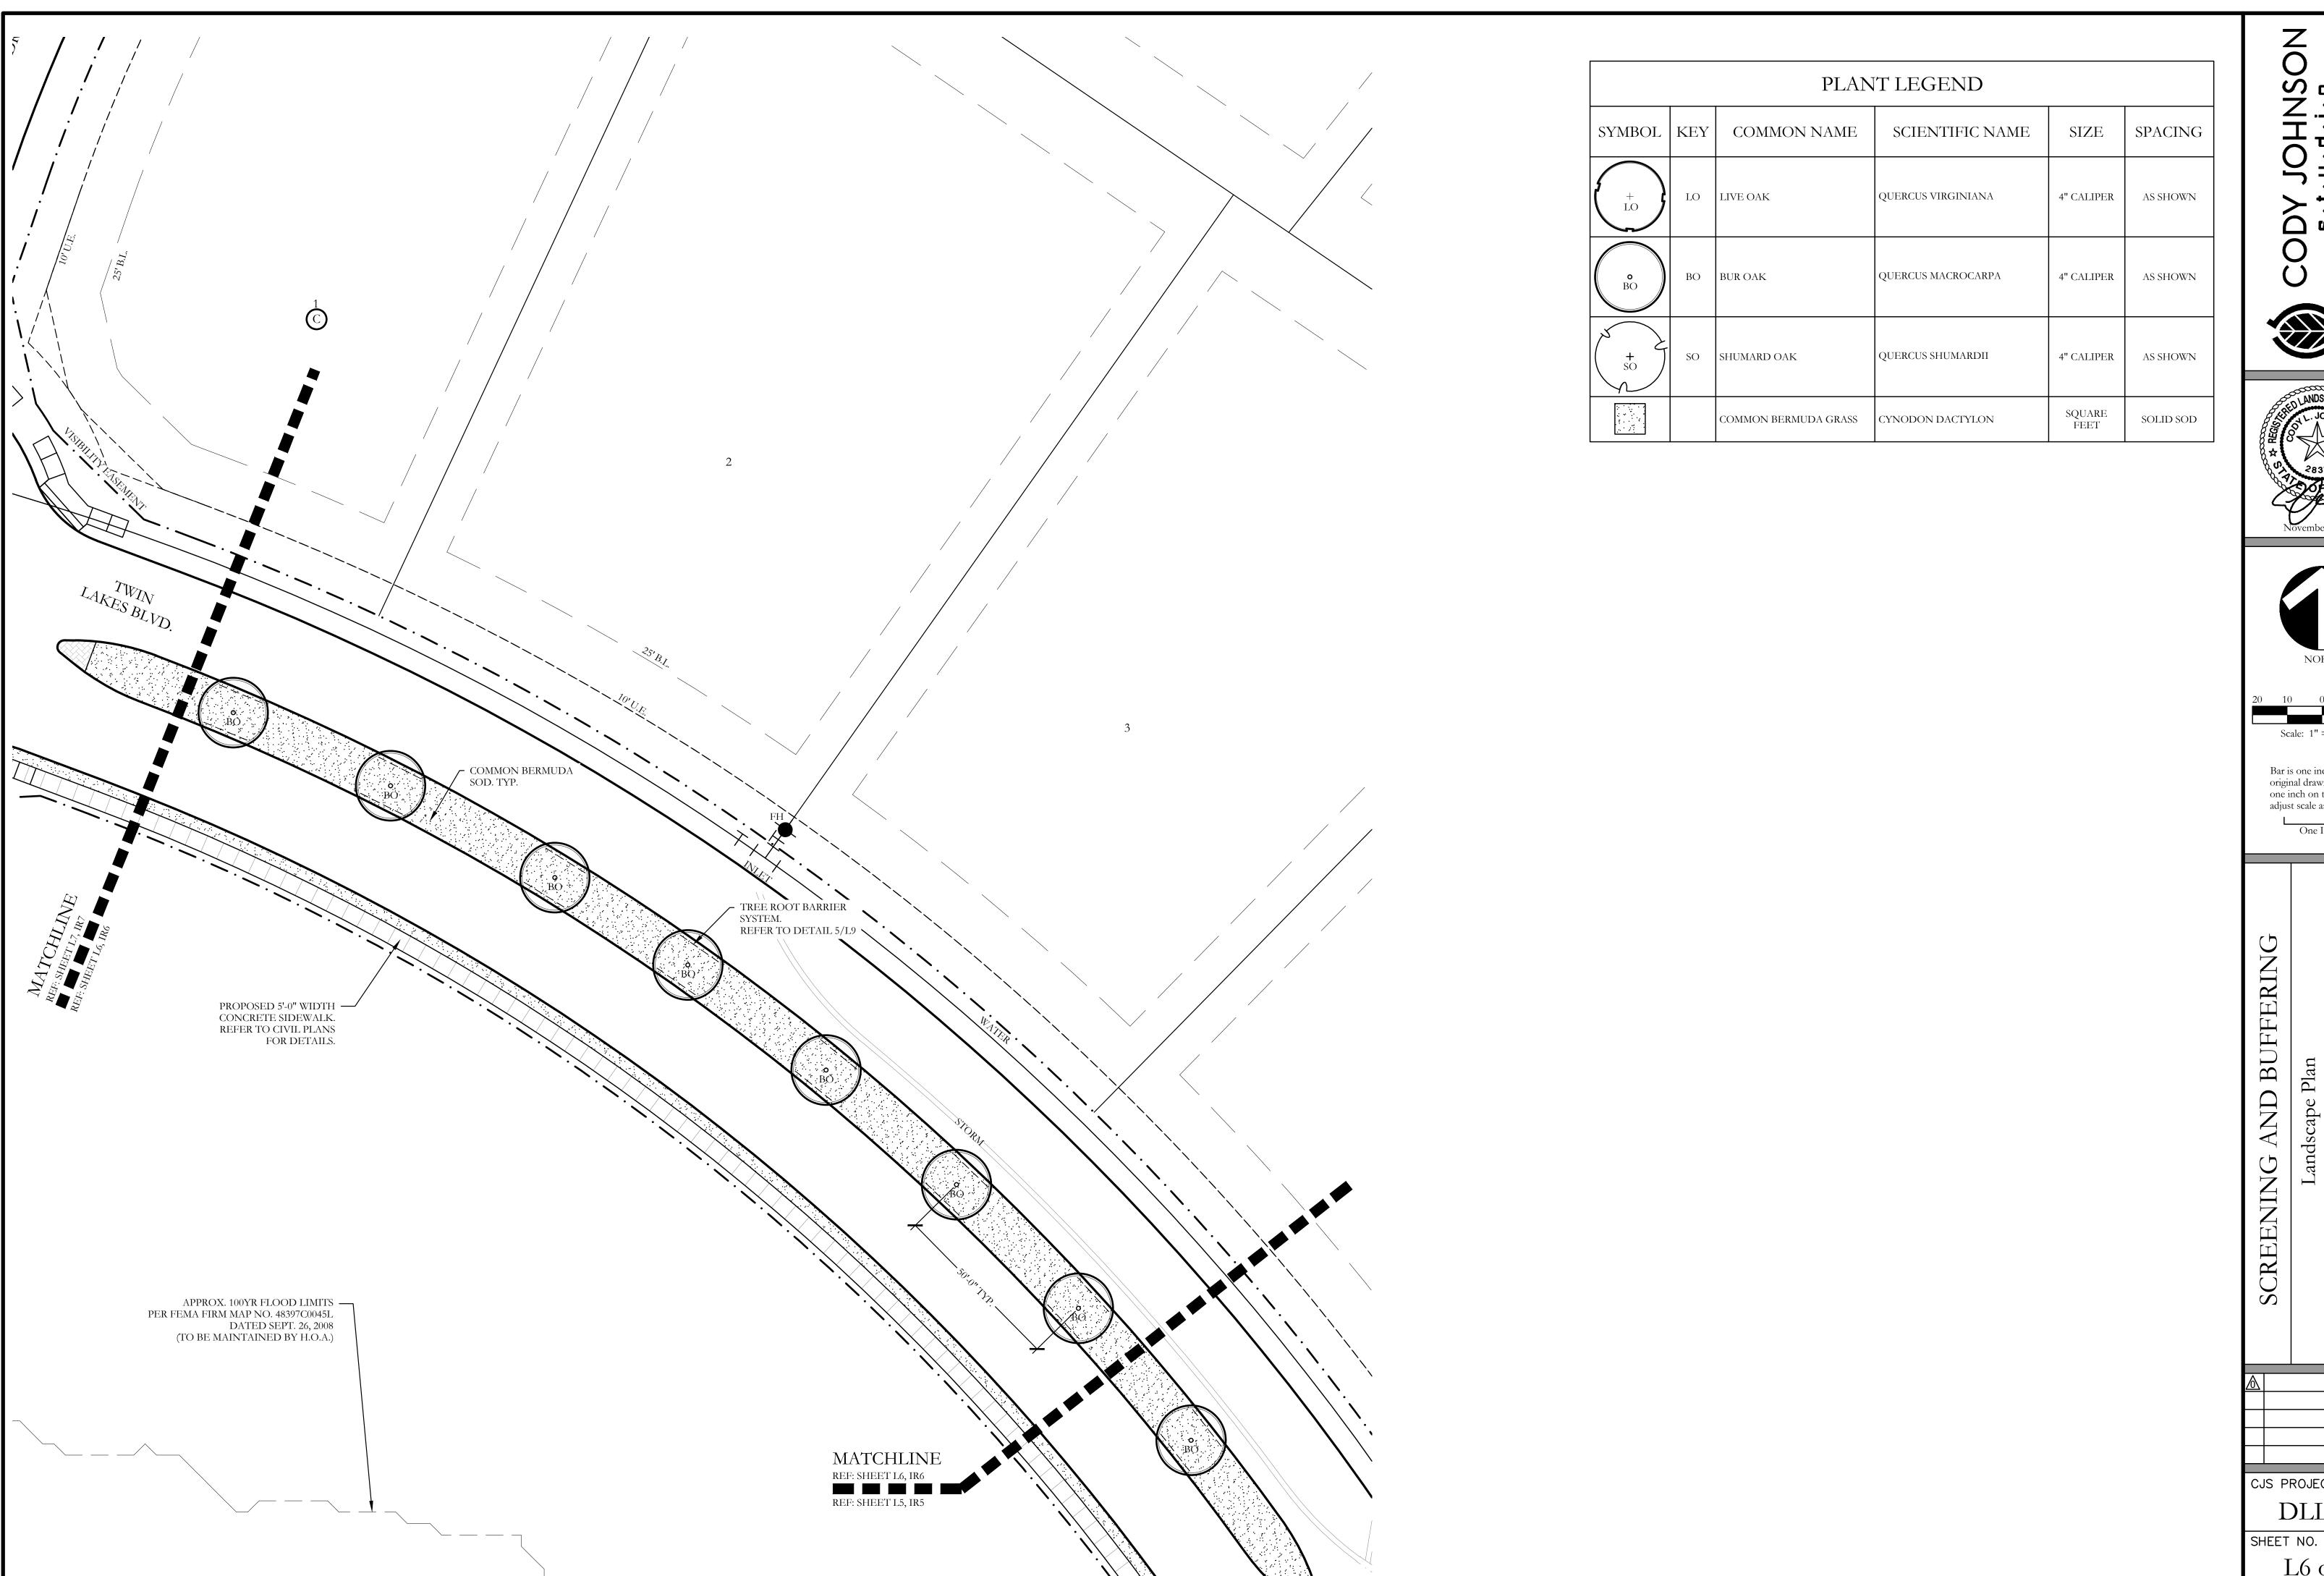


CODY Scale: 1'' = 20'-0''Bar is one inch on original drawing. If not one inch on this sheet, adjust scale as necessary. $\overline{}$ Lakes Ph.

CJS PROJECT NO.

DLL001

L6 of <u>9</u>

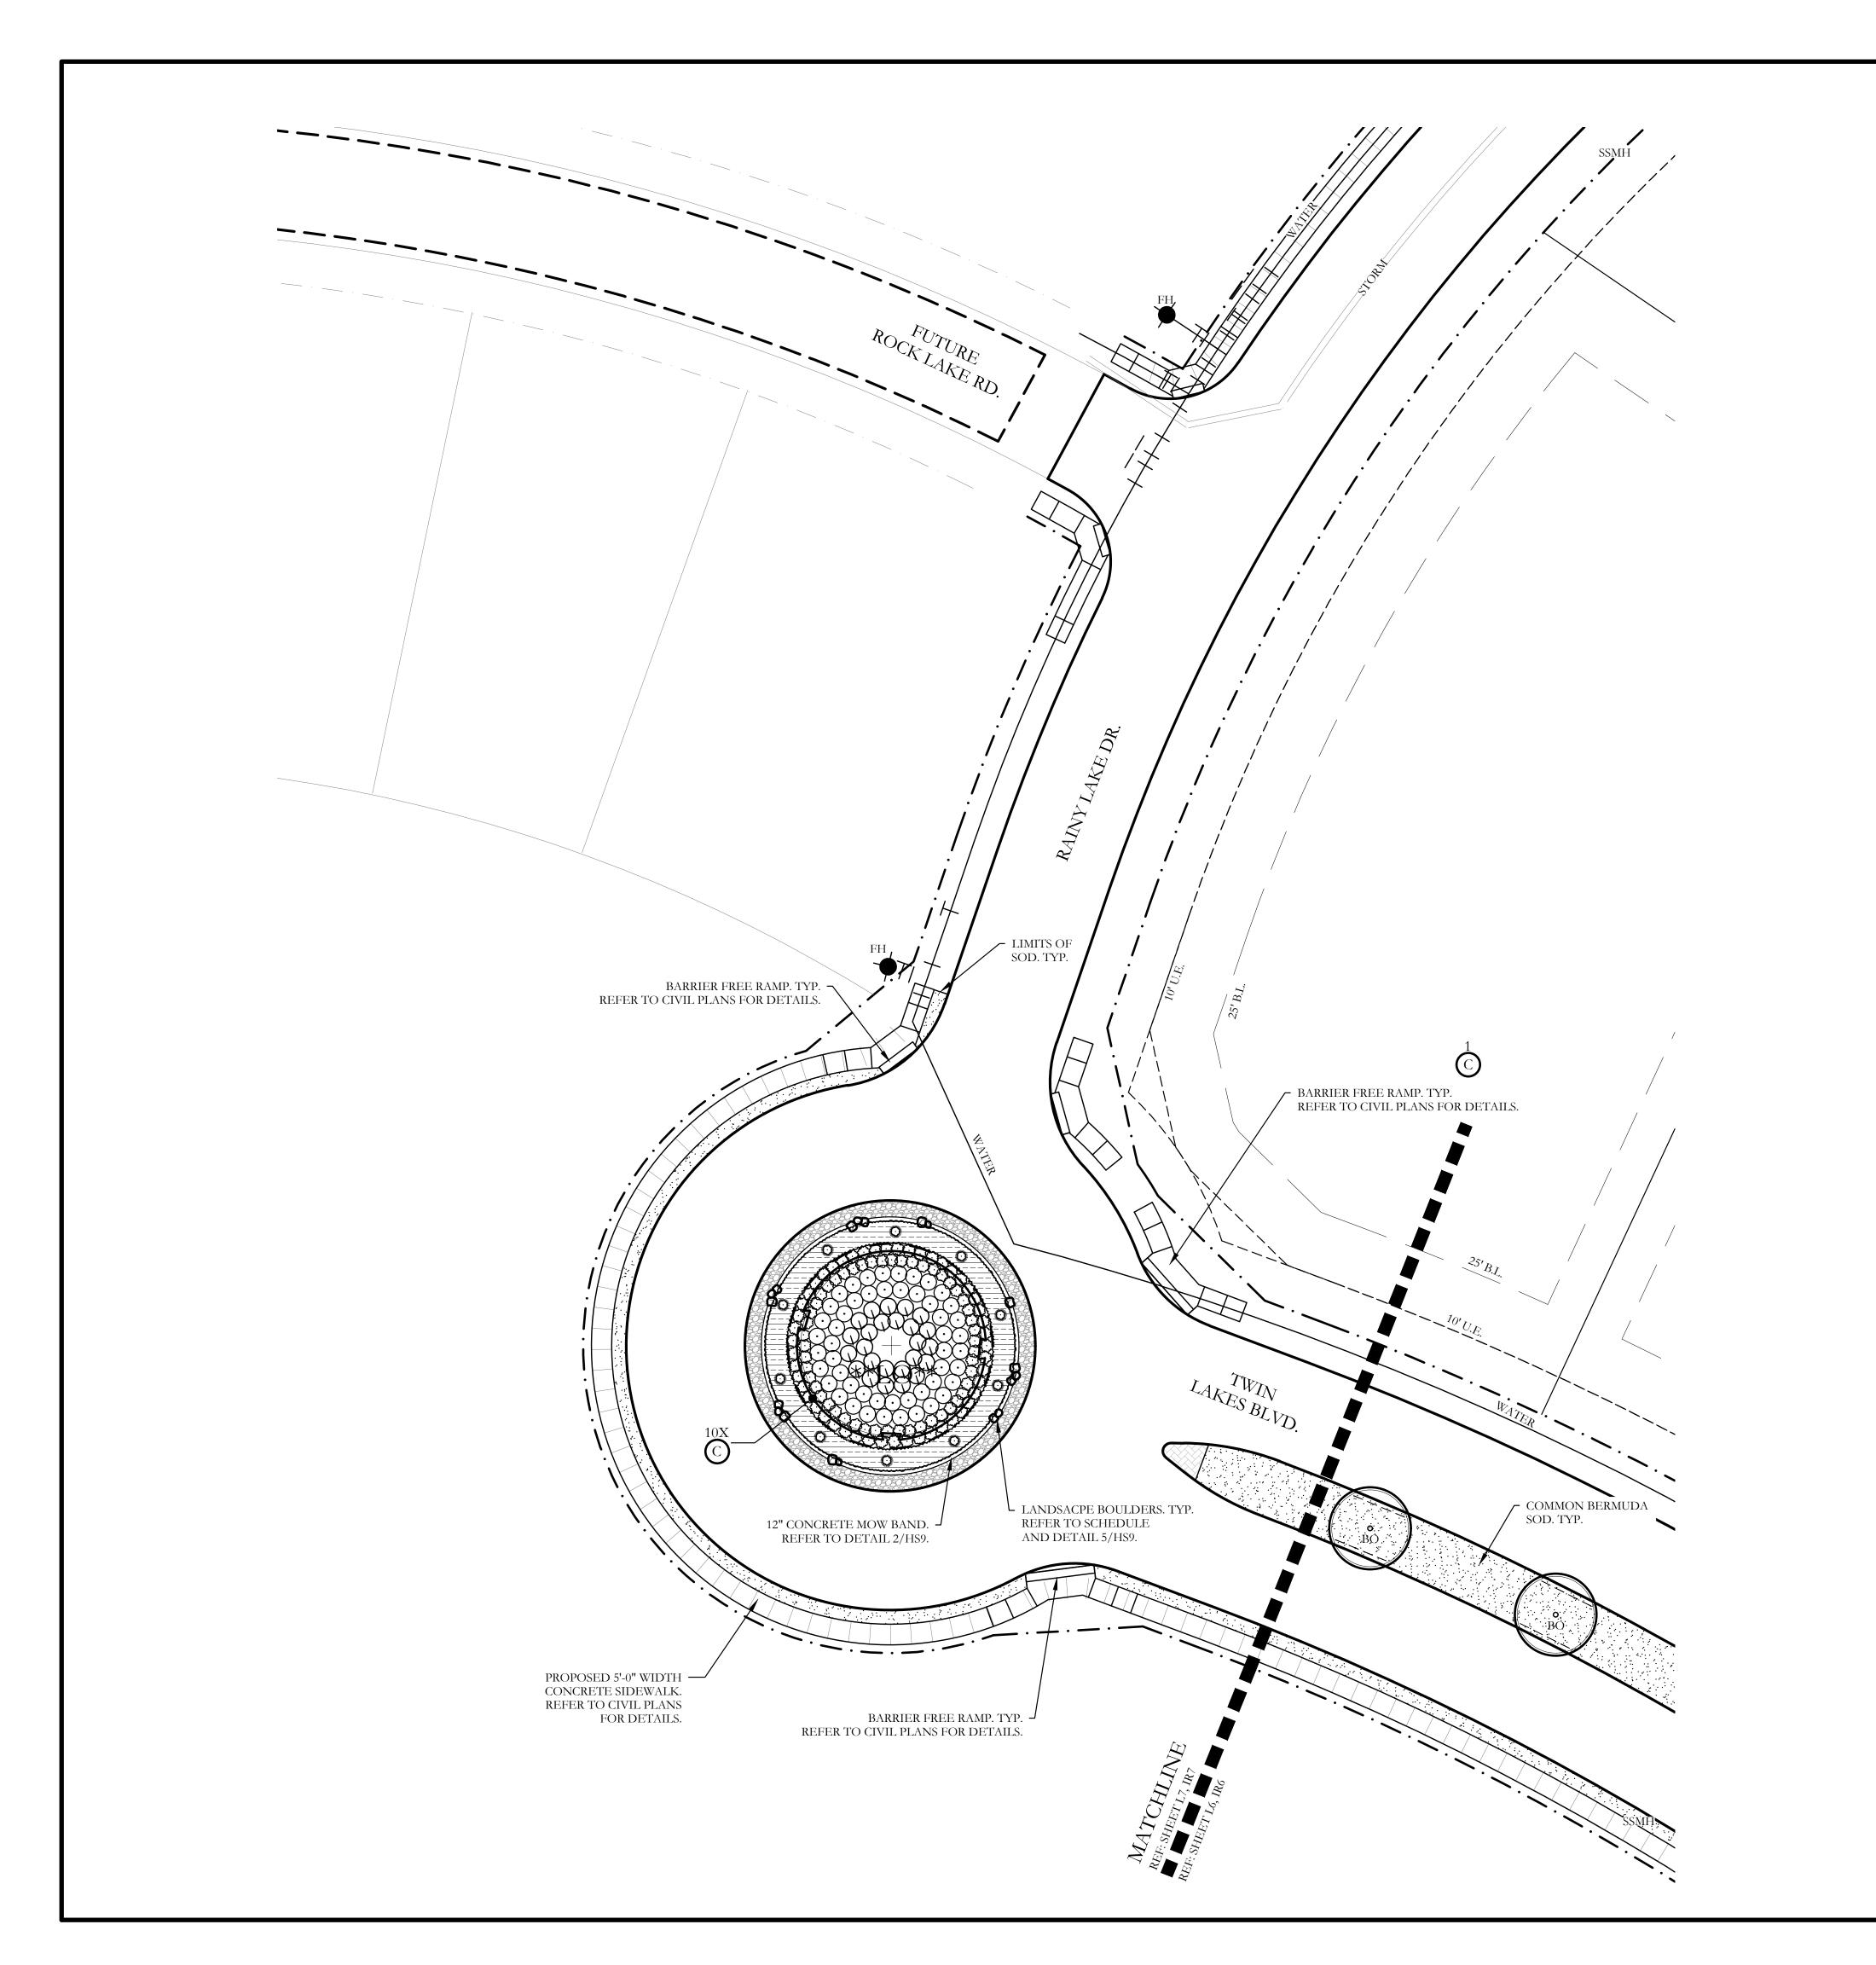

		PLAN	T LEGEND		
SYMBOL	KEY	COMMON NAME	SCIENTIFIC NAME	SIZE	SPACING
LO	LO LIVE OAK		QUERCUS VIRGINIANA	8" CALIPER	AS SHOWN
t.O	LO	LIVE OAK	QUERCUS VIRGINIANA	4" CALIPER	AS SHOWN
o BO	BO BUR OAK QUERCUS MACROCARPA		4" CALIPER	AS SHOWN	
+ SO	SO	SHUMARD OAK	QUERCUS SHUMARDII	4" CALIPER	AS SHOWN
© CE	CE	CEDAR ELM	ULMUS CRASSIFOLIA	4" CALIPER	AS SHOWN
V CHASTE TREE		CHASTE TREE	VITEX ANGUS-CASTUS	2" CALIPER	AS SHOWN
STANDARD BU		STANDARD BURFORD HOLLY	ILEX CORNUTA 'BURFORDII' 7 GALLON		48" O.C.
\odot		PURPLE DIAMOND LOROPETALUM	LOROPETALUM CHINENSIS ' PURPLE DIAMOND'	7 GALLON	48" O.C.
Q		DESPERADO TEXAS SAGE	LEUCOPHYLLUM FRUTESCENS 'GREADO'	7 GALLON	48" O.C.
0		PINKIE INDIAN HAWTHORN	RHAPHIOLEPIS INDICA 'PINKIE'	3 GALLON	36" O.C.
0		RED YUCCA	HESPERALOE PARVIFLORA	3 GALLON	36" O.C.
· · · · · · · · · · · · · · · · · · ·		YELLOW YUCCA	HESPERALOE PARVIFLORA 'YELLOW'	3 GALLON	36" O.C.
\odot		ADAM'S NEEDLE 'COLOR GUARD'	YUCCA FILAMENTOSA 'GOLOR GUARD'	3 GALLON	36" O.C.
		MEXICAN FEATHER GRASS	NASSELLA TENUISSIMA	1 GALLON	18" O.C.
		ANNUAL COLOR	TO BE SELECTED BY OWNER	4" POT	8" O.C.
		COMMON BERMUDA GRASS	CYNODON DACTYLON	SQUARE FEET	SOLID SOD
080		OKLAHOMA MOSS ROCK BOULDERS	50 LB. TO 250 LB. MAX SIZE; BURY BOTTOM THIRD OF BOULDER IN LANDSCAPE BED. FIELD LOCATE ALL BOULDER MASSES ON SITE AND MARK FOR LANDSCAPE ARCHITECT'S APPROVAL BEFORE PROCEEDING WITH WORK.	TON	AS SHOWN
		OKLAHOMA RIVER ROCK	3" DEPTH RIVER ROCK BED WITH LANDSCAPE FABRIC BENEATH AS SHOWN IN DETAILS. RIVER ROCK SHALL INCLUDE A MIXTURE OF TANS, BROWNS, GRAYS AND PINKS. RIVER ROCK SHALL BE AN EQUAL COMBINATION OF 1-2" AND 2-4" IN SIZE. REFER TO DETAIL 1/LS1.	SQUARE FEET	100% COVERAG

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36" O.C.		One I	nch	
18" O.C.				
8" O.C.				
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S SHOWN	BUFFE	Jan	akes Ph. 1	all County,
COVERAGE	NG AND	Landscape Plat	Discovery Lak	City of Rockwall, Rockwall County, Texas
	SCREENING A		Dis	City of Roc
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/ JOHNSON

LANDSCAPE PROVIDED

STATE HIGHWAY - 276

- MINIMUM TWENTY (25) FOOT LANDSCAPE BUFFER PROVIDED
- 6' HT. WROUGHT IRON METAL SCREENING FENCE PROVIDED.
- 3-4" CAL. CANOPY TREE / 100 LF OF LINEAR FRONTAGE.

 $\overline{545}$ LF OF FRONTAGE / 100 LF = 5.45

 $5.45 \times 3 = 16.35$ 4-ACCENT TREES / 100 LF OF LINEAR FRONTAGE.

545 LF OF FRONTAGE / 100 LF = 5.45 5.45 X 4 = 21.80

PROVIDED: 17 - 4" CALIPER TREES 22 - ACCENT TREES

SHRUBBERY SHALL HAVE A MINIMUM HEIGHT OF 30 INCHES

AND A MAXIMUM HEIGHT OF 48 INCHES.

MINIMUM 2.5' HT. LANDSCAPE BERMS PROVIDED ALONG FRONTAGE. REFER TO CIVIL PLANS FOR DETAILS

			PLANT LIST			
KEY	ESTIMATED QUANTITY	COMMON NAME	SCIENTIFIC NAME	SIZE	SPACING	REMARKS
LO	8	LIVE OAK	QUERCUS VIRGINIANA	4" CALIPER	AS SHOWN	NURSERY GROWN; FULL HEAD; MINIMUM BRANCHING HEIGHT AT 6'-0"; MINIMUM 10'-0" OVERALL HEIGHT.
TO	1	LIVE OAK - MULTI TRUNK	QUERCUS VIRGINIANA	8" CALIPER	AS SHOWN	NURSERY GROWN; FULL HEAD; MINIMUM BRANCHING HEIGHT AT 10'-0"; MINIMUM 15'-0" OVERALL HEIGHT.
ВО	8	BUR OAK	QUERCUS MACROCARPA	4" CALIPER	AS SHOWN	NURSERY GROWN; FULL HEAD; MINIMUM BRANCHING HEIGHT AT 6'-0"; MINIMUM 10'-0" OVERALL HEIGHT.
SO	19	SHUMARD OAK	QUERCUS SHUMARDII	4" CALIPER	AS SHOWN	NURSERY GROWN; FULL HEAD; MINIMUM BRANCHING HEIGHT AT 6'-0"; MINIMUM 10'-0" OVERALL HEIGHT.
CE	5	CEDAR ELM	ULMUS CRASSIFOLIA	4" CALIPER	AS SHOWN	NURSERY GROWN; FULL HEAD; MINIMUM BRANCHING HEIGHT AT 6'-0"; MINIMUM 10'-0" OVERALL HEIGHT.
v	22	CHASE TREE	VITEX ANGUS-CASTUS	2" CALIPER	AS SHOWN	NURSERY GROWN; FULL HEAD; MINIMUM 8'-0" OVERALL HEIGHT.
	105	STANDARD BURFORD HOLLY	ILEX CORNUTA 'BURFORDII'	7 GALLON	48" O.C.	CONTAINER GROWN; FULL PLANT.
	71	PURPLE DIAMOND LOROPETALUM	LOROPETALUM CHINENSIS ' PURPLE DIAMOND'	7 GALLON	48" O.C.	CONTAINER GROWN; FULL PLANT.
	25	DESPERADO TEXAS SAGE	LEUCOPHYLLUM FRUTESCENS 'GREADO'	3 GALLON	48" O.C.	CONTAINER GROWN; FULL PLANT.
	114	PINKIE INDIAN HAWTHORN	RHAPHIOLEPIS INDICA 'PINKIE'	3 GALLON	36" O.C.	CONTAINER GROWN; FULL PLANT.
	36	RED YUCCA	HESPERALOE PARVIFLORA	3 GALLON	36" O.C.	CONTAINER GROWN; FULL PLANT.
	50	YELLOW YUCCA	HESPERALOE PARVIFLORA 'YELLOW'	3 GALLON	36" O.C.	CONTAINER GROWN; FULL PLANT.
	19	ADAN'S NEEDLE 'COLOR GUARD'	YUCCA FILAMENTOSA 'COLOR GUARD'	3 GALLON	36" O.C.	CONTAINER GROWN; FULL PLANT.
	550	MEXICAN FEATHER GRASS	NASSELLA TENUISSIMA	1 GALLON	24" O.C.	CONTAINER GROWN; FULL PLANT.
	170	ANNUAL COLOR	TO BE SELECTED BY OWNER	4" POT	8" O.C.	CONTAINER GROWN; FULL PLANT.
	32,800	COMMON BERMUDA GRASS	CYNODON DACTYLON	SQUARE FEET	SOLID SOD	MINIMUM 100% COVERAGE ALL AREAS SHOWN
	1.5	OKLAHOMA MOSS ROCK BOULDERS	N/A	TON	AS SHOWN	50 LB. TO 250 LB. MAX SIZE; BURY BOTTOM THIRD OF BOULDER IN LANDSCAPE BED. FIELD LOCATE ALL BOULDER MASSES ON SITE AND MARK FOR LANDSCAPE ARCHITECT'S APPROVAL BEFORE PROCEEDING WITH WORK.
	825	OKLAHOMA RIVER ROCK	N/A	SQUARE FEET	100% COVERAGE	3" DEPTH RIVER ROCK BED WITH LANDSCAPE FABRIC BENEATH AS SHOWN IN DETAILS. RIVER ROCK SHALL INCLUDE A MIXTURE OF TANS, BROWNS, GRAYS, AND PINKS. RIVER ROCK SHALL BE AN EQUAL COMBUNATION OF 1"-2" AND 2"-4" IN SIZE.

GENERAL LANDSCAPE NOTES

INSPECTIONS:

1. NO EXCAVATION SHALL OCCUR IN CITY R.O.W. WITHOUT A R.O.W. PERMIT--CONTACT THE PUBLIC

- WORKS DEPARTMENT. 2. THE CONTRACTOR SHALL MARK ALL WATER LINES, SEWER LINES, AND TREE LOCATIONS PRIOR TO
- CALLING FOR ROW INSPECTION AND PERMIT.
- 3. THE LANDSCAPE INSTALLATION SHALL COMPLY WITH APPROVED LANDSCAPE DRAWINGS PRIOR TO FINAL ACCEPTANCE BY THE CITY AND ISSUANCE OF A CERTIFICATE OF OCCUPANCY.
- 4. WATER METERS, CLEANOUTS AND OTHER APPURTENANCES, SHALL BE ACCESSIBLE, ADJUSTED TO GRADE, CLEARLY MARKED WITH FLAGGING AND COMPLIANT WITH PUBLIC WORKS DEPARTMENT STANDARDS PRIOR TO CALLING FOR FINAL LANDSCAPE AND ROW INSPECTIONS.

LANDSCAPE STANDARDS:

1. PLANTINGS AND LANDSCAPE ELEMENTS SHALL COMPLY WITH THE CITY'S ENGINEERING DESIGN

STANDARDS, PUBLIC R.O.W. VISIBILITY REQUIREMENTS.

2. UNLESS OTHERWISE SPECIFIED, TREES SHALL BE PLANTED NO LESS THAN 4' FROM CURBS, SIDEWALKS, UTILITY LINES, SCREENING WALLS AND OTHER STRUCTURES. THE CITY HAS FINAL APPROVAL FOR ALL TREE PLACEMENTS.

3. A MINIMUM THREE FEET (3') RADIUS AROUND A FIRE HYDRANT MUST REMAIN CLEAR OF LANDSCAPE PURSUANT TO THE FIRE CODE.

4. STREET TREES, WHERE REQUIRED, SHALL BE (10') MINIMUM FROM THE EDGE OF A STORM SEWER CURB INLET BOX AND THE EDGE OF THE ROOT BALL SHALL BE (4') MINIMUM FROM THE WATER

5. THE AMERICAN STANDARD FOR NURSERY STOCK (ANSI Z60.1-2004) SPECIFICATIONS SHALL GOVERN PLANT QUALIFICATIONS, GRADES, AND STANDARDS. 6. TREE PLANTING SHALL COMPLY WITH DETAILS HEREIN AND THE INTERNATIONAL SOCIETY OF

ARBORICULTURE (ISA) STANDARDS. 7. A 2-3" LAYER OF MULCH SHALL BE PROVIDED AROUND THE BASE OF THE PLANTED TREE. THE

MULCH SHALL BE PULLED BACK 4" FROM THE TRUNK OF THE TREE.

8. TREE PITS SHALL BE TESTED FOR WATER PERCOLATION. IF WATER DOES NOT DRAIN OUT OF TREE PIT WITHIN 24-HOURS, THE TREE SHALL BE MOVED OR DRAINAGE SHALL BE PROVIDED.

9. ALL BEDS TO HAVE 3" OF COMPOSTED SOIL, LIVING EARTH TECHNOLOGY, OR APPROVED EQUAL

TILLED AND TURNED TO A DEPTH OF 8" MINIMUM. 10. ALL PLANT BEDS SHALL BE TOP-DRESSED WITH A MINIMUM OF 3 INCHES OF HARDWOOD MULCH.

11. NATIVE SITE TOPSOIL IS TO BE PROTECTED FROM EROSION OR STOCKPILED. NATIVE SITE TOPSOIL SHALL BE LABORATORY TESTED BY AND ACCREDITED LABORATORY AND AMENDED PER SAID LABORATORY'S RECOMMENDATIONS.

IRRIGATION STANDARDS:

- 1. ANY CHANGES TO THESE APPROVED IRRIGATION DRAWINGS SHALL BE AUTHORIZED BY THE CITY. 2. CONTACT DEVELOPMENT SERVICES FOR AN IRRIGATION PERMIT PRIOR TO INSTALLING THE IRRIGATION SYSTEM.
- 3. IRRIGATION OVER-SPRAY ON STREETS AND WALKS IS PROHIBITED.
- 4. MAINLINES, VALVES, OR CONTROL WIRES SHALL NOT BE LOCATED IN THE CITY'S ROW.
- 5. ET IRRIGATION CONTROLLERS SHALL BE PROGRAMMED AND ADJUSTED TO NOT EXCEED THE LANDSCAPE WATER ALLOWANCE (LWA) PRIOR TO APPROVAL OF LANDSCAPE INSTALLATION. 6. VALVES SHALL BE LOCATED A MINIMUM OF (3') AWAY FROM STORM SEWERS, AND SANITARY SEWER
- LINES AND 5 FEET FROM CITY FIRE HYDRANTS AND WATER VALVES. 7. THE BORE DEPTH UNDER STREETS, DRIVE AISLES, AND FIRE LANES SHALL PROVIDE (2') OF
- CLEARANCE (MINIMUM). 8. IRRIGATION HEADS THAT RUN PARALLEL AND NEAR PUBLIC WATER AND SANITARY SEWER LINES; SHALL BE FED FROM STUBBED LATERALS OR BULL-BEADS. A MINIMUM FIVE FOOT (5') SEPARATION IS REQUIRED BETWEEN IRRIGATION MAIN LINES AND LATERALS THAT RUN PARALLEL TO PUBLIC
- WATER AND SANITARY SEWER LINES. 9. NO VALVES, BACKFLOW PREVENTION ASSEMBLIES, QUICK COUPLERS ETC. SHALL BE LOCATED CLOSER THAN 10' FROM THE CURB AT STREET OR DRIVE INTERSECTION.

MAINTENANCE STANDARDS:

1. THE OWNER SHALL BE RESPONSIBLE FOR THE ESTABLISHMENT, MAINTENANCE, AND VIGOR OF PLANT MATERIAL IN ACCORDANCE WITH THE DESIGN INTENT AND AS APPROPRIATE FOR THE

2. LANDSCAPE AND OPEN AREAS SHALL BE FREE OF TRASH, LITTER AND WEEDS.

3. NO PLANT MATERIAL SHALL BE ALLOWED TO ENCROACH ON R.O.W., SIDEWALKS OR EASEMENTS TO THE EXTENT THAT VISION OR ROUTE OF TRAVEL FOR VEHICULAR, PEDESTRIAN, OR BICYCLE

4. TREE MAINTENANCE SHALL BE IN ACCORDANCE WITH THE STANDARDS OF THE INTERNATIONAL SOCIETY OF ARBORICULTURE.

5. TREE STAKING MATERIALS, IF USED, SHALL BE REMOVED AFTER (1) GROWING SEASON, NO MORE THAN (1) YEAR AFTER INSTALLATION (STEEL TREE STAKES, WIRES, AND HOSES ARE PROHIBITED).

TREE PROTECTION NOTES:

1. CONTACT DEVELOPMENT SERVICES FOR A TREE REMOVAL PERMIT PRIOR TO REMOVAL OR

TRANSPLANTING OF ANY TREES. 2. ALL TREES WHICH ARE TO REMAIN ON SITE SHALL BE PROTECTED WITH A (4') TALL BRIGHTLY

COLORED PLASTIC FENCE, OR SILT FENCE, PLACED AT THE DRIP LINE OF THE TREES.

3. PRIOR TO THE PRE-CONSTRUCTION MEETING OR OBTAINING A GRADING PERMIT, ALL TREE

MARKINGS AND PROTECTIVE FENCING SHALL BE INSTALLED BY THE OWNER AND BE INSPECTED BY DEVELOPMENT SERVICES. 4. NO EQUIPMENT SHALL BE CLEANED, OR HARMFUL LIQUIDS DEPOSITED WITHIN THE LIMITS OF THE

ROOT ZONE OF TREES WHICH REMAIN ON SITE.

5. NO SIGNS, WIRES, OR OTHER ATTACHMENTS SHALL BE ATTACHED TO ANY TREE TO REMAIN ON

6. VEHICULAR AND CONSTRUCTION EQUIPMENT SHALL NOT PARK OR DRIVE WITHIN THE LIMITS OF

7. GRADE CHANGES IN EXCESS OF 3 INCHES (CUT OR FILL) SHALL NOT BE ALLOWED WITHIN A ROOT ZONE, UNLESS ADEQUATE TREE PRESERVATION METHODS ARE APPROVED BY THE CITY.

8. NO TRENCHING SHALL BE ALLOWED WITHIN THE DRIP-LINE OF A TREE, UNLESS APPROVED BY THE

9. ALL REMOVED TREES SHALL BE CHIPPED AND USED FOR MULCH ON SITE OR HAULED OFF-SITE.

10. ALL TREE MAINTENANCE TECHNIQUES SHALL BE IN CONFORMANCE WITH INDUSTRY IDENTIFIED STANDARDS. IMPROPER OR MALICIOUS PRUNING TECHNIQUES ARE STRICTLY PROHIBITED.






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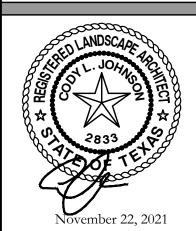
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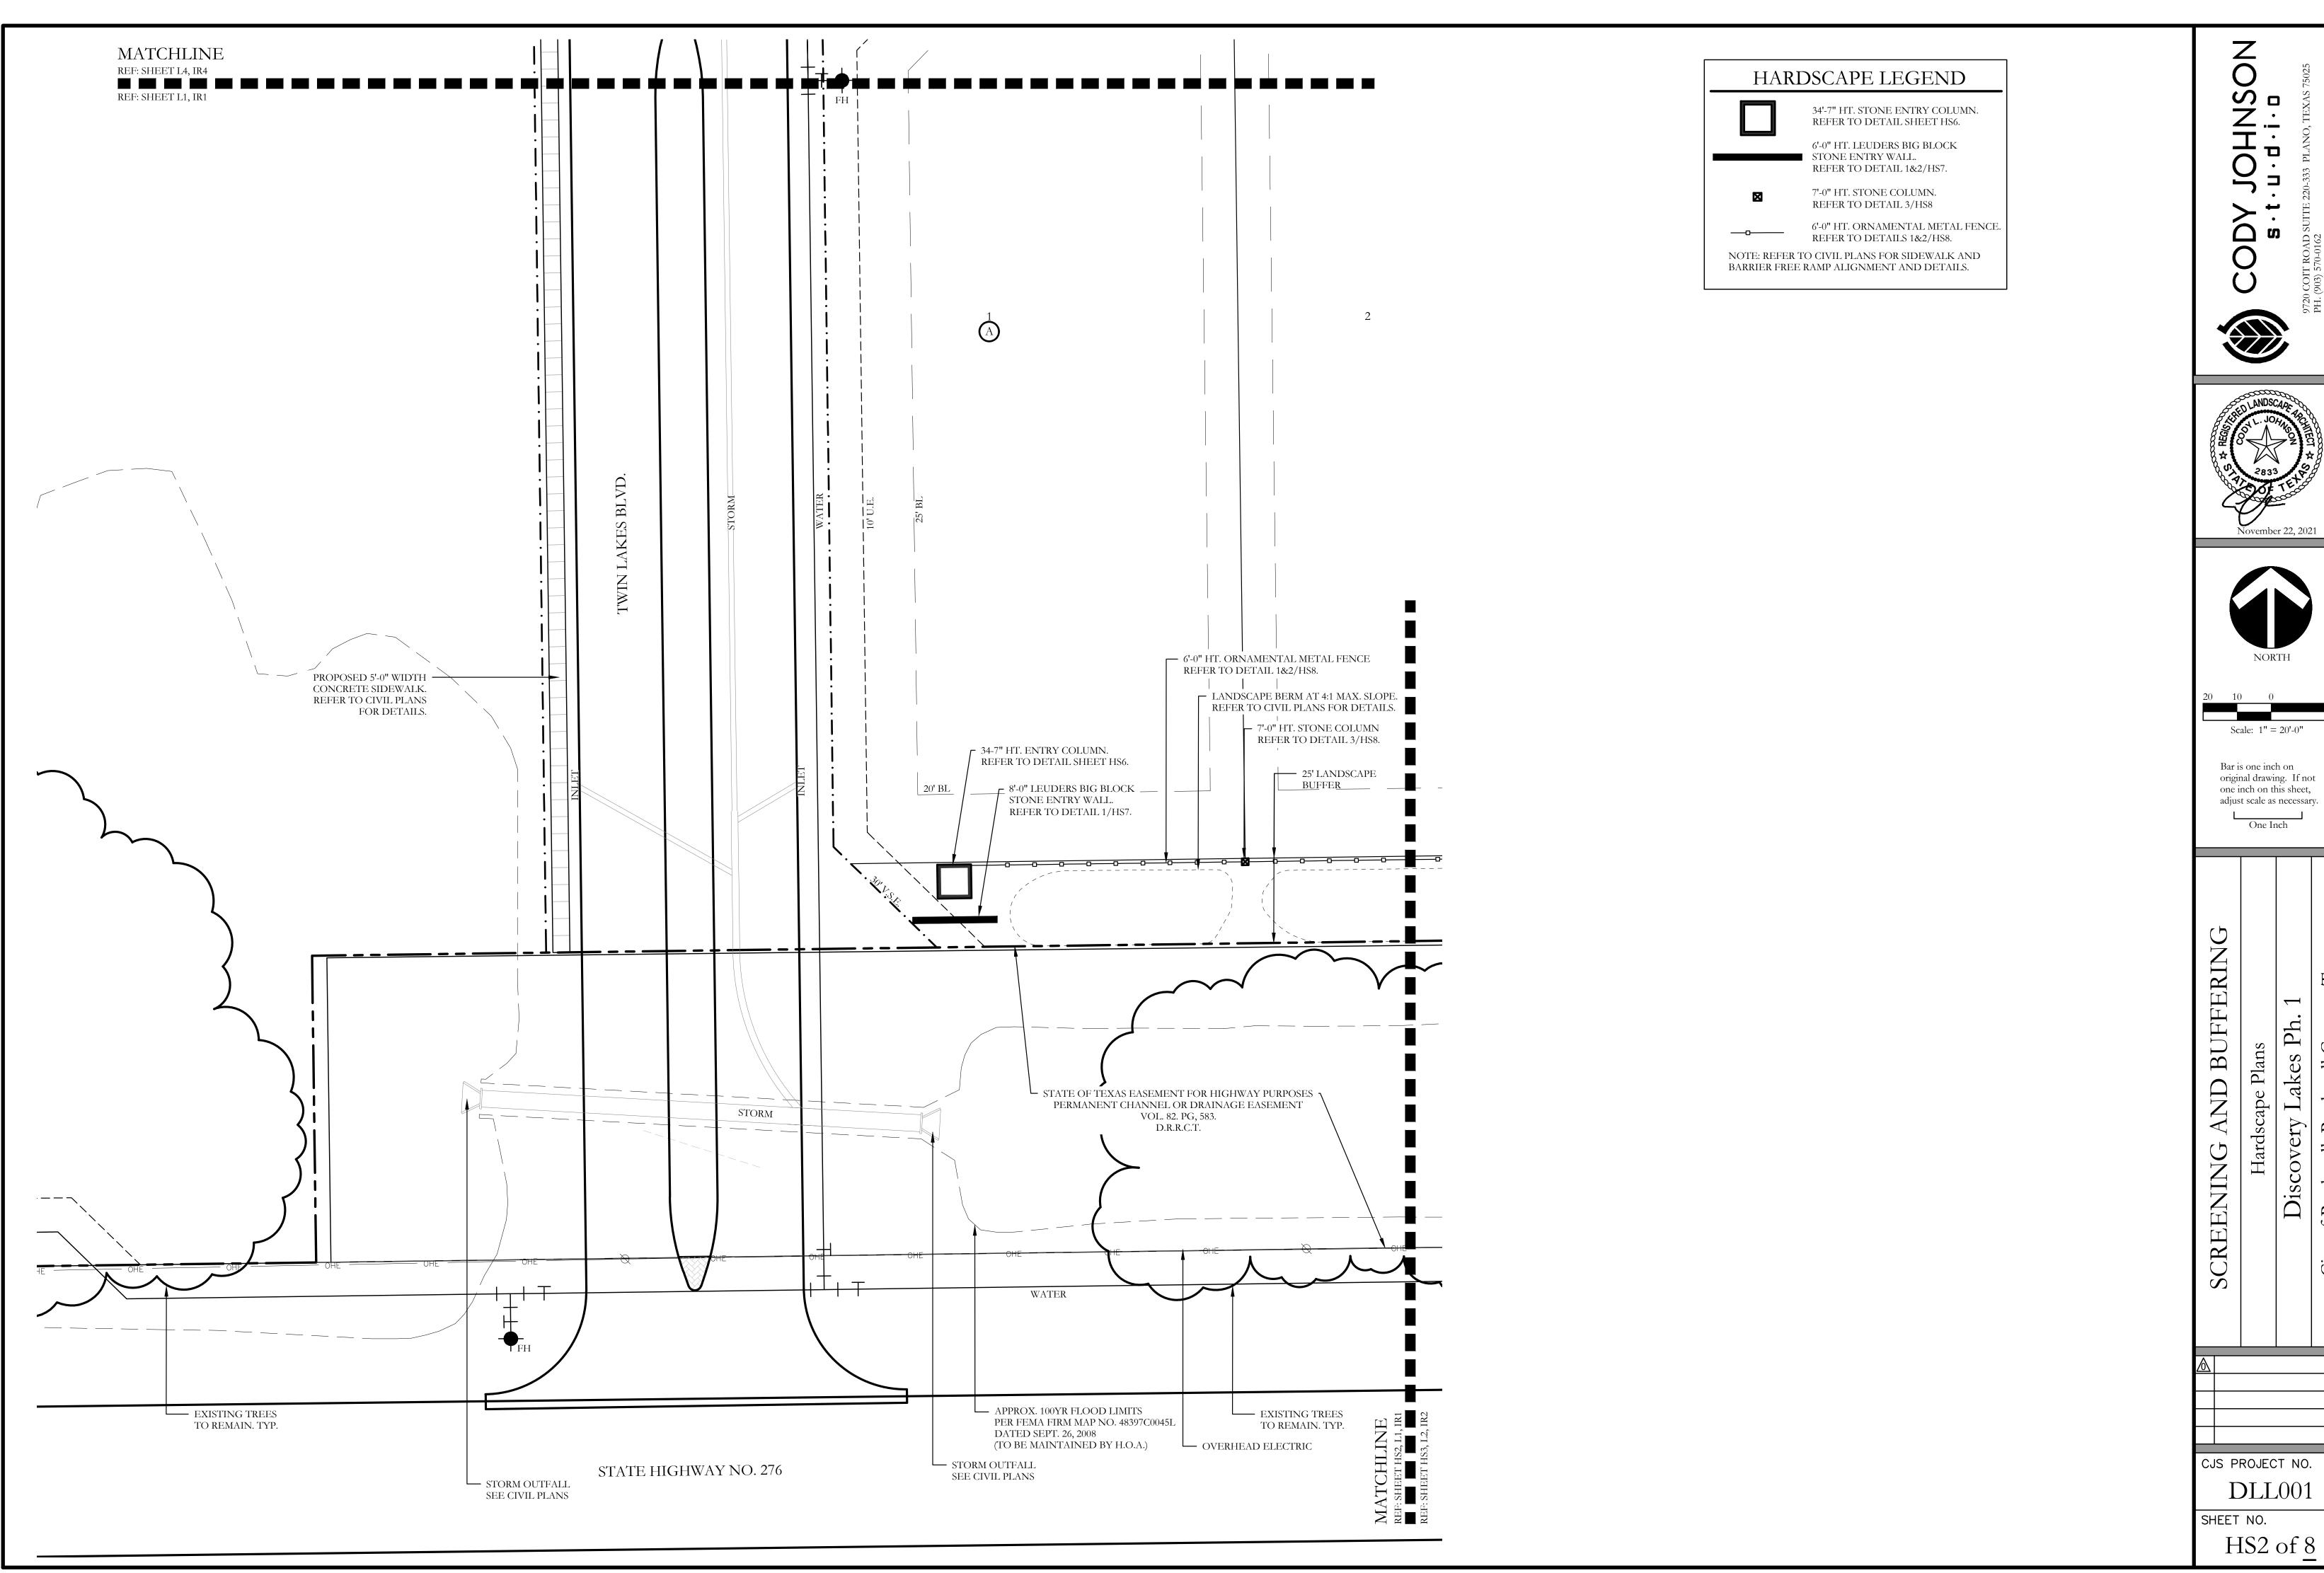


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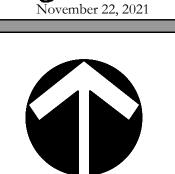
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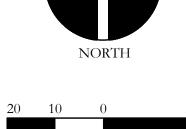
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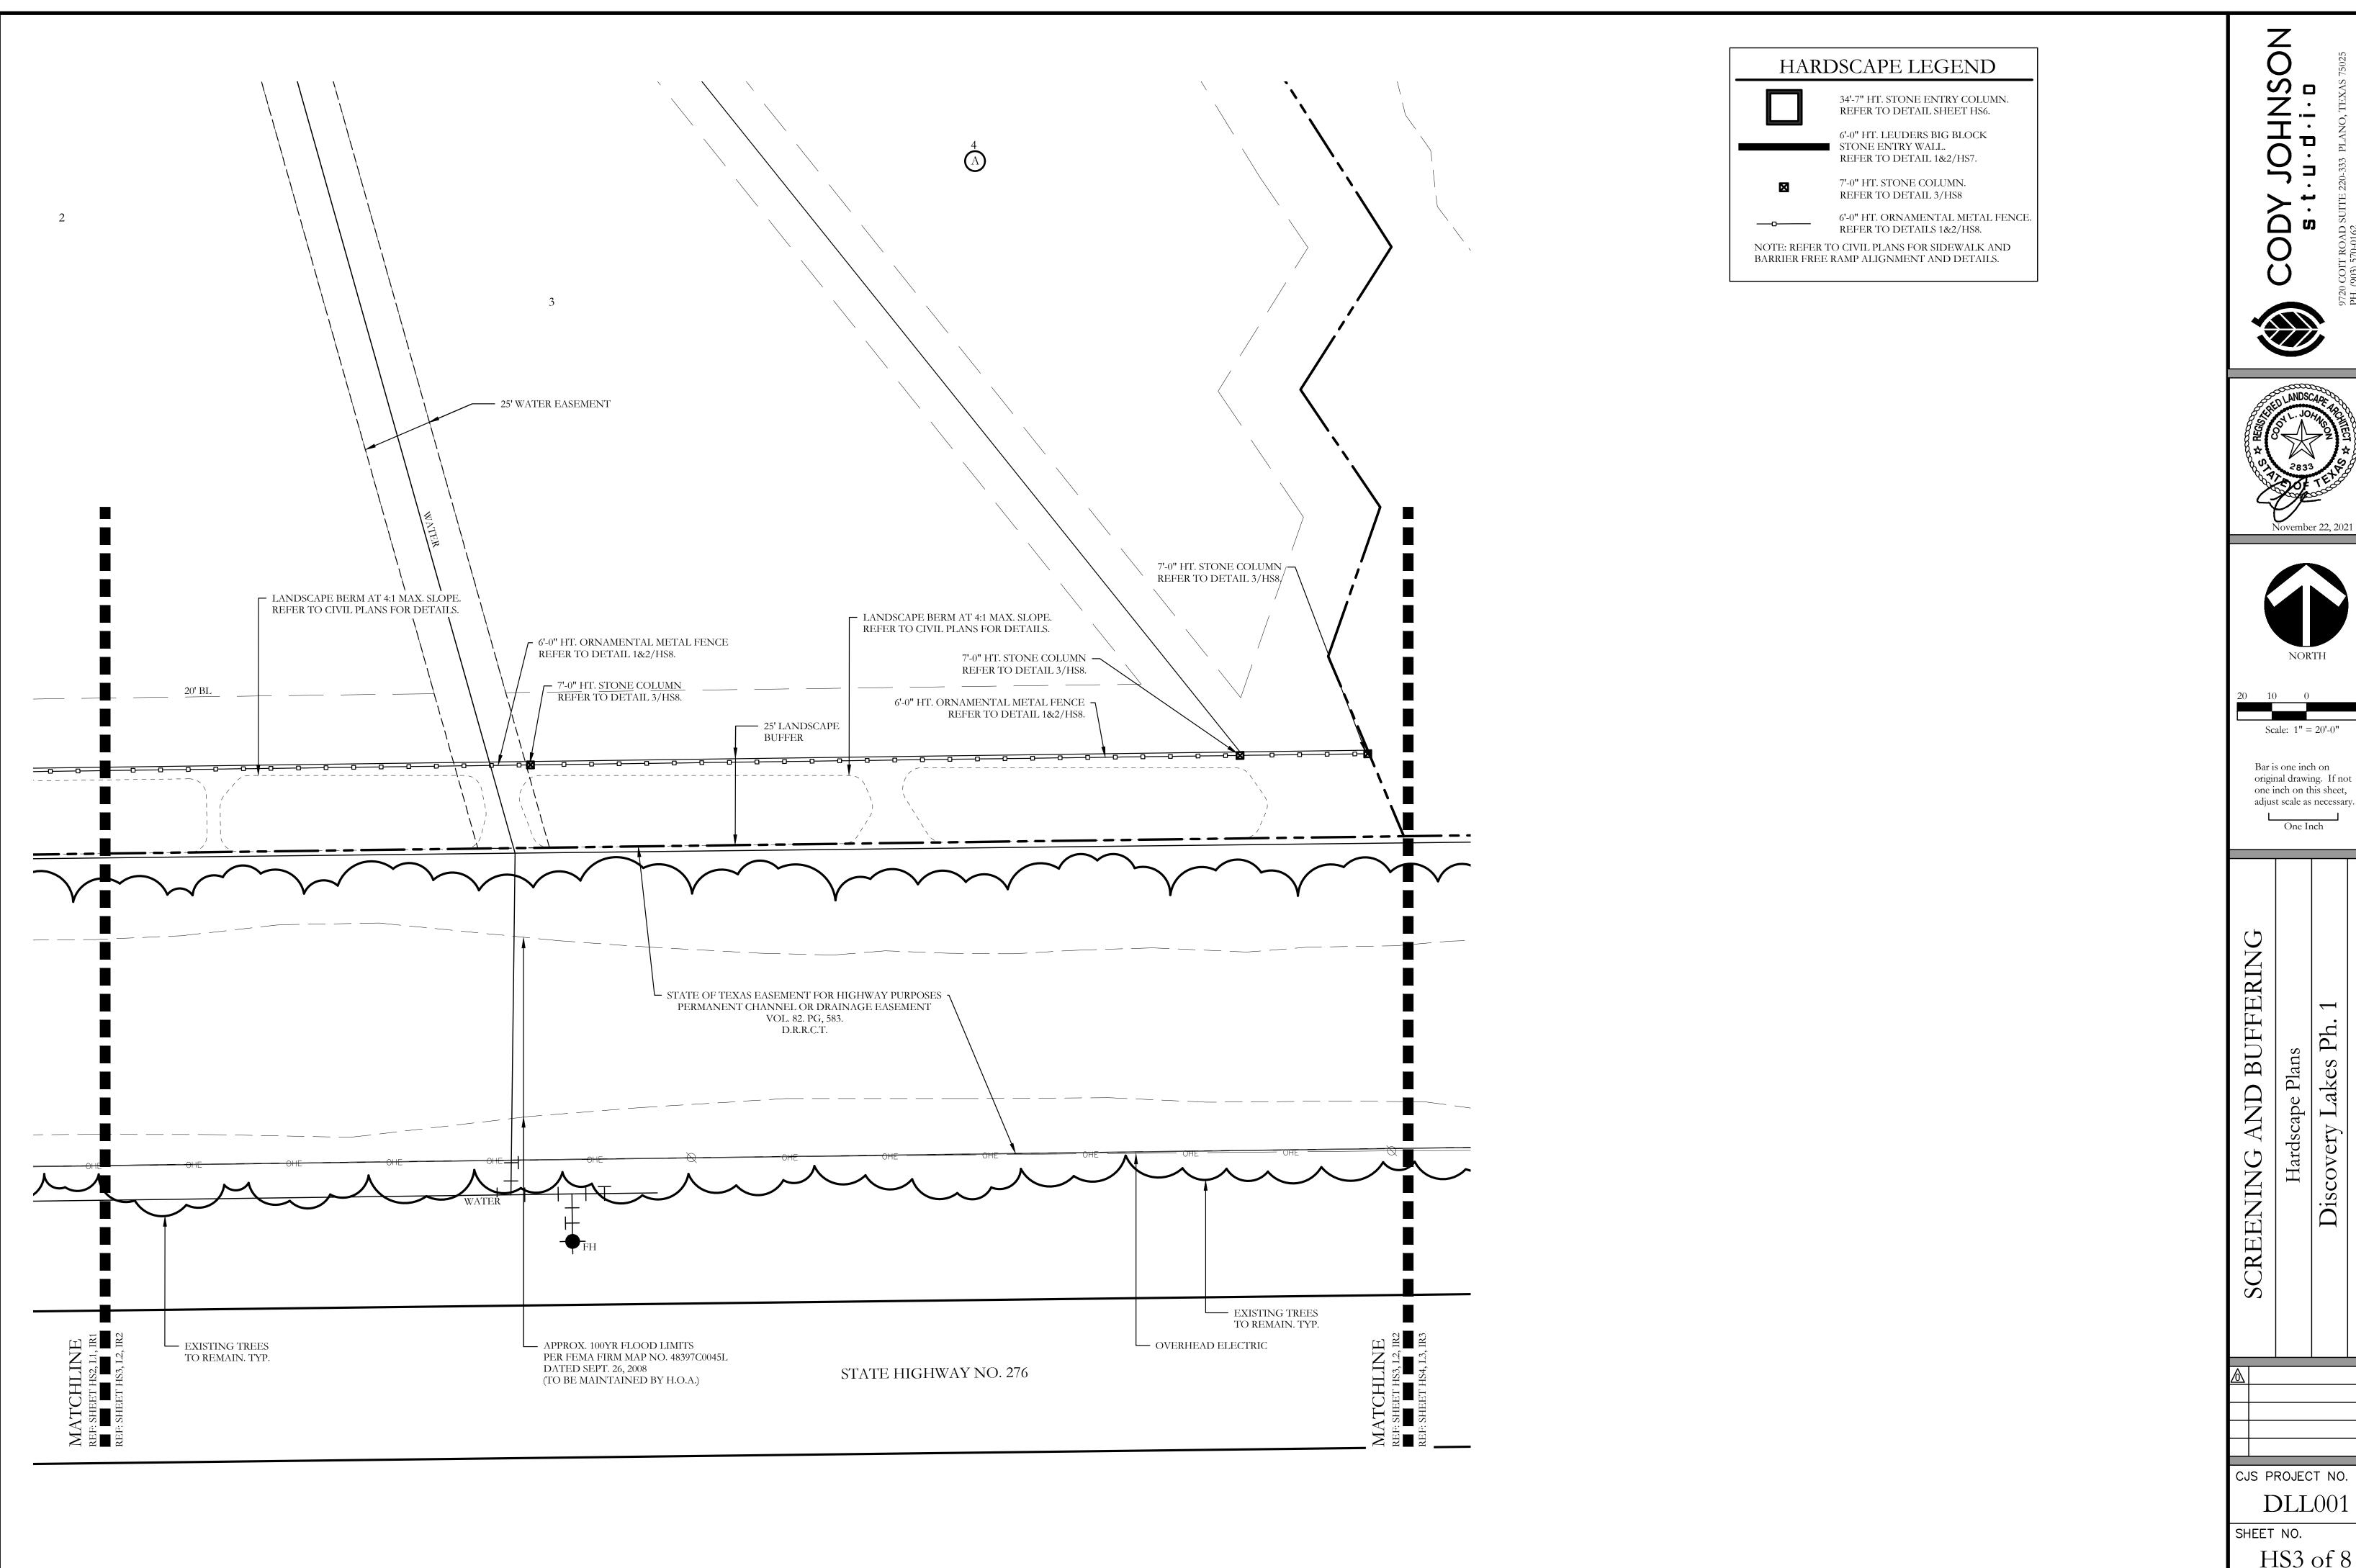


Scale: 1'' = 20'-0''


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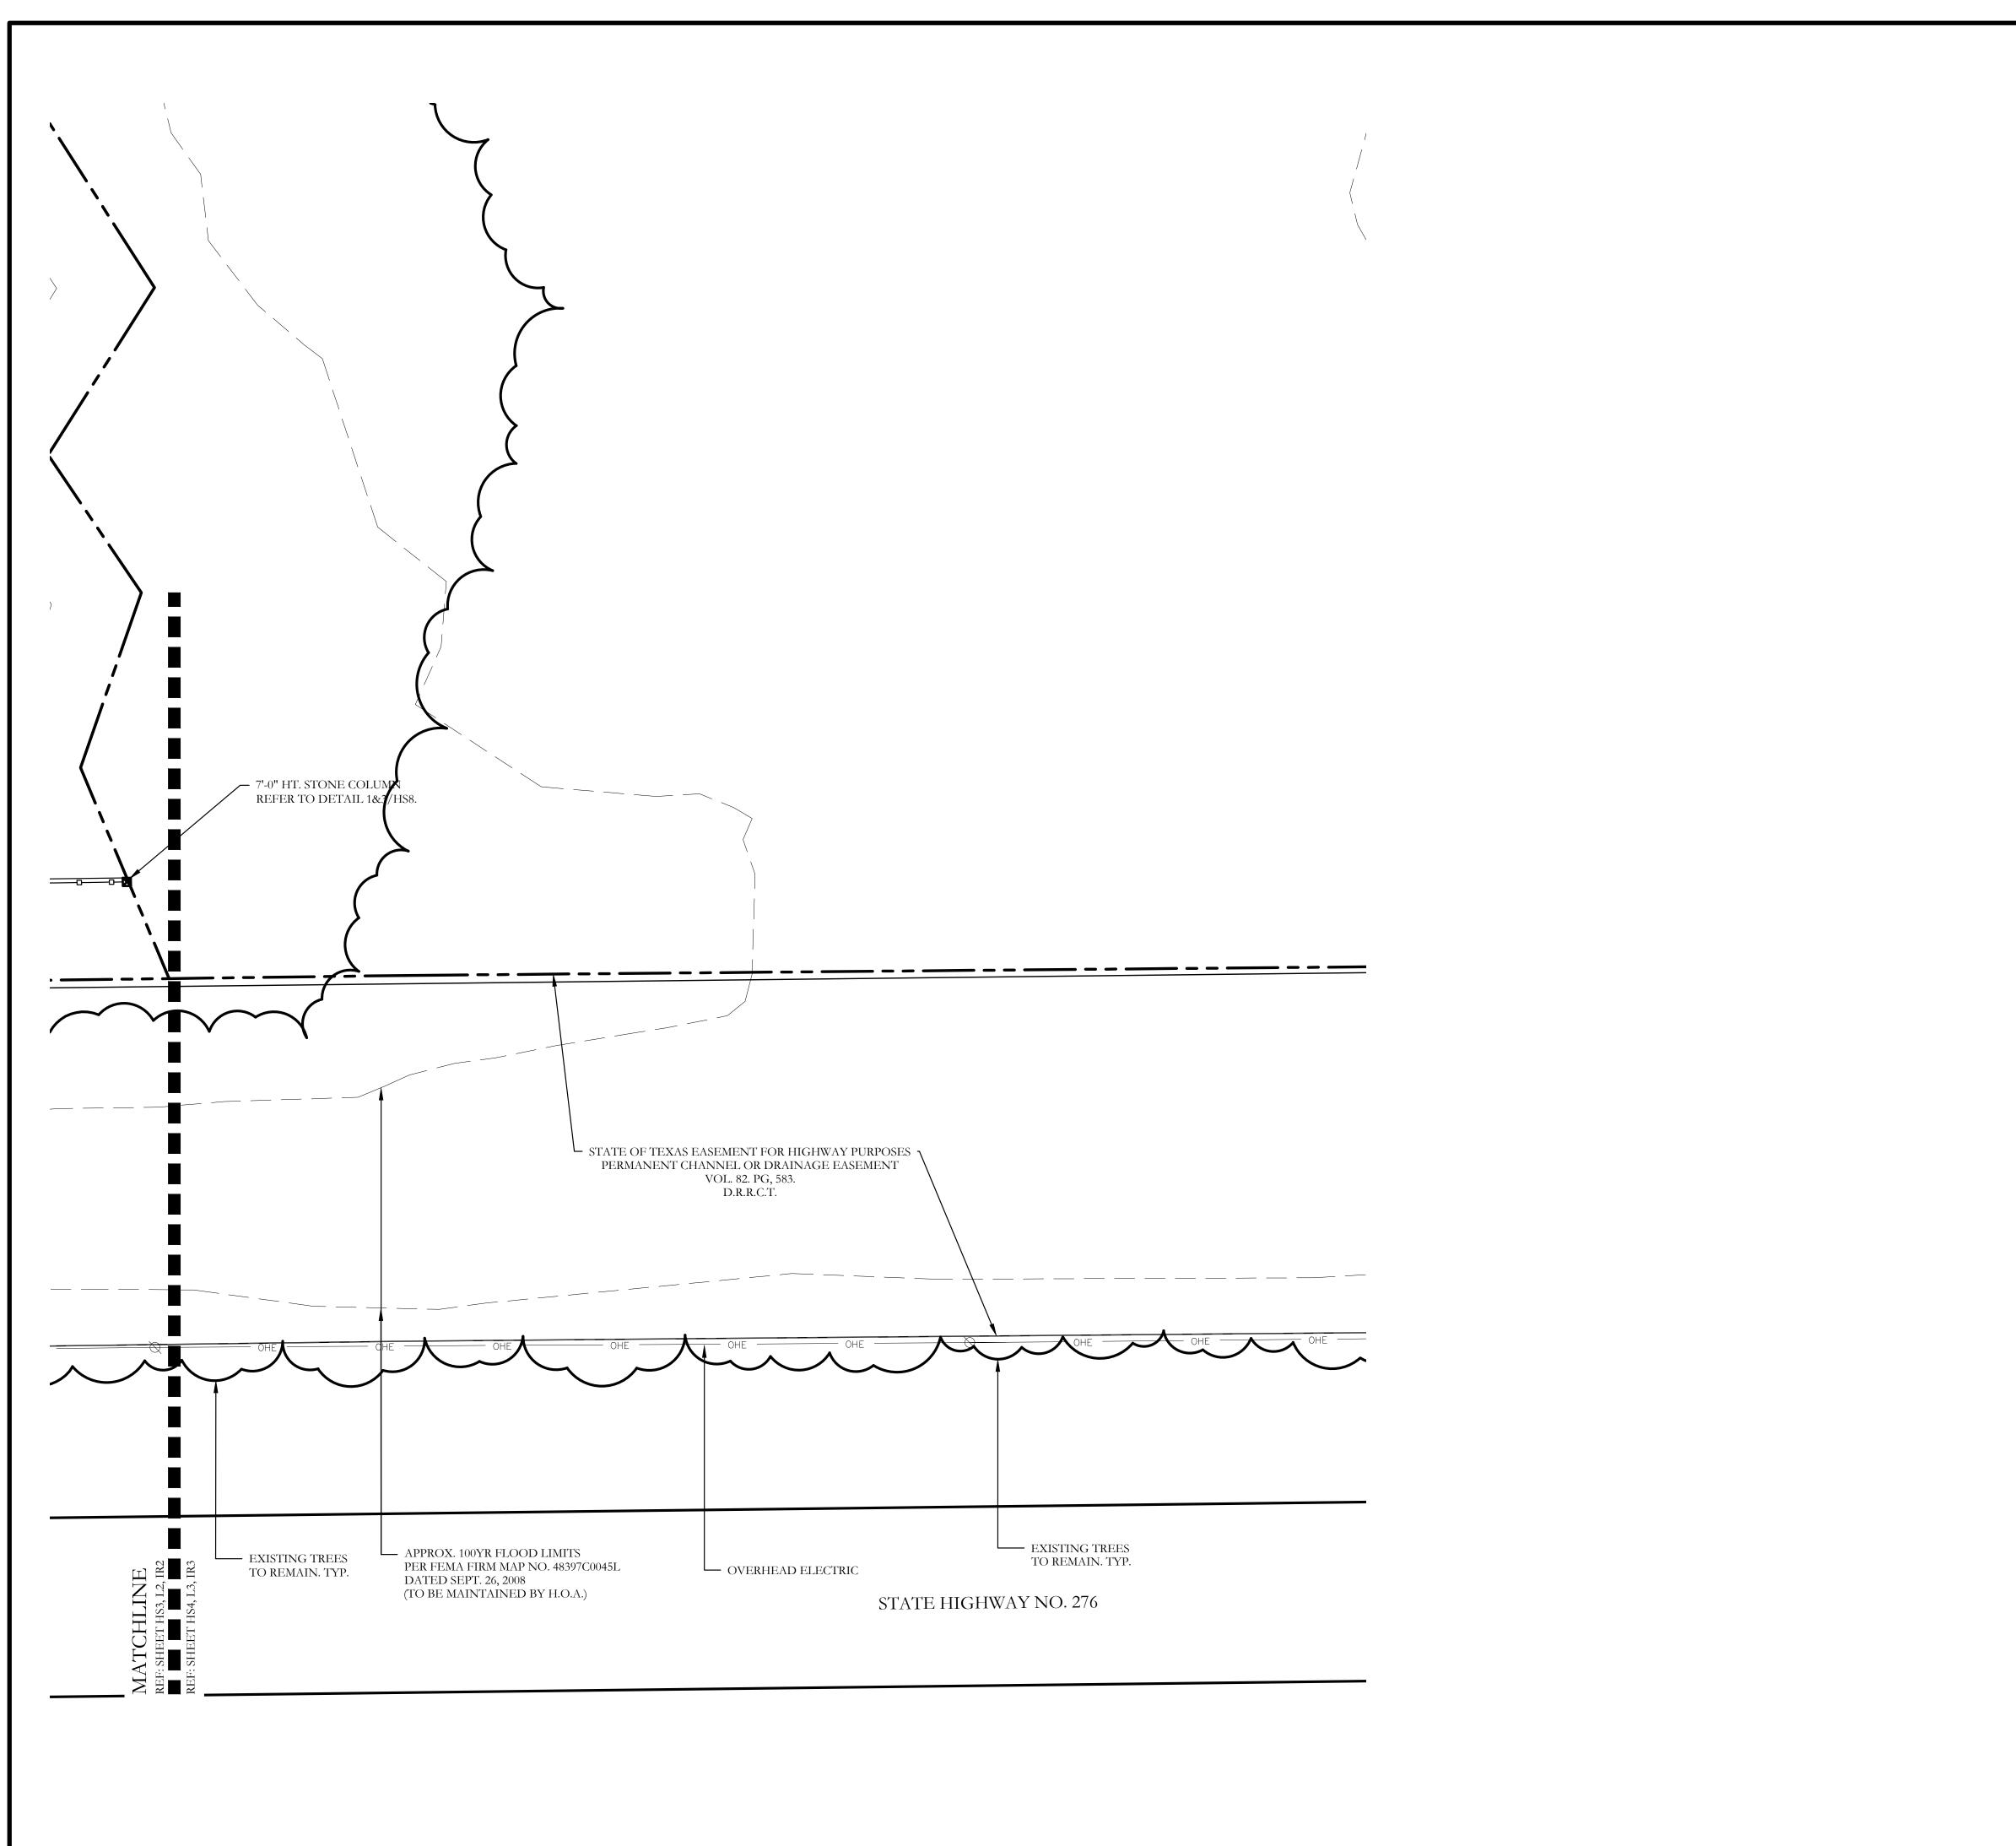


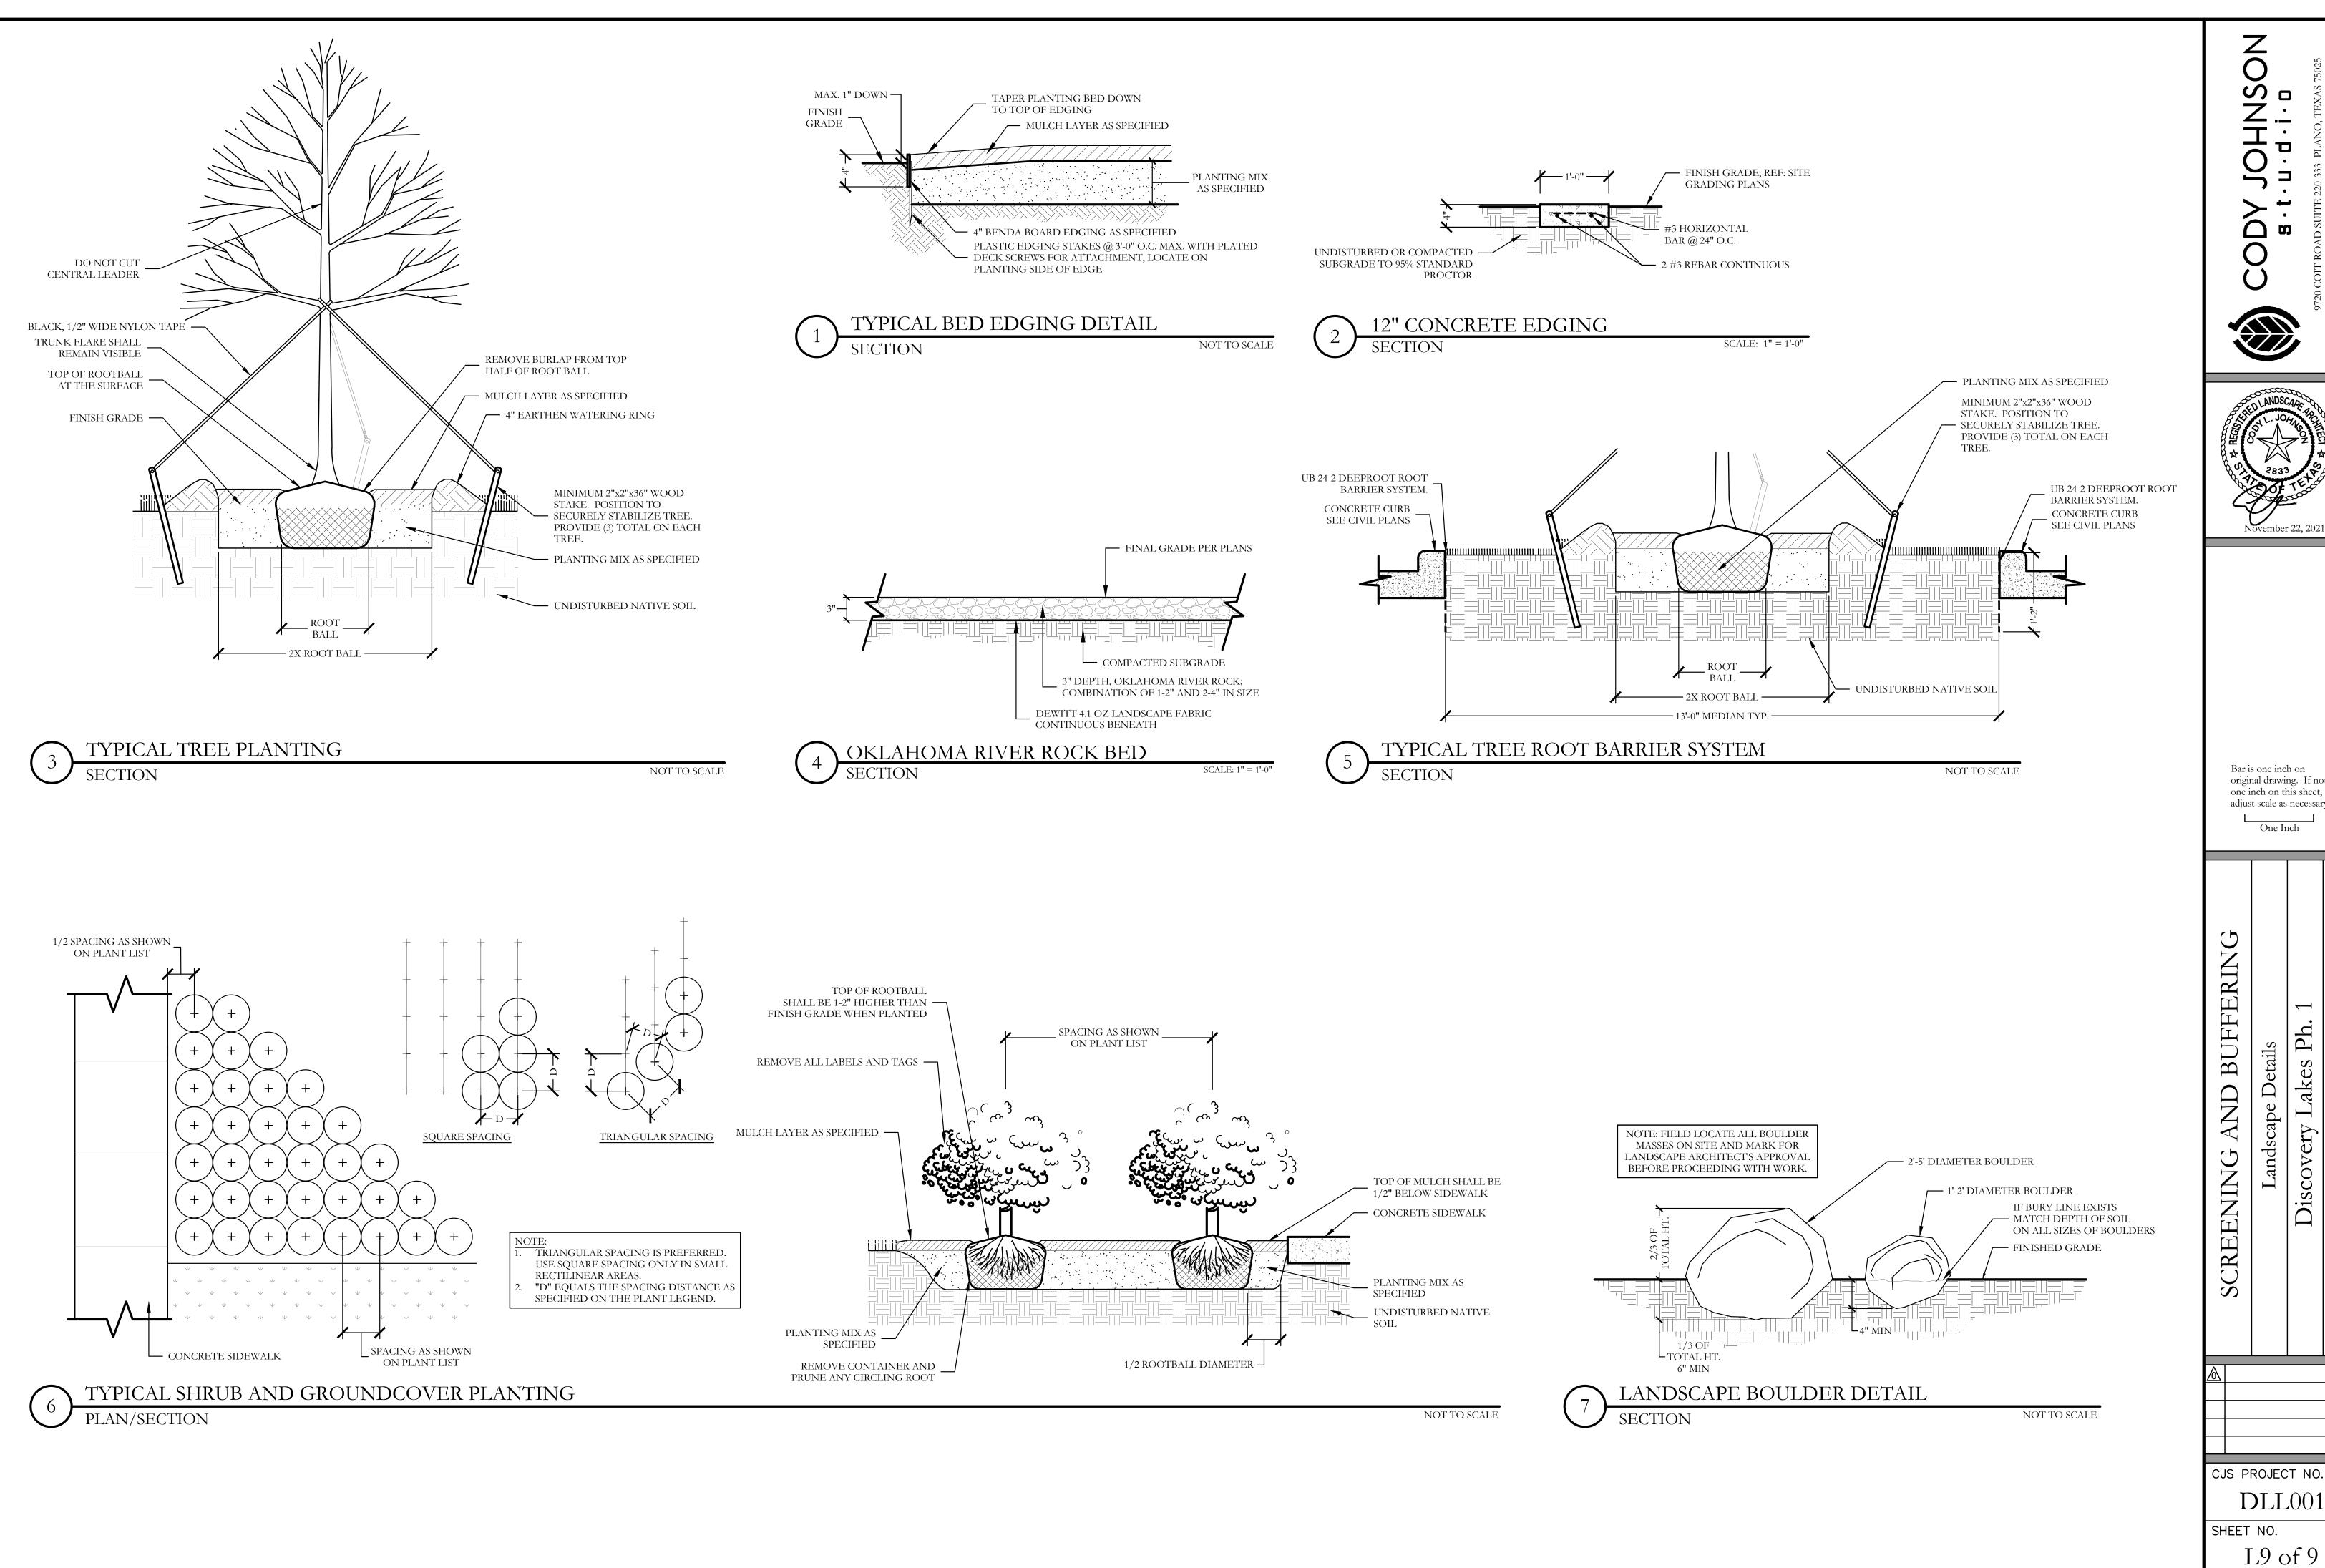

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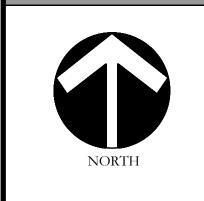
HS3 of 8




HARDSCAPE LEGEND 34'-7" HT. STONE ENTRY COLUMN. REFER TO DETAIL SHEET HS6. 6'-0" HT. LEUDERS BIG BLOCK STONE ENTRY WALL. REFER TO DETAIL 1&2/HS7. 7'-0" HT. STONE COLUMN. REFER TO DETAIL 3/HS8 6'-0" HT. ORNAMENTAL METAL FENCE. REFER TO DETAILS 1&2/HS8.
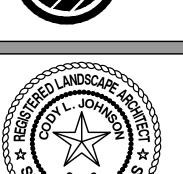
> NOTE: REFER TO CIVIL PLANS FOR SIDEWALK AND BARRIER FREE RAMP ALIGNMENT AND DETAILS.





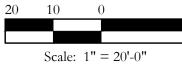


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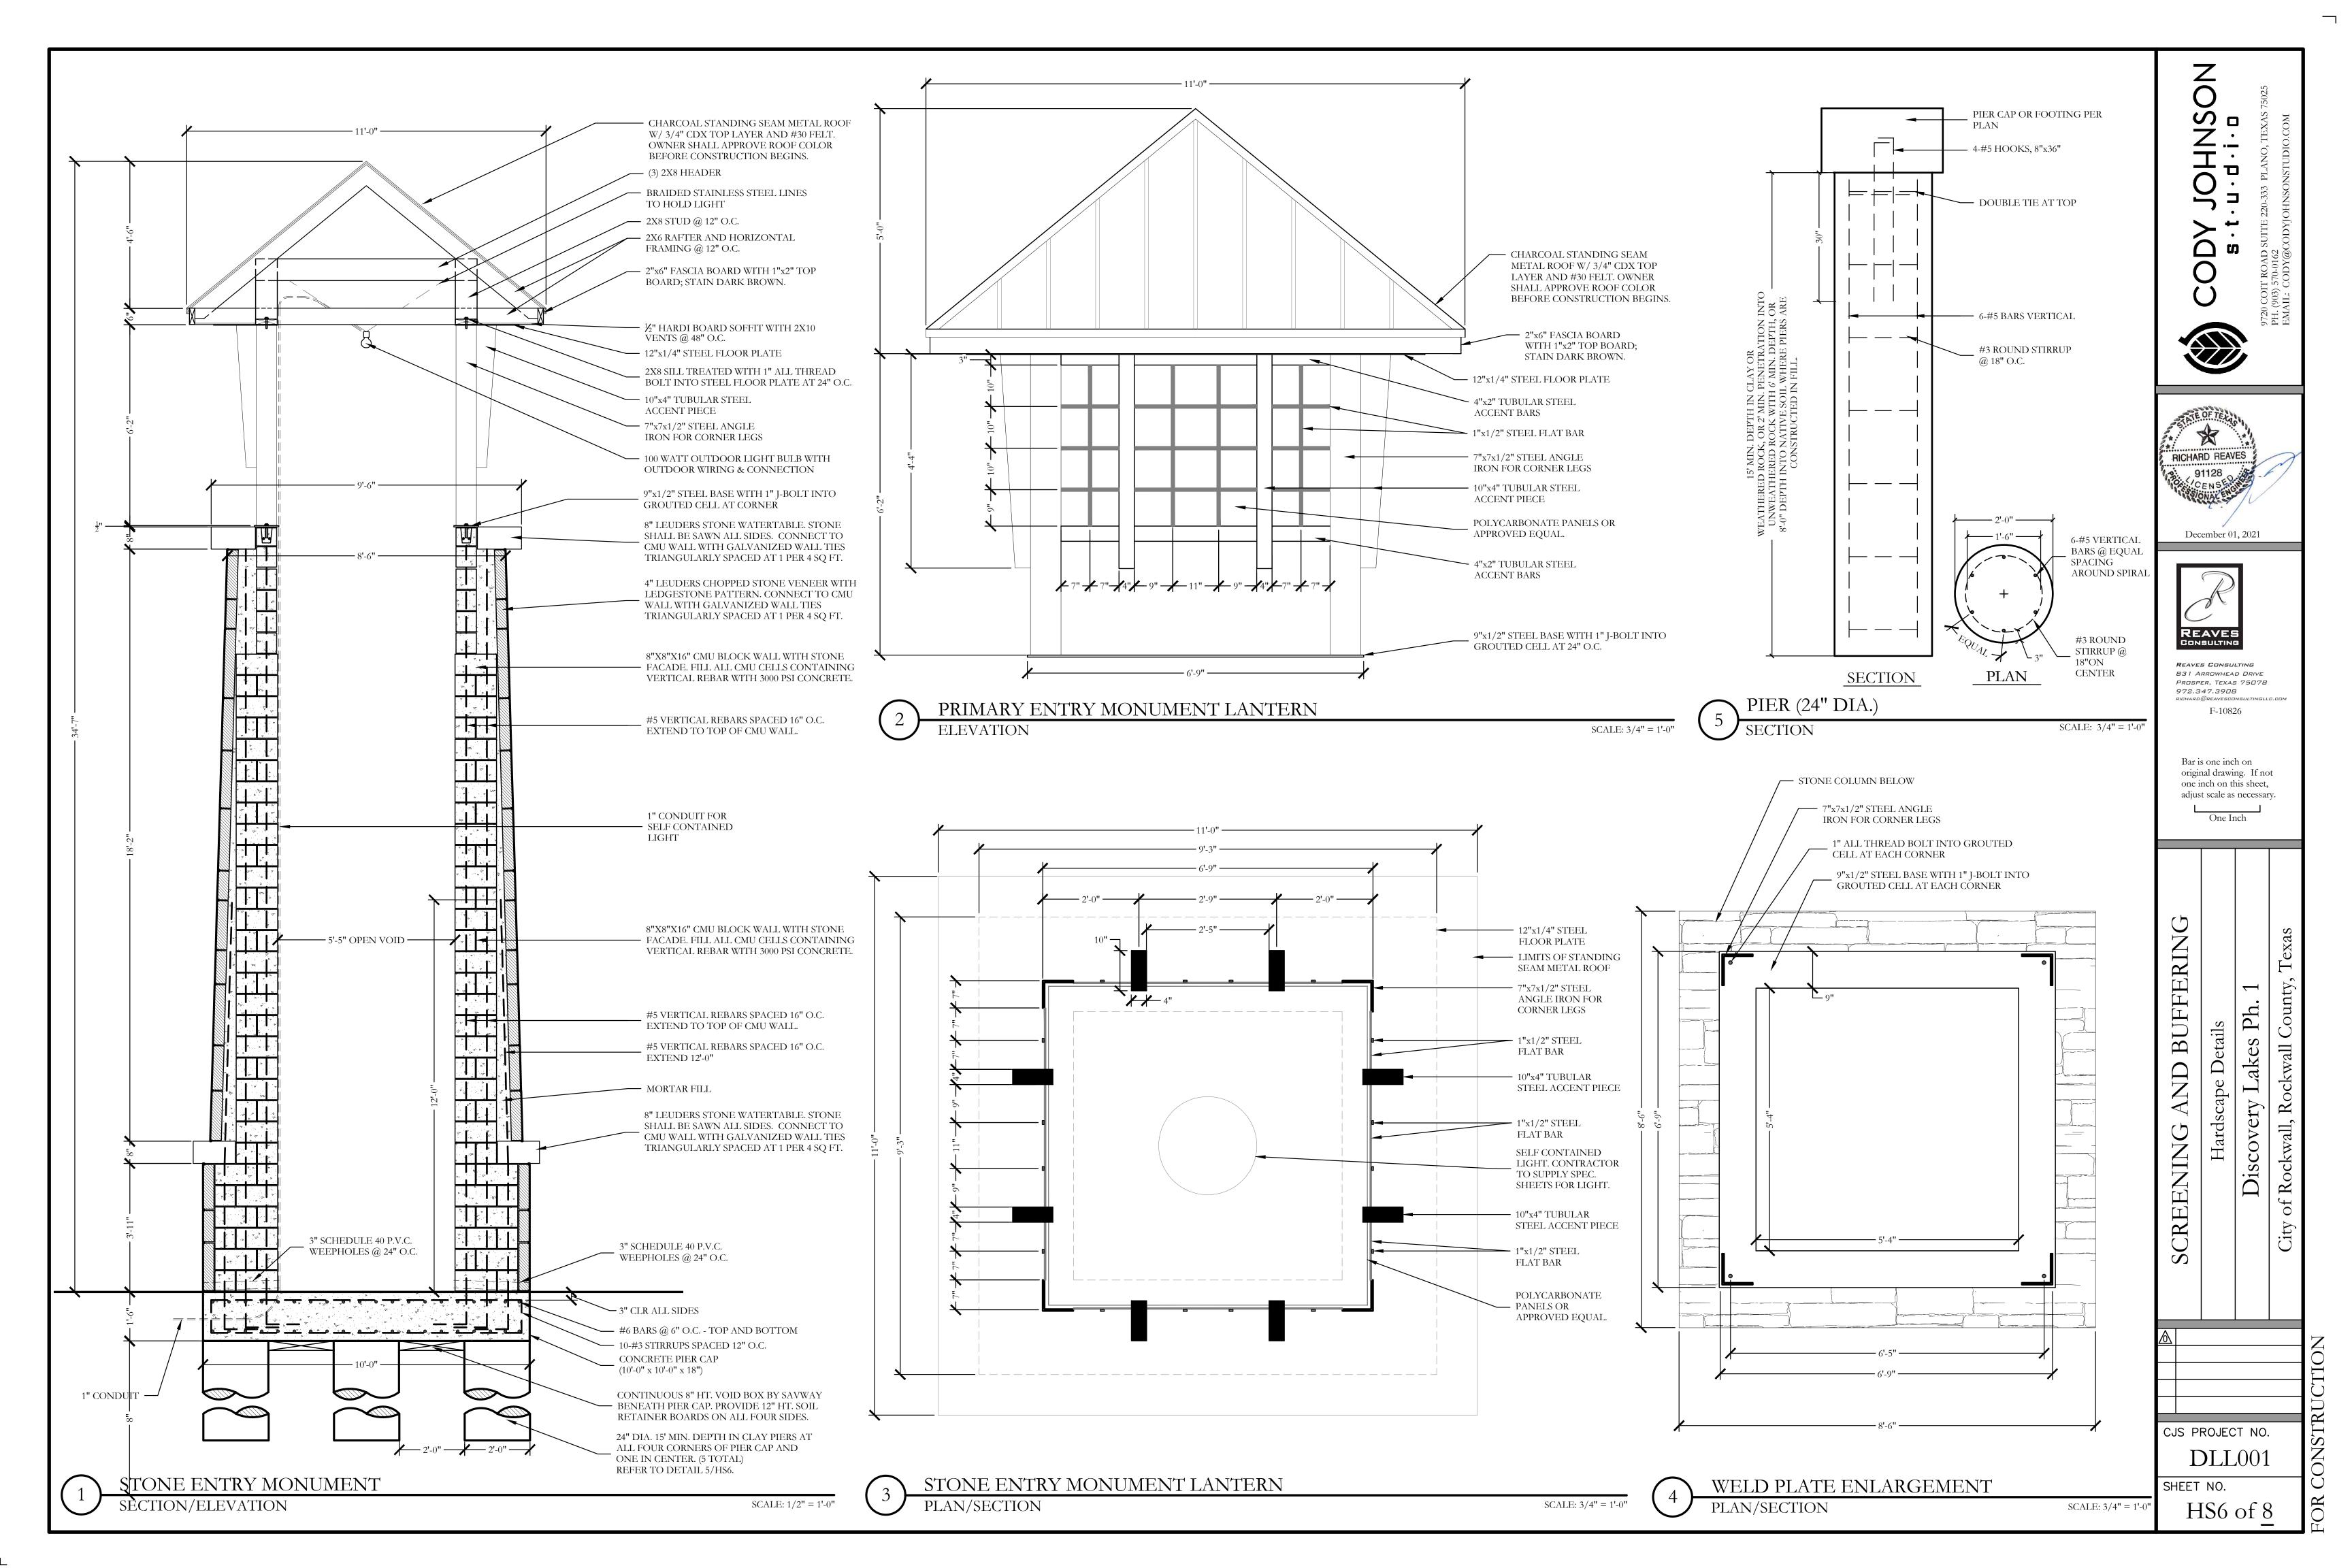
HS4 of <u>8</u>


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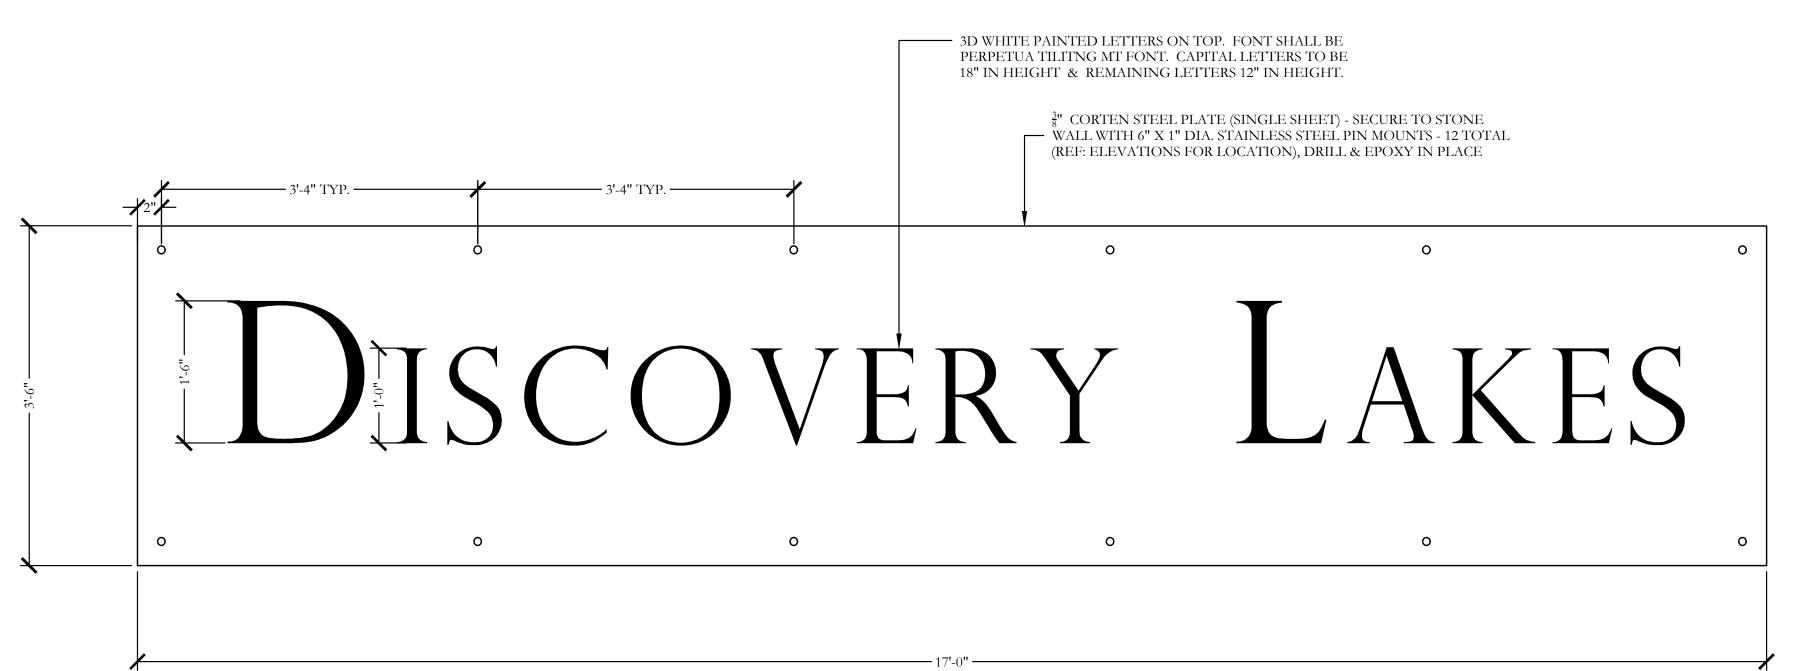




HS5 of <u>8</u>



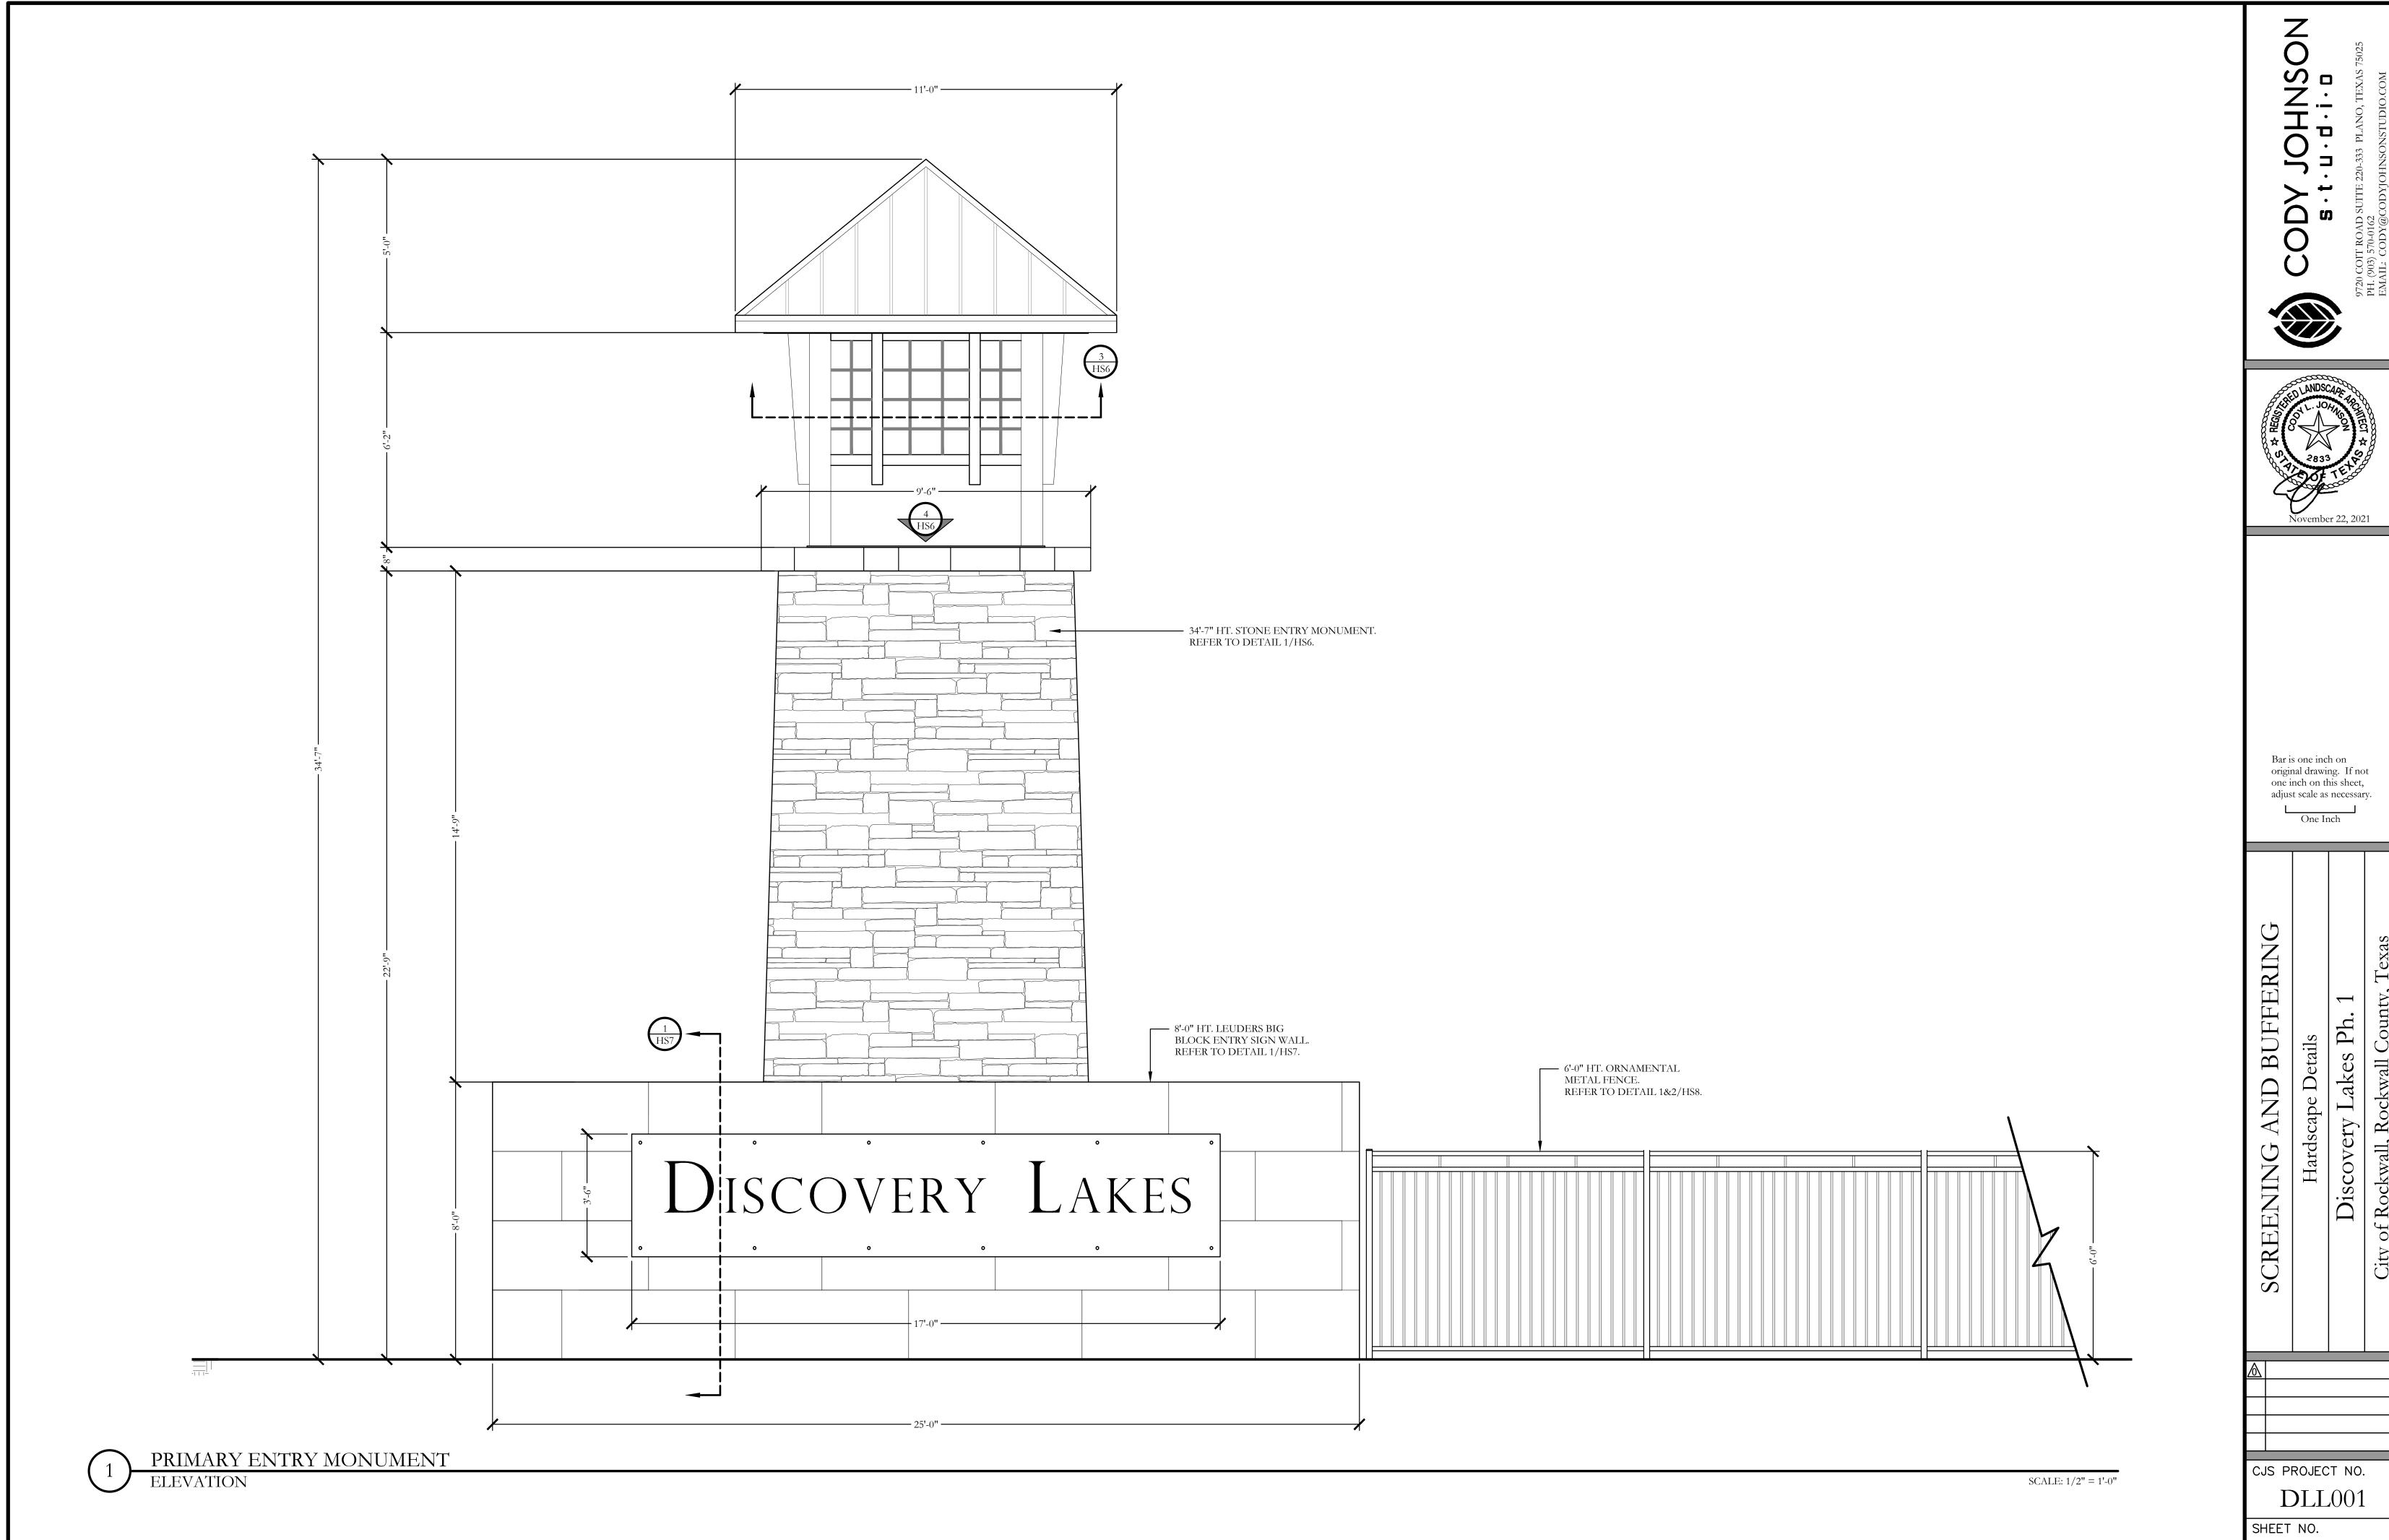

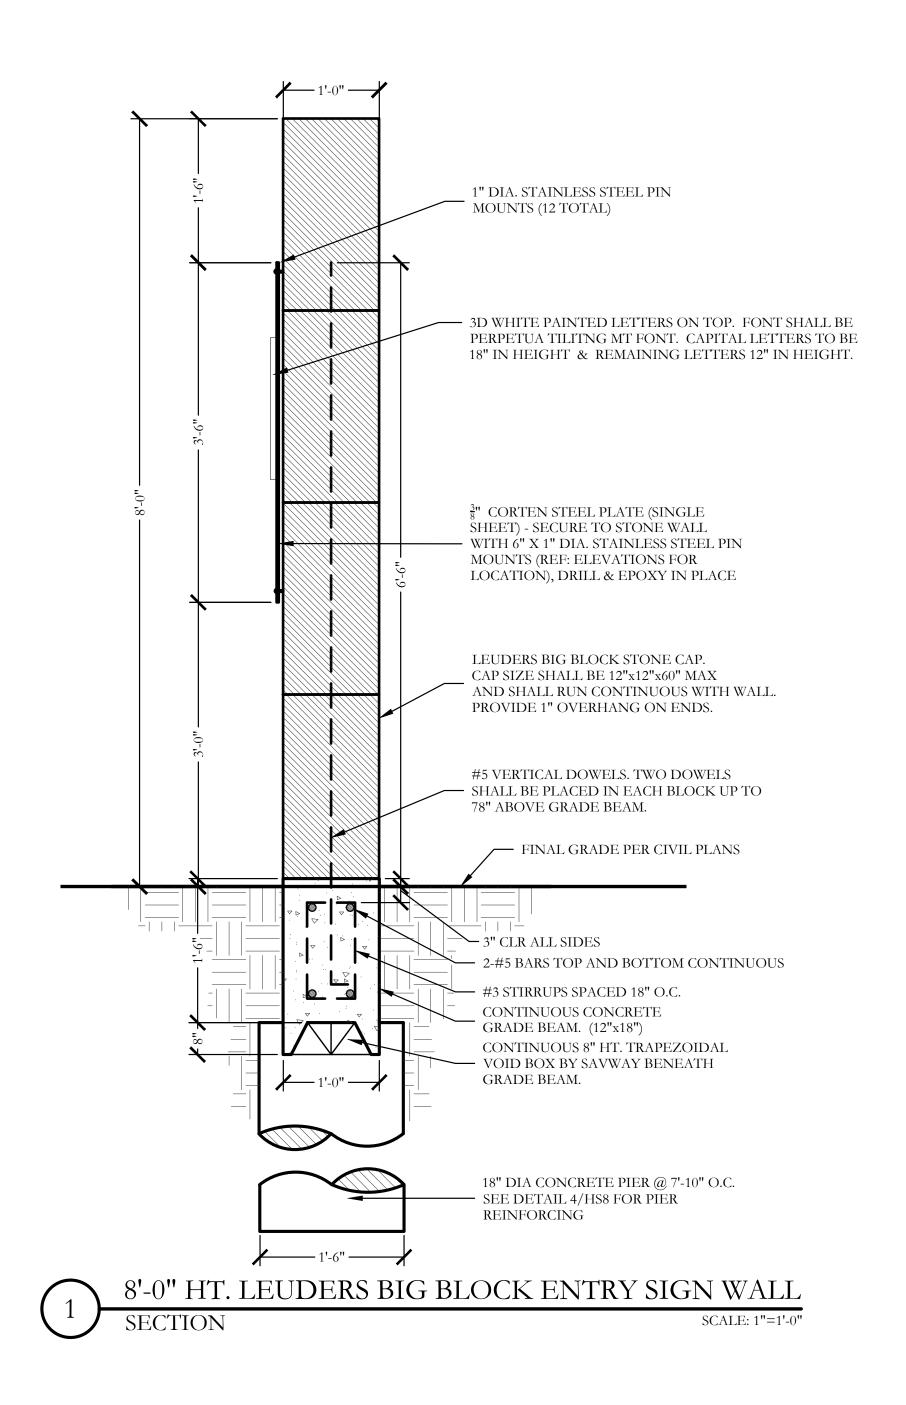

CORTEN SIGN PANEL & LETTING

REAVES CONSULTING REAVES CONSULTING 831 ARROWHEAD DRIVE PROSPER, TEXAS 75078 972.347.3908 F-10826 Bar is one inch on original drawing. If not one inch on this sheet, adjust scale as necessary. One Inch

SCALE: 1"=1'-0"

SCREENING AND BUFFERING $\overline{}$

December 01, 2021

Discovery Lakes Ph. Hardscape Details

CJS PROJECT NO. DLL001

SHEET NO.

HS7 of <u>8</u>

6'-0" HT. ORNAMENTAL METAL FENCE AND COLUMN

3-2" FLAGSTONE SLABS TO ACT AS

8"X8"X16" CMU BLOCK WITH STONE

FACADE. FILL ALL CMU CELLS WITH

2-2" FLAGSTONE SLABS TO ACT AS

2-#5 VERTICAL DOWELS EACH SIDE.

EXTEND TO TOP OF COLUMN.

- 2-#5 BARS TOP AND BOTTOM

8" HT. DONUT FORM VOID BOX BY - SAVWAY BENEATH PIER CAP WITH 12" HT. SOIL RETAINER BOARD.

SCALE: 3/4"=1'-0"

PROVIDE 4 BARS TOTAL.

FINAL GRADE

CONCRETE PIER CAP

18" DIA. CONCRETE PIER IN CENTER OF PIER CAP. REFER TO DETAIL 4/HS8.

- 3" CLR ALL SIDES

— 3-#3 STIRRUPS

(24"x24"x18")

1'-6"

'-0" HT. STONE COLUMN

- WATERTABLE. PROVIDE 1" OVERHANG

4" STONE VENEER AS SELECTED BY OWNER,

LEDGESTONE PATTERN. CONNECT TO CMU

COLUMN WITH GALVANIZED WALL TIES


TRIANGULARLY SPACED AT 1 PER 4 SQ FT.

ALL SIDES.

ALL SIDES.

3000 PSI CONCRETE.

COLUMN CAP. PROVIDE 1" OVERHANG

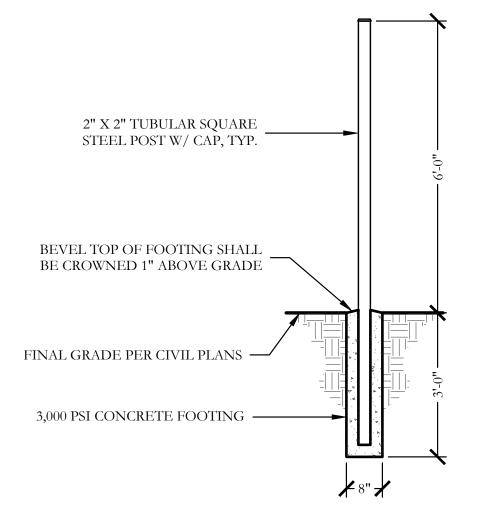


TYPICAL METAL POST FOOTING

4-#5 VERTICAL @ 90Deg. SPACING AROUND SPIRAL #3 ROUND — STIRRUP @ 18" ON CENTER

SCALE: 1/2"=1'-0"

PLAN/SECTION

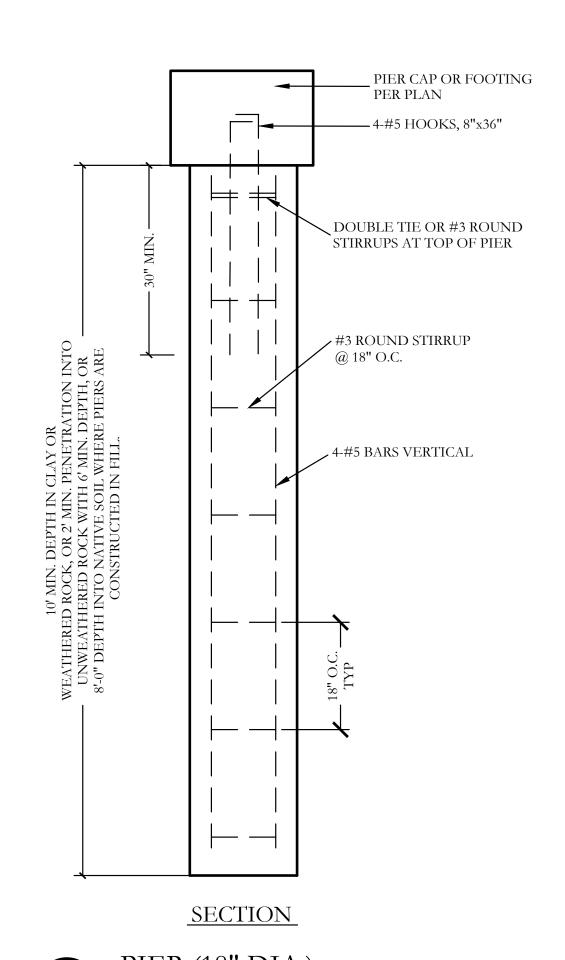

SCALE: 3/4'' = 1'-0''

GENERAL NOTES - HARDSCAPE CONSTRUCTION

INCH SLUMP. THE CEMENT SHALL BE TYPE 1 AND SHALL CONFORM TO ASTM C150. AGGREGATES SHALL CONFORM TO ASTM C33.

2. ALL MIXING, TRANSPORTING, PLACING, AND CURING OF CONCRETE SHALL COMPLY WITH

3. CONCRETE SHALL NOT BE PLACED IN RAINING OR FREEZING WEATHER.

5. MAXIMUM AGGREGATE SIZE = 1".

1. ALL REINFORCEMENT SHALL CONFORM TO ASTM A615 60 GRADE AND DEFORMED PER ASTM A305. PROVIDE 38 BAR DIAMETER LAP SPLICES FOR ALL CONTINUOUS BARS UNLESS

2.1. CONCRETE CAST AGAINST EARTH AND PERMANENTLY EXPOSED TO EARTH: 3 INCHES 2.2. CONCRETE EXPOSED TO EARTH OF WEATHER:

(A) BARS LARGER THAN NO. 5: 2 INCHES

(B) BARS NO. 5 AND SMALLER: 1-1/2 INCHES.

(A) BARS, LARGER THAN NO. 11: 1-1/2 INCHES

BEAMS AND COLUMNS: 1-1/2 INCHES

SHELLS AND FOLDED PLATES

(A) BAR LARGER THAN NO. 5: 3/4 INCHES.

- 1. PIERS NOT SPECIFICALLY LOCATED ON THE PLAN SHALL BE CENTERED ON WALL OR
- 2. PIER REINFORCING AND CONCRETE SHALL BE PLACED IMMEDIATELY OR TO WITHIN A
- MAXIMUM OF 8 HOURS AFTER DRILLING IS COMPLETE.
- PRESENT AT THE BOTTOM OF THE SHAFTS PRIOR TO PLACEMENT OF STEEL AND
- 4. PROVIDE 64 BAR DIAMETER LAP SPLICES IN ALL VERTICAL PIER REINFORCING AS
- 5. PROVIDE PIER TO GRADE BEAM DOWELS TO MATCH SIZE, QUANTITY, AND LOCATION OF LONGITUDINAL PIER REINFORCING. MIN DOWEL PROJECTION INTO PIER = 30 BAR DIA. MIN DOWEL PROJECTION INTO BEAM = TOP LONGITUDINAL GRADE BEAM REINFORCING.

STRUCTURAL CONCRETE MASONRY UNIT

- L. CONCRETE MASONRY UNITS SHALL BE HOLLOW LOAD-BEARING TYPE N-1 CONFORMING TO ASTM C90 AND HAVE A MINIMUM COMPRESSIVE STRENGTH OF 1900 PSI.
- PSI IN ACCORDANCE WITH ASTM C780. MASONRY CEMENT IS PROHIBITED.
- 4. COARSE GROUT SHALL HAVE A MINIMUM COMPRESSIVE STRENGTH OF 2500 PSI AND A
- FOR WALL REINFORCING BAR SIZE AND SPACING.
- 5. REINFORCE HORIZONTAL JOINTS WITH GALVANIZED LADDER-TYPE STEEL IN
- 6. HORIZONTAL REINFORCEMENT SHALL BE SPACED AT 16" MAXIMUM. PROVIDE A 16" LAP
- 7. JOINT REINFORCING SHALL BE DISCONTINUOUS AT CONTROL AND EXPANSION JOINTS.
- 8. LAP VERITCAL REINFORCING BARS AT 72 BAR DIAMETERS.
- 9. LAP HORIZONTAL REINFORCING BARS AT 48 BAR DIAMETERS. 10. PLACE GROUT USING LOW-LIFT METHOD, 6'-8" MAXIMUM LIFTS.
- 1. THE CONTRACTOR IS RESPONSIBLE FOR MAKING HIMSELF FAMILIAR WITH ALL UNDERGROUND UTILITIES, PIPES, AND STRUCTURES EITHER SHOWN OR NOT SHOWN ON THE PLANS. THE CONTRACTOR WILL BE RESPONSIBLE FOR ANY COST INCURRED DUE TO DAMAGE OR REPLACEMENT OF SAID UTILITIES AND STRUCTURES CAUSED BY
- 3. THE CONTRACTOR IS RESPONSIBLE FOR ALL REQUIRED PERMITS AND CITY

- 5. PROVIDE CONTINUOUS WELDS ALONG ALL EDGES OF FENCE MEMBERS. 6. GRIND SMOOTH ALL WELDS.
- RUSTPROOF PAINT, COLOR TO BE FLAT BLACK. CONTRACTOR TO SUBMIT SAMPLES AS
- STRENGTH, 60,000 PSI YIELD STRENGTH.
- DISTANCE OF 8'-0" O.C.
- RESPONSIBLE FOR ENSURING COMPLIANCE INCLUDING NECESSARY UPSIZING OF POSTS, PICKETS AND HORIZONTAL BARS AND INCREASING THE HEIGHT OF THE FENCE AS IT APPEARS IN THIS DETAIL AT NO ADDITIONAL COST TO THE OWNER FOR MATERIALS

1. ALL CONCRETE SHALL BE 3000 PSI, NORMAL WEIGHT, 28 DAY STRENGTH WITH A 4 TO 6

4. CHLORIDES SHALL NOT BE USED.

CONCRETE REINFORCING STEEL

2. PROVIDE THE FOLLOWING MINIMUM COVER FOR CONCRETE CAST IN PLACE

2.3. CONCRETE NOT EXPOSED TO EARTH OR WEATHER: SLABS, WALLS AND JOISTS

(B) BARS NO. 11 AND SMALLER: 3/4 INCHES.

(B) BARS NO. 5 AND SMALLER: 1/2 INCHES.

3. ALL REINFORCING STEEL SHALL BE CLEAN AND FREE OF GREASE.

3. STEEL CASING IS REQUIRED WHEN MORE THAN 2 INCHES OF STANDING WATER IS

PROVIDE STANDARD HOOK AT TERMINAL END OF DOWEL IN GRADE BEAM.


- 2. CONCRETE MASONRY UNITS SHALL HAVE A MINIMUM PRISM STRENGTH OF 1500 PSI AT 28
- 3. MORTAR SHALL BE ASTM C270, TYPE S, WITH A MINIMUM COMPRESSIVE STRENGTH OF 1800
- MAXIMUM AGGREGATE SIZE OF ½" IN ACCORDANCE WITH ASTM C476.REFER TO DETAILS
- ACCORDANCE WITH ANSI/ASTM A82. SIDE AND CROSS RODS SHALL BE 9 GA MINIMUM.

ORNAMENTAL METAL FENCE NOTES

- 2. ALL CONCRETE USED IN FOOTING AND PIERS SHALL HAVE A MINIMUM COMPRESSIVE STRENGTH OF 3000 PSI @ 28 DAYS.
- 4. ALL ORNAMENTAL METAL TUBES, POSTS, RAILS AND PICKETS SHALL BE FLUSH AND
- FREE OF ALL DENTS, SPURS, AND SHARP EDGES AND SHALL BE INSTALLED LEVEL,
- 7. ALL METAL SURFACES SHALL BE PRIMED AND PAINTED WITH TWO COATS OF
- 8. CONTRACTOR IS RESPONSIBLE FOR VERIFYING ALL DIMENSIONS BEFORE MANUFACTURING GATES AND FENCE. GATE LOCKING MECHANISM SHALL BE SELECTED BY OWNER.
- 9. ALL ORNAMENTAL METAL FENCE MEMBERS ARE TO BE TUBULAR MEMBERS IN ACCORDANCE WITH ASTM 513 HOT ROLLED STRUCTURAL STEEL 50,000 PSI TENSILE
- 10. FENCE MEMBER SIZES TO BE AS FOLLOWS: 10.1. PICKETS, 3/4" SQUARE 16 GA.
- 10.2. RAILS, 1-1/2" X 1/2" SQUARE 16 GA.

HIS FORCES.

- 10.3. POSTS, 2" SQUARE 11 GA.
- 11. CONCRETE FOOTING FOR POSTS SHALL BE A MINIMUM OF 3X POST WIDTH. 12. POSTS SHALL BE PLACED AT A MINIMUM DISTANCE OF 6'-0" O.C AND A MAXIMUM
- 13. FENCE SHALL MEET LOCAL CODES AND REQUIREMENTS. CONTRACTOR SHALL BE

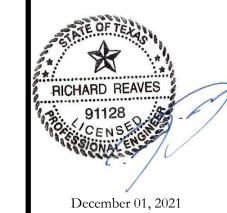



REAVES CONSULTING 831 ARROWHEAD DRIVE PROSPER, TEXAS 75078

F-10826

Bar is one inch on original drawing. If not one inch on this sheet,

One Inch

adjust scale as necessary.

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Ph. Hardscape

CJS PROJECT NO.

SHEET NO. HS8 of 8