

DEVELOPMENT APPLICATION

City of Rockwall Planning and Zoning Department 385 S. Goliad Street Rockwall, Texas 75087

STAFF USE ONLY	STA	FF	USE	ONLY
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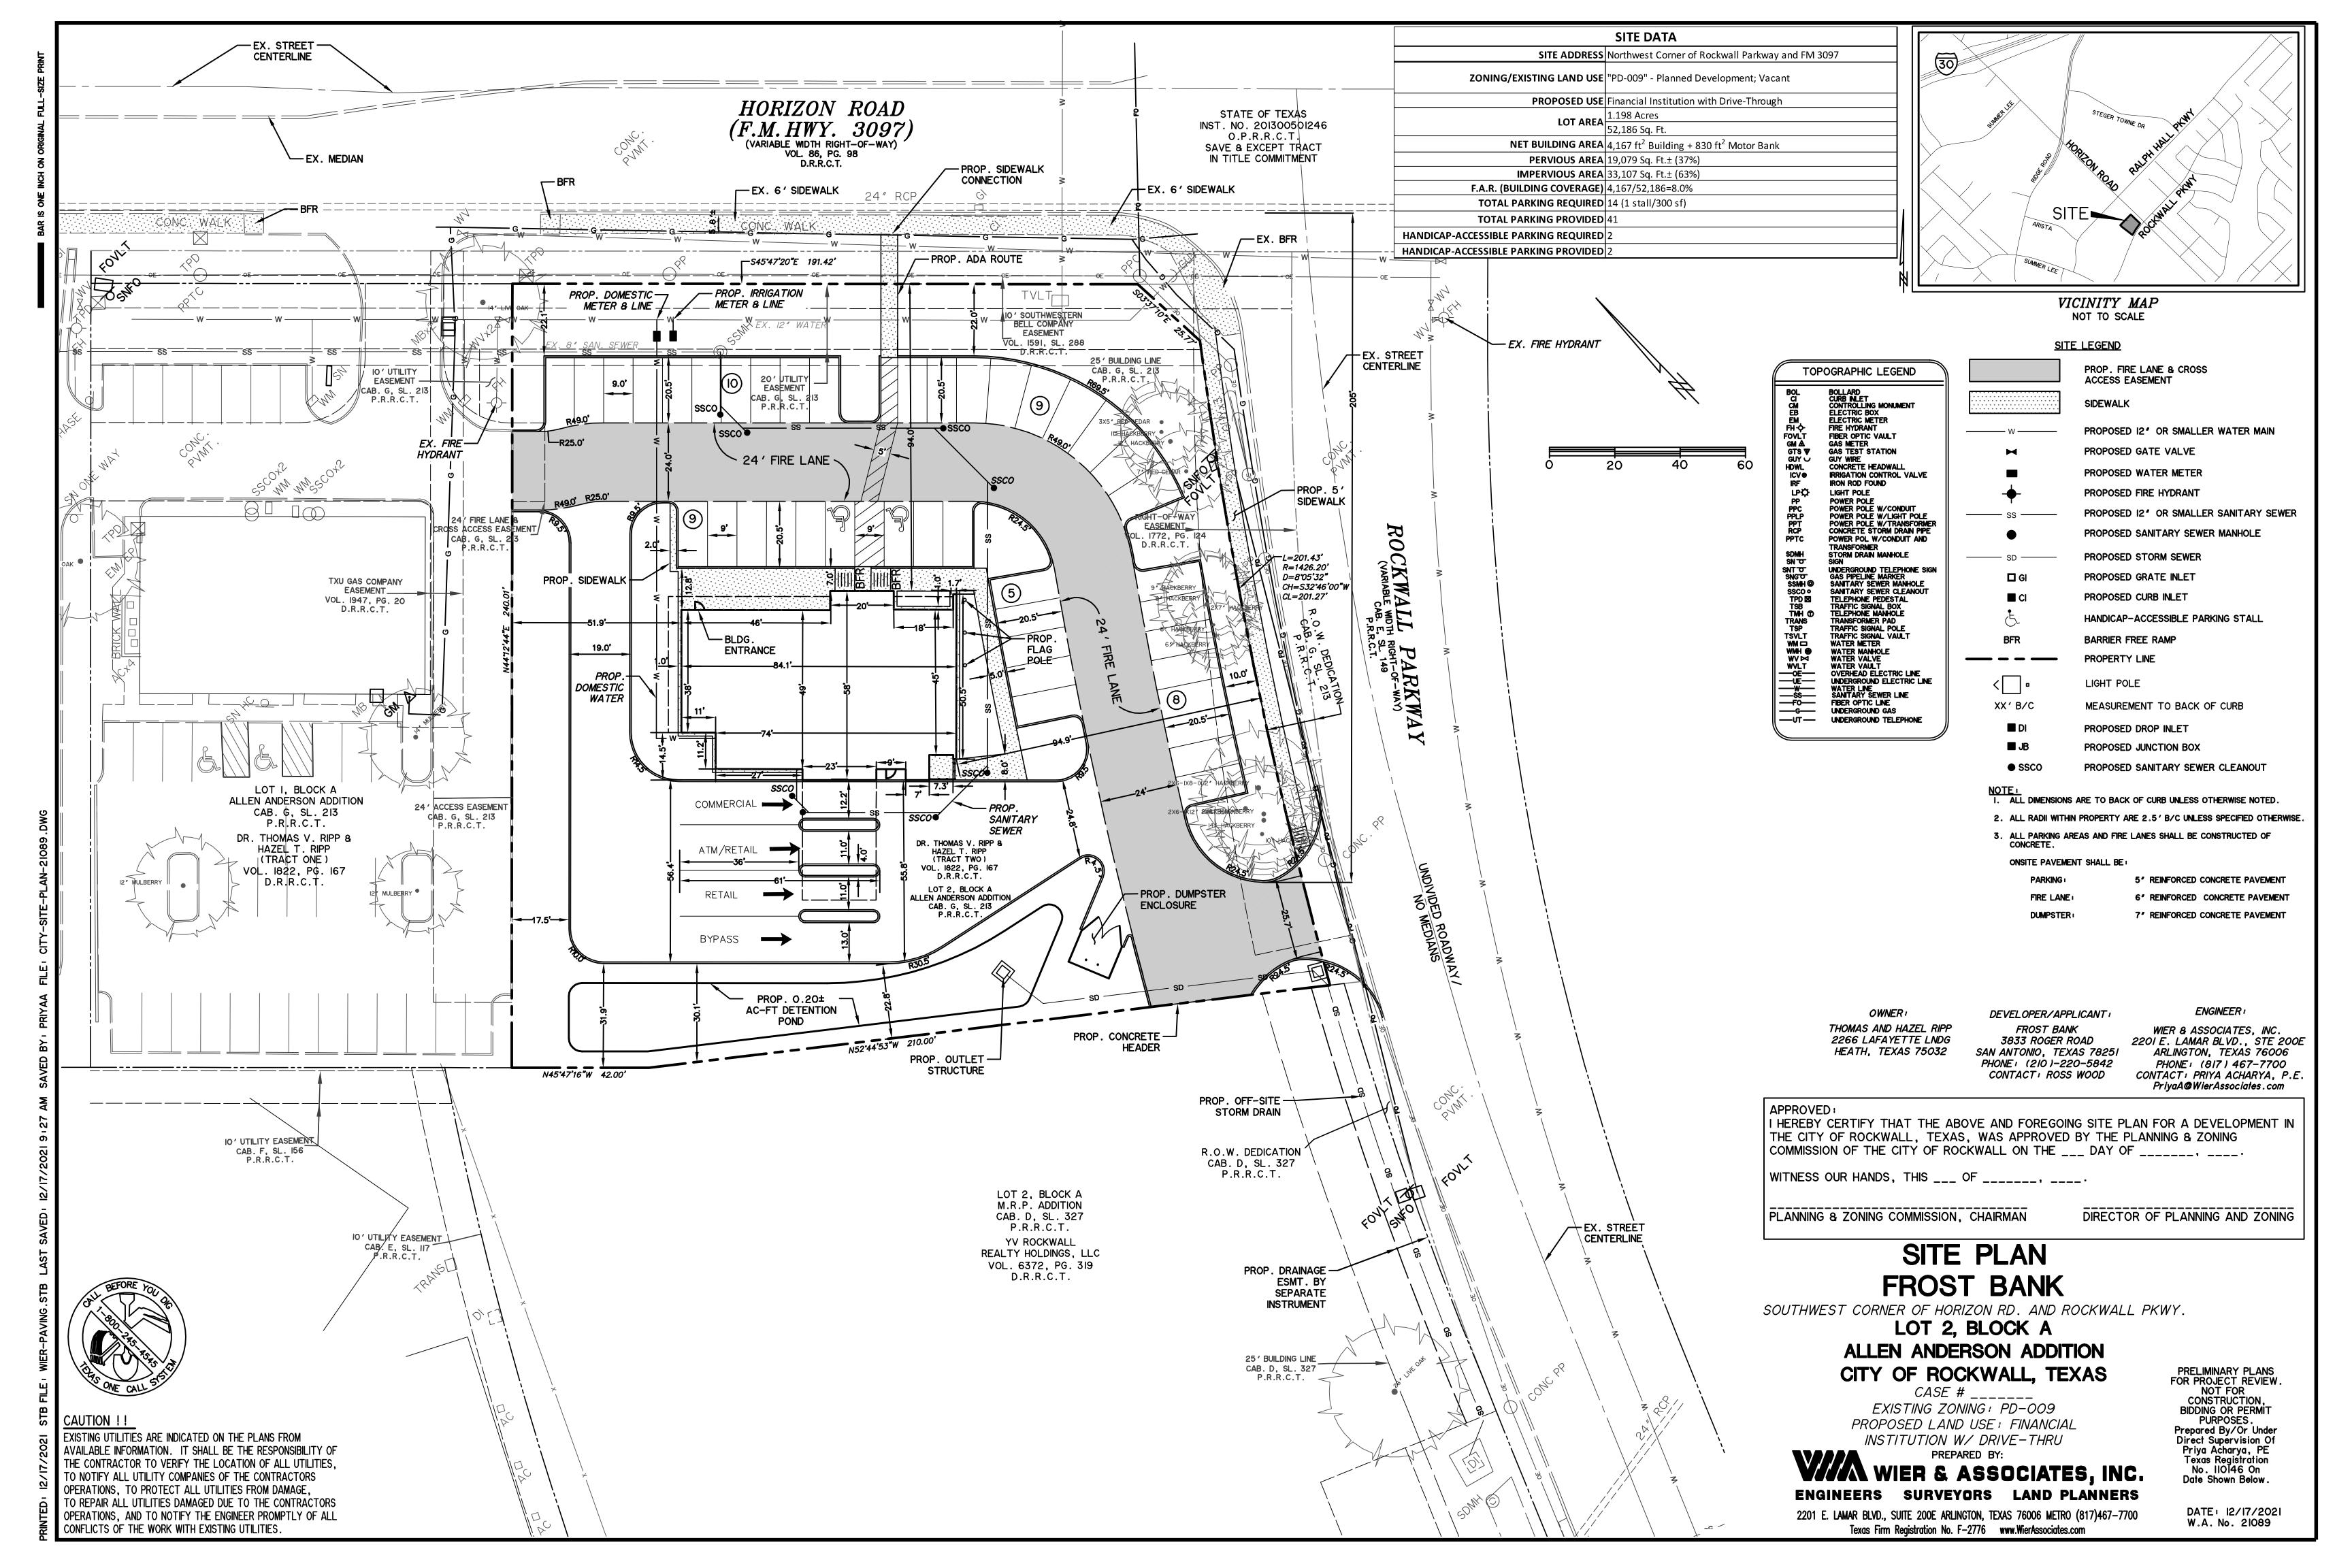
PLANNING & ZONING CASE NO. SP 2021-035


NOTE: THE APPLICATION IS NOT CONSIDERED ACCEPTED BY THE CITY UNTIL THE PLANNING DIRECTOR AND CITY ENGINEER HAVE SIGNED BELOW.


DIRECTOR OF PLANNING:

CITY ENGINEED.

		I ENGINEER.	i Decausion			
PLEASE CHECK THE	APPROPRIATE BOX BELOW TO INDICATE THE TYPE OF	E DEVELOPMENT RE	QUEST [SELECT	ONLY ONE B	OX]:	-
PLATTING APPLIC MASTER PLAT (PRELIMINARY F FINAL PLAT (\$30.0 REPLAT (\$300.0 AMENDING OR PLAT REINSTAT SITE PLAN APPLIC SITE PLAN (\$250 AMENDED SITE	☐ ZONING O ☐ SPECIFIC ☐ PD DEVEL OTHER APPL ☐ TREE REM ☐ VARIANCE NOTES: ¹: IN DETERM MULTIPLYING B	CHATION FEES: CHANGE (\$200.00 USE PERMIT (\$2 .OPMENT PLANS .ICATION FEES: MOVAL (\$75.00) E REQUEST (\$100 INING THE FEE, FIY THE PER ACRE A	+ \$15.00 ACR 00.00 + \$15.00 (\$200.00 + \$15.00 0.00) PLEASE USE TI MOUNT. FOR RI	ACRE) 1 5.00 ACRE) 1	AGE WHEN STHAN ONE	
		ACRE, ROUND (JP TO ONE (1) ACRE			
	RMATION [PLEASE PRINT]					
ADDRESS	Address not available					
SUBDIVISION	Allen Anderson Addition		LOT	2	BLOCK	2
GENERAL LOCATION	Northwest corner of Rockwall Parkway ar	nd FM 3097				
ZONING, SITE PL	AN AND PLATTING INFORMATION (PLEASE	PRINT)				
CURRENT ZONING		CURRENT USE	Vacant			
PROPOSED ZONING	N/A	PROPOSED USE	Financial	Institution v	with Drive-Th	rough
ACREAGE	1.198 LOTS [CURRENT]	1		S [PROPOSEI		
RESULT IN THE DE	PLATS: BY CHECKING THIS BOX YOU ACKNOWLEDGE THI PPROVAL PROCESS, AND FAILURE TO ADDRESS ANY OF ST ENIAL OF YOUR CASE.	IAFF'S COMMENTS B'	Y THE DATE PROV	IDED ON THE D	EVELOPMENT C	EXIBILITY WITH ALENDAR WILL
	ANT/AGENT INFORMATION (PLEASE PRINT/CHE	The state of the s				
OWNER CONTACT PERSON	Frost Bank Ross Wood	X APPLICANT	Charles and the control of			
ADDRESS	3833 Roger Road	CONTACT PERSON	Priya Acha		0 11 0000	
ADDRESS	3000 Nogel Noaq	ADDRESS	2201 E. La	mar Blvd.	Suite 200E	
CITY, STATE & ZIP	San Antonio, Texas, 78251	CITY, STATE & ZIP	Arlington,	Texas, 760	06	
PHONE	(210) 220-5842	PHONE	(817) 467-7	7700		
E-MAIL	ross.wood@frostbank.com	E-MAIL	priyaa@wi	erassociate	s.com	
STATED THE INFORMATION HEREBY CERTIFY THAT I.	SIGNED AUTHORITY, ON THIS DAY PERSONALLY APPEARED ON ON THIS APPLICATION TO BE TRUE AND CERTIFIED THE FOR THE PURPOSE OF THIS APPLICATION; ALL TO COVER THE COST OF THIS APPLICATION HAS	INFORMATION SUBMIT	TED HEREIN IS TRU	E AND CORREC		CATION FEE OF
	20 21. BY SIGNING THIS APPLICATION, I AGREE WITHIN THIS APPLICATION TO THE PUBLIC. THE CITY IS A DN WITH THIS APPLICATION, IF SUCH REPRODUCTION IS ASSOCIAND SEAL OF OFFICE ON THIS THE 12 DAY OF DECLE	THAT THE CITY OF RO	CKWALL (I.E. "CITY	") IS AUTHORIZE	ED AND PERMITTE IN CONTRIBUTED RANGE OF THE PROPERTY PUBLIC RY PUBLIC	
	OWNER'S SIGNATURE HON MICH			10		1111
NOTARY PUBLIC IN AND F	FOR THE STATE OF TEXAS	1	MY COM	MISSION EXPIR	\$ 1/3	1323
DEVELOPMEN	IT APPLICATION • CITY OF ROCKWALL • 25 SOUTH GOLIAD	STREET . ROCKWAL	L, TX 75087 • [P] (THINING PR	12448777 2013 ES 1-13-2013	WAR



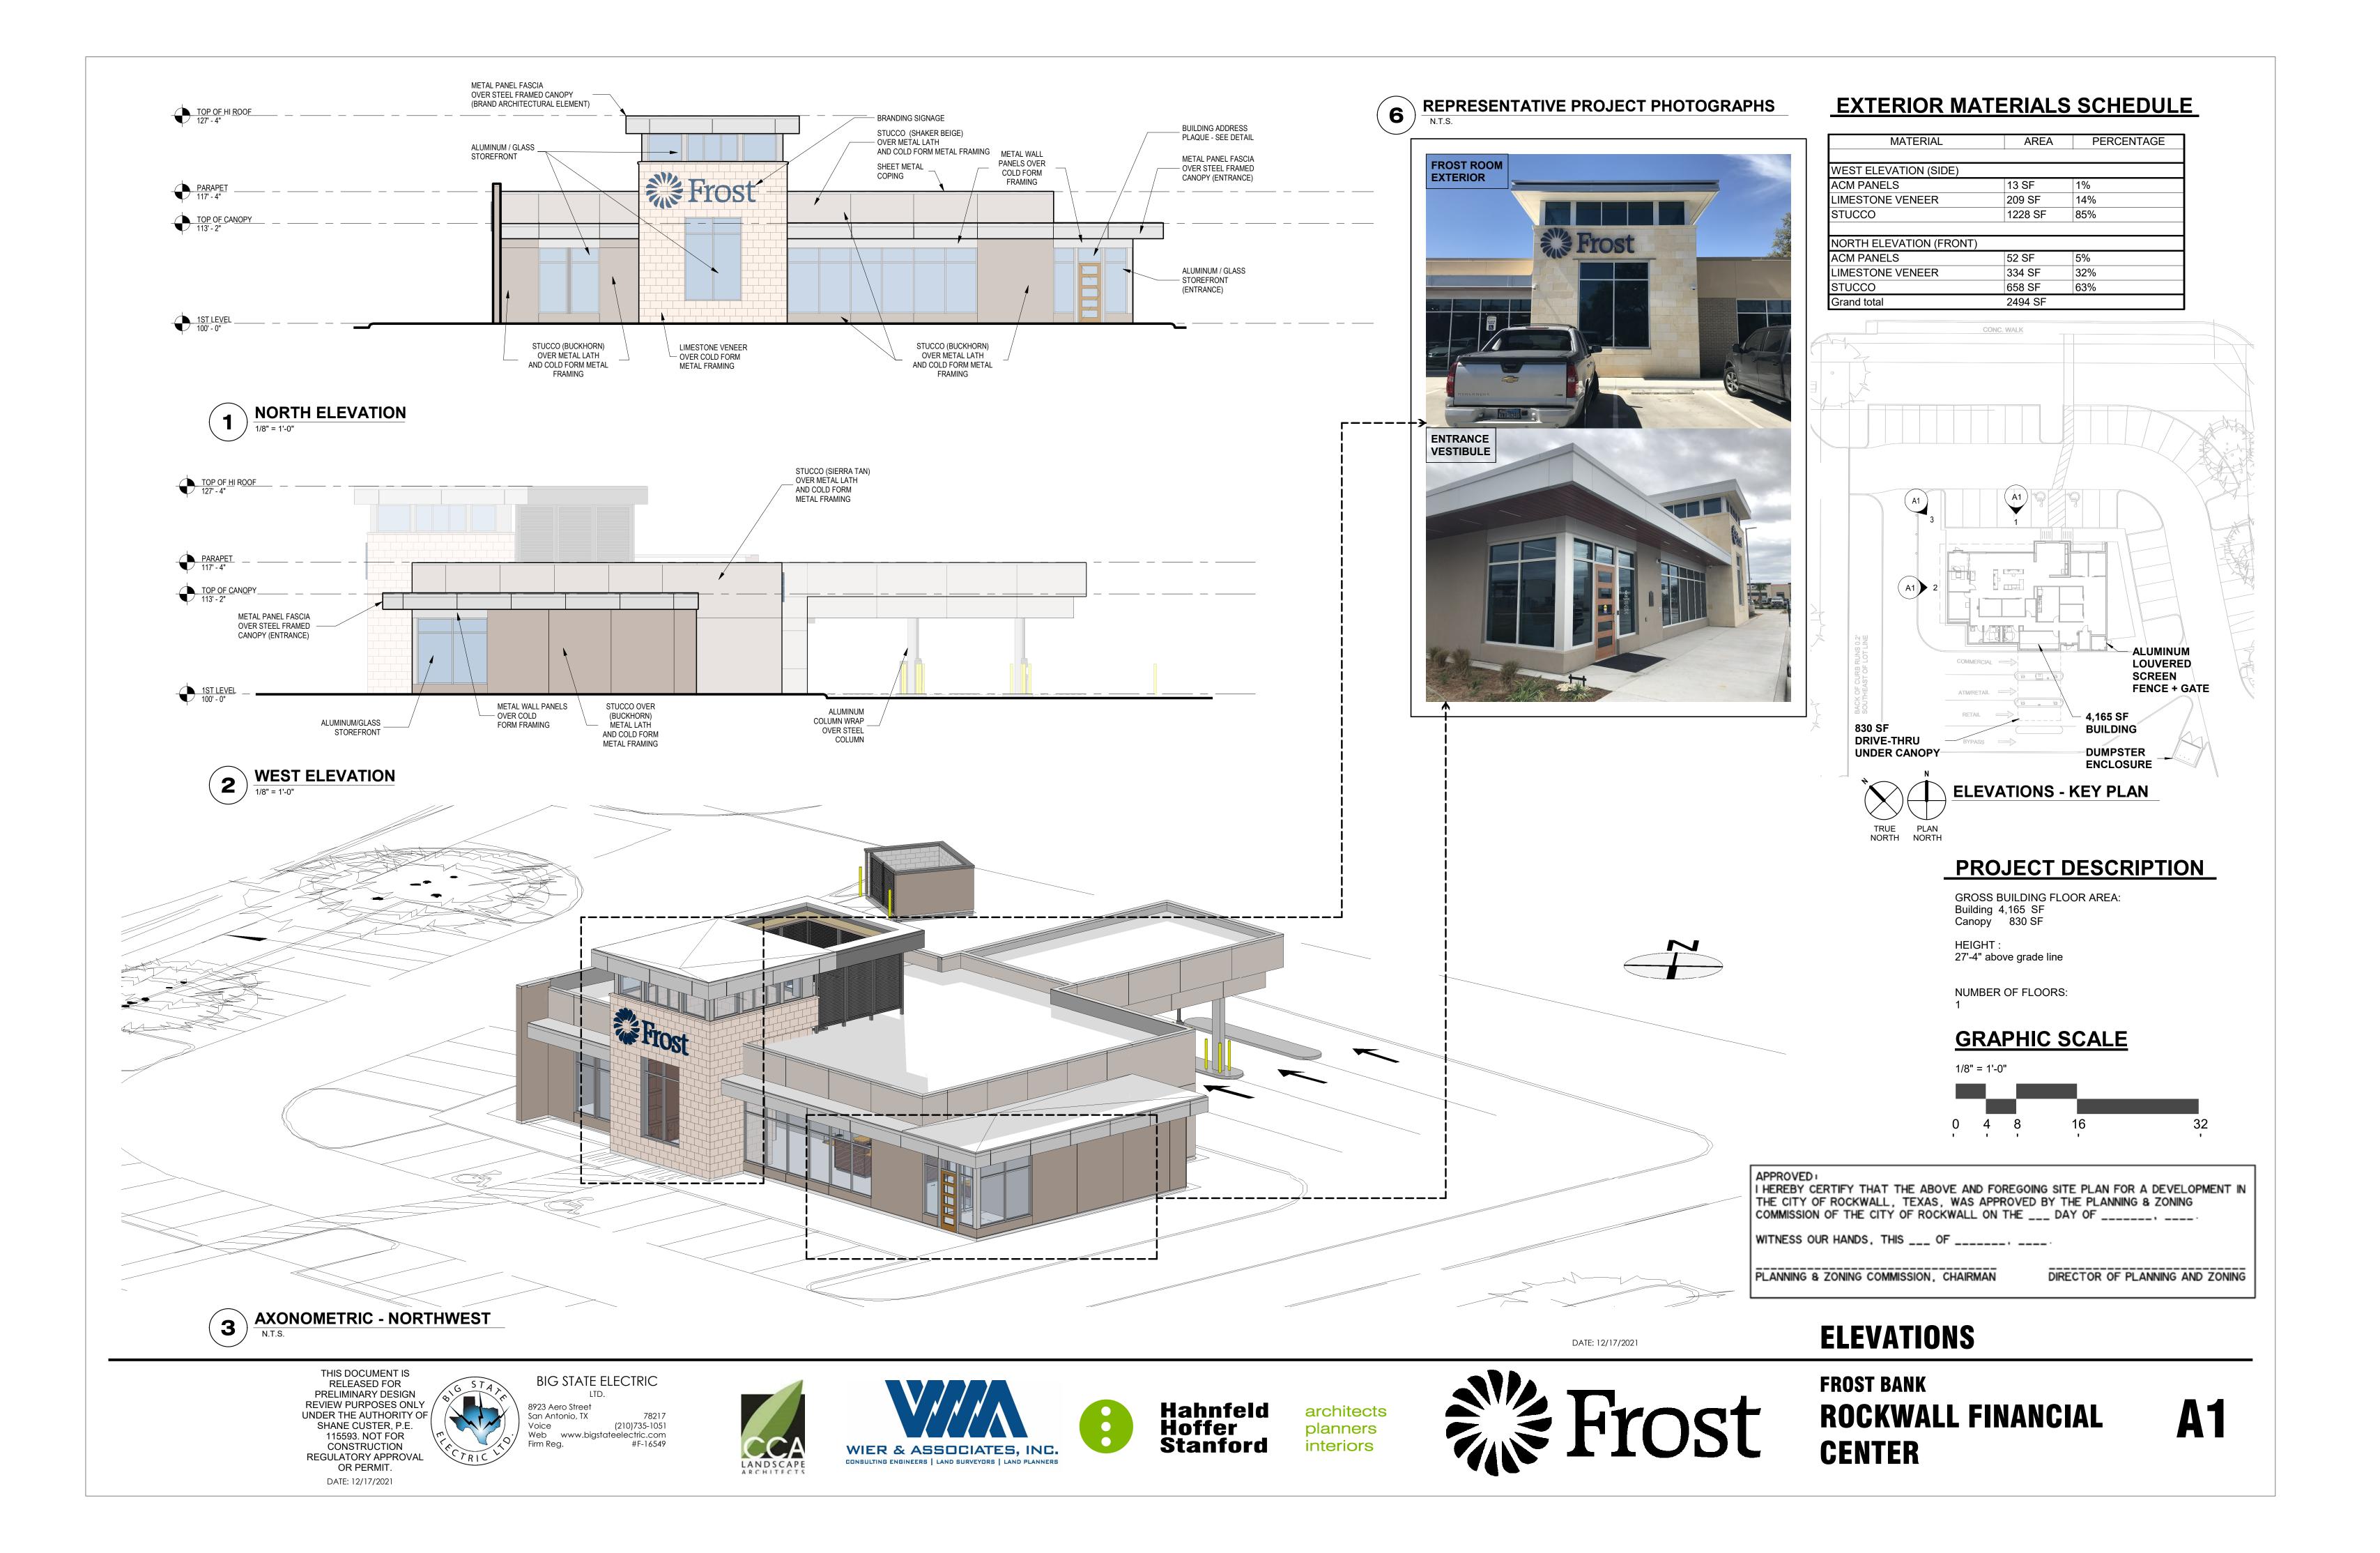

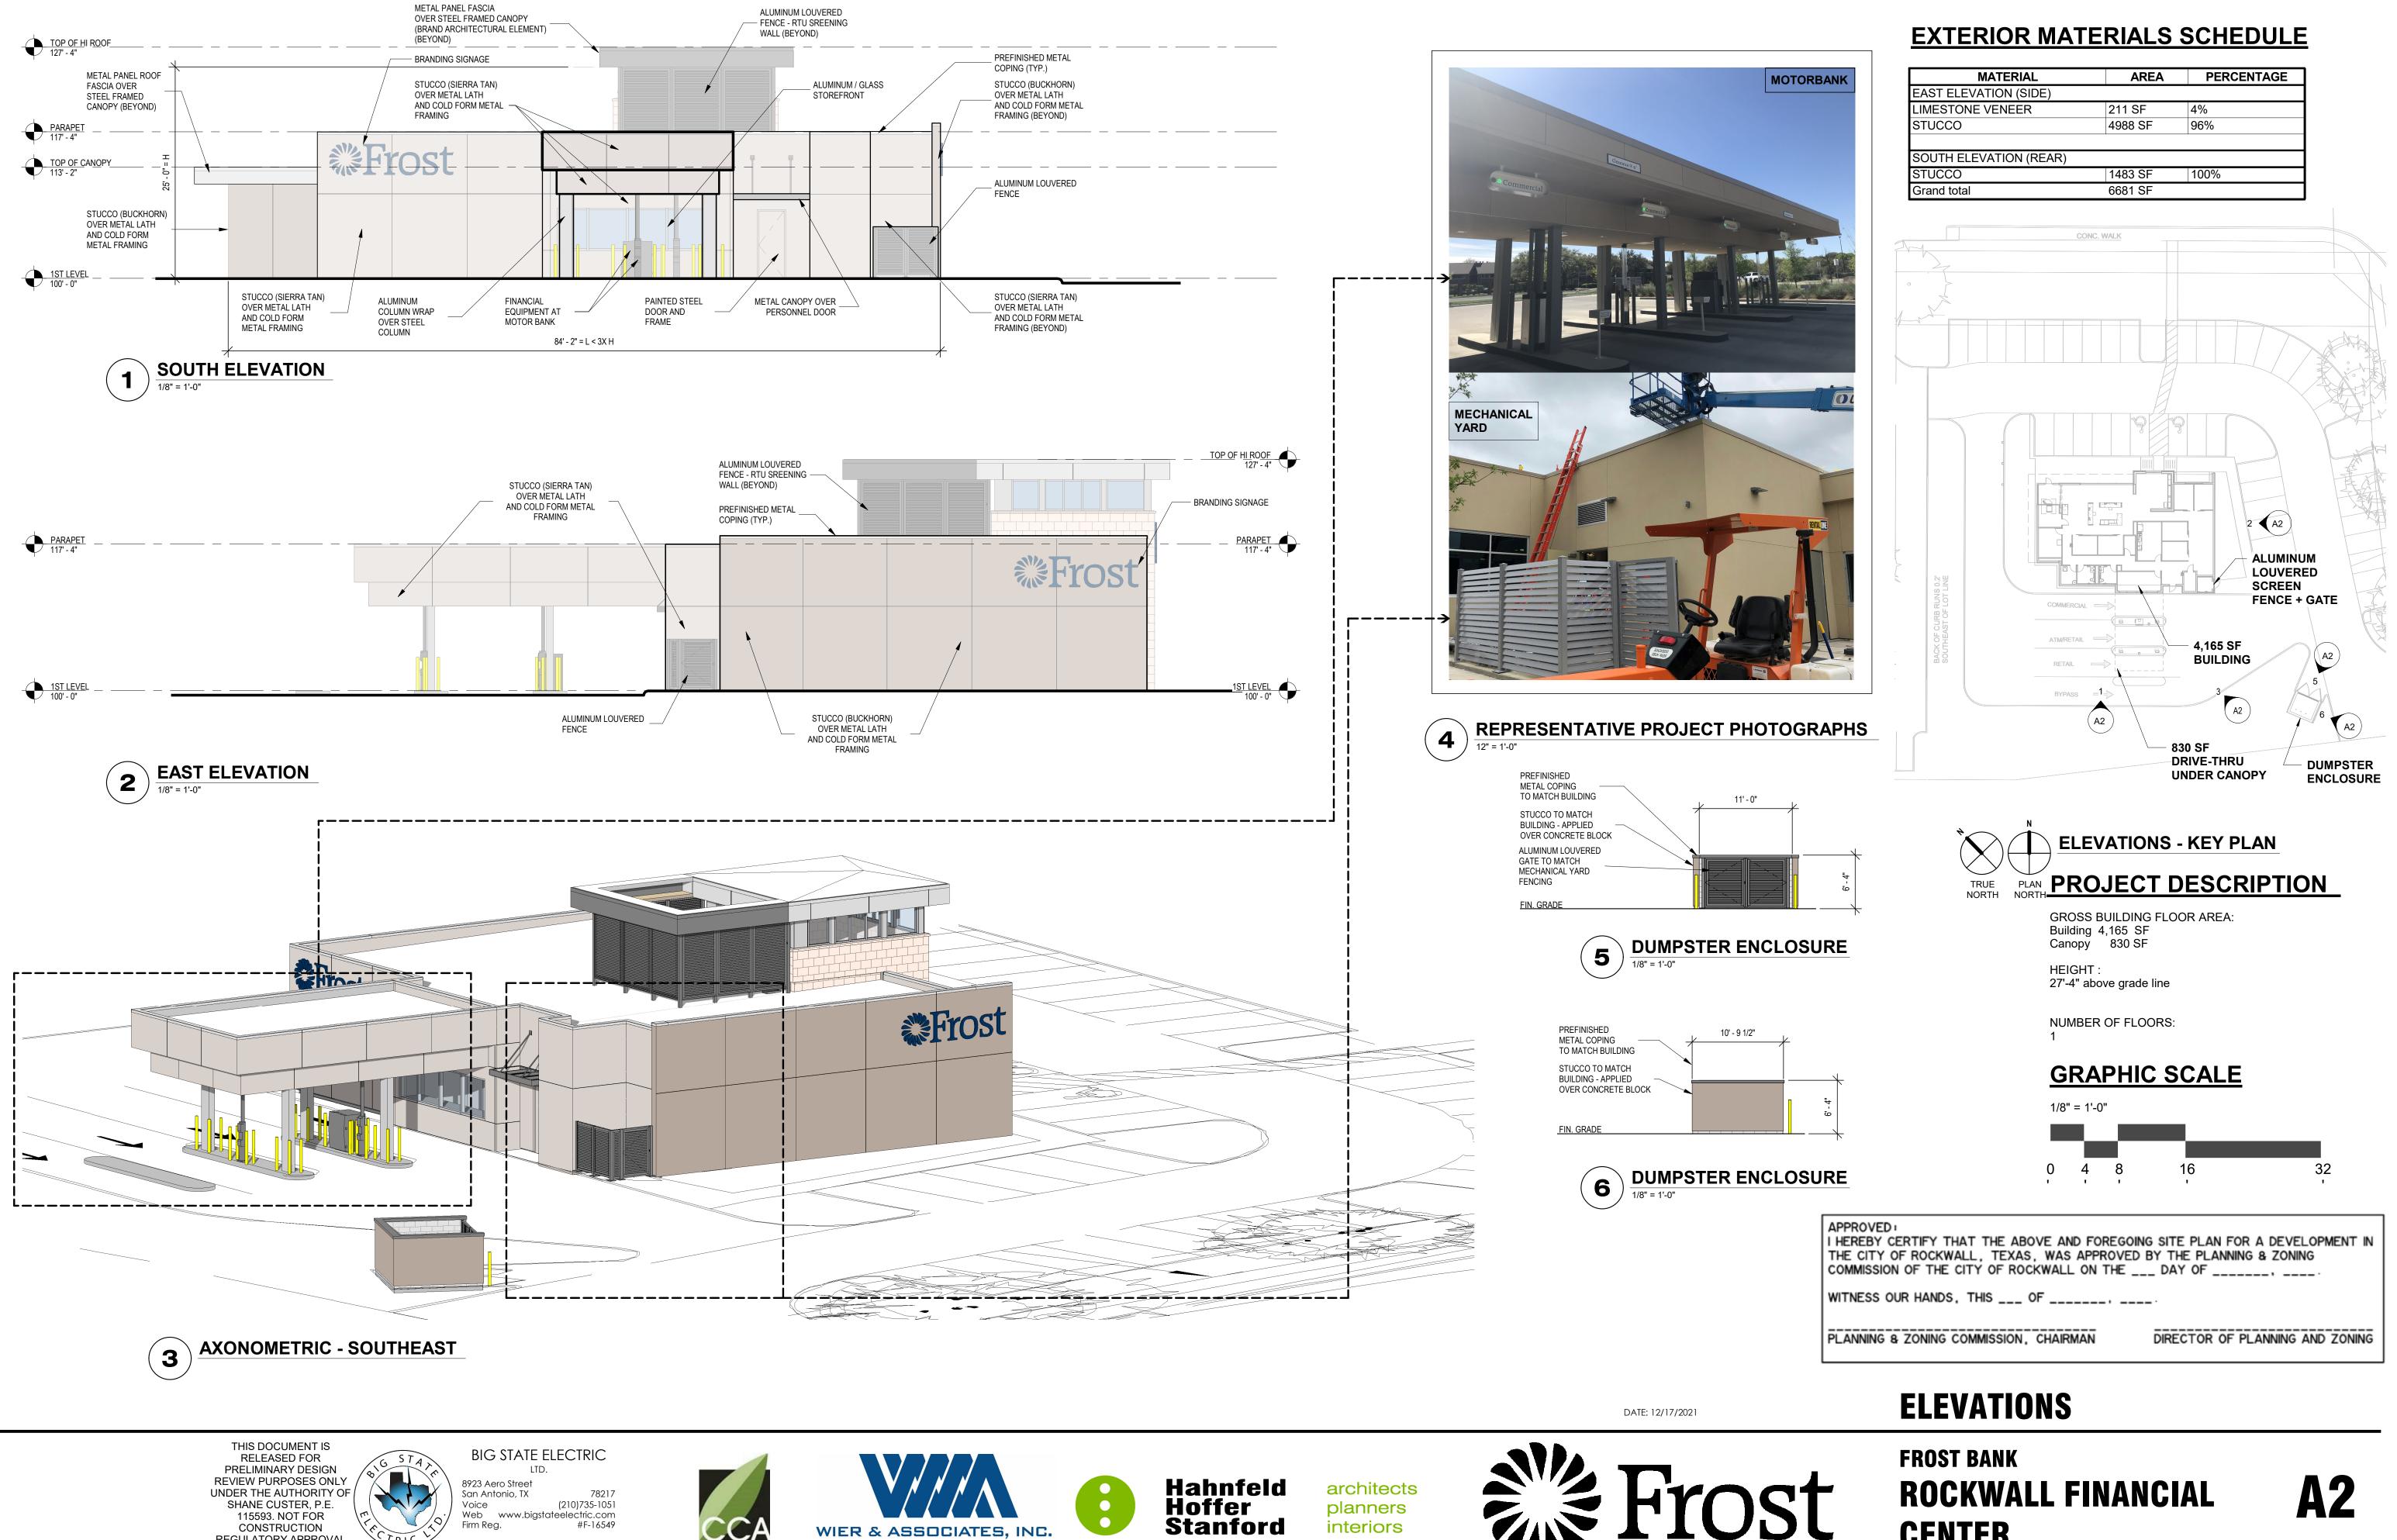

planners

interiors

SHANE CUSTER, P.E.

115593. NOT FOR

CONSTRUCTION REGULATORY APPROVAL OR PERMIT. DATE: 12/17/2021


(210)735-1051

Web www.bigstateelectric.com


A2

CENTER



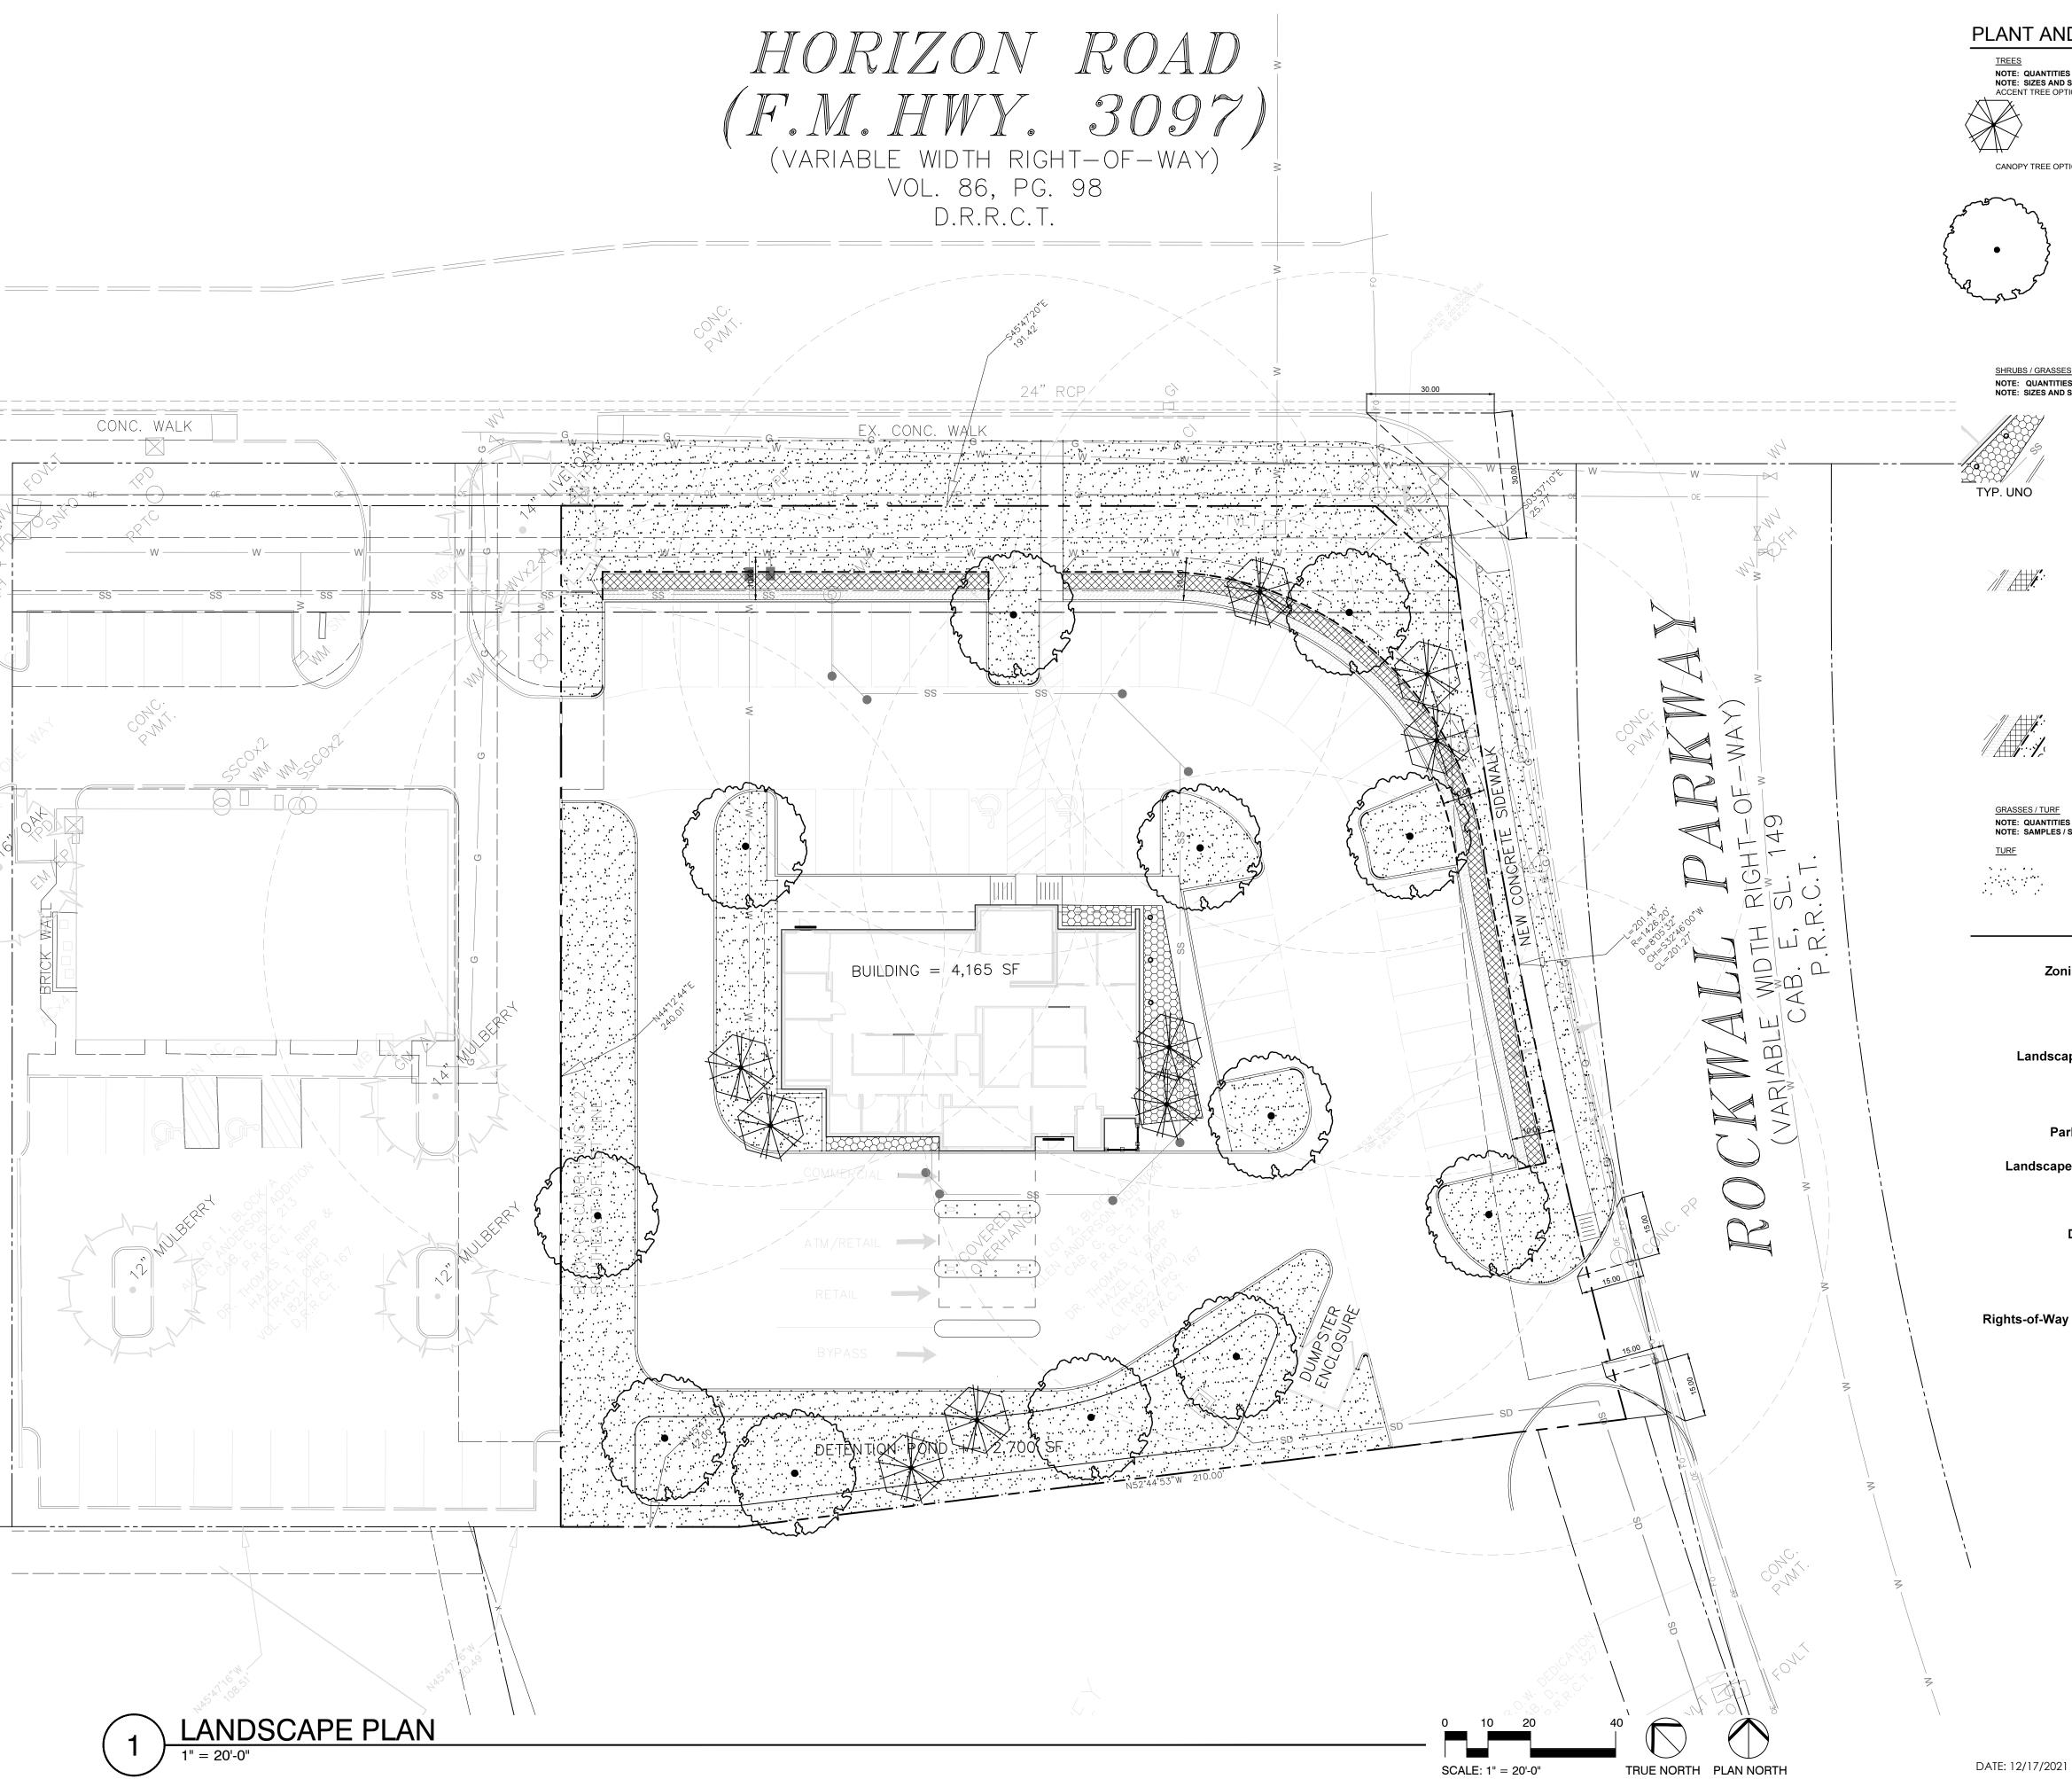



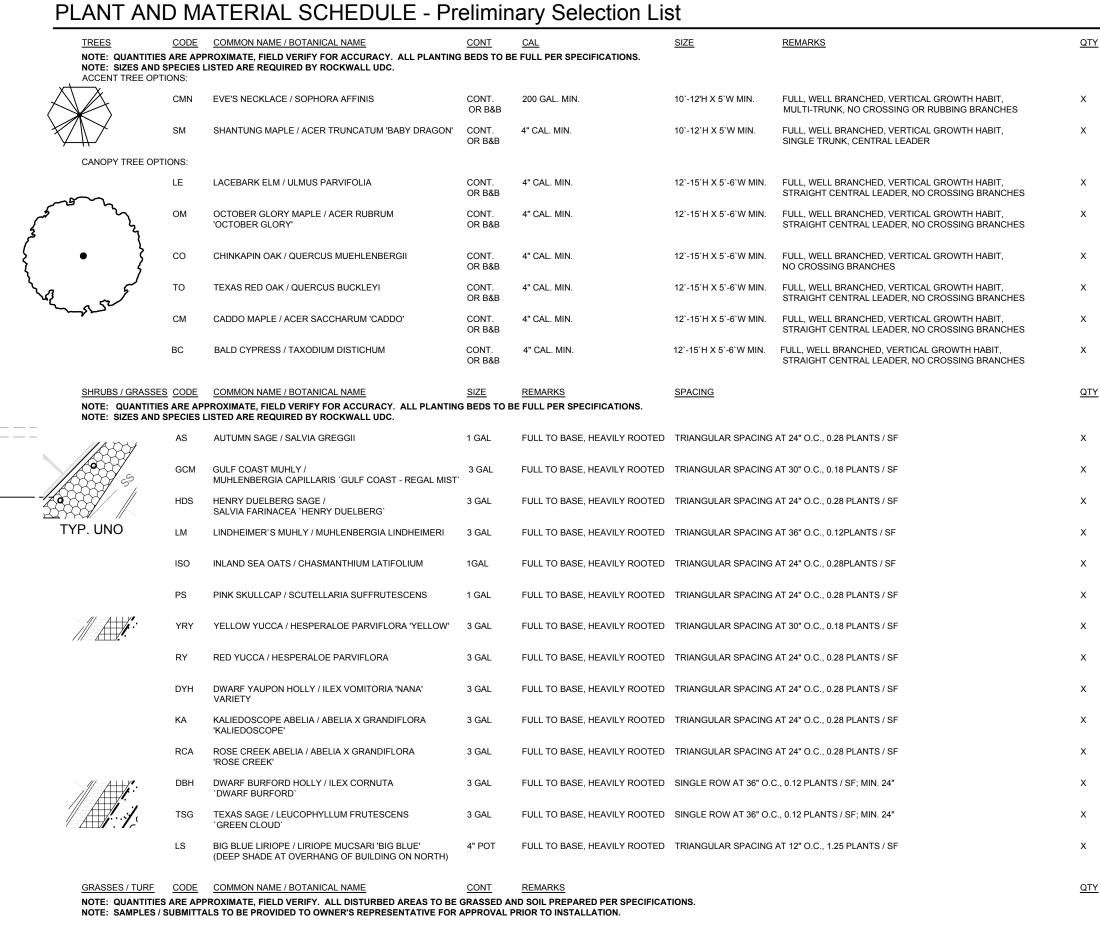

SITE DATA

CODE COMMON NAME / BOTANICAL NAME

Zoning/Existing Land Use PD- 9 - Planned Development, vacant Proposed Use Bank **Building** 4,165.00 SF 1.20 Acres Lot Area 58,186.00 SF Landscape / Open Space Area Required per PD 9 - Whittle Development - Exhibit "C" - 10% Min. 18,535.00 SF 32% Provided Pervious Area 18,535.00 SF Impervious Area 39,651.00 SF Parking Lot Landscaping 10' Buffer on 2' Berm (determine if allowed in utility easement along FM 3097) Parking Spaces 18 (1 stall/300 SF) Landscape Buffer - Street Trees 418.62 LF Frontage - trees restricted due to underground Utilities and Easements One (1) canopy tree and Three (3) accent trees at corner of lot provided **Tree Locations** One tree located min. 80' from parking spaces Trees set back min. 5' from head-in parking **Detention Pond Trees** 2,700.00 SF +-4 One canopy tree per 750 SF 2 One accent tree per 1,500 SF Visibility Triangles As reflected on plan per the UDC Irrigation Shall meet all requirements per the UDC Rights-of-Way & Landscape Buffers Shall meet all requirements per the UDC - improved with grass (sod)

Site Address Northwest Corner of Rockwall Parkway and FM 3097

BG BERMUDA GRASS / CYNODON DACTYLON 'TIFFWAY 419' SOD SOLID SOD, REF. SPEC 329200

LANDSCAPE PLAN














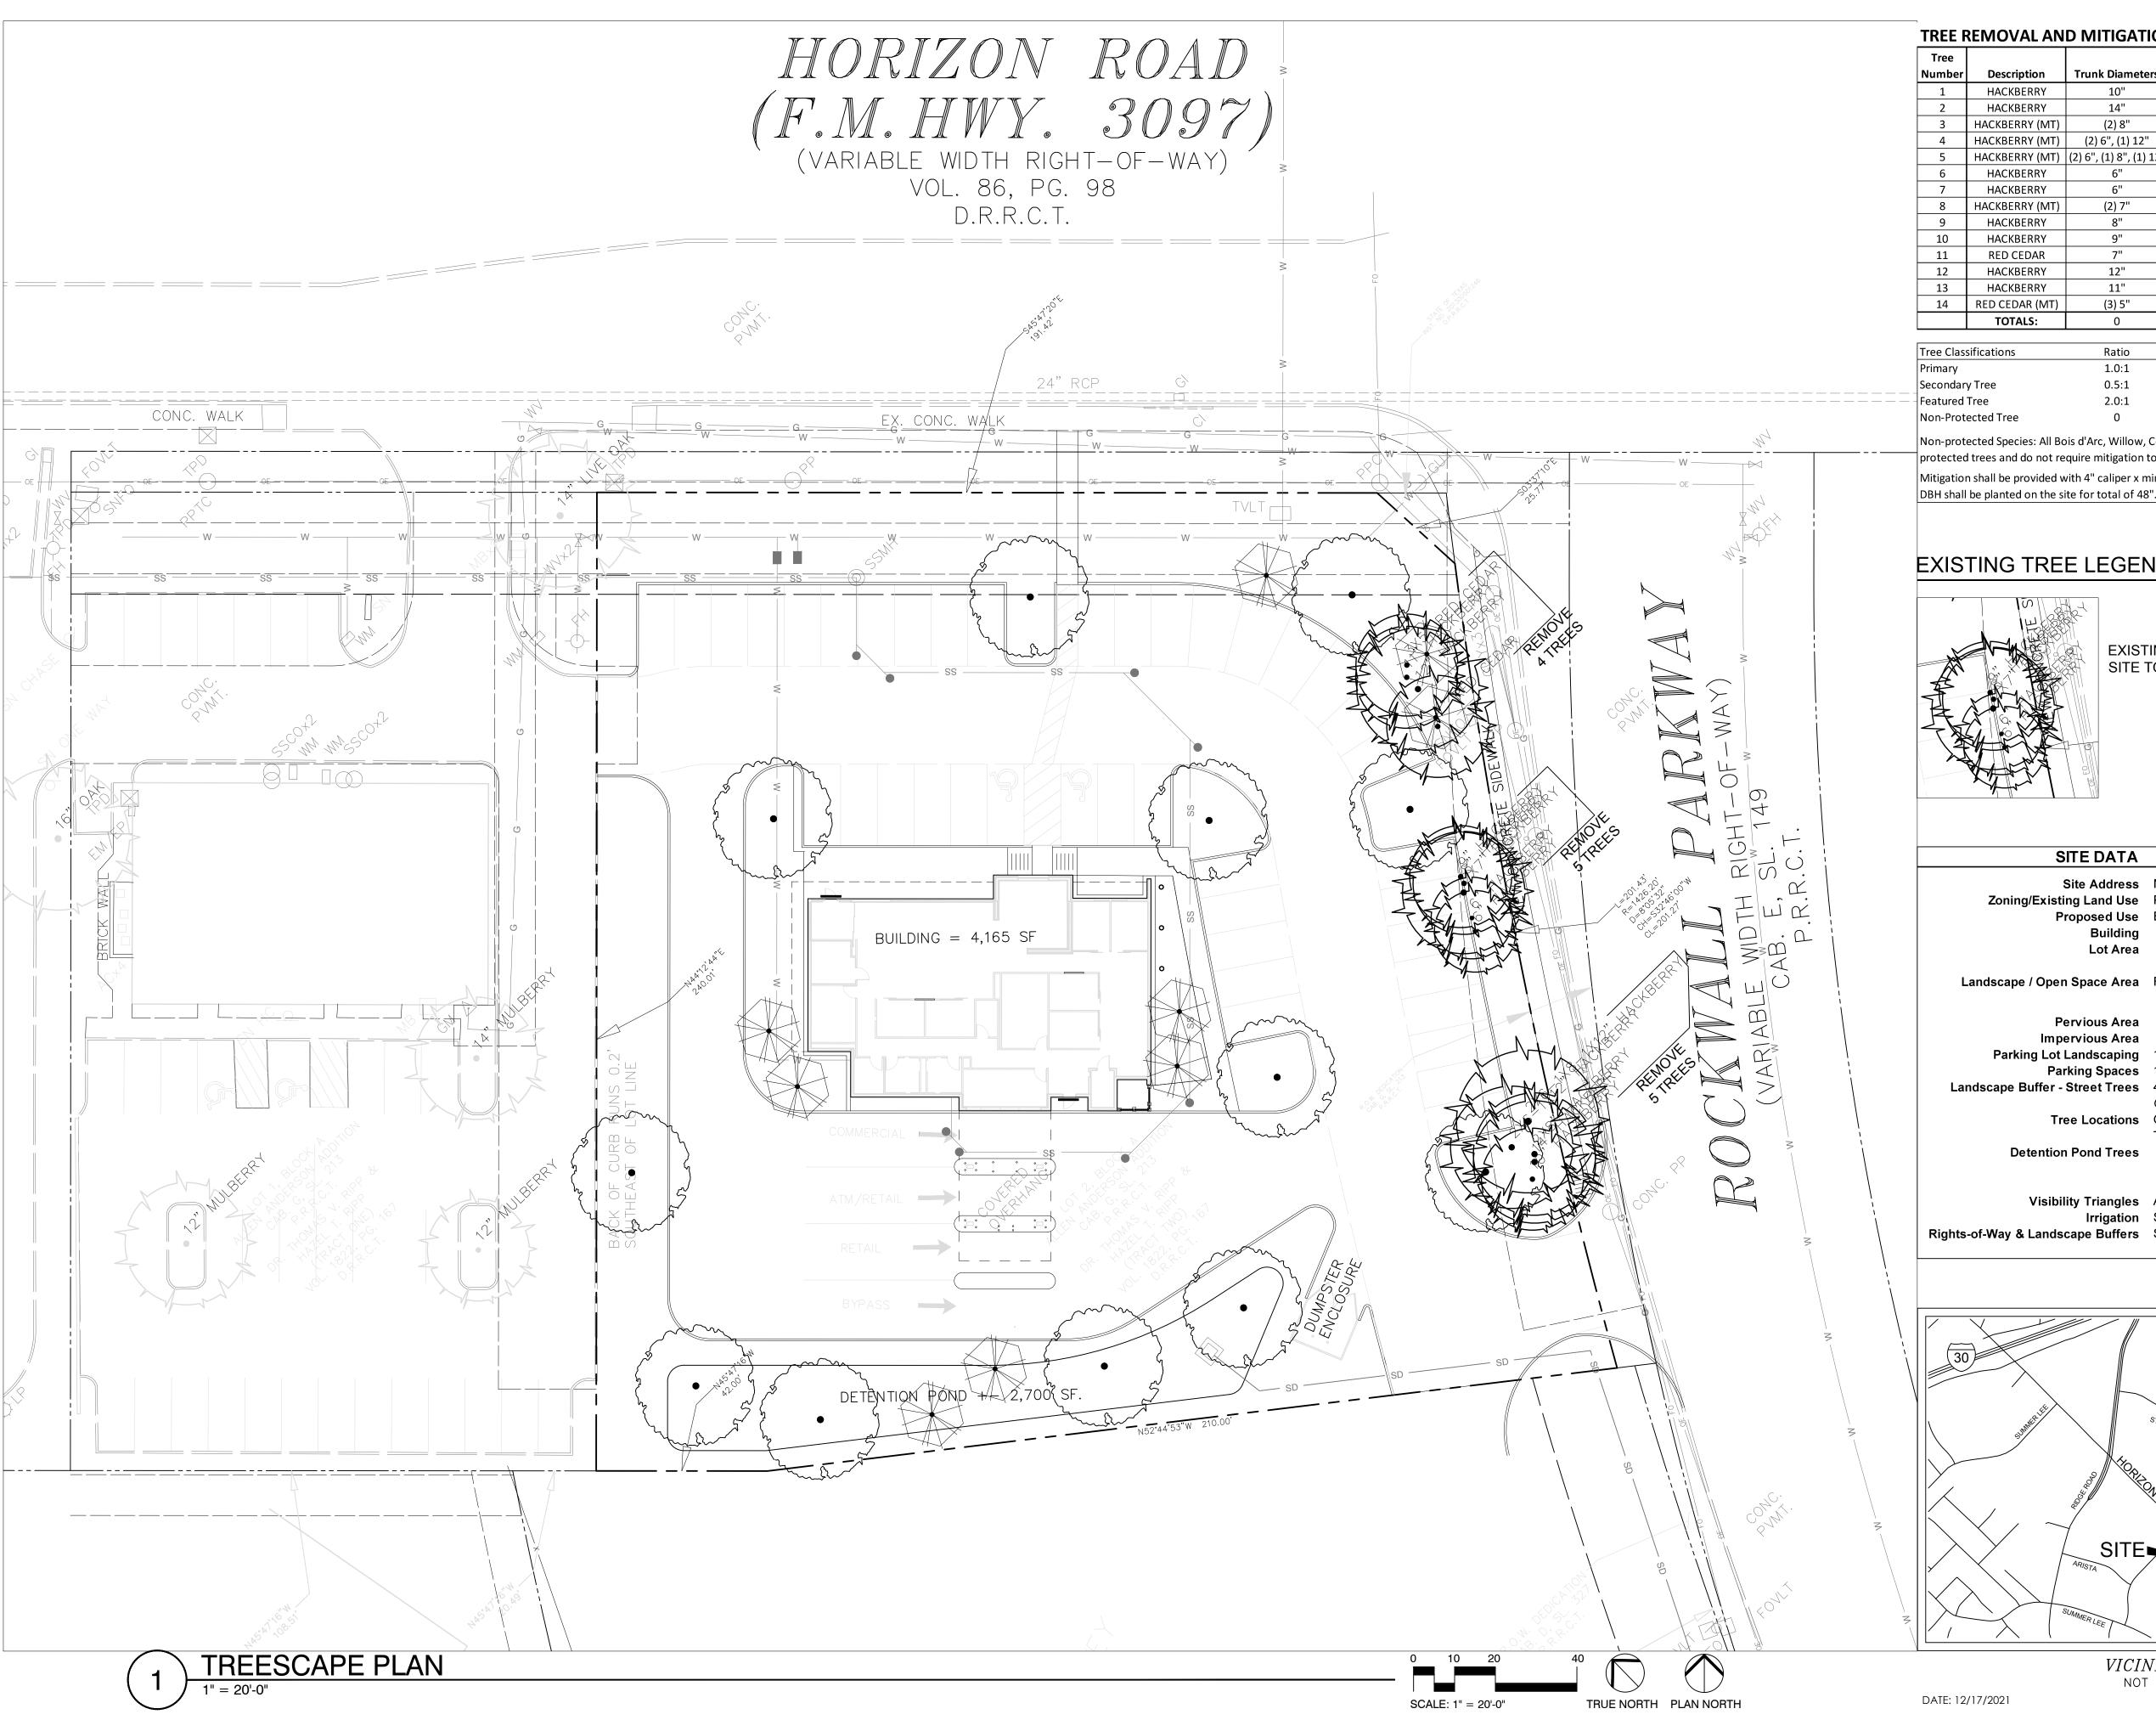

TREE REMOVAL AND MITIGATION LIST - FROST BANK

Tree	Donovintio v	Two als Diagraphs as	Cal	Ductoctod	Davis accept	Type of Tree	Mitigation	Cal Inches	Cal Inches	Nista
Number	Description	Trunk Diameters	Inches	Protected	Removed	Protection Status	Ratio	to Mitigate	Removed	Note
1	HACKBERRY	10"	10	N	у	Non	0	0.00	10.00	Remove
2	HACKBERRY	14"	14	Υ	Υ	Secondary	0.5:1	7.00	14.00	Remove
3	HACKBERRY (MT)	(2) 8"	12	Υ	Υ	Secondary	0.5:1	6.00	12.00	Remove
4	HACKBERRY (MT)	(2) 6", (1) 12"	18	Υ	Υ	Secondary	0.5:1	9.00	24.00	Remove
5	HACKBERRY (MT)	(2) 6", (1) 8", (1) 12"	22	Υ	Υ	Secondary	0.5:1	11.00	32.00	Remove
6	HACKBERRY	6"	6	Υ	Υ	Non	0	0.00	6.00	Remove
7	HACKBERRY	6"	6	Υ	Υ	Non	0	0.00	6.00	Remove
8	HACKBERRY (MT)	(2) 7"	10.5	Υ	Υ	Non	0	0.00	14.00	Remove
9	HACKBERRY	8"	8	Υ	Υ	Non	0	0.00	8.00	Remove
10	HACKBERRY	9"	9	Υ	Υ	Non	0	0.00	9.00	Remove
11	RED CEDAR	7"	7	Υ	Υ	Non	0	0.00	7.00	Remove
12	HACKBERRY	12"	12	Υ	Υ	Secondary	0.5:1	6.00	12.00	Remove
13	HACKBERRY	11"	11	Υ	Υ	Secondary	0.5:1	5.50	11.00	Remove
14	RED CEDAR (MT)	(3) 5"	10	Υ	Υ	Non	0	0.00	10.00	Remove
	TOTALS:	0	155.5					44.50	175.00	

Tree Classifications	Ratio	Ratio	Fee Per Caliper Inch	
Primary	1.0:1	1.0:1	\$579	Trees 4" to 25"
Secondary Tree	0.5:1	0.5:1	\$290	Hackberry and Cedar 11" to 25"
Featured Tree	2.0:1	2.0:1	\$193	All trees greater than 25"
Non-Protected Tree	0	0	\$135	Any tree less than 4" to 11" for Hackberry and Cedar

Non-protected Species: All Bois d'Arc, Willow, Cottonwood, Locust and Chinaberry, and Hackberry and Red Cedar trees less than 11" shall be considered nonprotected trees and do not require mitigation to be removed. Mitigation shall be provided with 4" caliper x min. 7' height trees from the Reclamation/Tree Preservation List. PROVIDE: Minimum of Twelve (12) trees at 4"

EXISTING TREE LEGEND

TREE REPLACEMENT LEGEND

EXISTING TREES ON SITE TO BE REMOVED

CANOPY TREE - FINAL QUANTITY PENDING UTILITY CONFLICTS

ACCENT TREE - FINAL QUANTITY

SITE DATA

Site Address Northwest Corner of Rockwall Parkway and FM 3097 Zoning/Existing Land Use PD- 9 - Planned Development, vacant

4,165.00 SF 1.20 Acres

58,186.00 SF Landscape / Open Space Area Required per PD 9 - Whittle Development - Exhibit "C" - 10% Min.

18,535.00 SF 32% Provided

Pervious Area 18,535.00 SF Impervious Area 39,651.00 SF

Parking Lot Landscaping 10' Buffer on 2' Berm (determine if allowed in utility easement along FM 3097) Parking Spaces 18 (1 stall/300 SF)

Landscape Buffer - Street Trees 418.62 LF Frontage - trees restricted due to underground Utilities and Easements

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Trees set back min. 5' from head-in parking


Detention Pond Trees 2,700.00 SF +-

4 One canopy tree per 750 SF 2 One accent tree per 1,500 SF

Visibility Triangles As reflected on plan per the UDC

Irrigation Shall meet all requirements per the UDC

Rights-of-Way & Landscape Buffers Shall meet all requirements per the UDC - improved with grass (sod)

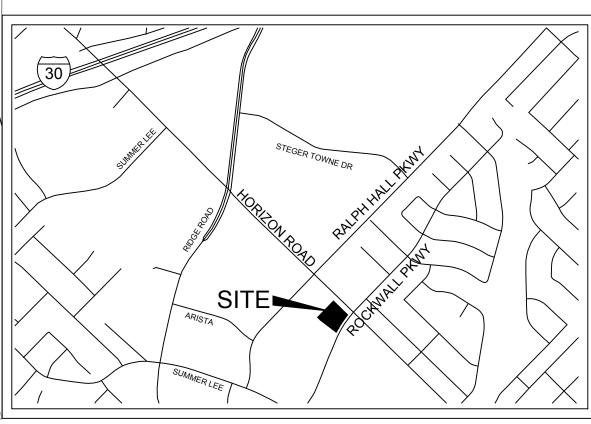

VICINITY MAP
NOT TO SCALE

TREESCAPE PLAN











FROST BANK **ROCKWALL FINANCIAL CENTER**



ROCKWALL

ROCKWAL PKWY ROCKWALL, TX US 75032

EXTERIOR SIGNAGE


12.16.2021

210P5428



This sign is intended to be installed in accordance with the requirements of Article 600 of the National Electrical Code and/or other applicable local codes. This includes proper grounding and bonding of the sign. Dimensions are approximate & may change due to construction factors or exact field conditions. Color shown are as close as printing will allow; Always follow written specifications. All rights reserved: This design has been created for you in connection with a project being planned for you by SSC Signs & Lighting. It may not be reproduced in any manner without prior consent.

SITE MAP

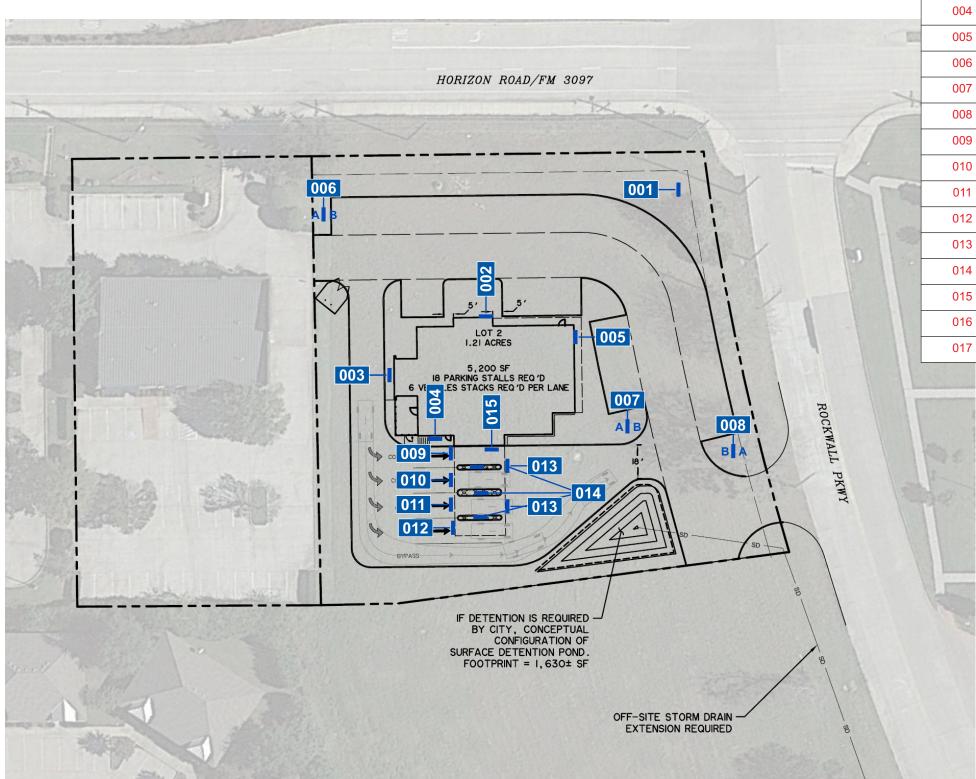


	SIGN SCHEDULE						
	LOCATION	SIGN TYPE	QTY	ITEM DESCRIPTION			
	001	PL.20	1	ILLUMINATED PYLON SIGN			
	002	ICL.30	1	ILLUMINATED CHANNEL LETTERS			
	003	ICL.24	1	ILLUMINATED CHANNEL LETTERS			
	004	ICL.30	1	ILLUMINATED CHANNEL LETTERS			
100	005	ICL.30	1	ILLUMINATED CHANNEL LETTERS			
	006	DS.01	1	DIRECTIONAL SIGN			
7	007	DS.01	1	DIRECTIONAL SIGN			
	800	DS.01	1	DIRECTIONAL SIGN			
	009	LD.01	1	LANE DESIGNATOR COMMERCIAL			
	010	LD.01	1	LANE DESIGNATOR COMMERCIAL			
	011	LD.01	1	LANE DESIGNATOR ATM/PERSONAL			
	012	LD.01	1	LANE DESIGNATOR PERSONAL			
-24	013	LD.02	2	LANE DESIGNATOR DO NOT ENTER			
	014	DSS.01	3	DEPOSIT SLIP STAND			
	015	DSB.01	1	DEPOSIT SLIP BOX			
	016	PS.01	1	PARKING SIGN W/ VAN			
1	017	PS.01	1	PARKING SIGN			

APPROVED:
I HEREBY CERTIFY THAT THE ABOVE AND FOREGOING SITE PLAN FOR A DEVELOPMENT IN THE CITY OF ROCKWALL, TEXAS, WAS APPROVED BY THE PLANNING & ZONING COMMISSION OF THE CITY OF ROCKWALL ON THE ___ DAY OF _____, ___

WITNESS OUR HANDS, THIS ___ OF ____.

PLANNING & ZONING COMMISSION, CHAIRMAN

DIRECTOR OF PLANNING AND ZONING

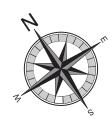



CLIENT **FROST** ROCKWALL **ADDRESS ROCKWAL PKWY** ROCKWALL, TX US 75032 **DATE** 12.16.2021 **DESIGNER - RSH** DRAWING NO.

210P5428

REVISION	DATE	


APPROVAL DATE -

APPROVED BY -

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PAGE 2 OF 16

PL.20 - ILLUMINATED PYLON

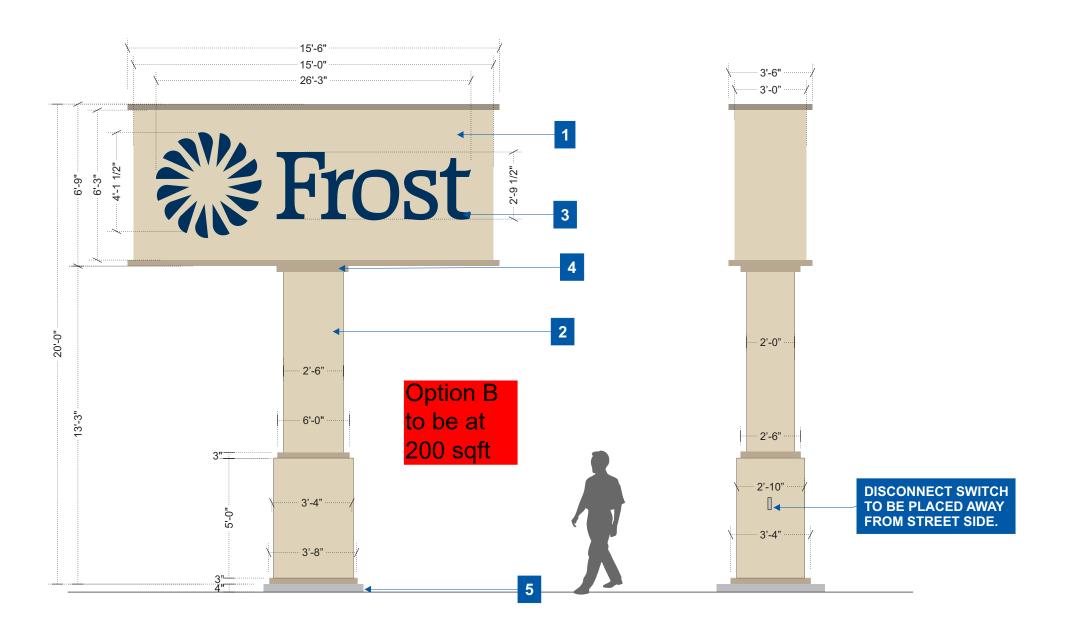

001 PL.20 - ILLUMINATED PYLON SCALE: 1/4"= 1' 100 SQ FT.


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WITNESS OUR HANDS, THIS ___ OF ____.

PLANNING & ZONING COMMISSION, CHAIRMAN DIRECTOR OF PLANNING AND ZONING

SPECIFICATIONS

- 1. FABRICATED ALUMINUM SIGN CABINET PAINTED SOLID COLOR TO MATCH STONE AKZO NOBEL COLORMAP 422A2.
- 2. FABRICATED ALUMINUM CLADDING PAINTED AKZO NOBELCOLORMAP 422A2.
- 3. SANDED 3/16" CLEAR FACE. 1/4" INSET EDGE TO BE ILLUMINATED. 1ST SURFACED APPLIED PERFORATED VINYL W/ 2ND SURFACE APPLIED 70% WHITE DIFFUSER. 3" DEEP CHANNEL LETTERS. .063 ALUM. RETURNS PAINTED TO MATCH PMS 540C BLUE. RETAINING BAND SIZE TO BE PROPORTIONAL TO LETTERS SIZE
- 4. ALUMINUM TRIM PAINTED MED FROST BEIGE SW6107 NOMADIC DESERT
- 5. 4" CONCRETE PAD
- **RETAILORED LOGO

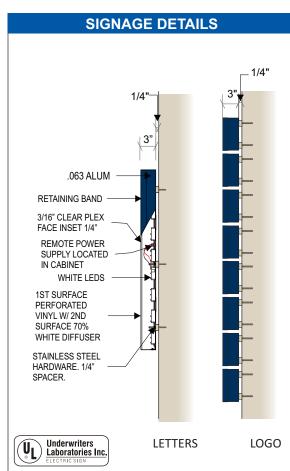

- V1 VINYL- 3M SCOTCHCAL 3635-210 PMS540C - V2 - 3M SCOTCHCAL TO MATCH PMS540C
- V5 DIFFUSER 70% WHITE
- P2 PAINT TO MATCH COLOR A AKZO NOBEL 422A2
- P4 PAINT TO MATCH COLOR B SW6107 NOMADIC DESERT



CLIENT FROST ROCKWALL ADDRESS

ROCKWAL PKWY ROCKWALL, TX US 75032

DATE 12.16.2021
DESIGNER - RSH
DRAWING NO.
210P5428

REVISION	DATE

APPROVAL DATE -

APPROVED BY -

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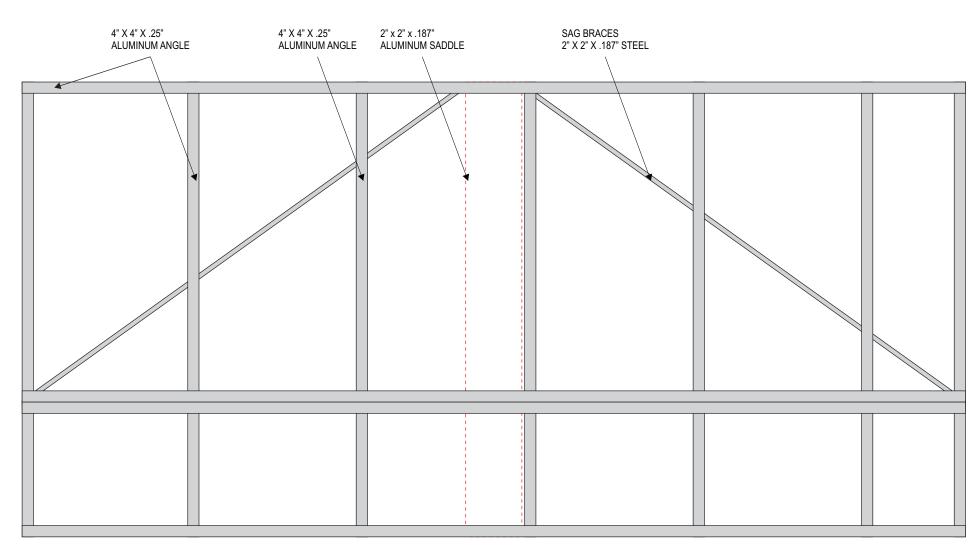
PAGE 3 OF 16

PYLON FRAME DETAIL


2" x 2" x 187" ALUMINUM
JACK BRACES

SAG BRACES

TOP ELEVATION



FRONT ELEVATION

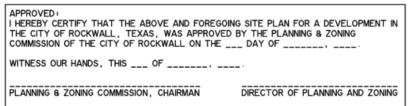



CLIENT FROST ROCKWALL ADDRESS	
ROCKWAL PKWY ROCKWALL, TX U	S 75032
DATE 12.16.20 DESIGNER - RSF DRAWING NO. 210P5428	
REVISION	DATE

SAG BRACES

SIDE ELEVATION


APPROVED BY -

APPROVAL DATE -

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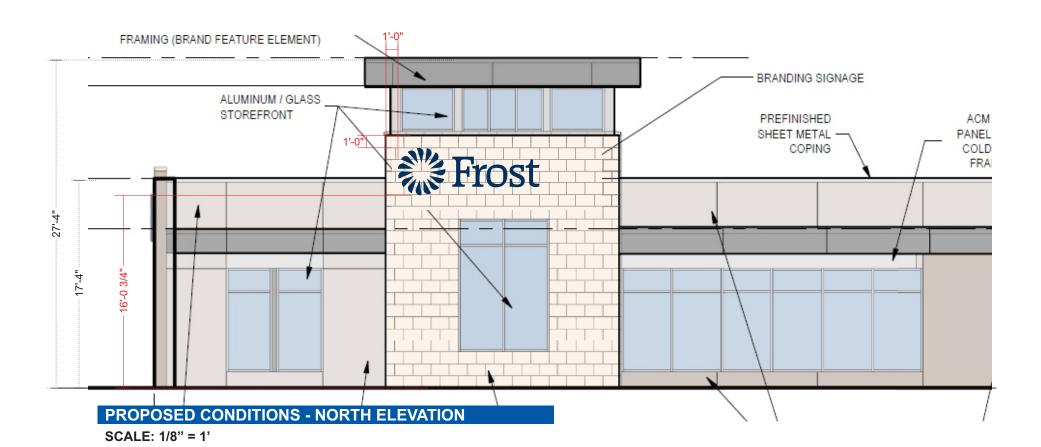
PAGE 4 OF 16

ICL.30 - ILLUMINATED CHANNEL LETTERS - NORTH ELEVATION

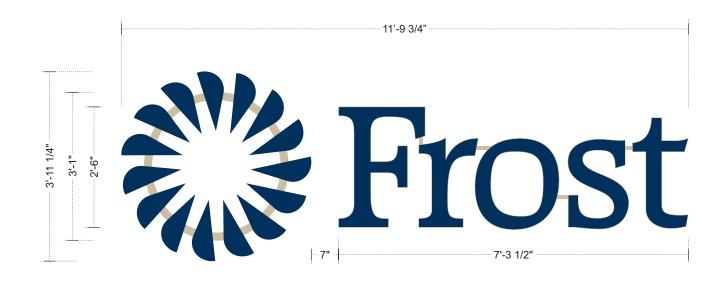

ICL.30 - ILLUMINATED CHANNEL LETTERS

SCALE: 1/2"= 1' - QTY 1



34 SQ FT.

APPROVED:
I HEREBY CERTIFY THAT THE ABOVE AND FOREGOING SITE PLAN FOR A DEVELOPMENT IN
THE CITY OF ROCKWALL, TEXAS, WAS APPROVED BY THE PLANNING & ZONING
COMMISSION OF THE CITY OF ROCKWALL ON THE ___ DAY OF _____,
WITNESS OUR HANDS, THIS ___ OF _____,
PLANNING & ZONING COMMISSION, CHAIRMAN DIRECTOR OF PLANNING AND ZONING

SIGN SCHEDULE

LOGO AND LETTERS:

FACE MATERIAL: 1/2" CLEAR FACE. 1/4" INSET. FACE FINISH: 3635-210 PMS540C / 1/4" PMS

540C OUTLINE - OPQ

RETURN MATERIAL: .063 ALUMINUM


RETURN FINISH: PAINT TO MATCH PMS540 C

RETURN DEPTH: 2 1/2"

SPACED OFF WALL: RACE WAY LOGO- 1/2" FROST- 1 1/2" PTM BUILDING EXTRIOR BACK MATERIAL: .090 ALUMINUM INTERNAL ILLUMINATION: WHITE LED'S

*RETAILORED LOGO

*RAILWAYS TO MATCH EXTERIOR OF BUILDING

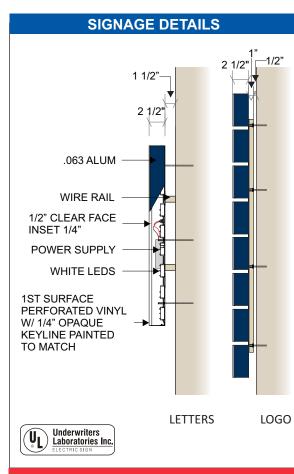

ELECTRICAL NOTE ELECTRICAL BY OTHERS

V1 - VINYL- 3M SCOTCHCAL 3635-210 PMS540C

V4 - DIFFUSER - 70% WHITE

P1 - PAINT TO MATCH PMS 540C - BLUE

PAINT TO MATCH BUILDING EXTRIOR



CLIENT FROST ROCKWALL ADDRESS

ROCKWAL PKWY
ROCKWALL, TX US 75032


DATE

DATE 12.16.2021
DESIGNER - RSH
DRAWING NO.
210P5428

REVISION
4 DDDOV41 D 4 T 5
APPROVAL DATE
APPROVED BY -
-
This sign is intended installed in accordan requirements of Artic


to be e with the e 600 of the National Electrical Code and/or other applicable local codes. This includes proper grounding and bonding of the sign. Dimensions are approximate & may change due to construction factors or exact field conditions. Color shown areas close as printing will allow; Always follow written specifications. All rights reserved This design has been created for you in connection with a project being planned for you by SSC Signs & Lighting. It may not be reproduced in any manner without prior consent.

PAGE 5 OF 16

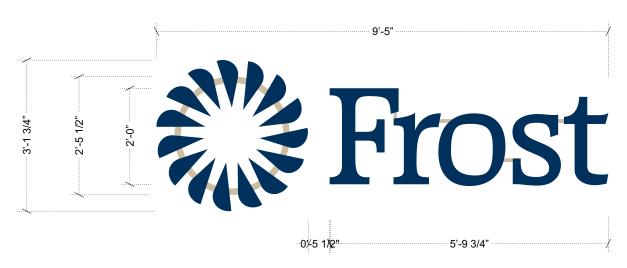

nna ICL.24 - ILLUMINATED CHANNEL LETTERS

SCALE: 1/2"= 1' - QTY 1 29 SQ FT.

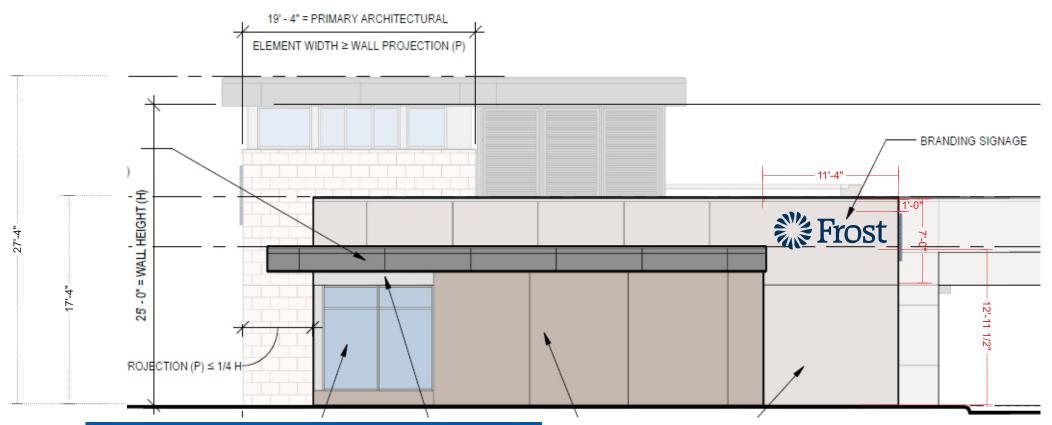

PROPOSED CONDITIONS - WEST ELEVATION

SCALE: 1/8" = 1'

APPROVED:
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PLANNING & ZONING COMMISSION, CHAIRMAN DIRECTOR OF PLANNING AND ZONING

SIGN SCHEDULE

LOGO AND LETTERS:

FACE MATERIAL: 1/2" CLEAR FACE. 1/4" INSET. FACE FINISH: 3635-210 PMS540C / 1/4" PMS

540C OUTLINE - OPQ

RETURN MATERIAL: .063 ALUMINUM


RETURN FINISH: PAINT TO MATCH PMS540 C

RETURN DEPTH: 2 1/2"

SPACED OFF WALL: RACE WAY LOGO- 1/2" FROST- 1 1/2" PTM BUILDING EXTRIOR BACK MATERIAL: .090 ALUMINUM INTERNAL ILLUMINATION: WHITE LED'S

*RETAILORED LOGO

*RAILWAYS TO MATCH EXTERIOR OF BUILDING

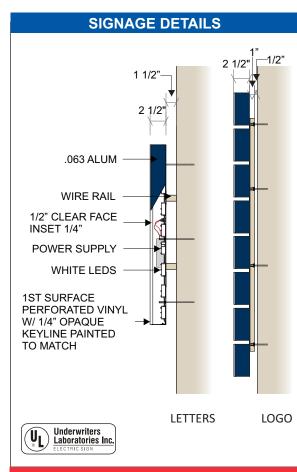

ELECTRICAL NOTE ELECTRICAL BY OTHERS

V1 - VINYL- 3M SCOTCHCAL 3635-210 PMS540C
V4 - DIFFUSER - 70% WHITE
P1 - PAINT TO MATCH PMS 540C - BLUE
PAINT TO MATCH BUILDING EXTRIOR



CLIENT FROST ROCKWALL ADDRESS

ROCKWAL PKWY ROCKWALL, TX US 75032

DATE 12.16.2021 DESIGNER - RSH DRAWING NO.

210P5428

REVISION	DATI		


APPROVAL DATE -

APPROVED BY -


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PAGE 6 OF 16

ICL.30 - ILLUMINATED CHANNEL LETTERS - SOUTH ELEVATION

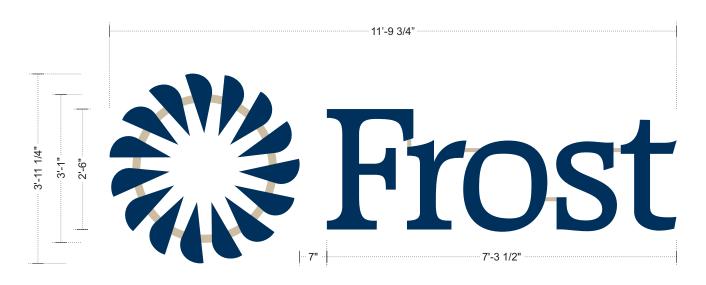

1004 ICL.30 - ILLUMINATED CHANNEL LETTERS SCALE: 1/2"= 1' - QTY 1 34 SQ FT.

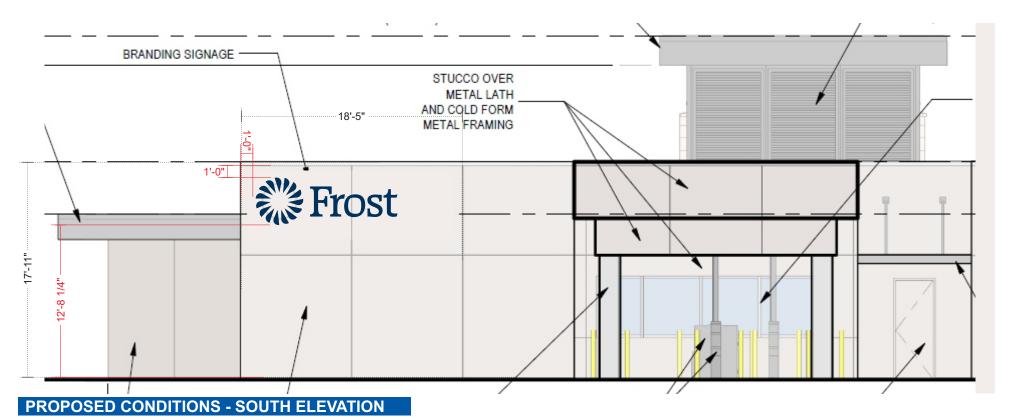

SCALE: 1/8" = 1'

APPROVED:
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WITNESS OUR HANDS, THIS ___ OF ____.

PLANNING & ZONING COMMISSION, CHAIRMAN DIRECTOR OF PLANNING AND ZONING

SIGN SCHEDULE

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540C OUTLINE - OPQ

RETURN MATERIAL: .063 ALUMINUM


RETURN FINISH: PAINT TO MATCH PMS540 C

RETURN DEPTH: 2 1/2"

SPACED OFF WALL: RACE WAY LOGO- 1/2" FROST- 1 1/2" PTM BUILDING EXTRIOR BACK MATERIAL: .090 ALUMINUM INTERNAL ILLUMINATION: WHITE LED'S

*RETAILORED LOGO

*RAILWAYS TO MATCH EXTERIOR OF BUILDING

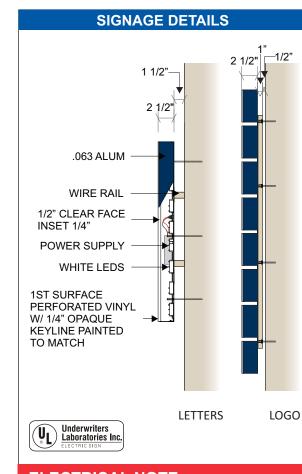

ELECTRICAL NOTE ELECTRICAL BY OTHERS

V1 - VINYL- 3M SCOTCHCAL 3635-210 PMS540C
V4 - DIFFUSER - 70% WHITE
P1 - PAINT TO MATCH PMS 540C - BLUE
PAINT TO MATCH BUILDING EXTRIOR



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ROCKWAL PKWY ROCKWALL, TX US 75032

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DRAWING NO.
210P5428


REVISION	DATE

APPROVAL DATE -


APPROVED BY -

This sign is intended to be installed in accordance with the requirements of Article 600 of the National Electrical Code and/or other applicable local codes. This includes proper grounding and bonding of the sign. Dimensions are approximate & may change due to construction factors or exact field conditions. Color shown areas close as printing will allow; Always follow written specifications. All rights reserved This design has been created for you in connection with a project being planned for you by SSC Signs & Lighting. It may not be reproduced in any manner without prior consent.

PAGE 7 OF 16

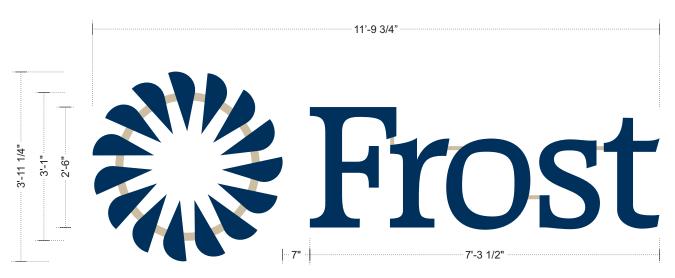

OO5 ICL.30 - ILLUMINATED CHANNEL LETTERS
SCALE: 1/2"= 1' - OTY 1 34 SQ FT.

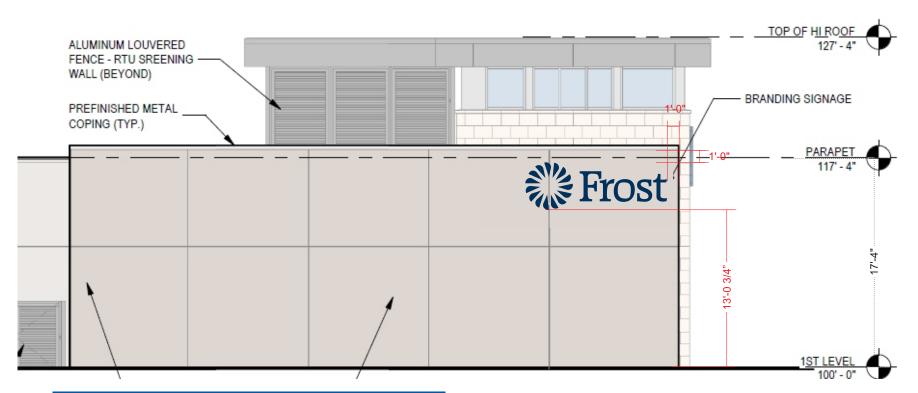

PROPOSED CONDITIONS - EAST ELEVATION

SCALE: 1/8" = 1'

APPROVED:
I HEREBY CERTIFY THAT THE ABOVE AND FOREGOING SITE PLAN FOR A DEVELOPMENT IN THE CITY OF ROCKWALL, TEXAS, WAS APPROVED BY THE PLANNING & ZONING COMMISSION OF THE CITY OF ROCKWALL ON THE ___ DAY OF _____, ___.

WITNESS OUR HANDS, THIS ___ OF ____.

PLANNING & ZONING COMMISSION, CHAIRMAN DIRECTOR OF PLANNING AND ZONING

SIGN SCHEDULE

LOGO AND LETTERS:

FACE MATERIAL: 1/2" CLEAR FACE. 1/4" INSET. FACE FINISH: 3635-210 PMS540C / 1/4" PMS

540C OUTLINE - OPQ

RETURN MATERIAL: .063 ALUMINUM


RETURN FINISH: PAINT TO MATCH PMS540 C

RETURN DEPTH: 2 1/2"

SPACED OFF WALL: RACE WAY LOGO- 1/2" FROST- 1 1/2" PTM BUILDING EXTRIOR BACK MATERIAL: .090 ALUMINUM INTERNAL ILLUMINATION: WHITE LED'S

*RETAILORED LOGO

*RAILWAYS TO MATCH EXTERIOR OF BUILDING

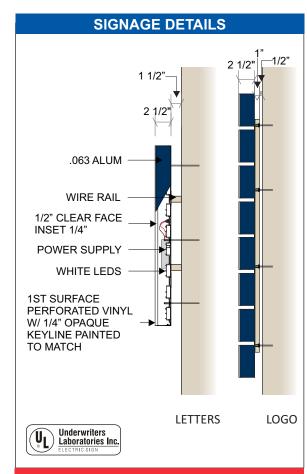

ELECTRICAL NOTE ELECTRICAL BY OTHERS

V1 - VINYL- 3M SCOTCHCAL 3635-210 PMS540C
V4 - DIFFUSER - 70% WHITE
P1 - PAINT TO MATCH PMS 540C - BLUE
PAINT TO MATCH BUILDING EXTRIOR



CLIENT FROST ROCKWALL ADDRESS

ROCKWAL PKWY ROCKWALL, TX US 75032

DATE

DATE 12.16.2021
DESIGNER - RSH
DRAWING NO.
210P5428

REVISION
APPROVAL DATE
APPROVED BY -
This sign is intended installed in accordan

This sign is intended to be installed in accordance with the requirements of Article 600 of the National Electrical Code and/or other applicable local codes. This includes proper grounding and bonding of the sign. Dimensions are approximate & may change due to construction factors or exact field conditions. Color shown areas close as printing will allow; Always follow written specifications. All rights reserved: This design has been created for you in connection with a project being planned for you by SSC Signs & Lighting. It may not be reproduced in any manner without prior consent.

PAGE 8 OF 16

SPECIFICATIONS DS.01 - DIRECTIONAL SIGNAGE 1. FABRICATED ALUMINUM CABINET W/ EMS 24-63-215 SIGN FRAME & EMS 24-63-216 SIGN RETAINER. BASE REVEAL TRIM TO BE .125" − 8 1/4" *−* ALUMINUM .CABINET TO BE PAINTED AKZO 1 1/2" **NOBLE COLORMAP 422A2.** 2. 1/2" PUSHED THRU ACRYLIC PAINTED TO **1** LOBBY MATCH PMS 540C BLUE. ← MOTOR **BANK** FONT: VERLAG BOLD **→** MOTOR 2 **†** EXIT BANK 3. .125 ROUTED ALUMINUM FACES PAINTED **AKZO NOBEL COLORMAP 422A2** → ATM 4. "STOP SIGN"/"DO NOT ENTER" DIGITAL 6 PRINTED TO 3M REFLECTIVE. 3 5. NEW CONCRETE PAD **CENTER POST** 6. CENTER POST IS 2" X 2" X 70" ALUMINUM SQ. TUBE *CABINET TO BE SCREWED TO CENTER **POLE** 5 - 0¦-10" -SIDE A SIDE B 2'-0" **DS.01 - DIRECTIONAL SIGNAGE** SCALE: 3/4"= 1' − 8 1/4" − 1 1/2" APPROVED: I HEREBY CERTIFY THAT THE ABOVE AND FOREGOING SITE PLAN FOR A DEVELOPMENT IN THE CITY OF ROCKWALL, TEXAS, WAS APPROVED BY THE PLANNING & ZONING 2 1/2" **←** LOBBY COMMISSION OF THE CITY OF ROCKWALL ON THE ___ DAY OF _____, 2 1/2" DO NOT 2 WITNESS OUR HANDS, THIS ___ OF ____. ___ **↑** EXIT PLANNING & ZONING COMMISSION, CHAIRMAN 4 DIRECTOR OF PLANNING AND ZONING **ENTER** 3 6 **CENTER POST** 5 - 0'-10" -SIDE A SIDE B V5 - VINYL - DG REFLECTIVE SHEETING 4090DS

DS.01 - DIRECTIONAL SIGNAGE

SCALE: 3/4"= 1"

2'-0"

972.219.2495

CLIENT FROST ROCKWALL ADDRESS

ROCKWAL PKWY ROCKWALL, TX US 75032

DATE 12.16.2021 **DESIGNER - RSH DRAWING NO.**

210P5428

REVISION	DATE

APPROVAL DATE -

APPROVED BY -


This sign is intended to be installed in accordance with the requirements of Article 600 of the National Electrical Code and/or other applicable local codes. This includes proper grounding and bonding of the sign. Dimensions are approximate & may change due to construction factors or exact field conditions. Color shown areas close as printing will allow; Always follow written specifications. All rights reserved: This design has been created for you in connection with a project being planned for you by SSC Signs & Lighting. It may not be reproduced in any manner without prior consent.

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P1 - PAINT TO MATCH PMS 540C - BLUE

P2 - PAINT TO MATCH AKZO NOBEL 422A2

DS.01 - DIRECTIONAL SIGNAGE

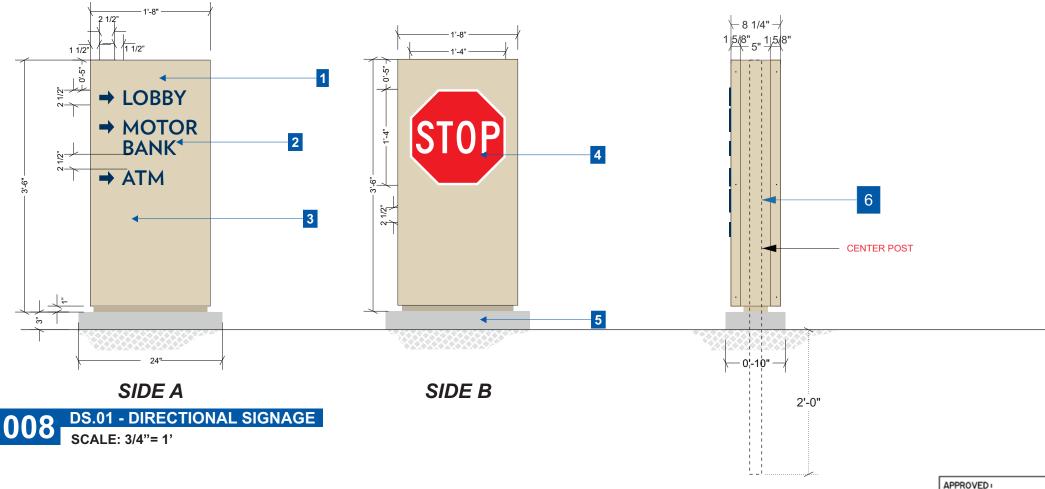

SPECIFICATIONS

- 1. FABRICATED ALUMINUM CABINET W/ EMS 24-63-215 SIGN FRAME & EMS 24-63-216 SIGN RETAINER. BASE REVEAL TRIM TO BE .125" ALUMINUM .CABINET TO BE PAINTED AKZO NOBLE COLORMAP 422A2.
- 2. 1/2" PUSHED THRU ACRYLIC PAINTED TO MATCH PMS 540C BLUE.

FONT: VERLAG BOLD

- 3. .125 ROUTED ALUMINUM FACES PAINTED AKZO NOBEL COLORMAP 422A2
- 4. "STOP SIGN"/"DO NOT ENTER" DIGITAL PRINTED TO 3M REFLECTIVE.
- 5. NEW CONCRETE PAD
- 6. CENTER POST IS 2" X 2" X 70" ALUMINUM SQ. TUBE

*CABINET TO BE SCREWED TO CENTER **POLE**

972.219.2495

CLIENT **FROST** ROCKWALL ADDRESS

ROCKWAL PKWY ROCKWALL, TX US 75032

DATE 12.16.2021 **DESIGNER - RSH DRAWING NO.** 210P5428

REVISION	DATE

APPROVAL DATE -

APPROVED BY -

This sign is intended to be installed in accordance with the requirements of Article 600 of the National Electrical Code and/or other applicable local codes. This includes proper grounding and bonding of the sign. Dimensions are approximate & may change due to construction factors or exact field conditions. Color shown areas close as printing will allow; Always follow written specifications. All rights reserved: This design has been created for you in connection with a project being planned for you by SSC Signs & Lighting. It may not be reproduced in any manner without prior consent.

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PAGE 10 OF 16


I HEREBY CERTIFY THAT THE ABOVE AND FOREGOING SITE PLAN FOR A DEVELOPMENT IN THE CITY OF ROCKWALL, TEXAS, WAS APPROVED BY THE PLANNING & ZONING COMMISSION OF THE CITY OF ROCKWALL ON THE ___ DAY OF _____, ___. WITNESS OUR HANDS, THIS ___ OF ____. ___

PLANNING & ZONING COMMISSION, CHAIRMAN


DIRECTOR OF PLANNING AND ZONING

V5 - VINYL - DG REFLECTIVE SHEETING 4090DS
P1 - PAINT TO MATCH PMS 540C - BLUE
P2 - PAINT TO MATCH AKZO NOBEL 422A2

LD.01 - LANE DESIGNATOR - WEST ELEVATION

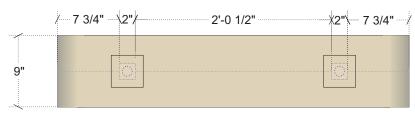

A TOP DETAIL SCALE: 1"= 1'

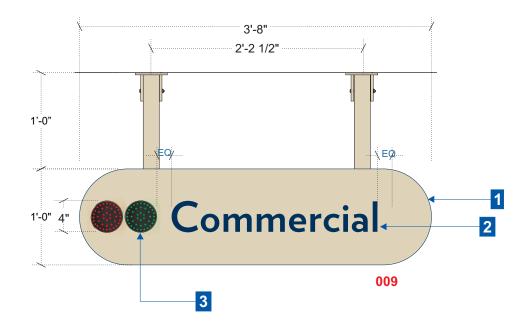


LD.01 - LANE DESIGNATORS
SCALE: 1"= 1' - QTY: 4

APPROVED:
I HEREBY CERTIFY THAT THE ABOVE AND FOREGOING SITE PLAN FOR A DEVELOPMENT IN THE CITY OF ROCKWALL, TEXAS, WAS APPROVED BY THE PLANNING & ZONING COMMISSION OF THE CITY OF ROCKWALL ON THE ___ DAY OF _____.

WITNESS OUR HANDS, THIS ___ OF ____.


PLANNING & ZONING COMMISSION, CHAIRMAN DIRECTOR OF PLANNING AND ZONING

\ **EQ** /...

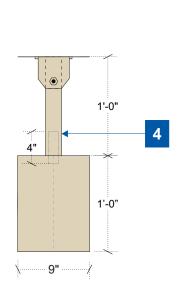



B SIDE DETAIL SCALE: 1"= 1"

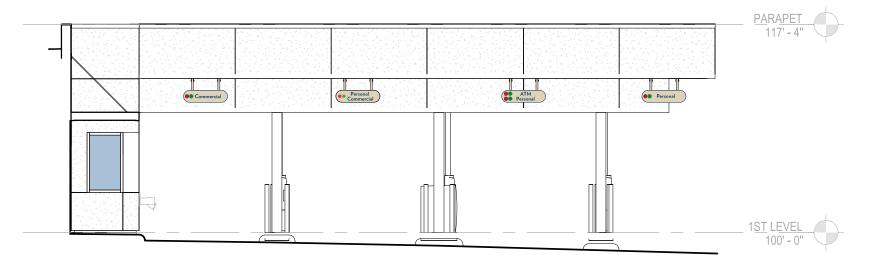

PROPOSED CONDITIONS - WEST ELEVATION


SCALE: 1/8" = 1'

SPECIFICATIONS

- 1. ALUMINUM SIGN CABINET PAINTED AKZO NOBEL COLORMAP 422A2 BEIGE
- 2. ROUTED ALUMINUM FACE PAINTED AKZO NOBEL COLORMAP 422A2 BEIGE. BACKED UP WHITE PLEX COPY W/APPLIED 3M SCOTCHCAL 3635-210 PMS540C

FONT: VERLAG BOLD

- 3. I SIGNS RED & GREEN LED LIGHT INDICATORS
- 4. 2"x 2" ALUMINUM TUBE ABLE TO BE CUT IN FIELD TO FIT FOR INSTALLATION WITH MOUNTED TO CABINET WITH 1 1/4" ALUMINUM PIPE WITH MECHANICAL FASTERNERS

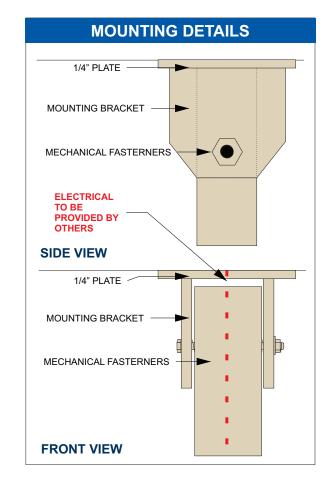

V1 - VINYL- 3

V1 - VINYL- 3M SCOTCHCAL 3635-210 PMS540C

P2 - PAINT TO MATCH AKZO NOBEL 422A2



CLIENT FROST ROCKWALL ADDRESS

ROCKWAL PKWY ROCKWALL, TX US 75032

DATE 12.16.2021
DESIGNER - RSH
DRAWING NO.
210P5428

REVISION	DATE

APPROVAL DATE -

APPROVED BY -

This sign is intended to be installed in accordance with the requirements of Article 600 of the National Electrical Code and/or other applicable local codes. This includes proper grounding and bonding of the sign. Dimensions are approximate & may change due to construction factors or exact field conditions. Color shown areas close as printing will allow; Always follow written specifications. All rights reserved: This design has been created for you in connection with a project being planned for you by SSC Signs & Lighting. It may not be reproduced in any manner without prior consent.


PAGE 11 OF 16

WWW.**sscsigns**.com

LD.02 - LANE DESIGNATOR



A TOP DETAIL SCALE: 1"= 1'

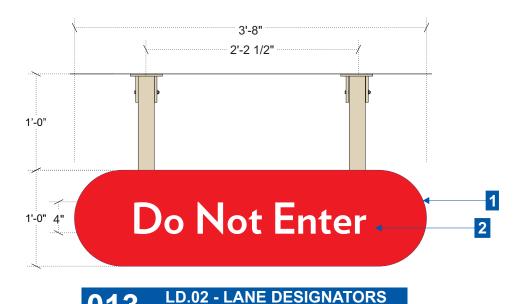


SCALE: 1"= 1' - QTY: 2


APPROVED:
I HEREBY CERTIFY THAT THE ABOVE AND FOREGOING SITE PLAN FOR A DEVELOPMENT IN THE CITY OF ROCKWALL, TEXAS, WAS APPROVED BY THE PLANNING & ZONING COMMISSION OF THE CITY OF ROCKWALL ON THE ___ DAY OF _____, ___.

WITNESS OUR HANDS, THIS ___ OF ____.

PLANNING & ZONING COMMISSION, CHAIRMAN DIRECTOR OF PLANNING AND ZONING

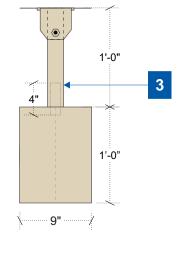

B SIDE DETAIL SCALE: 1"= 1"

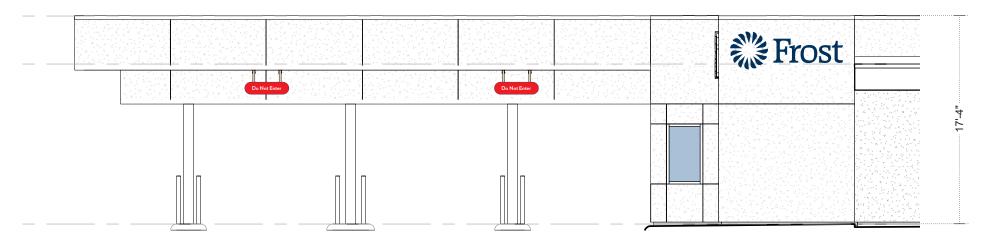

PROPOSED CONDITIONS - EAST ELEVATION


SCALE: 1/8" = 1'


SPECIFICATIONS

- 1. ALUMINUM SIGN CABINET PAINTED AKZO NOBEL COLORMAP 422A2 BEIGE
- 2. ROUTED ALUMINUM FACE PAINTED TO MATCH CARDINAL RED. BACKED UP WHITE PLEX COPY W/ APPLIED PERF VINYL TO MATCH WHITE

FONT: VERLAG BOLD

3.2"x 2" ALUMINUM TUBE ABLE TO BE CUT IN FIELD TO FIT FOR INSTALLATION WITH MOUNTED TO CABINET WITH 1 1/4" ALUMINUM PIPE WITH MECHANICAL FASTERNERS

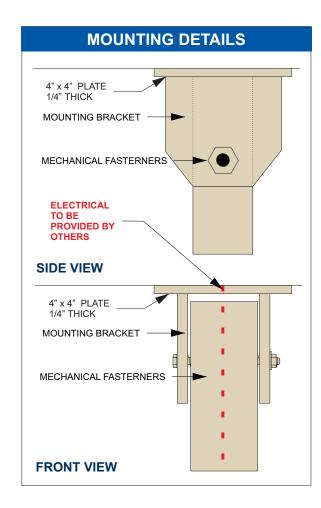

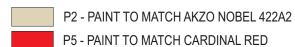

V3 - VINYL- 3M SCOTCHCAL 7725-10 WHITE



CLIENT FROST ROCKWALL ADDRESS

ROCKWAL PKWY ROCKWALL, TX US 75032

DATE 12.16.2021
DESIGNER - RSH
DRAWING NO.
210P5428

REVISION	DATE


APPROVAL DATE -

APPROVED BY -

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PAGE 12 OF 16

DSS.01 - DEPOSIT SLIP STANDS

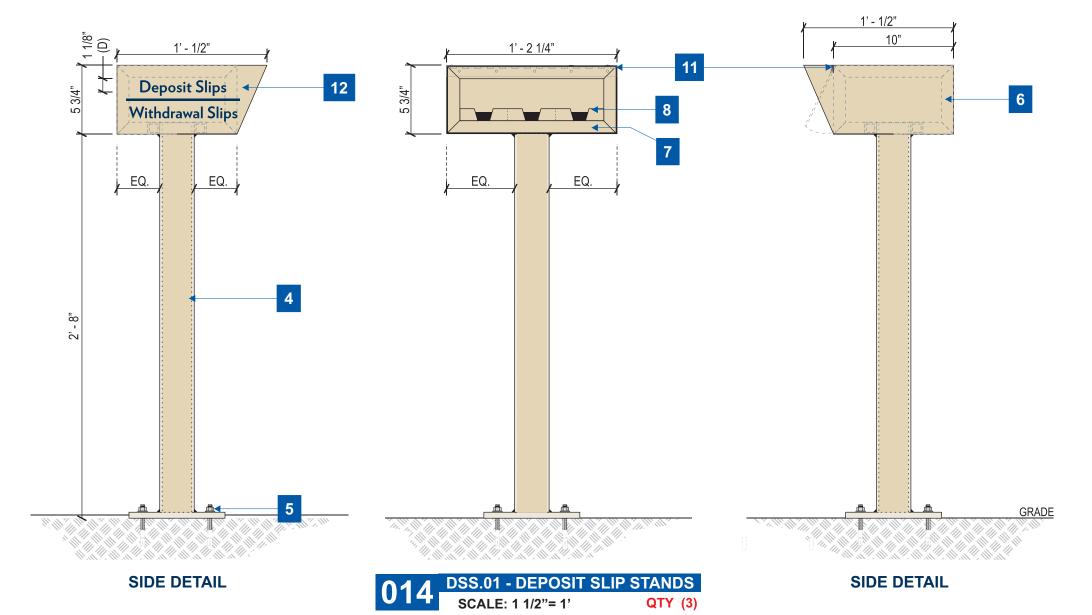

SPECIFICATIONS

1. ½"X8"X8" ALUM PLATE 3M 3630-36 DARK

FONT: VERLAG BOLD

2. ½" HOLES FOR ¾" HARDWARE

3. 2 1/2" SCH. 40 ALUM. PIPE (2 1/8" X 4.469 X .203). POWDERCOATED FROST BEIGE

4. 2 ½" SCH. 40 ALUM. PIPE (2 ½" X 4.469 X .203). POWDER COATED FROST BEIGE

5. %" HILTI KWICK-BOLT III STAINLESS STEEL (4 PLCS REQ'D) SEE PLATE DETAIL

6. 1"X 1/4" ALUM. SQ TUBE INNER FRAME. POWDER COATED FROST BEIGE (SHOWN BY DOTTED GRAY LINES)

7. 1/4" BREAK FORMED ALUM. SKIN AROUND BANKING SLIP BOX. POWDER COATED FROST BEIGE

8. .080"X 4" SIDE TRAY FOR BANKING SLIPS (3 TOTAL TRAYS REQ'D WITH ALUMINUM SPACER.)

9. 2 ½" SCH. 40 ALUM PIPE (2 1/8" X 2.469 X .203). POWDER COATED FROST BEIGE.

10. PIPE TO INNER TUBE FRAME

11. 1/8" CLEAR LEXAN DOOR WITH .050 LEAF X 1 1/2" PIANO HINGE. POWDER COATED FROST BEIGE (MCMASTER-CARR 15665A247) SPRING LOADED

12. BLUE VINYL COPY TO MATCH PMS 540C.



CLIENT FROST ROCKWALL ADDRESS

ROCKWAL PKWY ROCKWALL, TX US 75032

DATE 12.16.2021 **DESIGNER - RSH** DRAWING NO.

210P5428

REVISION DATE

APPROVAL DATE -

APPROVED BY -

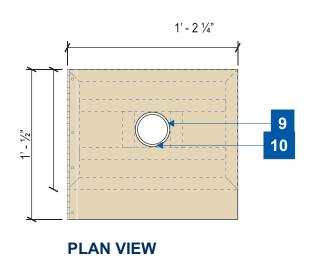
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5" (O.C.)

PLATE DETAIL




THE CITY OF THE CITY OF ROCKWALL, TEXAS, WAS APPROVED BY THE PLANNING & ZONING COMMISSION OF THE CITY OF ROCKWALL ON THE ___ DAY OF _____, ___. WITNESS OUR HANDS, THIS ___ OF ____. ___

PLANNING & ZONING COMMISSION, CHAIRMAN


DIRECTOR OF PLANNING AND ZONING


V1 - VINYL- 3M SCOTCHCAL 3630-36 DK. BLUE P2 - PAINT TO MATCH AKZO NOBEL 422A2

DSB.01 - DEPOSIT SLIP BOX

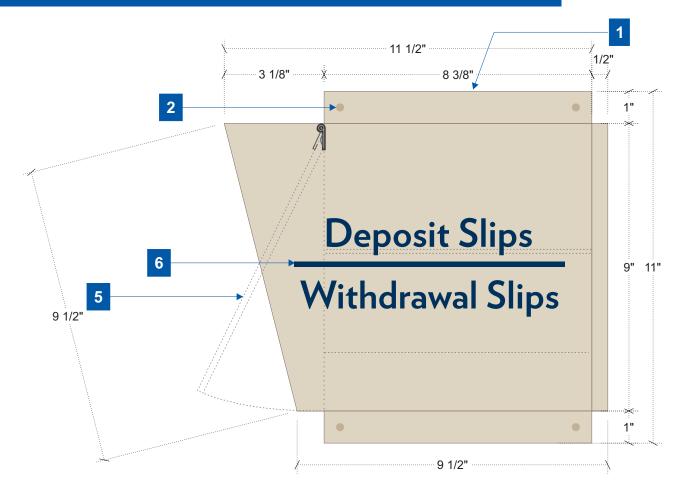

DSB.01 - DEPOSIT SLIP STANDS

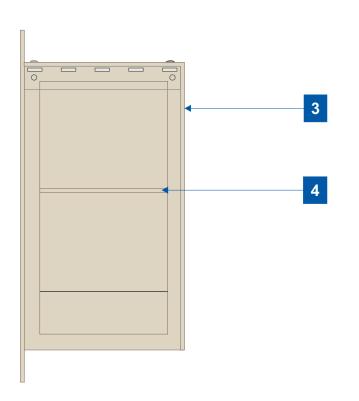

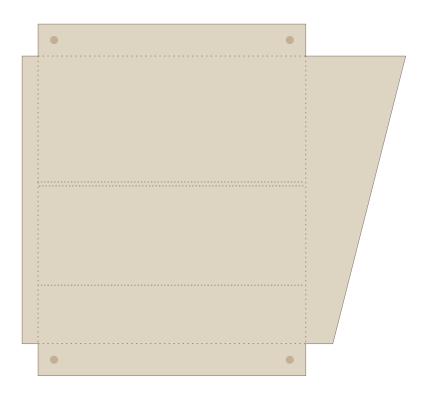

FRONT VIEW SIDE DETAIL

SPECIFICATIONS

- 1. 1/4" ALUM PLATE TO MOUNT TO WALL. POWDER COATED FROST BEIGE
- 2. ½" HOLES FOR ¾" HARDWARE
- 3. 1/4" BREAK FORMED ALUM. SKIN AROUND BANKING SLIP BOX. POWDER COATED FROST BEIGE
- 4. 1/8" ALUMINUM TRAY FOR BANKING SLIPS.
- 5. 1/8" CLEAR LEXAN DOOR WITH .050 LEAF X 1 1/2" PIANO HINGE. POWDER COATED FROST BEIGE SPRING LOADED
- 6. BLUE VINYL COPY TO MATCH PMS 540C.

V1 - VINYL- 3M SCOTCHCAL 3630-36 DK. BLUE

P2 - POWERED COATED TO MATCH AKZO NOBEL 422A2

FONT: VERLAG BOLD

APPROVED:
I HEREBY CERTIFY THAT THE ABOVE AND FOREGOING SITE PLAN FOR A DEVELOPMENT IN THE CITY OF ROCKWALL, TEXAS, WAS APPROVED BY THE PLANNING & ZONING COMMISSION OF THE CITY OF ROCKWALL ON THE ___ DAY OF _____. WITNESS OUR HANDS, THIS ___ OF _____, ___ PLANNING & ZONING COMMISSION, CHAIRMAN DIRECTOR OF PLANNING AND ZONING



CLIENT **FROST ROCKWALL ADDRESS**

ROCKWAL PKWY ROCKWALL, TX US 75032

DATE 12.16.2021 **DESIGNER - RSH** DRAWING NO. 210P5428

DATE


APPROVAL DATE -

APPROVED BY -

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PS.01 - PARKING SIGNAGE



HARDSCAPE MOUNT

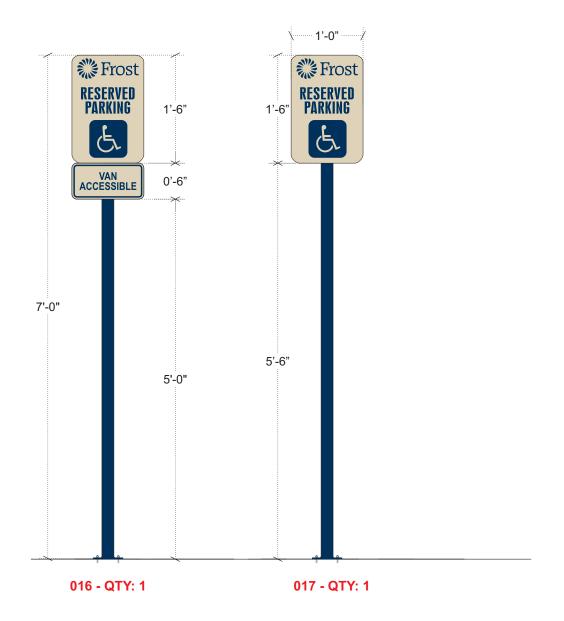016-017

PS.01 - PARKING SIGNAGE


SCALE: 3/4"= 1' - QTY: 2


I HEREBY CERTIFY THAT THE ABOVE AND FOREGOING SITE PLAN FOR A DEVELOPMENT IN THE CITY OF ROCKWALL, TEXAS, WAS APPROVED BY THE PLANNING & ZONING COMMISSION OF THE CITY OF ROCKWALL ON THE ___ DAY OF _____, WITNESS OUR HANDS, THIS ___ OF ____. PLANNING & ZONING COMMISSION, CHAIRMAN DIRECTOR OF PLANNING AND ZONING

V1 - VINYL- 3M SCOTCHCAL 3630-36 DK. BLUE P1 - PAINT TO MATCH PMS 540C - BLUE P2 - PAINT TO MATCH AKZO NOBEL 422A2

SPECIFICATIONS

- 1. .080 ALUMINUM PANEL FINISHED IN AKO COLORMAP 422A2 BEIGE WILL BE MOUNTED TO 1" ANGLE USING STRUCTURAL ADHESIVE. BRACKET WILL BE MOUNTED TO USING MECHANICAL **FASTENERS**
- 2. 3M SCHOTCAL 3630-36 DARK BLUE VINYL GRAPHICS.
- 3. 2" X 2" X 1/8" ALUMINUM SQ TUBE SUPPORT PAINTED TO MATCH PMS 540C BLUE.

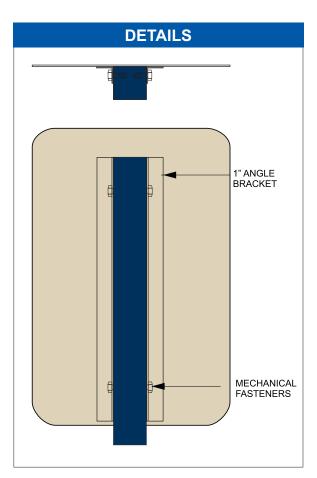

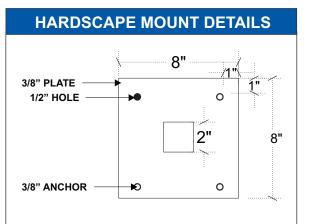



CLIENT FROST ROCKWALL ADDRESS ROCKWAL PKWY

ROCKWALL, TX US 75032

DATE 12.16.2021 **DESIGNER - RSH DRAWING NO.** 210P5428

DEVISION

REVISION	DATE

APPROVAL DATE -

APPROVED BY -

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CLIENT, MANUFACTURING, AND INSTALLATION NOTES FOR ALL DESIGNS

SSC SIGNS&LIGHTING 972,219,2495

CLIENT NOTES:

- 1) CLIENT TO PROVIDE VECTOR ARTWORK INCLUDING CORRECT FONTS.
- 2) CLIENT TO PROVIDE ALL COLORS FOR SIGNS WITHIN DESIGN INCLUDING RACEWAY COLORS. COLORS TO BE PROVIDED ARE TO BE IN A SHERWIN WILLIAMS OR PANTONE / PMS COLORS. CMYK COLORS ARE NOT USABLE.
- 3) CLIENT TO APPROVE AND INITIAL DESIGNS THEN RETURN TO SSC SIGNS & LIGHTING ONCE APPROVED.
- 4) CLIENT TO PROVIDE ELECTRICAL TO ALL ILLUMINATED SIGNS. ELECTRICAL TO BE WITHIN 5'-0" OF SIGNAGE PRIOR TO INSTALL DATE.
- 5) ALL ELECTRICAL SCOPE TO BE INSTALLED BY TENANT CONTRACTOR

MANUFACTURING NOTES:

- 1) IF SIGN NEEDS TO BE PERMITTED, MANUFACTURING WILL START AS SOON AS PERMITS ARE APPROVED BY CITY.
- 2) MANUFACTURING TO SUPPLY ALL NEEDED HARDWARE AND ELECTRICAL COMPONENTS NEEDED FOR INSTALLATION OF SIGN.
- 3) A MINIMUM OF 6'-0" WHIPS FROM THE BACK OF EACH CHANNEL LETTERS FOR INSTALLATION WHEN NEEDED.

INSTALLATION NOTES:

- 1) INSTALLER TO INSPECT SIGN UPON RECEIPT AND REPORT ANY ISSUES OR DAMAGED ITEMS. INSTALLER WILL BE HELD LIABLE FOR ANY DAMAGES OR ISSUES REPORTED AFTER DAY SIGN IS RECEIVED.
- 2) INSTALLER TO VERIFY WITH CLIENT THAT SIGN IS BEING INSTALLED IN CORRECT LOCATION.
- 3) INSTALLER TO VERIFY ALL SERVICE IS COMPLETE PRIOR TO LEAVING THE SITE FOR THAT DAY AND/OR NIGHT INCLUDING COMPLETION PHOTOS OF SIGNS INSTALLED AND ILLUMINATED.
- 4) INSTALLER TO CLEAN UP ALL TRASH AND DEBRIS. ALSO, CLEAN ALL SIGNS AS NEEDED INCLUDING FACES.

CLIENT FROST ROCKWALL ADDRESS

ROCKWAL PKWY ROCKWALL, TX US 75032

DATE 12.16.2021
DESIGNER - RSH
DRAWING NO.

210P5428


REVISION	DATE


APPROVAL DATE -


APPROVED BY -


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PAGE 16 OF 16



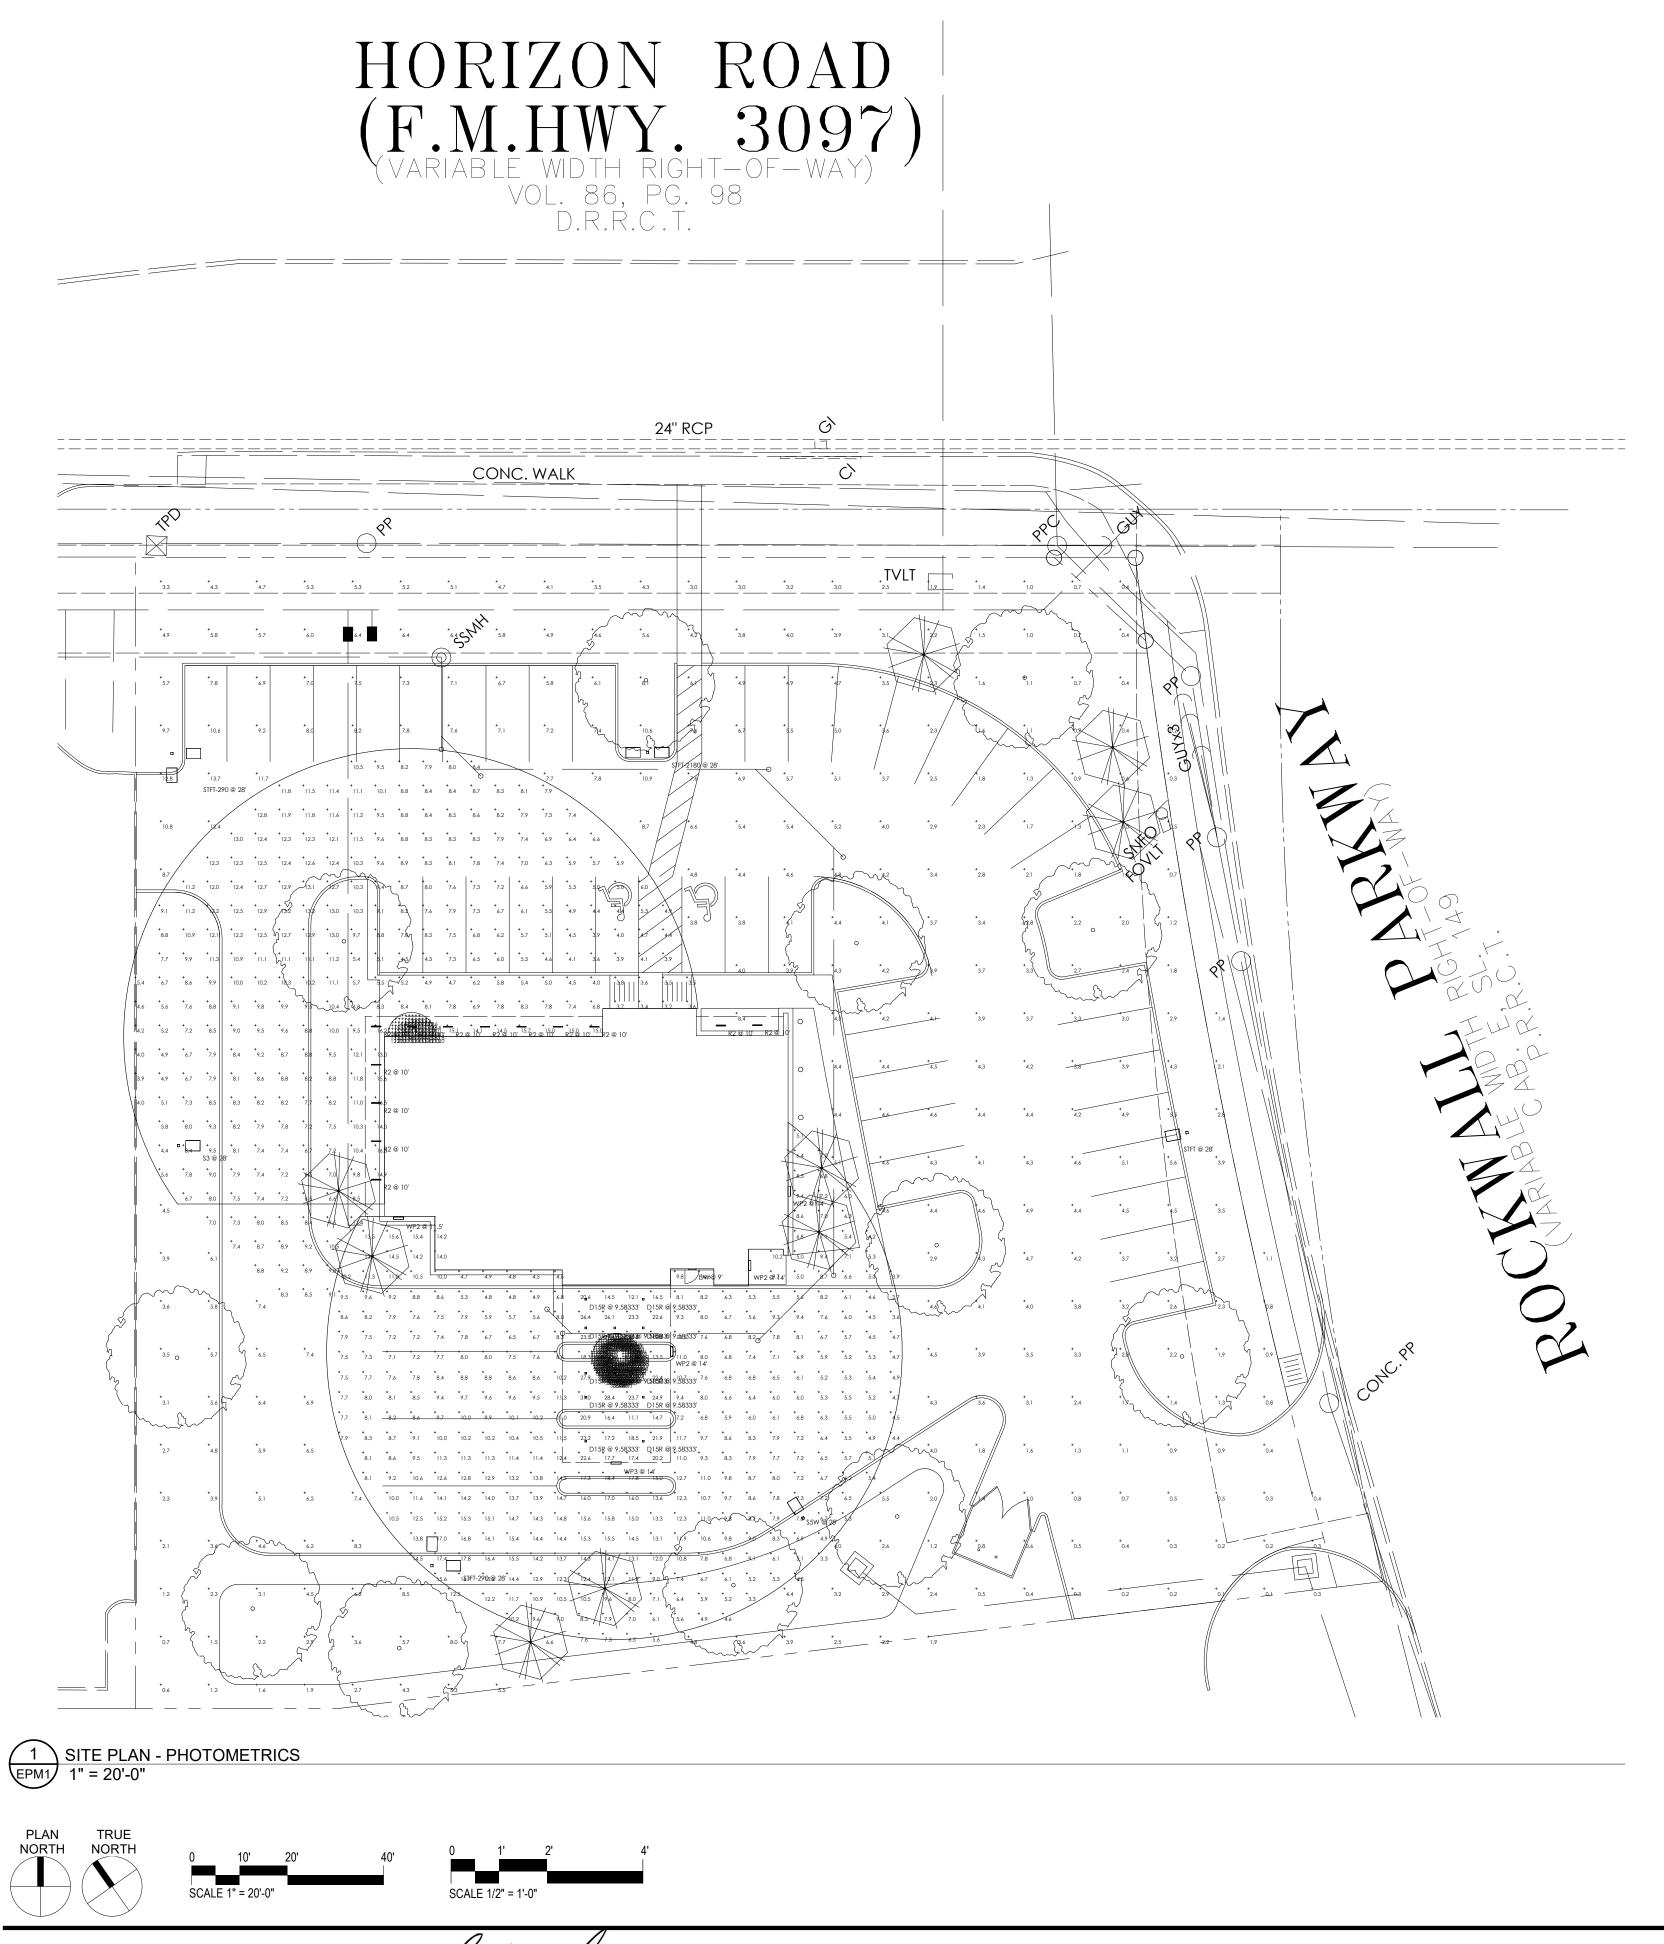

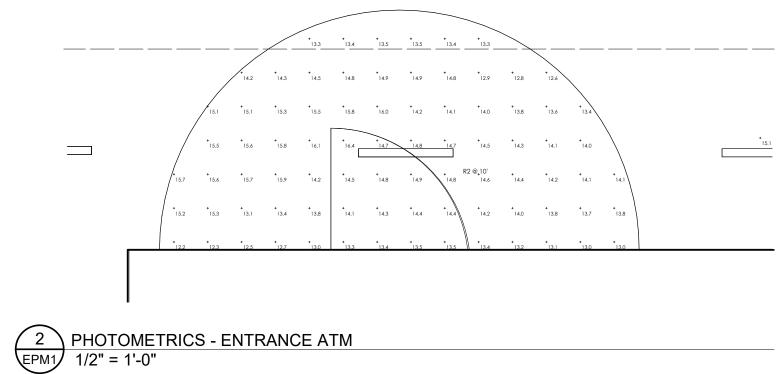


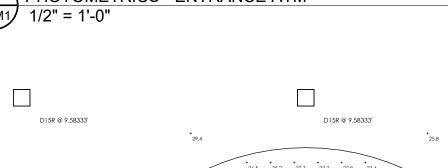

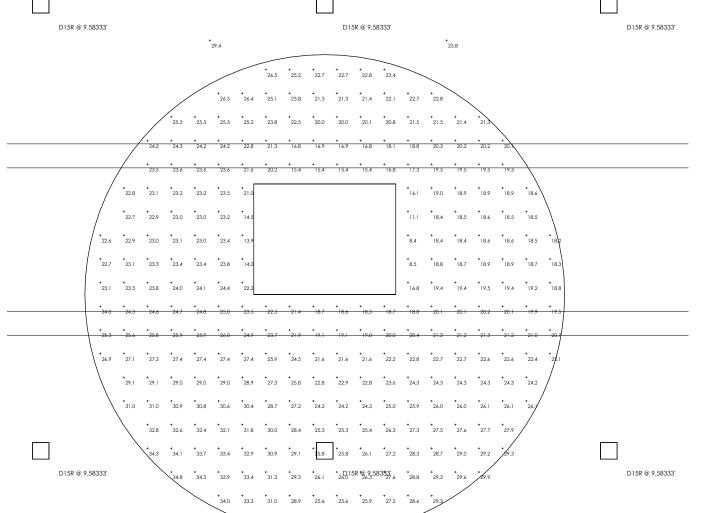

Description	Symbol	Avg	Max	Min	Max/Min	Avg/Mir
DRIVE THRU ATM 5'	+	23.7 fc	34.8 fc	8.4 fc	4.1:1	2.8:1
FRONT ATM 5'	+	14.2 fc	16.4 fc	12.2 fc	1.3:1	1.2:1
FRONT ATM 60'	+	8.5 fc	16.5 fc	3.2 fc	5.2:1	2.7:1
SITE	+	3.9 fc	13.7 fc	0.1 fc	137.0:1	39.0:1
DRIVE THRU ATM 60'	+	10.0 fc	31.0 fc	3.3 fc	9.4:1	3.0:1

Schedule	1								
Symbol	Label	Quantity	Manufacturer	Catalog Number	Description	Number Lamps	Lumens Per Lamp	Light Loss Factor	Wattage
	R2	13	Mark Architectural Lighting	SL2L 2 FLP 80CRI 40K 600LMF	Slot 2 LED, 2ft Length, Flushed Lens Position, 80CRI, 4000K LED Boards, 600LMF	1	2192	0.45	23.3
	\$3	1	Lithonia Lighting	DSX2 LED P5 40K T3M MVOLT	DSX2 LED P5 40K T3M MVOLT	1	36864	0.9	321
	STFT	1	Lithonia Lighting	DSX2 LED P5 40K TFTM MVOLT	DSX2 LED P5 40K TFTM MVOLT	1	37949	0.9	321
• 🗆	STFT- 290	2	Lithonia Lighting	DSX2 LED P7 40K TFTM MVOLT	DSX2 LED P7 40K TFTM MVOLT	1	45935	0.9	796
	STFT- 2180	1	Lithonia Lighting	DSX2 LED P5 40K TFTM MVOLT	DSX2 LED P5 40K TFTM MVOLT	1	37949	0.9	642
	WP2	4	Lithonia Lighting	DSXW1 LED 20C 1000 40K T3M MVOLT	DSXW1 LED WITH (2) 10 LED LIGHT ENGINES, TYPE T3M OPTIC, 4000K, @ 1000mA.	1	7572	0.9	73.2
	WP3	1	Lithonia Lighting	DSXW1 LED 20C 1000 40K TFTM MVOLT	DSXW1 LED WITH (2) 10 LED LIGHT ENGINES, TYPE TFTM OPTIC, 4000K, @ 1000mA.	1	7711	0.9	73.2
	S5W	1	Lithonia Lighting	DSX2 LED P5 40K T5W MVOLT	DSX2 LED P5 40K T5W MVOLT	1	39142	0.9	321
	EM	1	SIGNTEX, INC	MUE10X-T	EXTRUDED ALUMINUM HOUSING, FROSTED PLASTIC ENCLOSURE.	1	494	0.9	10.7
	D15R	12	Lithonia Lighting	LDN4SQ 40/15 LS4AR LSS	4IN LDN SQUARE, 4000K, 1500LM, CLEAR, SEMI-SPECULAR REFLECTOR, CRI80	1	1267	0.9	17.5

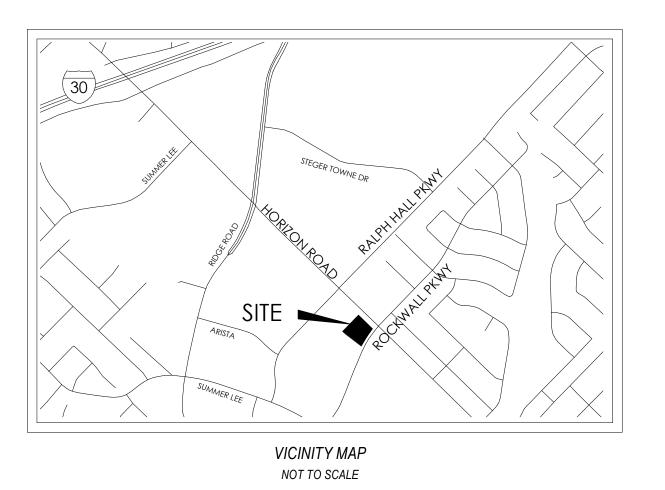

ALL CONTENTS WITHIN THIS SHEET ARE NOT FOR CONSTRUCTION. THIS SHEET AND THE CONTENT WHITHIN LIGHTING TEXAS FINANCE CODE SECTION 59.307 IN ORDER

TO ENSURE PATRON SAFETY AND SECURITY

CALCULATION NOTES:


1. ALL EXTERIOR CALCULATIONS ARE ASSUMED ON EVEN OR FLAT TERRAIN. ALL EXTERIOR CALCULATIONS ARE TAKEN AT 0'-0" AFG. ATM CALCULATIONS ARE TAKEN AT 3'-0"AFG.

VALUE NEXT TO LUMINAIRE LABEL ON DRAWING REPRESENTS OVERALL MOUNTING HEIGHT. TREES REFLECTANCE/TRANSMITTANCE VALUES ARE ASSUMED BASED OF

ROUGH ESTIMATIONS OF TREE TYPES. PHOTOMETRY ANALYSIS WAS DONE USING VISUAL LIGHTING 2020 R2

DATE: 12/16/2021

SITE PLAN - PHOTOMETRICS

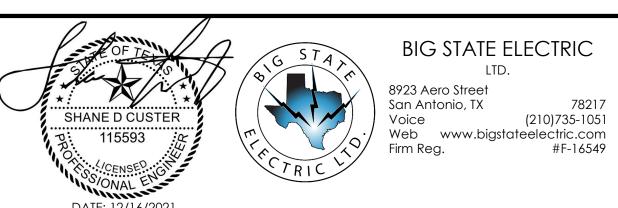











FROST BANK ROCKWALL FINANCIAL EPM 1
CENTER





FEATURES & SPECIFICATIONS

INTENDED USE — Typical applications include corridors, lobbies, conference rooms and private offices. **CONSTRUCTION** — Durable square metal reflectors retained by torsion springs.

Galvanized steel mounting/plaster frame; galvanized steel junction box with bottom-hinged access covers and spring latches.

Vertically adjustable mounting brackets with commercial bar hangers provide 3-3/4" total adjustment. Two combination 1/2"-3/4" and four 1/2" knockouts for straight-through conduit runs. Capacity: 8 (4 in, 4 out). No. 12 AWG conductors, rated for 90°C.

Accommodates 12"-24" joist spacing.

Passive cooling thermal management for 25°C standard; high ambient (40°C) option available. Light engine and drivers are accessible from above or below ceiling.

Max ceiling thickness 1-1/2".

OPTICS — LEDs are binned to a 3-step SDCM; 80 CRI minimum. 90 CRI optional.

LED light source concealed with diffusing optical lens.

General illumination lighting with 1.0 S/MH and 55° cutoff to source and source image.

Self-flanged anodized reflectors in specular, semi-specular, or matte diffuse finishes. Also available in white and black painted reflectors.

Self-flanged anodized reflectors in specular, semi-specular, or matte diffuse finishes.

ELECTRICAL — Multi-volt (120-277V, 50/60Hz) 0-10V dimming drivers mounted to junction box, 10% or 1% minimum dimming level available.

0-10V dimming fixture requires two (2) additional low-voltage wires to be pulled.

70% lumen maintenance at 60,000 hours.

LISTINGS — Certified to US and Canadian safety standards. Wet location standard (covered ceiling). IP55 rated. ENERGY STAR® certified product.

WARRANTY — 5-year limited warranty. Complete warranty terms located at:

www.acuitybrands.com/support/warranty/terms-and-conditions

Note: Actual performance may differ as a result of end-user environment and application.

All values are design or typical values, measured under laboratory conditions at 25 $^{\circ}$ C.

Specifications subject to change without notice.











ORDE	ORDERING INFORMATION Lead times will vary depending on options selected. Consult with your							Consult with your sale	s represei	ntative.		Exa	mple	: LDN4SQ 35/15	LS4AR L	.SS MVOLI EZ
LDN4	isq 40/30				LS4AR			LSS	LSS		MVOLT					
Series	5	Color temperature Lumens ¹			Aperture/Trim Color				Finish		Voltage	Voltage				
LDN4S	Q 4" square	27/ 30/ 35/ 40/ 50/	2700K 3000K 3500K 4000K 5000K	7	05 07 10 15	500 lumens 750 lumens 1000 lumens 1500 lumens	20 25 30 40	2000 lumens 2500 lumens 3000 lumens 4000 lumens	LS4 LSW4	Downlight Wallwash	AR WR ² BR ²	Clear White Black	LSS LD LS	Semi-specular Matte diffuse Specular	MVOLT 120 277 347 ³	Multi-volt 120V 277V 347V

EZ1	0	WL			
Drive		Options			
GZ10 GZ1 D10 D1 EZ10	0-10V driver dims to 10% 0-10V driver dims to 19% Minimum dimming 10% driver for use with JOT Minimum dimming 1% driver for use with JOT 0-10V eldoLED driver with smooth and flicker- free deep dimming performance down to 10% 0-10V eldoLED driver with smooth and flicker- free deep dimming performance down to 10% eldoLED DALI SOLDRIVE	ELRSD ⁶ ELRSD ⁶ E10WCPR ⁶	Single fuse White painted flange Black painted flange Emergency battery pack with integral test switch. 10W Constant Power, Not Certified in CA Title 20 MAEDBS Emergency battery pack with remote test switch. 10W Constant Power, Not Certified in CA Title 20 MAEDBS Emergency battery pack with self-diagnostics, 10W Constant Power, integral test switch. Not Certified in CA Title 20 MAEDBS Emergency battery pack with self-diagnostics, 10W Constant Power, remote test switch. Not Certified in CA Title 20 MAEDBS Emergency battery pack, 10W Constant Power with integral test switch. Certified in CA Title 20 MAEDB Emergency battery pack, 10W Constant Power with remote test switch. Certified in CA Title 20 MAEDB	NPS80EZ ⁷ NPS80EZER ⁷ NLTAIR2 ^{8,10} NLTAIRER2 ^{8,10} NLTAIREM2 ^{8,10} N80 ⁹ JOT ¹³ HAO ¹¹ CP ¹² RRL	nLight® dimming pack controls 0-10V eldoLED drivers (EZ10, EZ1). nLight® dimming pack controls 0-10V eldoLED drivers (EZ10, EZ1). ER controls fixtures on emergency circuit. nLight® Air enabled nLight® Air Dimming Pack Wireless Controls. Controls fixtures on emergency circuit, not available with battery pack options nLight® AIR Dimming Pack Wireless Controls. UL924 Emergency Operation, via power interrupt detection. Available with battery pack options. nLight™ Lumen Compensation Wireless room control with "Just One Touch" pairing High ambient option (40°C) Chicago Plenum RELOC®-ready luminaire connectors enable a simple and consistent factory installed option across all ABL luminaire brands. Refer
	dim to dark	NPP16D ⁷ NPP16DER ⁷	nLight® network power/relay pack with 0-10V dimming for non-eldoLED drivers (GZ10, GZ1). nLight® network power/relay pack with 0-10V dimming for non-eldoLED drivers (GZ10, GZ1). ER controls fixtures on emergency circuit.	USPOM 90CRI	to RRL for complete nomenclature. Available only in RRLA, RRLB, RRLAE, and RRLC12S. US point of manufacture High CRI (90+)

- Overall height varies based on lumen package; refer to dimensional chart on page 3. Not available with finishes.
- Not available with emergency options. Must specify voltage 120V or 277V.
- Available with clear (AR) reflector only.
- 12.5" of plenum depth or top access required for
- battery pack maintenance.
 Specify voltage. ER for use with generator supply EM power. Will require an emergency hot feed and normal hot feed.
- NLTAIR2, NLTAIRER2 and NLTAIREM2 not recommended for metal ceiling installations
- Fixture begins at 80% light level. Must be specified with NPS80EZ or NPS80EZ ER. Only available with EZ10 and EZ1 drivers.
- Not available with CP, NPS80EZ, NPS80EZER, NPP16D, NPP16DER or N80 options.
 Fixture height is 5-11/16" for all lumen packages
- Must specify voltage for 3000lm. Not available with emergency battery pack option.

 Must specify D10 or D1 driver. Not available with
- nLight options. Not available with CP. Not recom-mended for metal ceiling installation. Not for use with emergency backup power systems other than battery packs.

DOWNLIGHTING IDN4S0

Mullion Mount Outdoor Emergency Egress Lighting

Series MUE

REV #: MUE.11.20.17

PROJECT:

TYPE:


CATALOG#

OVERVIEW

Linear LED outdoor egress with both emergency lighting and night lighting function. The MUE series is designed to mount directly on mullion frames used in typical glass panel entrance structures, with vertical mounting surface as small as 2". High efficiency LEDs and full 90° cut-off provide uniform emergency and night lighting on the extended egress pathway. All models are outdoor rated, UL wet location, ADA compliant, and exceed requirements of UL Standard 924 and NFPA 101. Designed and manufactured in the USA, complies with ARRA (American Recovery and Reinvestment Act) and Buy American requirements.


SPECIAL FEATURES

- Very low profile extruded aluminum housing and mount bracket blend seamlessly with structural metal frames
- Remote power supply for 10W and 20W BB and AC model single fixtures, or Central Battery System power for RE model multiple fixtures.
- · Option for 20 watt models to operate for 2 hours in emergency mode
- Options for mount bracket height, from 2" to 5"
- Standard finishes include Brushed Aluminum, Satin White, Bronze or Black. Custom colors available on request
- · Custom satin finishes for extended outdoor use are available to match any surface
- · IP66 housing seals against heavy water spray and fine dust
- · Universal side or top mount
- · Wide lighting distribution designed for entrance walkways
- · 10W or 20W emergency power models
- · Optional normal-on switch allows timed control of night lighting
- Self-Test Diagnostics is standard for central battery models and optional for integral battery models.
- · Certified IP66 housing withstands multi direction water spray and fine dust ingress
- Wall mount version available (see Series MAE)
- Standard CRI 5000K, with optional color corrections filters for 2900K, 3200K and 3800K.
- · Code compliant emergency lighting layouts provided

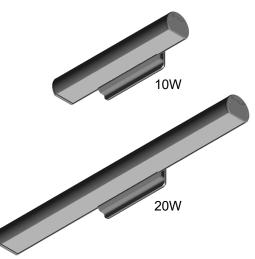



FIXTURE ORDERING INFORMATION EXAMPLE: MUEBB10AW-DG

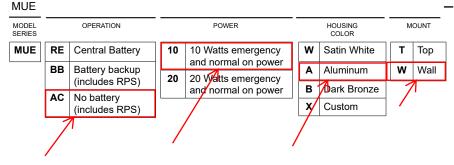

	or none
DG	Self-test diagnostics (BB models only)
SD	Night Lighting Control Switch for models with DG option (120/277VAC)
SB120	Night Lighting Control Switch for standard BB models (120VAC)
SB277	Night Lighting Control Switch for standard BB models (277VAC)
REC	20W RPS panel recessed mount
2EM	2 hrs emergency operation for BB models
CW1	Color temp 3800K
CW2	Color temp 3200K
CW3	Color temp 2900K
DAC	Dual AC input
2HT	2" Mount Bracket height
5HT	5" Mount Bracket height

Mullion Mount Outdoor Emergency Egress Lighting

Series MUE

REV #: MUE.11.20.17

CONSTRUCTION

- Extruded aluminum lamp housing 2" diameter, with gasketed mount bracket only 2 ½"Ht that includes a waterproof compression seal for universal wall or top mount.
- · Available models include:

RE: Multiple fixtures powered from a Central Battery System BB and AC: Single fixtures powered from a Remote Power Supply

AC: 120/277 VAC input, with or without battery

· Wet location listed, UL924 and certified IP66

- · Gasketed, molded end caps and Sealed acrylic lens
- · Stainless steel hardware

LIGHTING

- Lamps connected in parallel allow continuous lighting after failure of one lamp, meeting NEC and NFPA requirements.
- Standard output color 5000K. Optional outputs available 2900K, 3200K and 3800K.
- · Dual function available for emergency or normally -on operation.
- Standard Operating Temperature

RE: -40C to 50C (-40F to 120F)

BB: -20C to 40C (-4F to 104F)

AC: -20C to 40C (-4F to 104F)

ELECTRONICS


- Self-Test/Self-Diagnostic operation is standard for all RE models, and optional for BB models with the Remote Power Supply.
- · Line latch circuit prevents unwanted emergency activation at installation.
- · Low Voltage Disconnect prevents deep battery discharge


CODES

 Manufactured and tested to UL Standard 924, NFPA Life Safety Code 101, and certified to IP66.

WARRANTY

 10 year total customer satisfaction warranty. For details see Signtex product catalog technical data section.

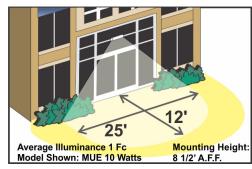

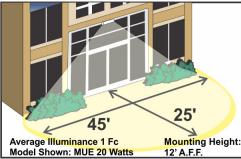

NOTE: FOR REFERENCE ONLY. STANDARD REFLECTANCES 80/50/20. SIGNTEX IS NOT RESPONSIBLE FOR SPECIFIC CONDITIONS THAT MAY ALTER THE RESULTS.



Self-test Diagnostic Functions (BB models)

STATUS	LED DISPLAY
Normal Full Charge	GREEN ON
Normal Fast Charge	ORANGE ON
Failed Battery	RED FLASH FAST
Failed Lamp	GREEN FLASH
Failed Transfer	ORANGE FLASH
Failed Charger	RED FLASH SLOW



Catalog Number

S3: DSX2 LED P5 40K T3M MVOLT S5W: DSX2 LED P5 40K T5W MVOLT STFT: DSX2 LED P5 40K TFTM MVOLT

STFT-2180: (2@180DEGREES)DSX2 LED P5 40K TFTM MVOLT STFT-290: (2@90DEGREES) DSX2 LED P5 40K TFTM MVOLT

S5W STFT STFT-2180 STFT-290

Туре



D-Series Size 2

LED Area Luminaire










Specifications

1.1 ft² (0.10 m²) EPA: 40" Length: (101.6 cm) 15" (38.1 cm) Width: 7-1/4" Height 1: (18.4 cm) Height 2: (max): 3.5" Weight: 36lbs

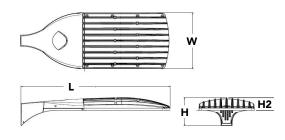

Introduction

The modern styling of the D-Series is striking yet unobtrusive - making a bold, progressive statement even as it blends seamlessly with its environment.

The D-Series distills the benefits of the latest in LED technology into a high performance, high efficacy, long-life luminaire. The outstanding photometric performance results in sites with excellent uniformity, greater pole spacing and lower power density. The Size 2 is ideal for replacing 400-1000W metal halide in area lighting applications with energy savings of up to 80% and expected service life of over 100,000 hours.

Order	ring Information	on	EXAMPLE: DSX2 LED	D P7 40K T3	BM MVOLT SPA	NLTAIR2 PIRHN DDBX
DSX2 LED	P5	40K	T5W	MVOLT	SPA	
Series	LEDs	Color temperature	Distribution	Voltage	Mounting	
DSX2LED	Forward optics P1 P5¹ P2 P6 P3 P7¹ P4 P8¹ Rotated optics P10² P13¹،² P11² P14¹,² P12²	30K 3000 K 40K 4000 K 50K 5000 K	T2M Type Medium T5W Type V Wide 3 T3S Type II Short BLC Backlight control 4 T3M Type II Medium LCCO Left corner cutoff 4 T4M Type V Medium RCCO Right corner cutoff 4 RCCO RI	MVOLT 5 XVOLT (277V-480V) 6.7.8 120 9 208 9 240 9 277 9 347 9 480 9	RPA Round p WBA Wall bra SPUMBA Square p RPUMBA Round p Shipped separately	oole mounting ole mounting cket 3 tole universal mounting adaptor 11 ole universal mounting adaptor 11 ole universal mounting adaptor 11 n mounting bracket adaptor (specify finish) 10
						DNAXD
Control opti	ions			Other options		Finish (required)
PIRHN PER PER5 PER7 DMG	Installed InLight AIR generation 2 enables Network, Bi-Level motion/ambie NEMA twist-lock receptacle onl Five-wire receptacle only (no co Seven-wire receptacle only (no 0-10V dimming extend out bac external control (no controls) Dual switching 18,19	ent sensor ¹⁴ y (no controls) ¹⁵ ontrols) ^{15,16} Fontrols) ^{15,16} F	PIRH Bi-level, motion/ambient sensor, 15-30′ mounting height, ambient sensor enable at 5fc ²⁰ PIRH1FC3V High/low, motion/ambient sensor, 15-30′ mounting height, ambient sensor enabled at 1fc ²⁰ FAO Field Adjustable Output ²³	SF Single fus DF Double fu L90 Left rotate R90 Right rota HA 50°C amt Shipped separ. BS Bird spike	de shield ²² se (120, 277, 347V) ⁹ use (208, 240, 480V) ⁹ ed optics ² sted optics ² sient operations ¹ ately	DDBXD Dark bronze DBLXD Black DNAXD Natural aluminum DWHXD White DDBTXD Textured dark bronze DBLBXD Textured black DNATXD Textured natural aluminum DWHGXD Textured white



Catalog Number

S3: DSX2 LED P5 40K T3M MVOLT S5W: DSX2 LED P5 40K T5W MVOLT STFT: DSX2 LED P5 40K TFTM MVOLT

STFT-2180: (2@180DEGREES)DSX2 LED P5 40K TFTM MVOLT STFT-290: (2@90DEGREES) DSX2 LED P5 40K TFTM MVOLT

S5W STFT STFT-2180 STFT-290

Туре

Ordering Information

Accessories

DLL127F 1.5 JU Photocell - SSL twist-lock (120-277V) 24 DLL347F 1.5 CUL JU Photocell - SSL twist-lock (347V) 24 DLL480F 1.5 CUL JU Photocell - SSL twist-lock (480V) 2 DSHORT SBK U Shorting cap 2 House-side shield for 80 LED unit 22 DSX2HS 80C U DSX2HS 90C U House-side shield for 90 LED unit 12 DSX2HS 100C U House-side shield for 100 LED unit 22

Square and round pole universal mounting bracket (specify finish) 25 PIIMRA DDRXD II* Mast arm mounting bracket adaptor (specify finish) 12 KMA8 DDBXD U

DSX2EGS (FINISH) U External glare shield

For more control options, visit DTL and ROAM online.

NOTES

- HA not available with P5 P7 P8 P13 and P14
- P10, P11, P12, P13 or P14 and rotated optics (L90, R90) only available together.
- Any Type 5 distribution with photocell, is not available with WBA.

- 3 Any Type 5 distribution with photocell, is not available with WBA.

 Not available with HS.

 MVOLT driver operates on any line voltage from 120-277V (50/60 Hz).

 XVOLT is only suitable for use with P5, P6, P7, P8, P13 and P14.

 XVOLT works with any voltage between 277V and 480V.

 XVOLT not available with fusing (SF or DP) and not available with PIRH or PIRH1FC3V.

 Single fuse (SF) requires 120V, 277V or 347V. Double fuse (DF) requires 208V, 240V or 480V.

 Suitable for mounting to round poles between 3.5" and 12" diameter.
- 11 Universal mounting bracket intended for retrofit on existing pre-drilled poles only. 1.5 G vibration load rating per ANCI C136.31. Only usable when pole's drill pattern is NOT Lithonia template #8.

 12 Must order fixture with SPA option. Must be ordered as a separate accessory; see Accessories information. For use with 2-3/8" diameter mast arm (not included).
- 13 Must be ordered with PIRHN. Sensor cover only available in dark bronze, black, white or natural aluminum color.
 14 Must be ordered with NLTAIR2. For more information on nLight Air 2 visit this link.
- 15 Photocell ordered and shipped as a separate line item from Acuity Brands Controls. See accessories. Not available with DS option. Shorting Cap included. 16 If ROAM® node required, it must be ordered and shipped as a separate line item from Acuity Brands Controls. Node with integral dimming. . 17 DMG not available with PIRHN, PERS, PER7, PIR, PIRH, PIR1FC3V or PIRH1FC3V, FAO.


- 18 Requires (2) separately switched circuits with isolated neutrals.
 19 Provides 50/50 fixture operation via (2) independent drivers. Not available with PER, PER5, PER7, PIR or PIRH. Not available with P1, P2, P10.
- 20 Reference Controls Options table settings table on page 4. Reference Motion Sensor Default table on page 4 to see functionality. 21 Reference controls options table on page 4. 22 Not available with BLC, LCCO and RCCO distribution. Also available as a separate accessories; see Accessories information.

- 23 Must be ordered with fixture for factory pre-drilling.
 24 Requires luminaire to be specified with PER, PER5 and PER7 option. Ordered and shipped as a separate line item from Acuity Brands Controls.
 25 For retrofit use only. Only usable when pole's drill pattern is NOT Lithonia template #8.

Options

EGS - External Glare Shield




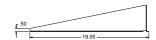




Drilling

HANDHOLE ORIENTATION

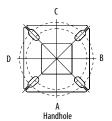

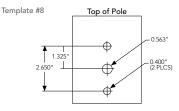

Tenon Mounting Slipfitter

Tenon O.D.	Mounting	Single Unit	2 @ 180	2 @ 90	3 @ 90	3 @120	4 @ 90
2-3/8"	RPA	AS3-5 190	AS3-5 280	AS3-5 290	AS3-5 390	AS3-5 320	AS3-5 490
2-7/8"	RPA	AST25-190	AST25-280	AST25-290	AST25-390	AST25-320	AST25-490
4"	RPA	AST35-190	AST35-280	AST35-290	AST35-390	AST35-320	AST35-490

		-		L.	<u>-7-</u>	**	-1-
Mounting Option	Drilling Template	Single	2 @ 180	2 @ 90	3 @ 90	3 @ 120	4@90
Head Location		Side B	Side B & D	Side B & C	Side B, C & D	Round Pole Only	Side A, B, C & D
Drill Nomenclature	#8	DM19AS	DM28AS	DM29AS	DM39AS	DM32AS	DM49AS

DSX2 Area Luminaire - EPA

*Includes luminaire and integral mounting arm. Other tenons, arms, brackets or other accessories are not included in this EPA data

Fixture Quantity & Mounting Configuration	Single DM19	2 @ 180 DM28	2 @ 90 DM29	3 @ 90 DM39	3 @ 120 DM32	4 @ 90 DM49
Mounting Type	-=		₹.	_T_	*	
DSX2 LED	1.100	2.200	2.120	3.300	2.850	4.064

	Drilling Template		Minimum Acceptable Outside Pole Dimension								
SPA	#8	2-7/8"	2-7/8"	3.5"	3.5"	3"	3.5"				
RPA	#8	2-7/8"	2-7/8"	3.5"	3.5"	3"	3.5"				
SPUMBA	#5	2-7/8"	3"	4"	4"	3.5"	4"				
RPUMBA	#5	2-7/8"	3.5"	5"	5"	3.5"	5"				




Catalog Number

SL2L LOP 2FT FLP FL 80CRI 35K 600LMF MIN1 120 RALTBD ZT WL

RAL = FL/RAL8002SG



MARK ARCHITECTURAL

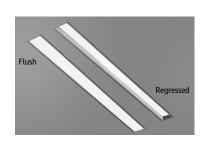

Slot 2 LED

Recessed Linear

Slot 2 LED takes both form and function a step further with increased efficacy and integral controls creating a digitally addressable luminaire that is perfect where visually harmonious illumination and energy efficiency are desired.

Slot 2 LED is the ideal choice for spaces that emphasize lines and clean contemporary design. It is a perfect fit for Armstrong TechZone™ ceiling systems. A regressed lens option provides added dimension to the sleek, slender design and the flush lens now has a Wet Label option.

Specification Features (continued on page 2)

Housing

Nominal 2" x 2', 3', 4', 5', 6', 7', 8' and continuous rows in 1" increments as standard, upper housing fabricated from cold-rolled steel with extruded aluminum ceiling trim.

Finish

Painted high reflectance matte white powder coat.

Reflector

Precision-formed steel; high reflectance matte white powder coat; 93% reflectivity.

Shieldina

Flush Lens: Snap-in 90% transmissive satin acrylic

Regressed Lens: Lay-in 90% transmissive satin acrylic lens.

Mounting

Recessed. Available for sheetrock, 9/16" slot grid or 15/16" inverted tee ceilings, or 9/16" inverted tee.

CSA tested to UL 1598 standards. Optional Damp or Wet location listings available, see ordering tree. This product is IC rated.


Warranty 5-year limited warranty. Complete warranty terms located at:

www.acuitybrands.com/support/warranty/termsand-conditions

Note: Actual performance may differ as a result of end-user environment and application. All values are design or typical values, measured under laboratory conditions at 25 °C.

Specifications subject to change without notice.

Technical Drawing

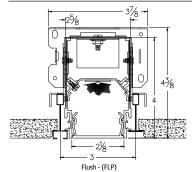











Fixture Performance - SL2L*

Lumens Output	400 LMF		600 LMF**		800L	MF**	1000LMF	
Fixture Style	RLP	FLP	RLP	FLP	RLP	FLP	RLP	FLP
Delivered Lumens/FT	234	308	404	533	534	705	654	862
Input Watts/FT	4	4	6	6	8	8	11	11
Lumen/Watt	68	89	69	91	67	88	62	82

LED Components


Linear: Nichia® - 757 Series LED chips (available in 80 or 90 CRI)

Rated 65,000 hours (L80) at 25 °C ambient temperature.

Color Consistency

The Acuity Brands circuit boards for the linear LED components use a precise binning algorithm which creates a consistent color temperature from board to board. Color variation is no greater than a 2.5 Step MacAdam (2.5SDCM) along the black body locus from board to board.

eldoLED constant current driver options delivers ultra-smooth dimming resolution from 100% to 0.1%, while assuring flicker free, low current inrush, 89% efficiency and low EMI.

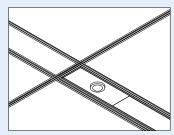

Occupancy Sensor (PDT) and/or Photocell (ADC)

Integrated Controls

Optional nLight® embedded controls make luminaire addressable- allowing it to digitally communicate with other nLight enabled controls such as dimmers, switches, occupancy sensors and photocontrols. Simply connect all the nLight enabled control devices using standard CAT5 Cabling. (Input option: NLIGHT)

Photometry

For photometric information refer to www.marklighting.com

^{*}CCT (35K) *Consult factory for customized lumen output and wattage **Based on calculated values

Confirm Finish



D-Series Size 1 LED Wall Luminaire





d"series

Specifications


Luminaire

Width:	13-3/4" (34.9 cm)	Weight:	12 lbs (5.4 kg
Depth:	10" (25.4 cm)		
Height:	6-3/8" (16.2 cm)		



Back Box (BBW, ELCW)

Width:	13-3/4" (34.9 cm)	BBW Weight:	5 lbs (2.3 kg)
Depth:	4" (10.2 cm)	ELCW Weight:	10 lbs (4.5 kg)
Height:	6-3/8" (16.2 cm)		

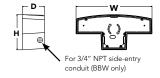

Introduction

The D-Series Wall luminaire is a stylish, fully integrated LED solution for building-mount applications. It features a sleek, modern design and is carefully engineered to provide long-lasting, energy-efficient lighting with a variety of optical and control options for customized performance.

With an expected service life of over 20 years of nighttime use and up to 74% in energy savings over comparable 250W metal halide luminaires, the D-Series Wall is a reliable, low-maintenance lighting solution that produces sites that are exceptionally illuminated.

Ordering Information

EXAMPLE: DSXW1 LED 20C 1000 40K T3M MVOLT DDBTXD

DSXW1	LED	20C	1000	40K	ТЗМ	MVOL		
Series		LEDs	Drive Current	Color temperature	Distribution	Voltage	Mounting	Control Options
DSXW1	LED	10C 10LEDs (one engine) 20C 20LEDs (two engines)	350 350 mA 530 530 mA 700 700 mA 1000 1000 mA (1 A) ¹	30K 3000 K 40K 4000 K 50K 5000 K AMBPC Amber phosphor converted	T2S Type II Short T2M Type II Medium T3S Type III Short T3M Type III Medium T4M Type IV Medium TFTM Forward Throw Medium	MVOLT ² 120 ³ 208 ³ 240 ³ 277 ³ 347 ^{3,4} 480 ^{3,4}	Shipped included (blank) Surface mounting bracket BBW Surface- mounted back box (for conduit entry) 5	Shipped installed PE Photoelectric cell, button type 6 DMG 0-10v dimming wires pulled outside fixture (for use with an external control, ordered separately) PIR 180° motion/ambient light sensor, <15′ mtg ht 12′ PIRH 180° motion/ambient sensor, 8-15′ mounting height, ambient sensor enabled at 1fc 12′ PIRHFC3V Motion/ambient sensor, 15-30′ mounting height, ambient sensor enabled at 1fc 12′ PIRHFC3V Emergency battery backup (includes external component enclosure), CA Title 20 Noncompliant 83

			'	DNA	(D	'			
Other Options			Finish (required)						
Shipp SF DF HS SPD	ed installed Single fuse (120, 277 or 347V) 3.10 Double fuse (208, 240 or 480V) 3.10 House-side shield 11 Separate surge protection 12	Shipp BSW VG DDL	ed separately ¹¹ Bird-deterrent spikes Vandal guard Diffused drop lens	DDBXD DBLXD DNAXD DWHXD	Dark bronze Black Natural aluminum White	DSSXD DDBTXD DBLBXD DNATXD	Sandstone Textured dark bronze Textured black Textured natural aluminum	DWHGXD DSSTXD	Textured white Textured sandstone

Accessories

Ordered and shipped separately.

DSXWHS U House-side shield (one per light engine) DSXWRSW II Bird-deterrent spikes DSXW1VG U Vandal guard accessory

- 1 20C 1000 is not available with PIR, PIRH, PIR1FC3V or PIRH1FC3V.
- MVOLT driver operates on any line voltage from 120-277V (50/60 Hz).
- Single fuse (SF) requires 120, 277 or 347 voltage option. Double fuse (DF) requires 208, 240 or 480 voltage option.
- Only available with 20C, 700mA or 1000mA. Not available with PIR or PIRH.
- Back box ships installed on fixture. Cannot be field installed. Cannot be ordered as an accessory.
- Photocontrol (PE) requires 120, 208, 240, 277 or 347 voltage option. Not available with motion/ambient light sensors (PIR or PIRH).
- Reference Motion Sensor table on page 3.
- Cold weather (-20C) rated. Not compatible with conduit entry applications. Not available with BBW mounting option. Not available with fusing. Not available with 347 or 480 voltage options. Emergency components located in back box housing. Emergency mode IES files located on product page at www.lithonia.com
- Not available with SPD.
- 10 Not available with ELCW.
- 11 Also available as a separate accessory; see Accessories information.
- 12 Not available with ELCW.





TEXAS FINANCE CODE

TITLE 3. FINANCIAL INSTITUTIONS AND BUSINESSES

SUBTITLE A. BANKS

CHAPTER 59. MISCELLANEOUS PROVISIONS

Subchapter D. Safety at Unmanned Teller Machines³

Sec. 59.301. Definitions. In this subchapter:

- (1) "Access area" means a paved walkway or sidewalk that is within 50 feet of an unmanned teller machine. The term does not include a public right-of-way or any structure, sidewalk, facility, or appurtenance incidental to the right-of-way.
- (2) "Access device" has the meaning assigned by Regulation E (12 C.F.R. Section 205.2), as amended, adopted under the Electronic Fund Transfer Act (15 U.S.C. Section 1693 et seq.), as amended.
- (3) "Candlefoot power" means the light intensity of candles on a horizontal plane at 36 inches above ground level and five feet in front of the area to be measured.
- (4) "Control" means the authority to determine how, when, and by whom an access area or defined parking area may be used, maintained, lighted, and landscaped.
- (5) "Customer" means an individual to whom an access device is issued for personal, family, or household use.
- (6) "Defined parking area" means the portion of a parking area open for unmanned teller machine customer parking that is contiguous to an access area, is regularly, principally, and lawfully used during the period beginning 30 minutes after sunset and ending 30 minutes before sunrise for parking by customers using the machine, and is owned or leased by the owner or operator of the machine or owned or controlled by a person leasing the machine site to the owner or operator of the machine. The term does not include:
 - (A) a parking area that is physically closed or on which one or more conspicuous signs indicate that the area is closed; or
 - (B) a level of a multiple-level parking area other than the level considered by the operator of the unmanned teller machine to be the most directly accessible to a customer.
- (7) "Financial institution" has the meaning assigned by Section 201.101.

- (8) "Operator" means the person primarily responsible for the operation of an unmanned teller machine.
- (9) "Owner" means a person having the right to determine which financial institutions are permitted to use or participate in the use of an unmanned teller machine.
- (10) "Unmanned teller machine" means a machine, other than a telephone, capable of being operated solely by a customer to communicate to a financial institution:
 - (A) a request to withdraw money from the customer's account directly or under a line of credit previously authorized by the financial institution for the customer;
 - (B) an instruction to deposit money in the customer's account with the financial institution;
 - (C) an instruction to transfer money between one or more accounts maintained by the customer with the financial institution;
 - (D) an instruction to apply money against an indebtedness of the customer to the financial institution; or
 - (E) a request for information concerning the balance of the account of the customer with the financial institution.

Sec. 59.302. Exception for Certain Unmanned Teller Machines. This subchapter does not apply to an unmanned teller machine:

(1) by which:

- (A) a customer of a financial institution can authorize and effect the electronic transfer of money from the customer's account at the financial institution to a merchant's account at a financial institution in the county or municipality in which the terminal is located to obtain cash or to purchase, rent, or pay for goods or services; and
- (B) the merchant can ascertain that the transaction has been completed and the money has been or will be transferred to the merchant's account at the merchant's financial institution in the county or municipality in which the terminal is located; or

(2) located:

- (A) inside a building:
 - (i) unless the building is a freestanding installation existing solely to provide an enclosure for the machine; or
 - (ii) except to the extent a transaction can be conducted from outside the building; or
- (B) in an area not controlled by the owner or operator of the machine.

Sec. 59.303. Applicability to Certain Persons Who Are Not Owners or Operators. (a) A person is not an owner or operator solely because the person's primary function is to provide for the exchange, transfer, or dissemination of electronic fund transfer data.

- (b) A person whose primary function is to provide for the exchange, transfer, or dissemination of electronic fund transfer data and who is not an owner or operator is not liable to a customer or user of an unmanned teller machine for a claim arising out of or in connection with a use or attempted use of the machine.
- **Sec. 59.304. Construction of Subchapter.** (a) This subchapter does not require the relocation or modification of an unmanned teller machine on the occurrence of a particular event or circumstance.
- (b) A violation of this subchapter or a rule adopted under this subchapter is not negligence per se. Substantial compliance with this subchapter and each rule adopted under this subchapter is prima facie evidence that a person has provided adequate safety protection measures relating to an unmanned teller machine under this subchapter.
- **Sec. 59.305. Lighting Required.** During the period beginning 30 minutes after sunset and ending 30 minutes before sunrise, lighting shall be provided for:
 - (1) an unmanned teller machine;
 - (2) the machine's access area and defined parking area; and
 - (3) the exterior of the machine's enclosure, if the machine is located in an enclosure.
- **Sec. 59.306. Persons Required to Provide Lighting.** (a) Except as provided by Subsection (b), the owner or operator shall provide the lighting required by this subchapter.
- (b) A person who leases the site where an unmanned teller machine is located shall provide the lighting required by this subchapter if the person controls the access area or defined parking area for the machine and the owner or operator does not control the access area or defined parking area.

Sec. 59.307. Standards for Lighting. The lighting must be at least:

- (1) 10 candlefoot power at the face of the unmanned teller machine and extending in an unobstructed direction outward five feet:
- (2) two candlefoot power within 50 feet from any unobstructed direction from the face of the machine, except as provided by Subdivision (3):
- (3) if the machine is located within 10 feet of the corner of a building and is generally accessible from the adjacent side, two candlefoot power along the first 40 unobstructed feet of the adjacent side of the building; and
- (4) two candlefoot power in the part of the defined parking area within 60 feet of the unmanned teller machine.

Sec. 59.308. Safety Evaluation. (a) An owner or operator shall in good faith evaluate the safety of each unmanned teller machine that the person owns or operates.

- (b) In making the evaluation, the owner or operator shall consider:
 - (1) the extent to which the lighting for the machine complies with Section 59.307;
 - (2) the presence of obstructions, including landscaping and vegetation, in the area of the machine and the access area and defined parking area for the machine; and

- (3) the incidence of violent crimes in the immediate neighborhood of the machine as shown by local law enforcement records and of which the owner or operator has actual knowledge.
- **Sec. 59.309. Notice of Safety Precautions.** (a) An issuer of an access device shall give the customer a notice of basic safety precautions that the customer should follow while using an unmanned teller machine.
- (b) The issuer shall personally deliver or mail the notice to each customer whose mailing address is in this state according to records for the account to which the access device relates. If the issuer furnishes an access device to more than one customer on the same account, the issuer is required to furnish a notice to only one of the customers.
- (c) The issuer may furnish information under this section with other disclosures related to the access device, including an initial or periodic disclosure statement furnished under the Electronic Fund Transfer Act (15 U.S.C. Section 1693 et seq.).
- **Sec. 59.310. Enforcement and Rules.** (a) The finance commission and the Credit Union Commission shall enforce this subchapter and adopt rules to implement this subchapter. 4
- (b) The rules must establish security requirements to be implemented by a financial institution for the operation of an unmanned teller machine. The rules may require the financial institution to install and maintain security devices in addition to those required by this subchapter to be operated in conjunction with the machine for the protection of customers using the machine, including:
 - (1) video surveillance equipment that is maintained in working order and operated continuously during the hours of operation of the machine; and
 - (2) adequate lighting around the premises that contain the machine.
- (c) A financial institution that violates a rule adopted under this section is subject to a civil penalty of not less than \$50 or more than \$1,000 for each day of violation and each act of violation.