



## City of Rockwall

Planning & Zoning Department 385 S. Goliad Street Rockwall, Texas 75032 (P): (972) 771-7745 (W): www.rockwall.com The City of Rockwall GIS maps are continually under development and therefore subject to change without notice. While we endeavor to provide timely and accurate information, we make no guarantees. The City of Rockwall makes no warranty, express or implied, including warranties of merchantability and fitness for a particular purpose. Use of the information is the sole responsibility of the user.



## Miller, Ryan

To: Subject: Gonzales, David RE: Request for Exception to Exterior Material Requirement - 306 Harborview Dr

From: Marc Camacho Sent: Friday, November 18, 2016 3:22 PM To: Gonzales, David Cc: Jarita Green Subject: Request for Exception to Exterior Material Requirement - 306 Harborview Dr

Mr. Gonzales,

This letter represents a formal request for exception to exterior material requirement for a new residential construction at 306 Harborview Dr, Rockwall 75032.

The proposed building finishes are as follows:

- 74% Fiber Cement Cladding (white and dark gray, integrally colored)
- 12% Stone Masonry
- 9% Concrete Panels (white, integrally colored)
- 5% Clear Red Cedar

I have attached the drawings as well as some exterior renderings for you perusal.

The Chandlers Landing HOA has already approved our proposed exterior finishes. However, we do not have an official letter from them just yet; at the end of our meeting with the HOA committee they communicated a conditional approval subject to receipt of city permit.

We were granted our building permit by the city yesterday.

Please let me know if you need anything else.

Respectfully, Marc Camacho



FOR ILLUSTRATION ONLY NO SCALE

## **GENERAL NOTES:**

ALL WORK SHALL BE DONE IN COMPLIANCE WITH THE 2015 INTERNATIONAL RESIDENTIAL & BUILDINGS CODES, AS APPLICABLE, AND SHALL BE IN ACCORDANCE WITH ANY ADDITIONAL REQUIREMENTS OF THE STATE OF TEXAS, CITY OF ROCKWALL, AND CHANDLERS LANDING ASSOCIATION. THE CONTRACTOR SHALL ASSUME FULL RESPONSIBILITY FOR ANY WORK PERFORMED CONTRARY TO SUCH LAWS, ORDINANCES, OR REGULATIONS. THE CONTRACTOR SHALL ALSO PERFORM COORDINATION WITH ALL UTILITIES AND STATE SERVICE AUTHORITIES.

THE CONTRACTOR SHALL VERIFY THAT SITE AND BUILDING CONDITIONS ARE CONSISTENT WITH THESE PLANS BEFORE STARTING WORK. WORK NOT SPECIFICALLY DETAILED SHALL BE CONSTRUCTED TO THE SAME QUALITY AS SIMILAR WORK THAT IS DETAILED. WORK PERFORMED SHALL ALSO MEET THE WORKMANSHIP AND METHODOLOGY GUIDELINES AS RECOMMENDED BY THE RESPECTIVE GOVERNING BODY.

WRITTEN DIMENSIONS AND SPECIFIC NOTES SHALL TAKE PRECEDENCE OVER SCALED DIMENSIONS AND GENERAL NOTES. CONTRACTORS SHALL VERIFY AND ARE RESPONSIBLE FOR ALL DIMENSIONS (INCLUDING ROUGH OPENINGS) AND CONDITIONS ON THE JOB. CAMACHO ENGINEERING SHALL BE CONSULTED FOR CLARIFICATION IF SITE CONDITIONS ARE ENCOUNTERED THAT ARE DIFFERENT THAN SHOWN, IF DISCREPANCIES ARE FOUND IN THE PLANS OR NOTES, OR IF QUESTIONS ARISES OVER THE INTENT OF THE PLANS OR NOTES. CONTRACTOR SHALL VERIFY AND IS RESPONSIBLE FOR ALL DIMENSIONS (INCLUDING ROUGH OPENINGS).

PLUMBING, HVAC AND ELECTRICAL CONTRACTORS ARE RESPONSIBLE FOR THE PROPER FUNCTION THE RESPECTIVE SYSTEMS. THE CONTRACTOR SHALL NOTIFY THE DESIGNER WITH ANY PLAN CHANGES OR BUILDING/FRAMING MODIFICATIONS REQUIRED FOR PROPER INSTALLATION AND FUNCTION OF PLUMBING, HVAC, AND ELECTRICAL SYSTEMS.

CAMACHO ENGINEERING WILL NOT BE RESPONSIBLE FOR CONSTRUCTION METHODS, ACTS, OR OMISSIONS OF THE CONTRACTOR OR SUBCONTRACTOR, OR FAILURE OF ANY OF THEM TO CARRY OUT WORK IN ACCORDANCE WITH THE CONSTRUCTION DOCUMENTS. ANY INCONSISTENCY OR IRREGULARITY DISCOVERED IN THE CONSTRUCTION DOCUMENTS SHALL BE BROUGHT TO THE ATTENTION OF CAMACHO ENGINEERING BY WRITTEN NOTICE BEFORE PROCEEDING WITH WORK. CONTRACTOR SHALL CONFIRM RECEIPT OF WRITTEN NOTICE AND SHALL ALLOW REASONABLE TIME FOR ISSUE TO BE ADDRESSED PRIOR TO COMMENCING WORK AND ENACTING MODIFICATIONS. THE BURDEN OF COST AND LIABILITY FROM DEFECTIVE OR SUBSTANDARD WORK, OR WORK THAT DOES NOT SATISFY THE PLANS AND SPECS WILL REST UPON THE CONTRACTOR.

FOUNDATION, PATIOS, TERRACES, AND GARAGE AREAS ARE NOT INCLUDED IN LIVING AREA. ALL PENETRATIONS OF THE BUILDING ENVELOPE SHALL BE SEALED WITH CAULK OR FOAM.

ROOF SURFACES SHALL NOT TO THROUGH-FASTENED, CUT, OR PENETRATED FOR ANY REASON, OR USED FOR EQUIPMENT SUPPORT/INSTALLATION; UNLESS INDICATED OTHERWISE IN THE CONSTRUCTION DOCUMENTS, OR UNLESS PROVIDED WITH WRITTEN CONSENT AND OVERSIGHT FROM CAMACHO ENGINEERING. ALL PLUMBING AND FLUE VENTS SHALL BE ROUTED THROUGH A SIDEWALL AND EXTENDED ABOVE THE EAVE ELEVATION AS REQUIRED. SEE ROOF NOTES FOR ADDITIONAL INFORMATION AND DETAILS.

PLEASE SEE ADDITIONAL NOTES CALLED OUT ON OTHER SHEETS.

## **RENDERINGS:**

RENDERINGS ARE NOT TO SCALE; ALL RENDERINGS ARE FOR ARTISTIC DEPICTION ONLY. PLAN UPDATES MAY NOT BE REFLECTED IN RENDERINGS. RENDERINGS SHALL NOT BE USED FOR CONSTRUCTION.

## **BUILDING CODES & PERFORMANCE NOTES:**

MUNICIPALITY:	CITY OF ROC
<u>CODE INFO:</u>	2015 INTERN 2015 INTERN 2015 INTERN 2015 INTERN 2015 INTERN 2015 INTERN 2015 INTERN
STRUCTURAL ENGINEER:	MARC A. CAN
ARCHITECTURAL DESIGNER:	MARC CAMAG MCAMACHO@

## BUILDER:

THIS STRUCTURE SHALL BE ADEQUATELY BRACED FOR WIND LOADS UNTIL THE ROOF, FLOOR AND WALLS HAVE BEEN PERMANENTLY FRAMED TOGETHER, INTEGRALLY SHORED, AND SHEATHED.

INSTALL WATERPROOF GYPSUM BOARD AT ALL WATER SPLASH AREAS TO MINIMUM 70" ABOVE SHOWER DRAINS.

INSULATE WASTE LINES FOR SOUND CONTROL.


CONFIRMING CODE CONFORMANCE.

OTHERWISE PROVIDED WITH SUPPORT.

CONTRACTORS TO REVIEW AND VERIFY ALL DIMENSIONS, SPECS, DETAILS, AND CONNECTIONS BEFORE CONSTRUCTION BEGINS.

## **DISCLAIMER:**

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# **CAMACHO ENGINEERING**
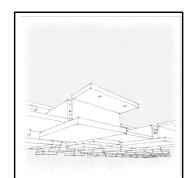
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MCAMACHO@CAMACHOENGINEERING.COM-832.671.5724-ROWLETT, TX

# **PROJECT NOTES**

CKWALL - 385 S. GOLIAD STREET, ROCKWALL, TEXAS 75087

NATIONAL RESIDENTIAL CODE W/ LOCAL AMENDMENTS NATIONAL BUILDING CODE W/ LOCAL AMENDMENTS NATIONAL PLUMBING CODE W/ LOCAL AMENDMENTS NATIONAL FUEL GAS CODE W/ LOCAL AMENDMENTS NATIONAL MECHANICAL CODE W/ LOCAL AMENDMENTS NATIONAL ENERGY CONSERVATION CODE W/ LOCAL AMENDMENTS NAL ELECTRIC CODE W/ LOCAL AMENDMENTS

MACHO, TEXAS PE# 114209

ACHO - CAMACHO ENGINEERING @CAMACHOENGINEERING.COM

CAMACHO ENGINEERING, TX FIRM# F16426

INSTALL POLYISOCYANURATE FOAM TYPE INSULATION AT FLOOR AND PLATE LINES, OPENINGS IN PLATES, CORNER STUD CAVITIES AND AROUND DOOR AND WINDOW ROUGH OPENING CAVITIES.

EXHAUST ALL VENTS AND FANS (VIA SIDEWALL ACCESS) DIRECTLY TO OUTSIDE VIA METAL DUCTS. PROVIDE 90 CFM (MIN) FANS TO PROVIDE 5 AIR CHANGES PER HOUR IN BATHS CONTAINING TUB AND / OR SHOWER AND IN LAUNDRY ROOMS.

ALL RECESSED LIGHTS IN INSULATED CEILINGS TO HAVE THE I.C. LABEL, OR ALTERNATIVE DOCUMENTATION/ IDENTIFICATION

PROJECT:

PROVIDE SOLID BLOCKING UNDER ALL BEARING WALLS PERPENDICULAR TO JOISTS AND OTHER BEARING POINTS NOT

## **PROJECT DETAILS:**

HOME OWNER:	JARITA & MARC CAMACHO
PROJECT ADDRESS:	306 HARBORVIEW DR. ROCKWALL, TX 75032
LEGAL:	LOT 14, BLOCK C
MAX ROOF HEIGHT:	479'
FIRE DISTRICT:	ROCKWALL FIRE DEPARTMENT
WATER DISTRICT:	NORTH TEXAS MUNICIPAL
STORM WATER#:	
BLDG PERMIT#:	


## **PROJECT STATISTICS:**

LOT SIZE:		12,151 SQ. FT.
BUILDING AREAS	<u>.</u>	
	FLOOR 1 (CONDITIONED SPACE) :	3,286 SQ. FT.
	FLOOR 2 (CONDITIONED SPACE): FLOOR 2 (NON-CONDITIONED):	1,713 SQ. FT. 61 SQ. FT.
	VEHICLE GARAGE: UTILITY GARAGE:	676 SQ. FT. 110 SQ. FT.
	LIVABLE AREA:	4,999 SQ. FT.
FLATWORK AREA	<u>.S:</u>	
	RESIDENCE FOUNDATION:	3,465 SQ. FT.
	GARAGE FOUNDATION:	706 SQ. FT.
	DRIVEWAY SLAB:	1,514 SQ. FT.
	CONCRETE PADS:	84 SQ. FT.
ROOF AREA:		5,018 SQ. FT.
PROPOSED MAX	ROOF HEIGHT:	478.9 FT.

REFER TO ARCHITECTURAL, STRUCTURAL, PLUMBING, MECHANICAL, AND ELECTRICAL NOTES FOR ADDITIONAL CRITERIA.

DRAWING TITLE:


306 HARBORVIEW DR., ROCKWALL, TEXAS 75032 — CHANDLERS LANDING —

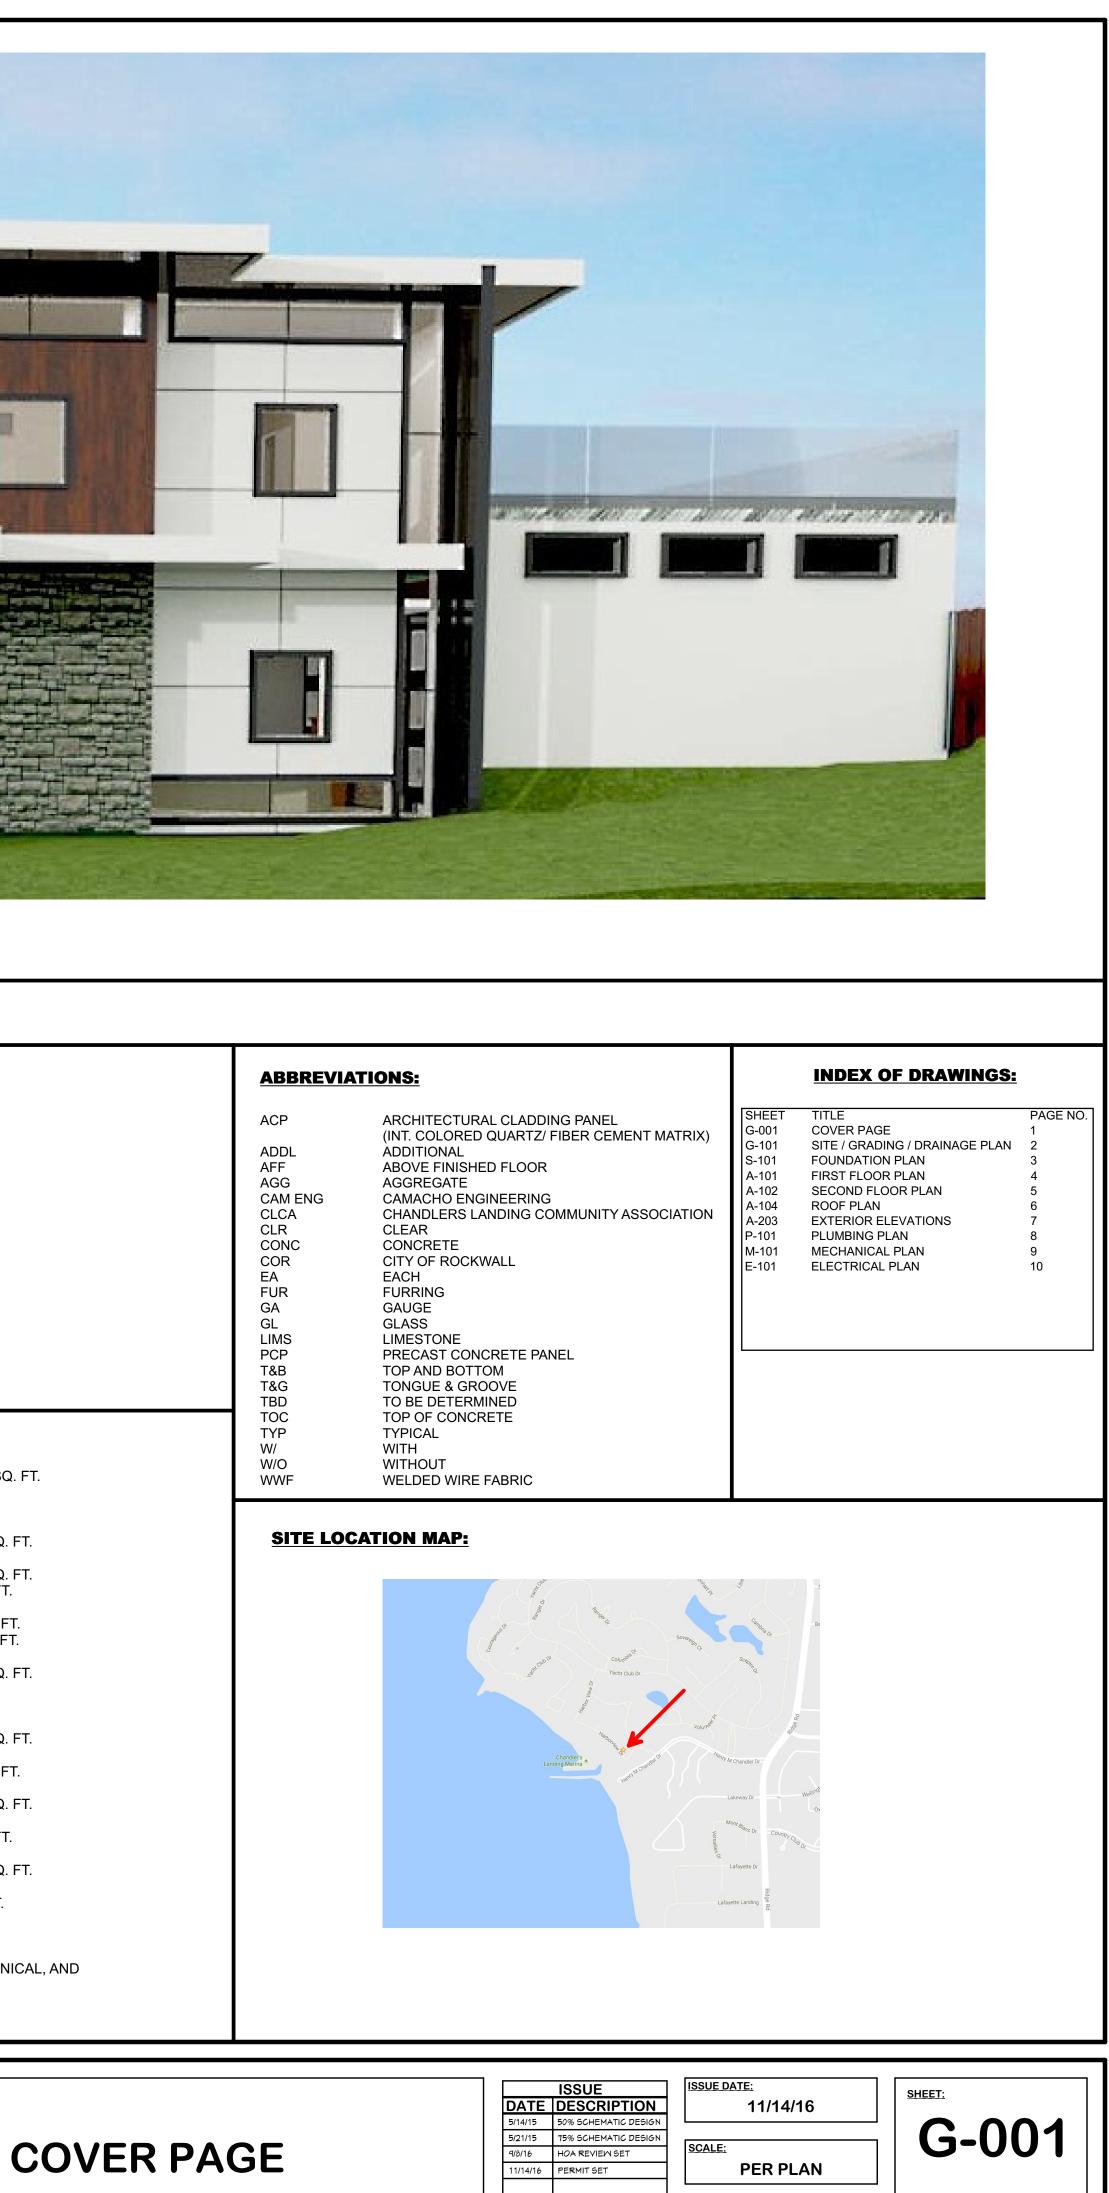

COVER PAGE

DESIGNED BY:

M.A.C.

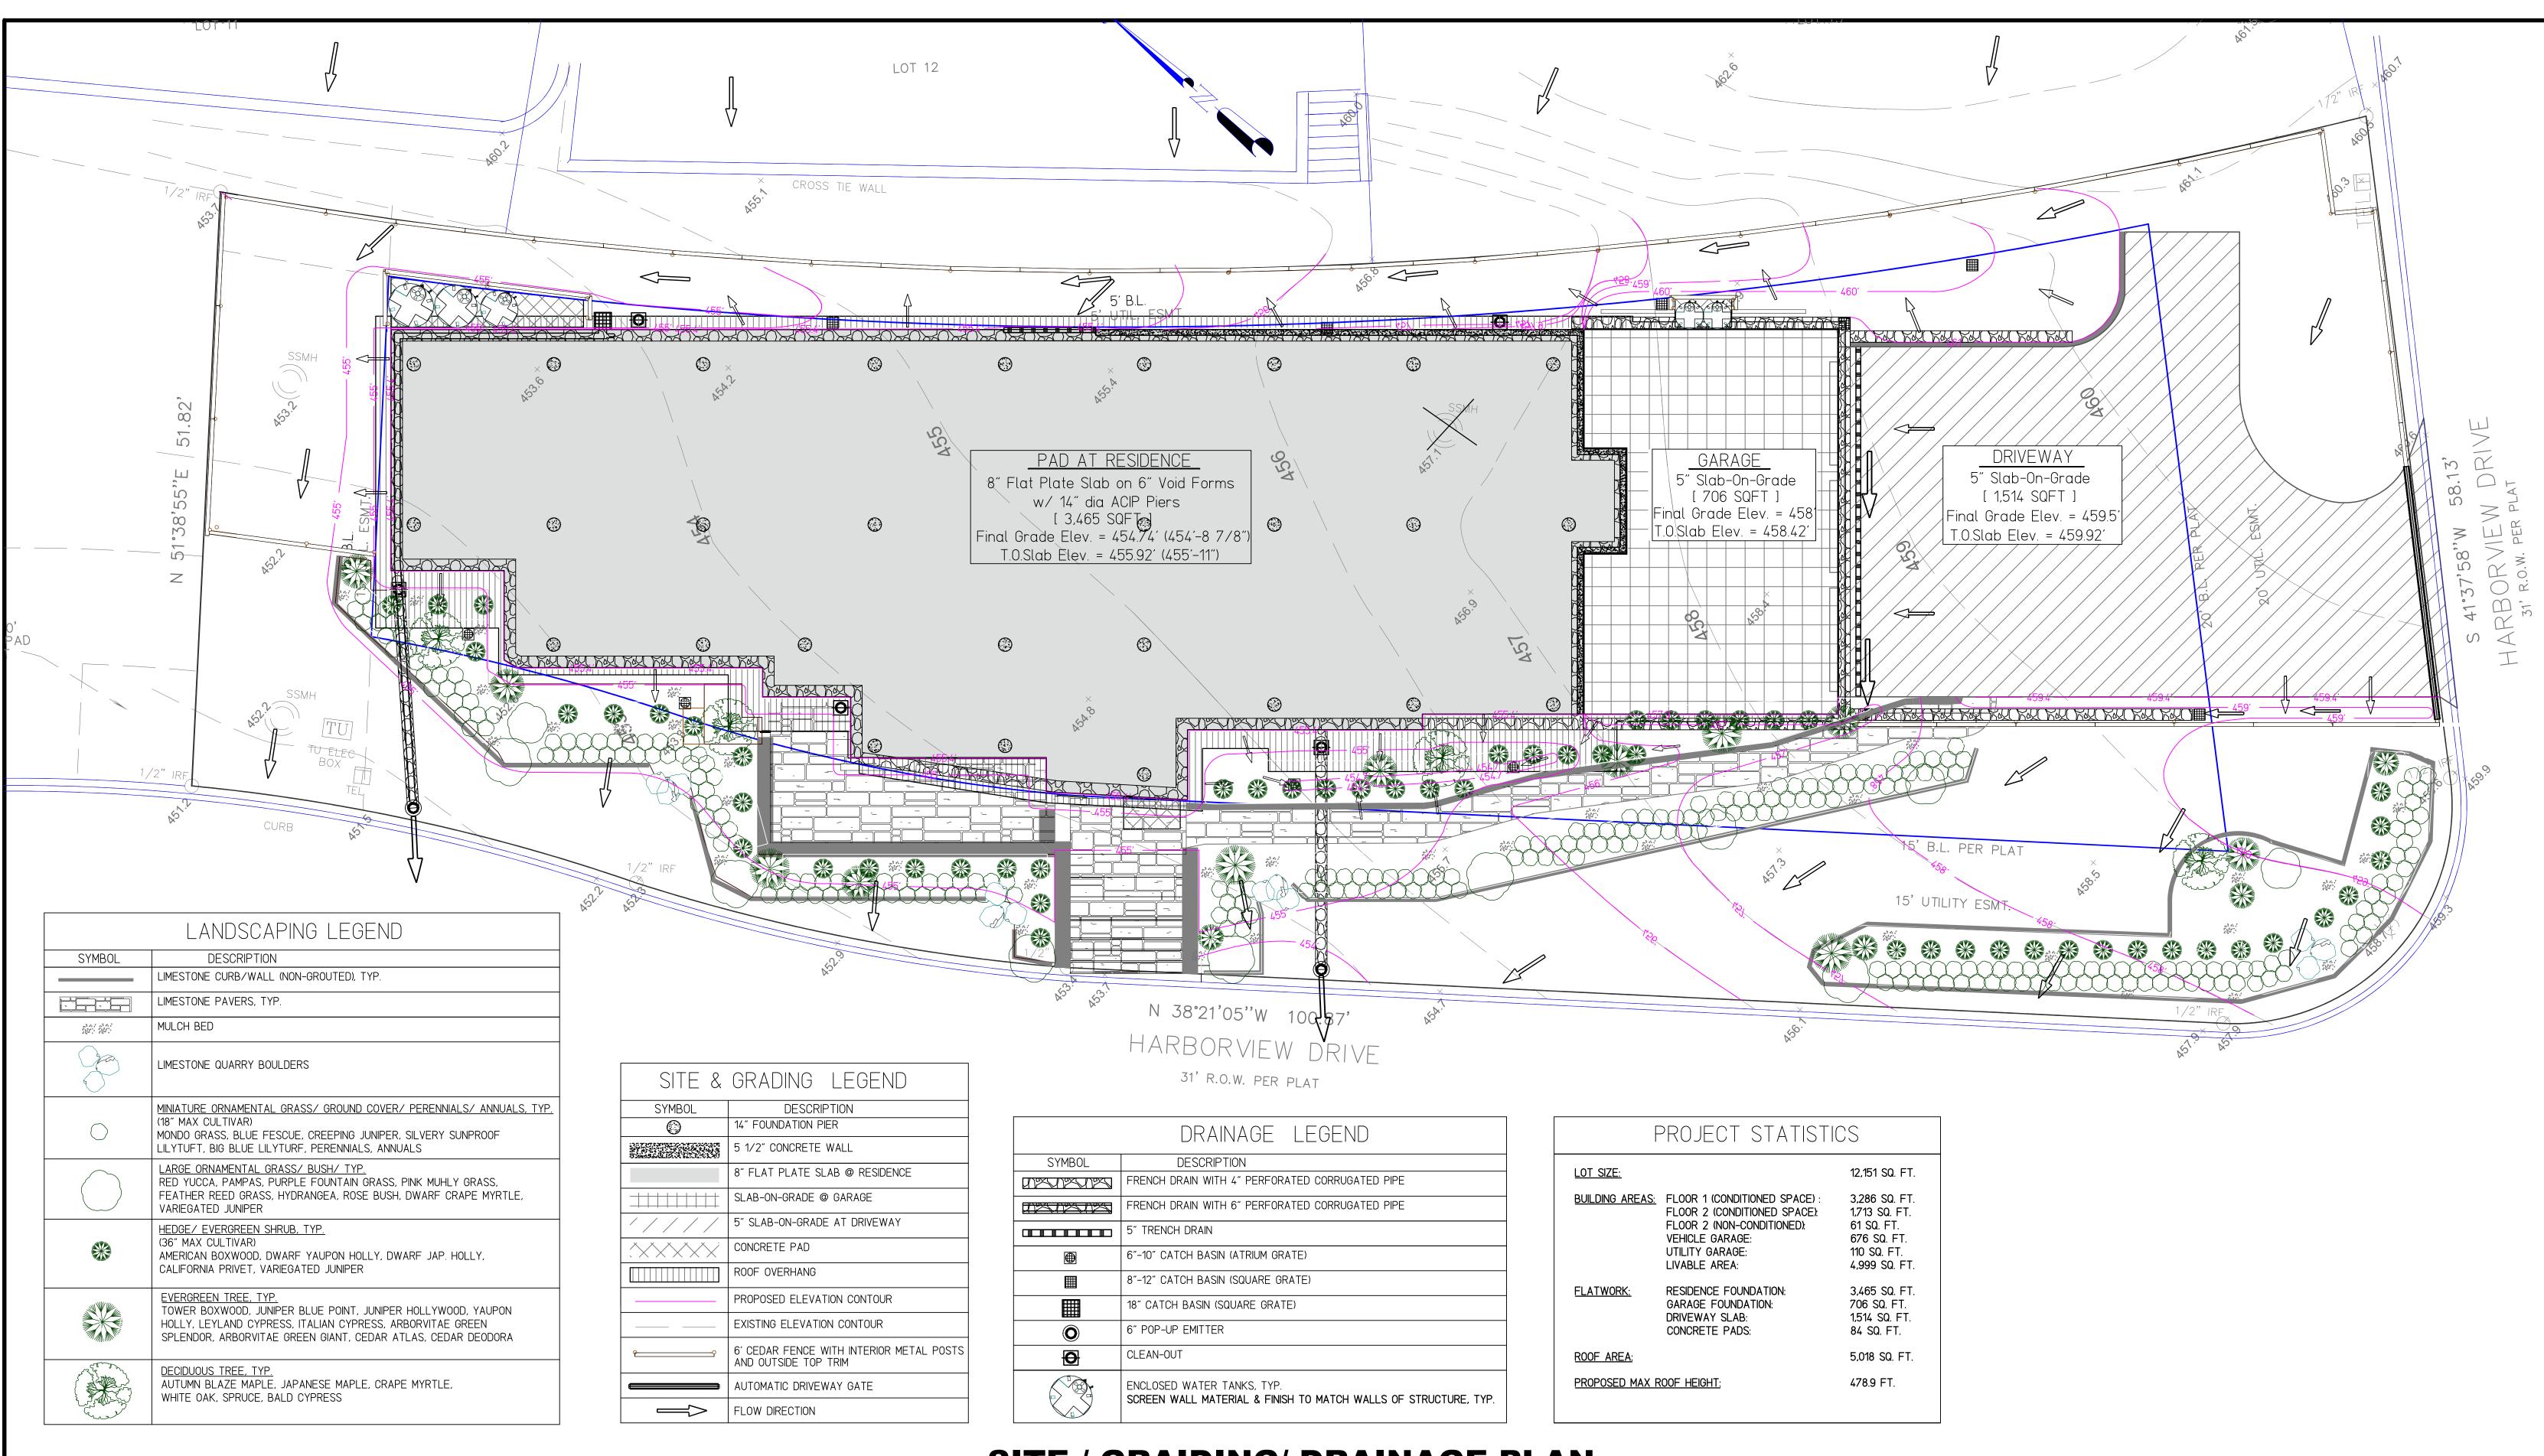


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# SITE / GRAIDING/ DRAINAGE PLAN

SCALE: 5/32" = 1'



**306 HARBORVIEW** 

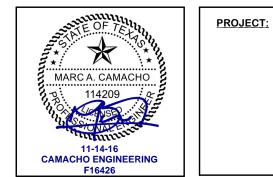
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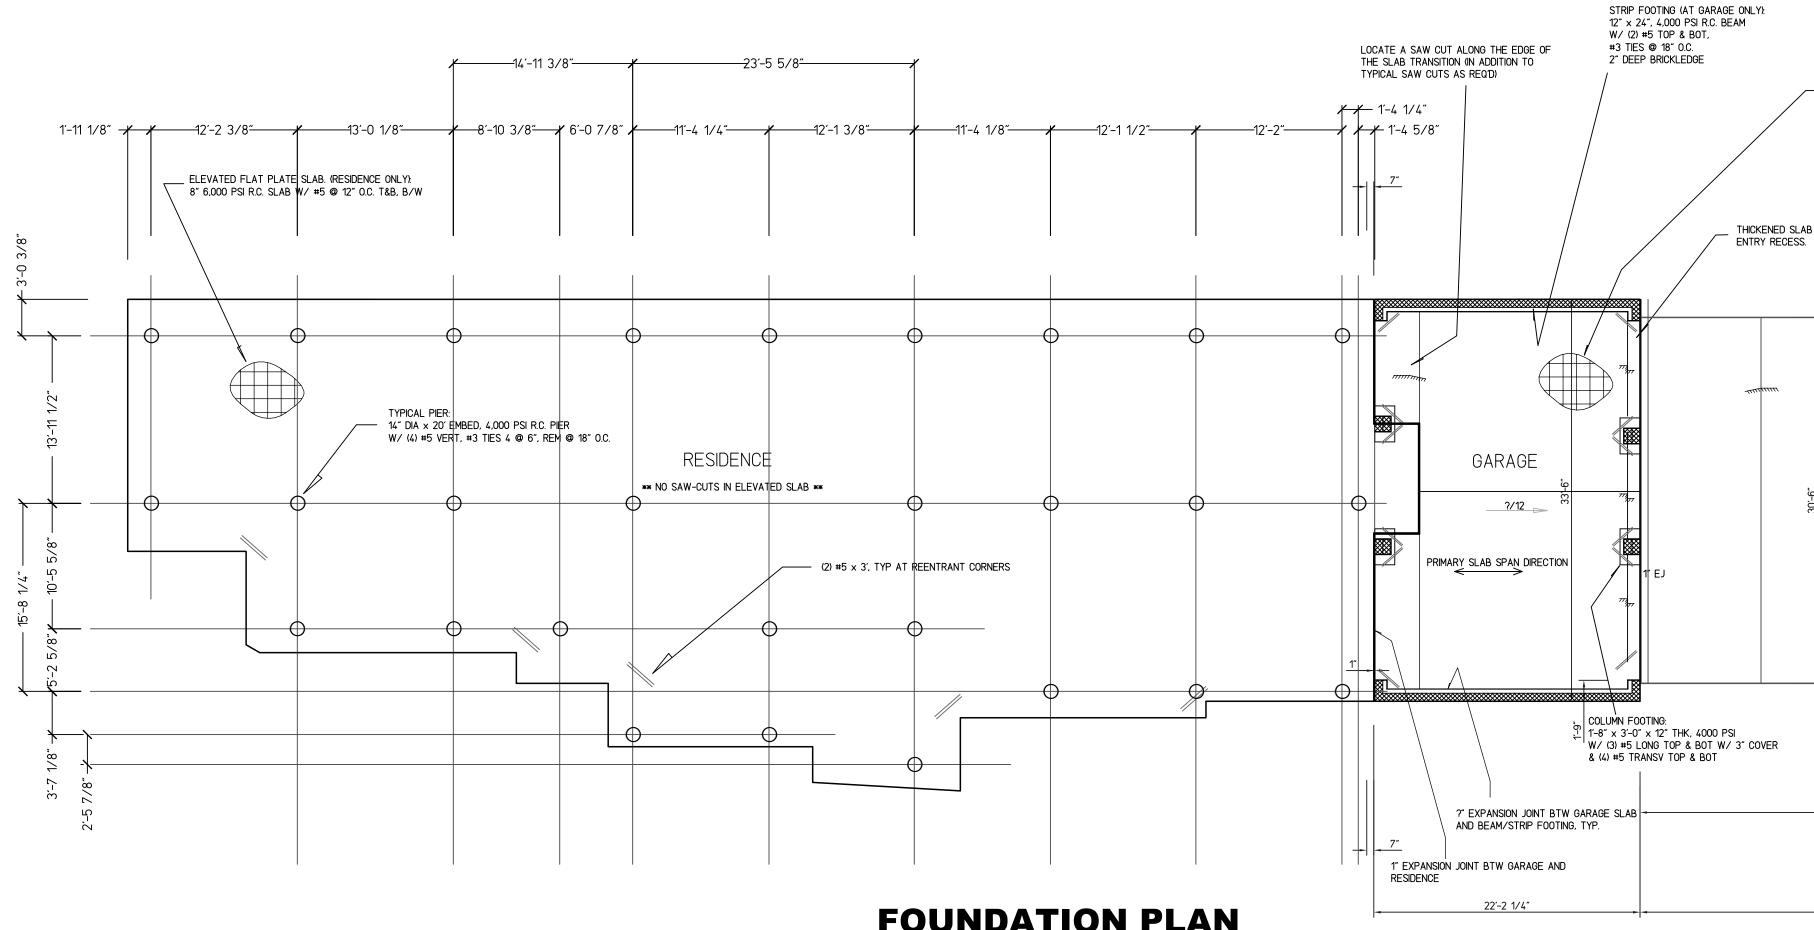
306 HARBORVIEW DR., ROCKWALL, TEXAS 75032 — CHANDLERS LANDING —


ISSUE DATE DESCRIPTION **ISSUE DATE:** SHEET: 11/14/16 5/14/15 50% SCHEMATIC DESIGN G-101 75% SCHEMATIC DESIG **SITE / GRADING / DRAINAGE PLAN** SCALE: HOA REVIEW SET 9/8/16 PERMIT SET PER PLAN SITE / GRADING / DRAINAGE PLAN DESIGNED BY: M.A.C.

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# **CAMACHO ENGINEERING**





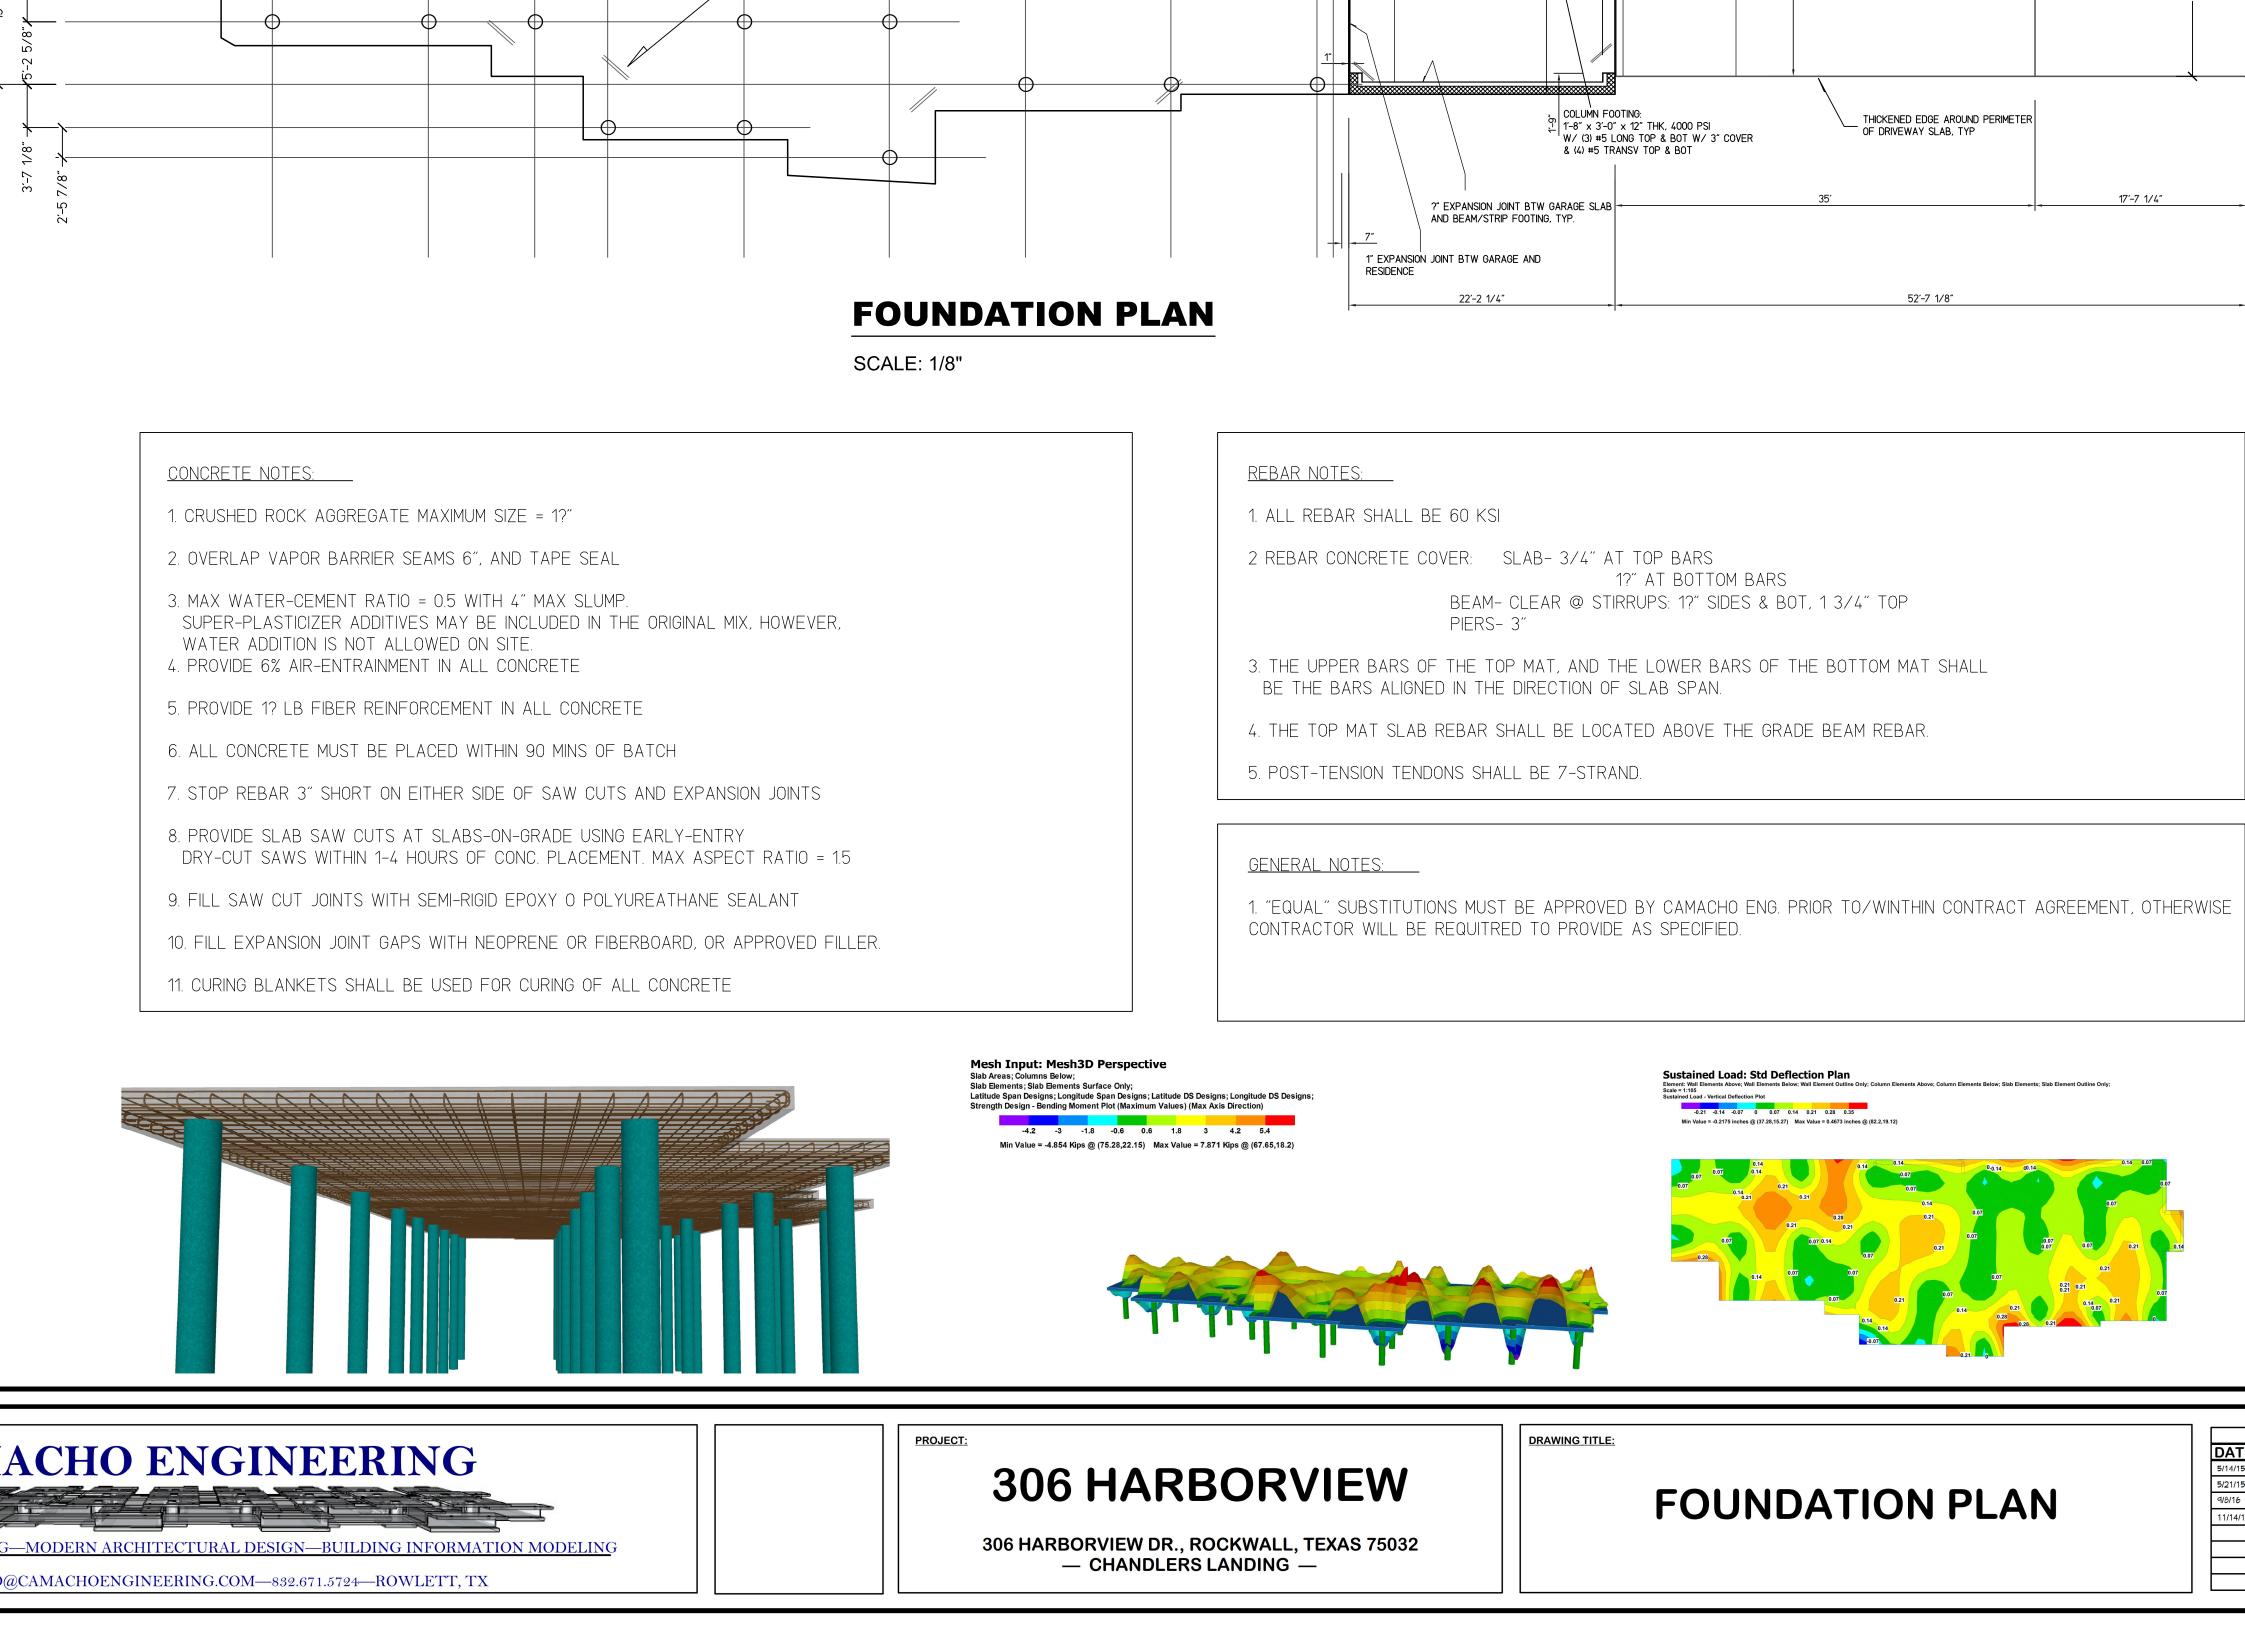

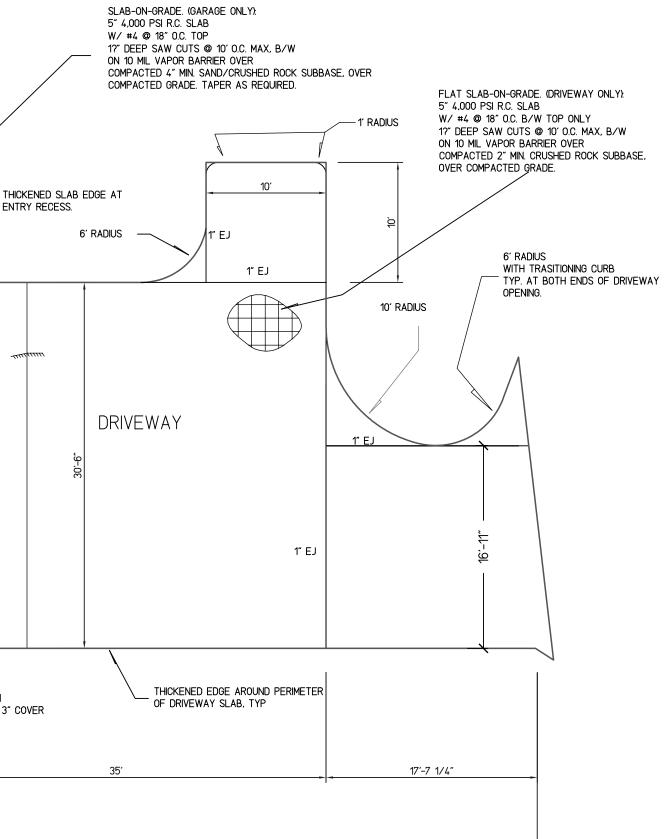ISSUE DATE DESCRIPTION 5/14/15 50% SCHEMATIC DESIGN 5/21/15 75% SCHEMATIC DESIGN 9/8/16 HOA REVIEW SET 11/14/16 PERMIT SET


11/14/16 SCALE: PER PLAN **DESIGNED BY:** 

**ISSUE DATE:** 

SHEET: S-101 FOUNDATION PLAN

PAGE: 4 OF 18


M.A.C.

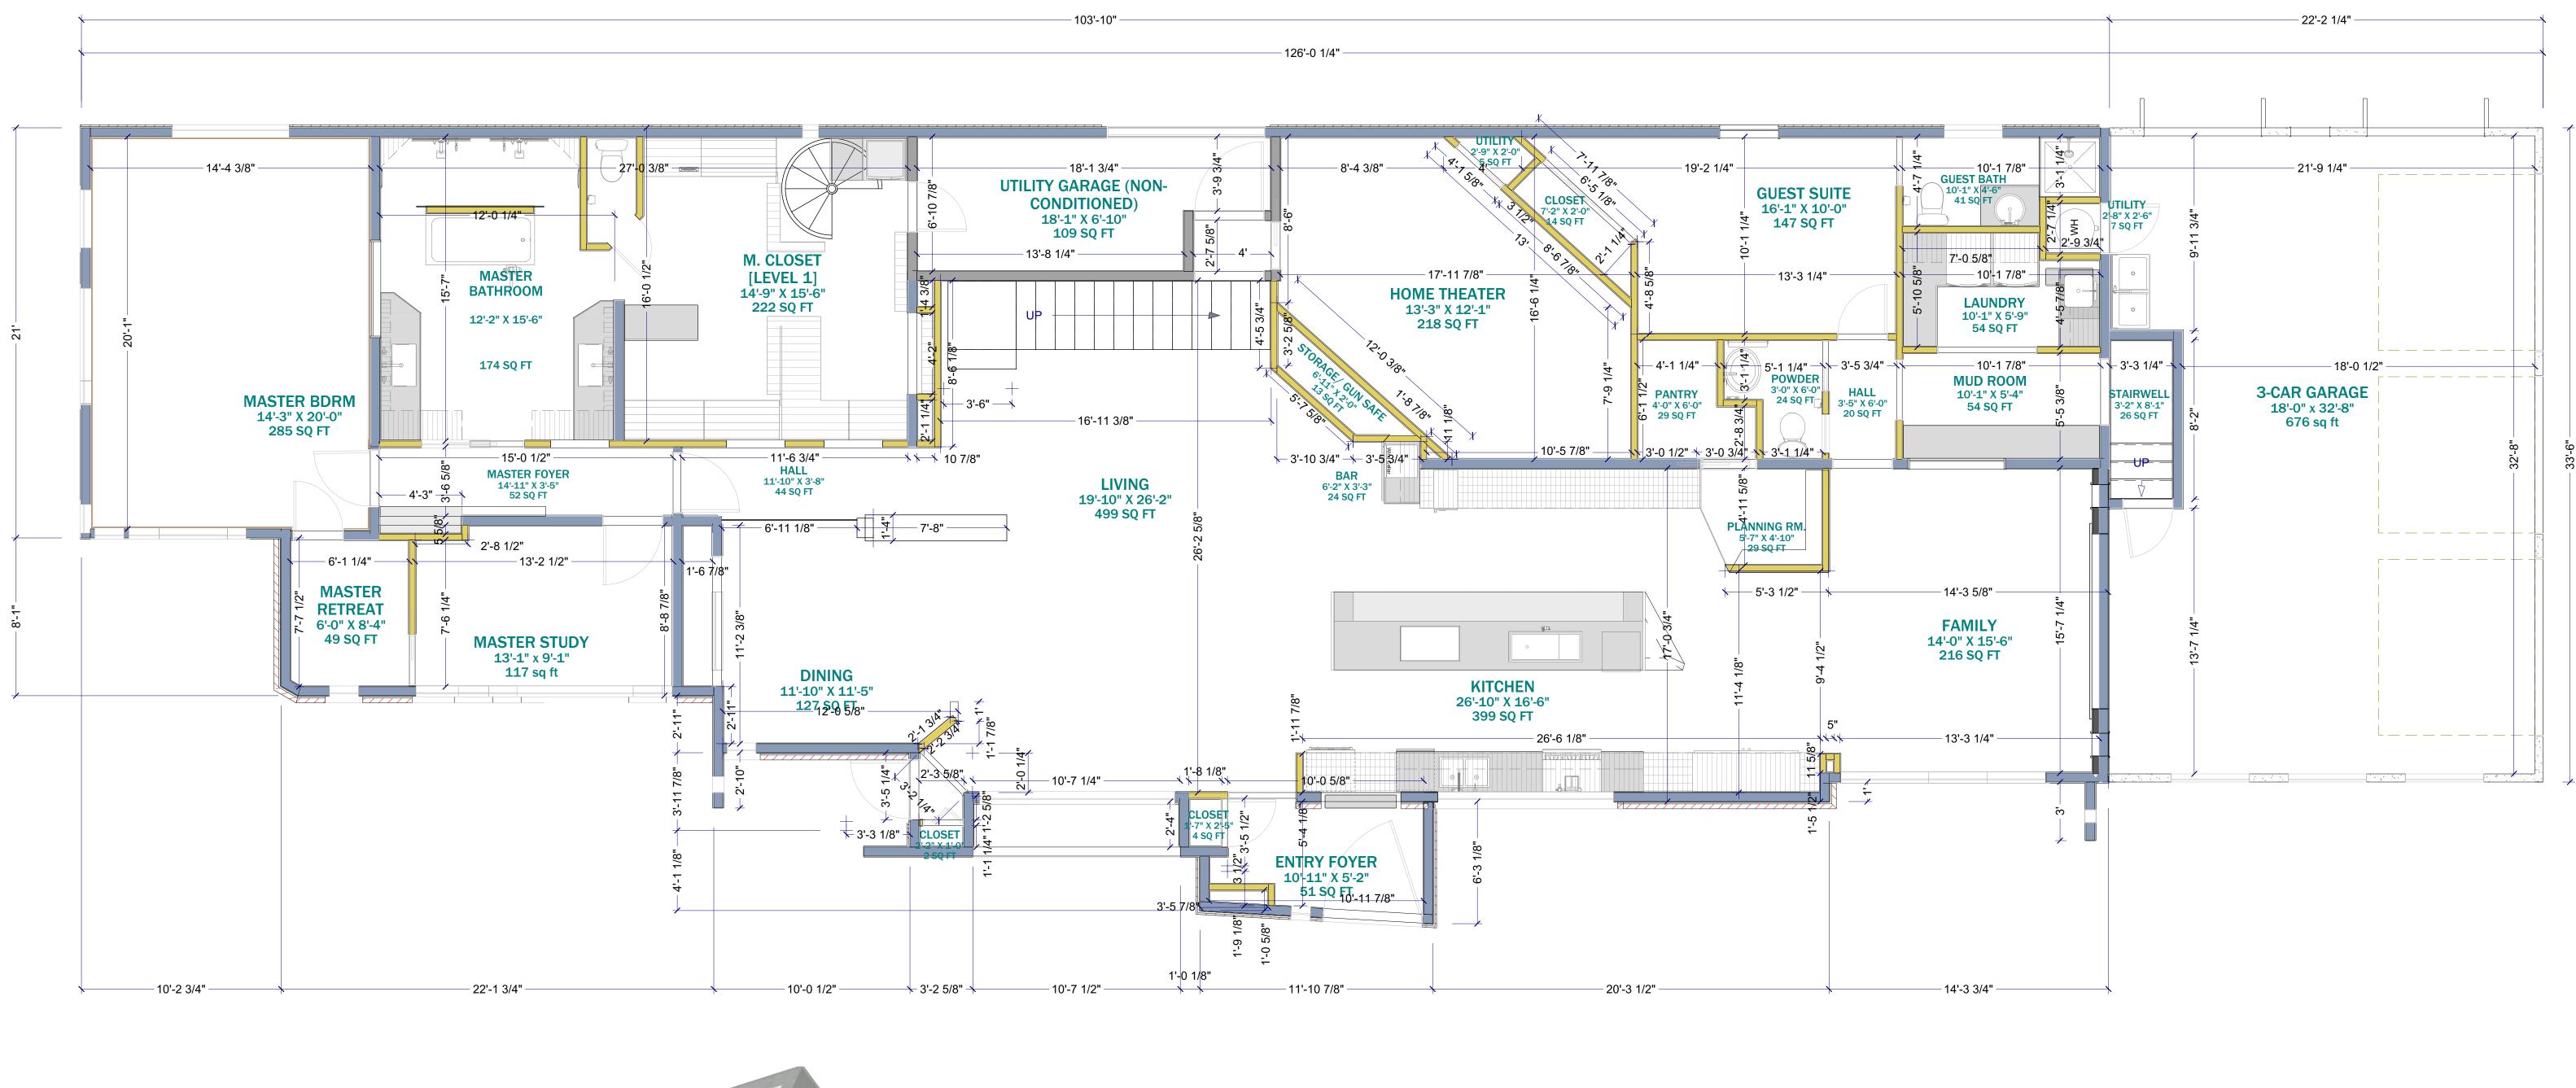



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# **FIRST FLOOR PLAN**

**SCALE: 1/4** 

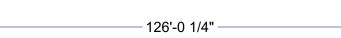LIVING AREA 3287 SQ FT

ALL EXPOSED INSULATION IS TO HAVE A FLAME SPREAD RATING OF LESS THEN 25 AND A SMOKE DENSITY RATING OF LESS THAN 450.

SPECIFIC MANUFACTURES AND MODEL NUMBERS SHOWN ON THE PLANS ARE INDICATIONS OF QUALITY ONLY. THE OWNER/BUILDER SHALL NOT BE PROHIBITED FROM SUBSTITUTING MATERIALS AND/OR APPLIANCES OF EQUAL QUALITY/STRENGTHS FROM NON-SPECIFIED MANUFACTURERS.



## **FLOORS AND ROOFS**

PROVIDE INSULATION BAFFLES AT EAVE VENTS BETWEEN RAFTERS.

THE OWNER/BUILDER SHALL NOT BE SUBSTITUTING MATERIALS PROVIDED THEY MEET CURRENT BLDG. CODE, AND ARE APPROVED FOR THAT SPECIFIC USE BY THE BUILDING OFFICIAL

## **MISCELLANEOUS NOTES:**

EACH BEDROOM TO HAVE A MINIMUM WINDOW OPENING OF 5.7 SQ. FT. WITH A MINIMUM WIDTH OF 20 IN. AND A SILL LESS THAN 44" ABOVE FIN. FLR.

ALL TUB AND SHOWER ENCLOSURES ARE TO BE GLAZED WITH SAFETY GLASS.

ALL EXTERIOR WINDOWS ARE TO BE DOUBLE GLAZED AND ALL EXTERIOR DOORS ARE TO BE SOLID CORE WITH WEATHERSTRIPPING. PROVIDE 1/2 IN. DEADBOLT LOCKS ON ALL EXTERIOR DOORS, AND LOCKING DEVICES ON ALL DOORS AND WINDOWS WITHIN 10 FT. (VERTICAL) OF GRADE. PROVIDE PEEPHOLE 54-66 IN. ABOVE FIN. FLOOR ON EXTERIOR ENTRY DOORS.

PROVIDE ONE SMOKE DETECTOR IN EACH ROOM AND ONE IN EACH CORRIDOR ACCESSING BEDROOMS. CONNECT SMOKE DETECTORS TO HOUSE POWER AND INTER-CONNECT SMOKE DETECTORS TO HOUSE POWER AND INTERCONNECT SO THAT, WHEN ANY ONE IS TRIPPED, THEY ALL WILL SOUND. PROVIDE BATTERY BACKUP FOR ALL UNITS.

BATHROOMS AND UTILITY ROOMS ARE TO BE VENTED TO THE OUTSIDE WITH A FAN CAPABLE OF PRODUCING A MINIMUM OF 5 AIR EXCHANGES PER HOUR.

# **FIRST FLOOR PLAN**

ISSUE DATE DESCRIPTION 5/14/15 50% SCHEMATIC DESIG 
 5/21/15
 75% SCHEMATIC DESIG

 9/8/16
 HOA REVIEW SET
 11/14/16 PERMIT SET

11/14/16 SCALE: PER PLAN


**DESIGNED BY:** M.A.C.

ISSUE DATE:

SHEET:

A-101

FIRST FLOOR PLAN

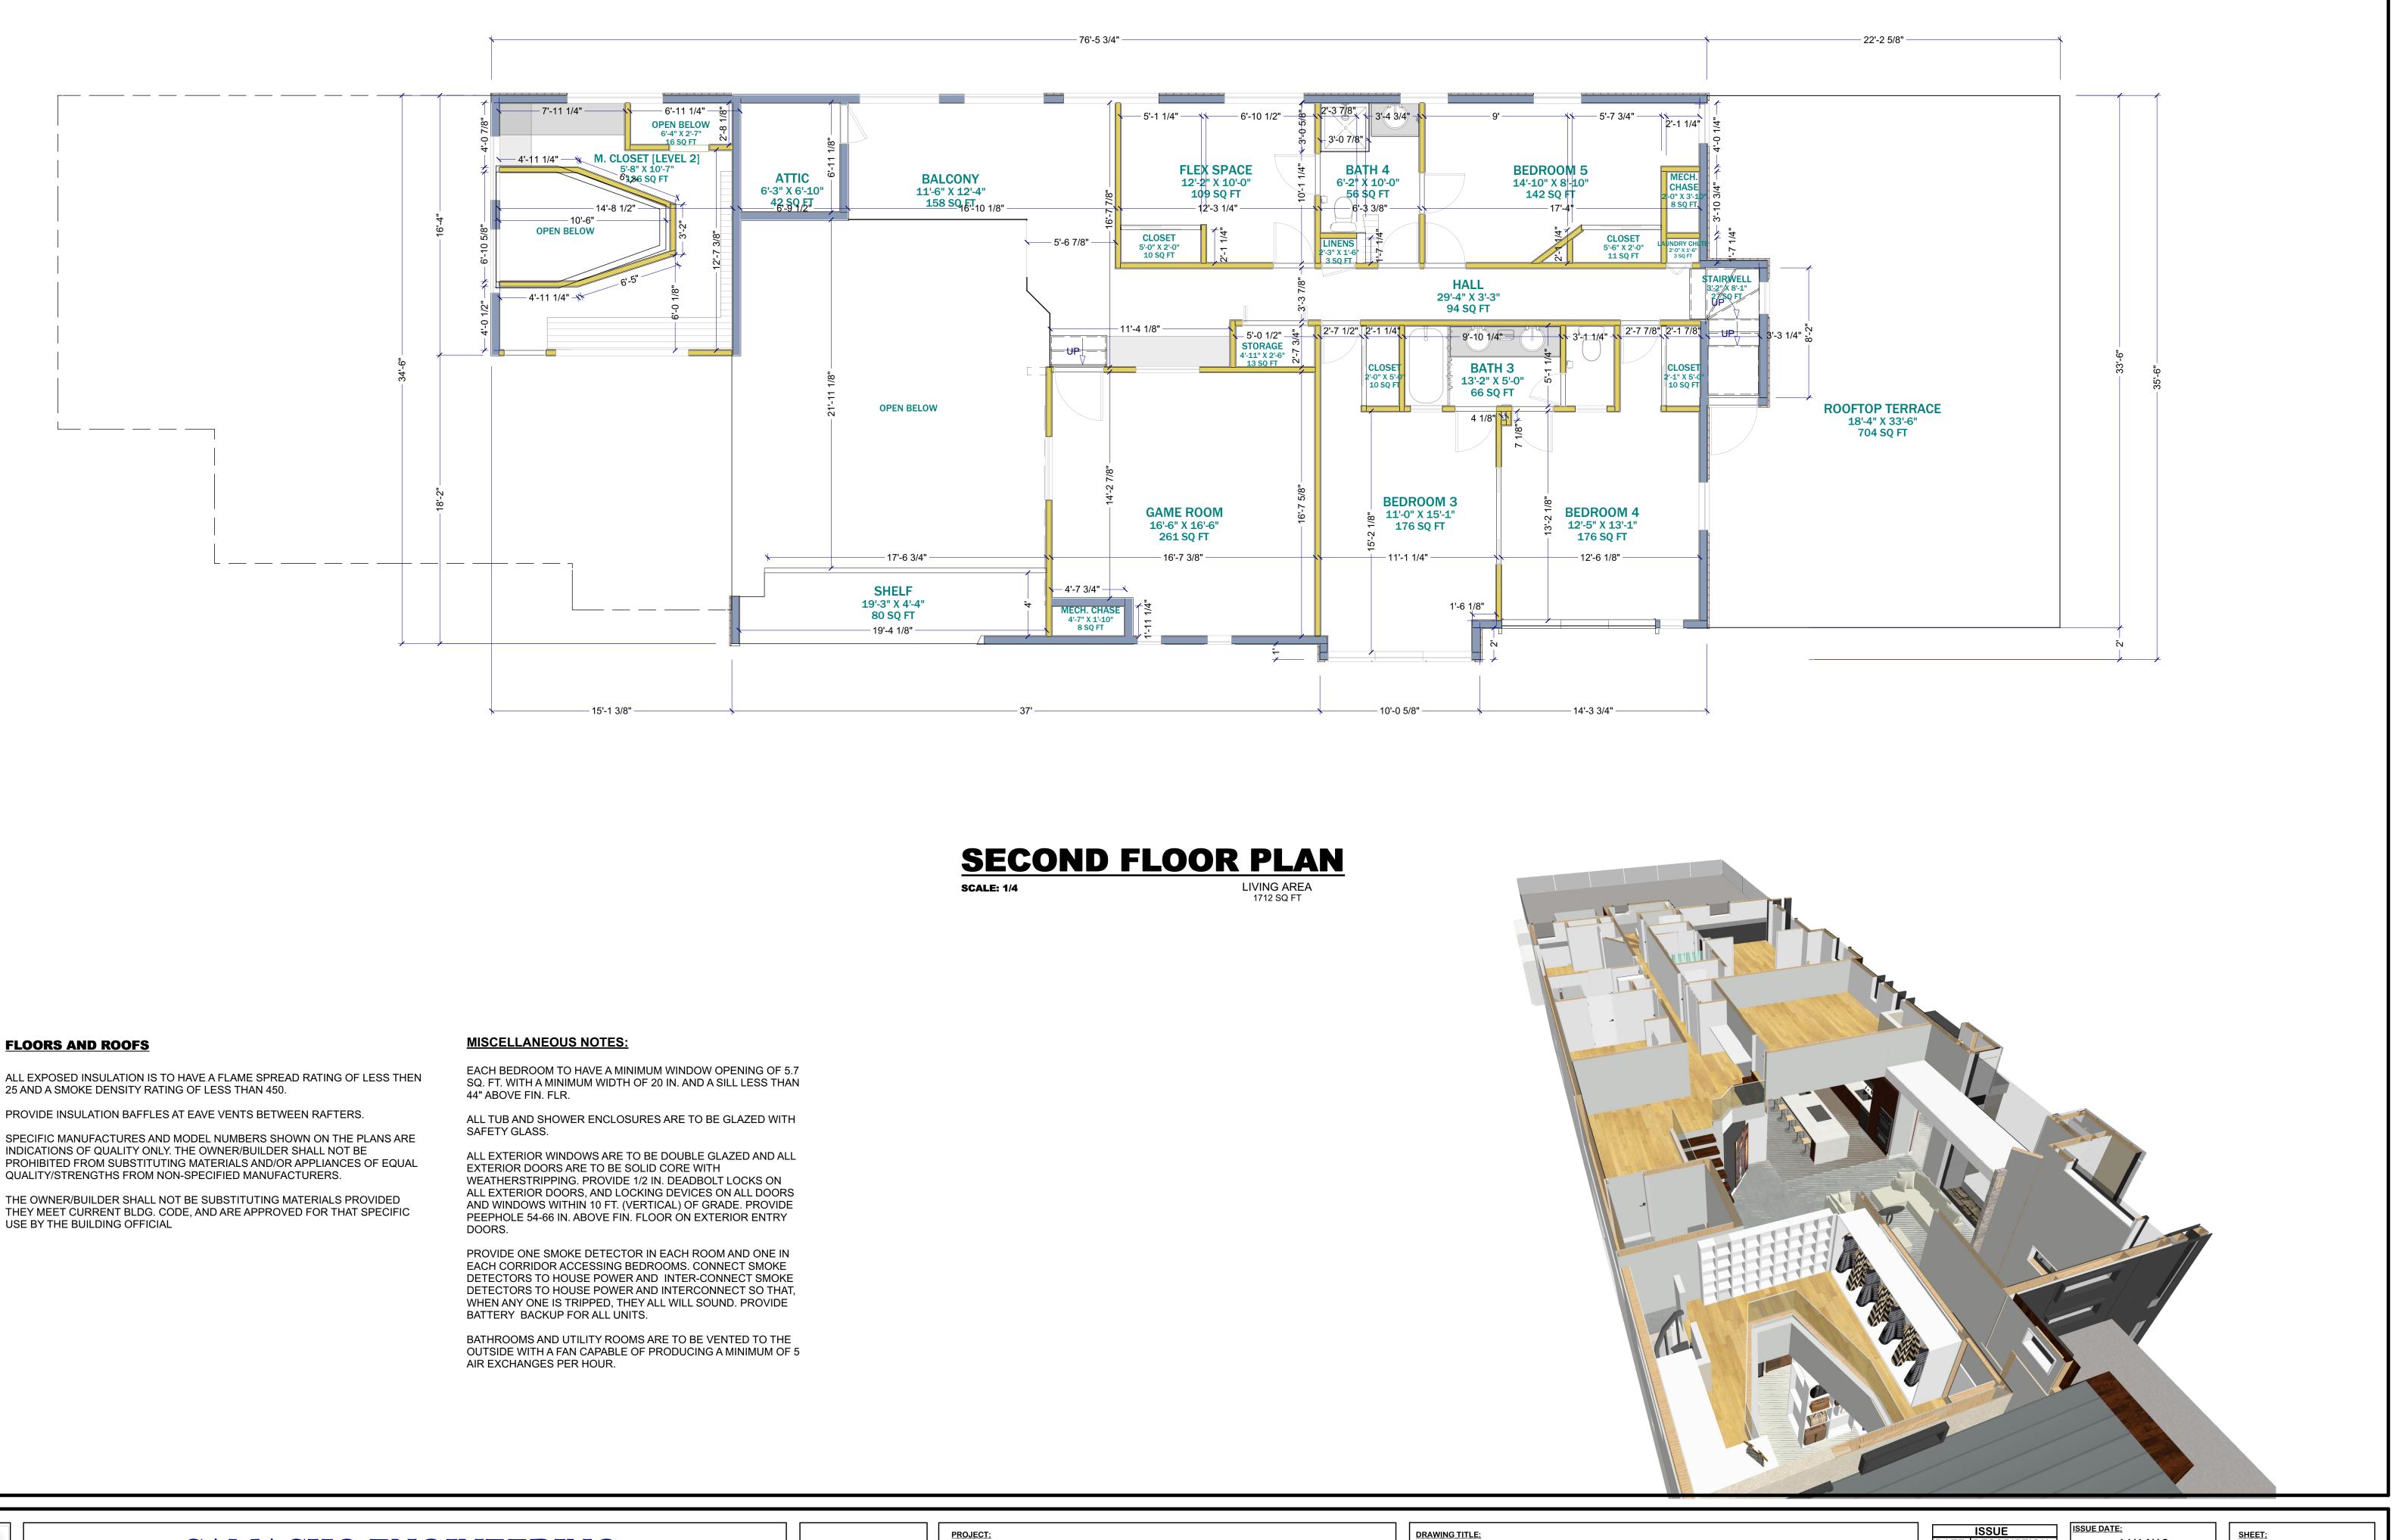

## FLOORS AND ROOFS

ALL EXPOSED INSULATION IS TO HAVE A FLAME SPREAD RATING OF LESS THEN 25 AND A SMOKE DENSITY RATING OF LESS THAN 450.

PROVIDE INSULATION BAFFLES AT EAVE VENTS BETWEEN RAFTERS.

SPECIFIC MANUFACTURES AND MODEL NUMBERS SHOWN ON THE PLANS ARE INDICATIONS OF QUALITY ONLY. THE OWNER/BUILDER SHALL NOT BE PROHIBITED FROM SUBSTITUTING MATERIALS AND/OR APPLIANCES OF EQUAL QUALITY/STRENGTHS FROM NON-SPECIFIED MANUFACTURERS.

THEY MEET CURRENT BLDG. CODE, AND ARE APPROVED FOR THAT SPECIFIC USE BY THE BUILDING OFFICIAL

# 

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DRAWING TITLE:

306 HARBORVIEW DR., ROCKWALL, TEXAS 75032 - CHANDLERS LANDING -

# **SECOND FLOOR PLAN**


ISSUE					
DATE	DESCRIPTION				
5/14/15	50% SCHEMATIC DESIGN				
5/21/15	75% SCHEMATIC DESIGN				
9/8/16	HOA REVIEW SET				
11/14/16	PERMIT SET				

11/14/16

SCALE: PER PLAN

**DESIGNED BY:** M.A.C.

SHEET: A-102 SECOND FLOOR PLAN

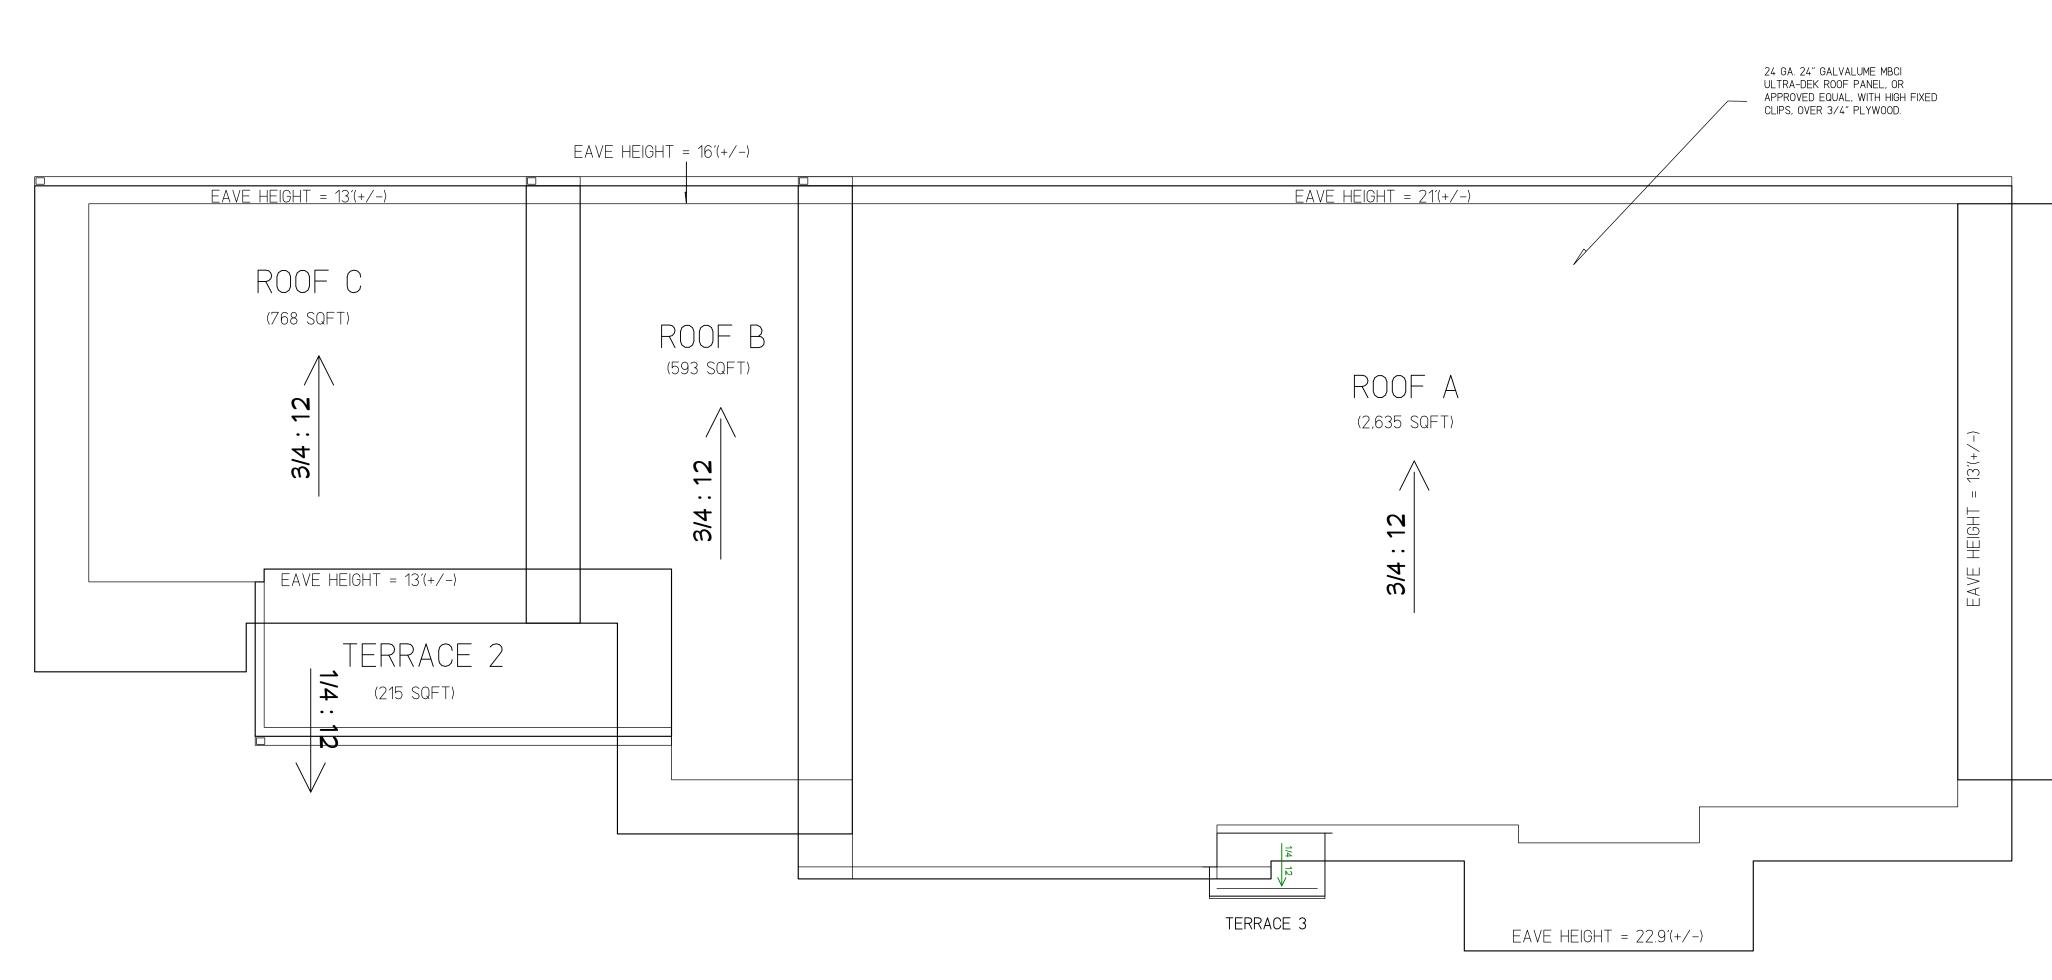

## ROOF NOTES:

1. ALL ROOF PANELS AND ROOF DECK SHALL BE CONTINUOUS FROM EAVE TO EAVE. NO PANEL END LAPS.

ALL GUTTERS & DOWNSPOUTS SHALL BE SIZED BY THE CONTRATOR AS REQ'D PER IRC/IBC 2015.
ROOF DIMENSIONS ON THIS PAGE ARE TO OUTSIDE FACE OF FASCIA.
ROOF PANEL SHALL BE EXTENDED MIN. 2" PAST THE FASCIA ALONG THE LOW EAVE, TYP.

5. SEE PLAN FOR ADDN'L INFO.

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# **ROOF LAYOUT**


NOT TO SCALE


## <u>GENERAL NOTES:</u>

1. "EQUAL" SUBSTITUTIONS MUST BE APPROVED BY CAM. ENG. PRIOR TO/WINTHIN CONTRACT AGREEMENT, OTHERWISE CONTRACTOR WILL BE REQUITRED TO PROVIDE AS SPECIFIED.


2. ROOFING, FLASHING & TRIM, CONCRETE AND REBAR QUANTITIES ARE TO BE DETERMINED BY THE CONTRACTOR AS REQUIRED. CONTRACTORS ARE RESPONSIBLE FOR DETERMINING THE NECESSARY MATERIAL QUANTITIES FOR BID, AREAS INDICATED HERIN REPRESENT THE "FLAT" AREA, AND ARE PROVIDED ONLY AS A GUIDE.


<u>N</u> G	BROJECT: <b>306 HARBORVIEW DR., ROCKWALL, TEXAS 75032</b> — CHANDLERS LANDING —	RO

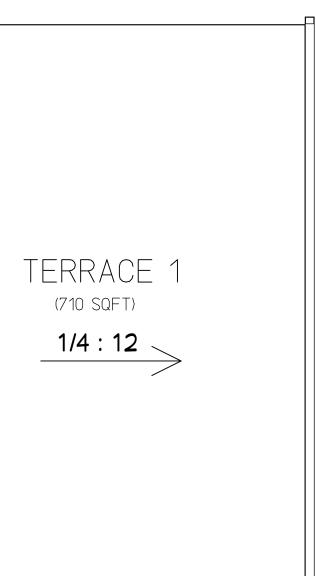


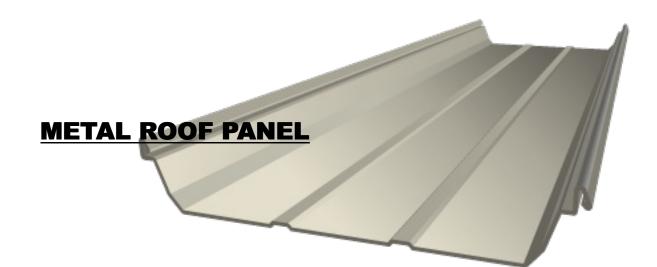

OOF PLAN	<b>DATE</b> 5/14/15 5/21/15 9/8/16 11/14/16	ISSUE DESCRIPTION 50% SCHEMATIC DESIGN 75% SCHEMATIC DESIGN HOA REVIEW SET PERMIT SET	ISSUE DATE: 11/14/16 SCALE: PER PLAN	SHEET: A-104
			<u>DESIGNED BY:</u> M.A.C.	ROOF PLAN

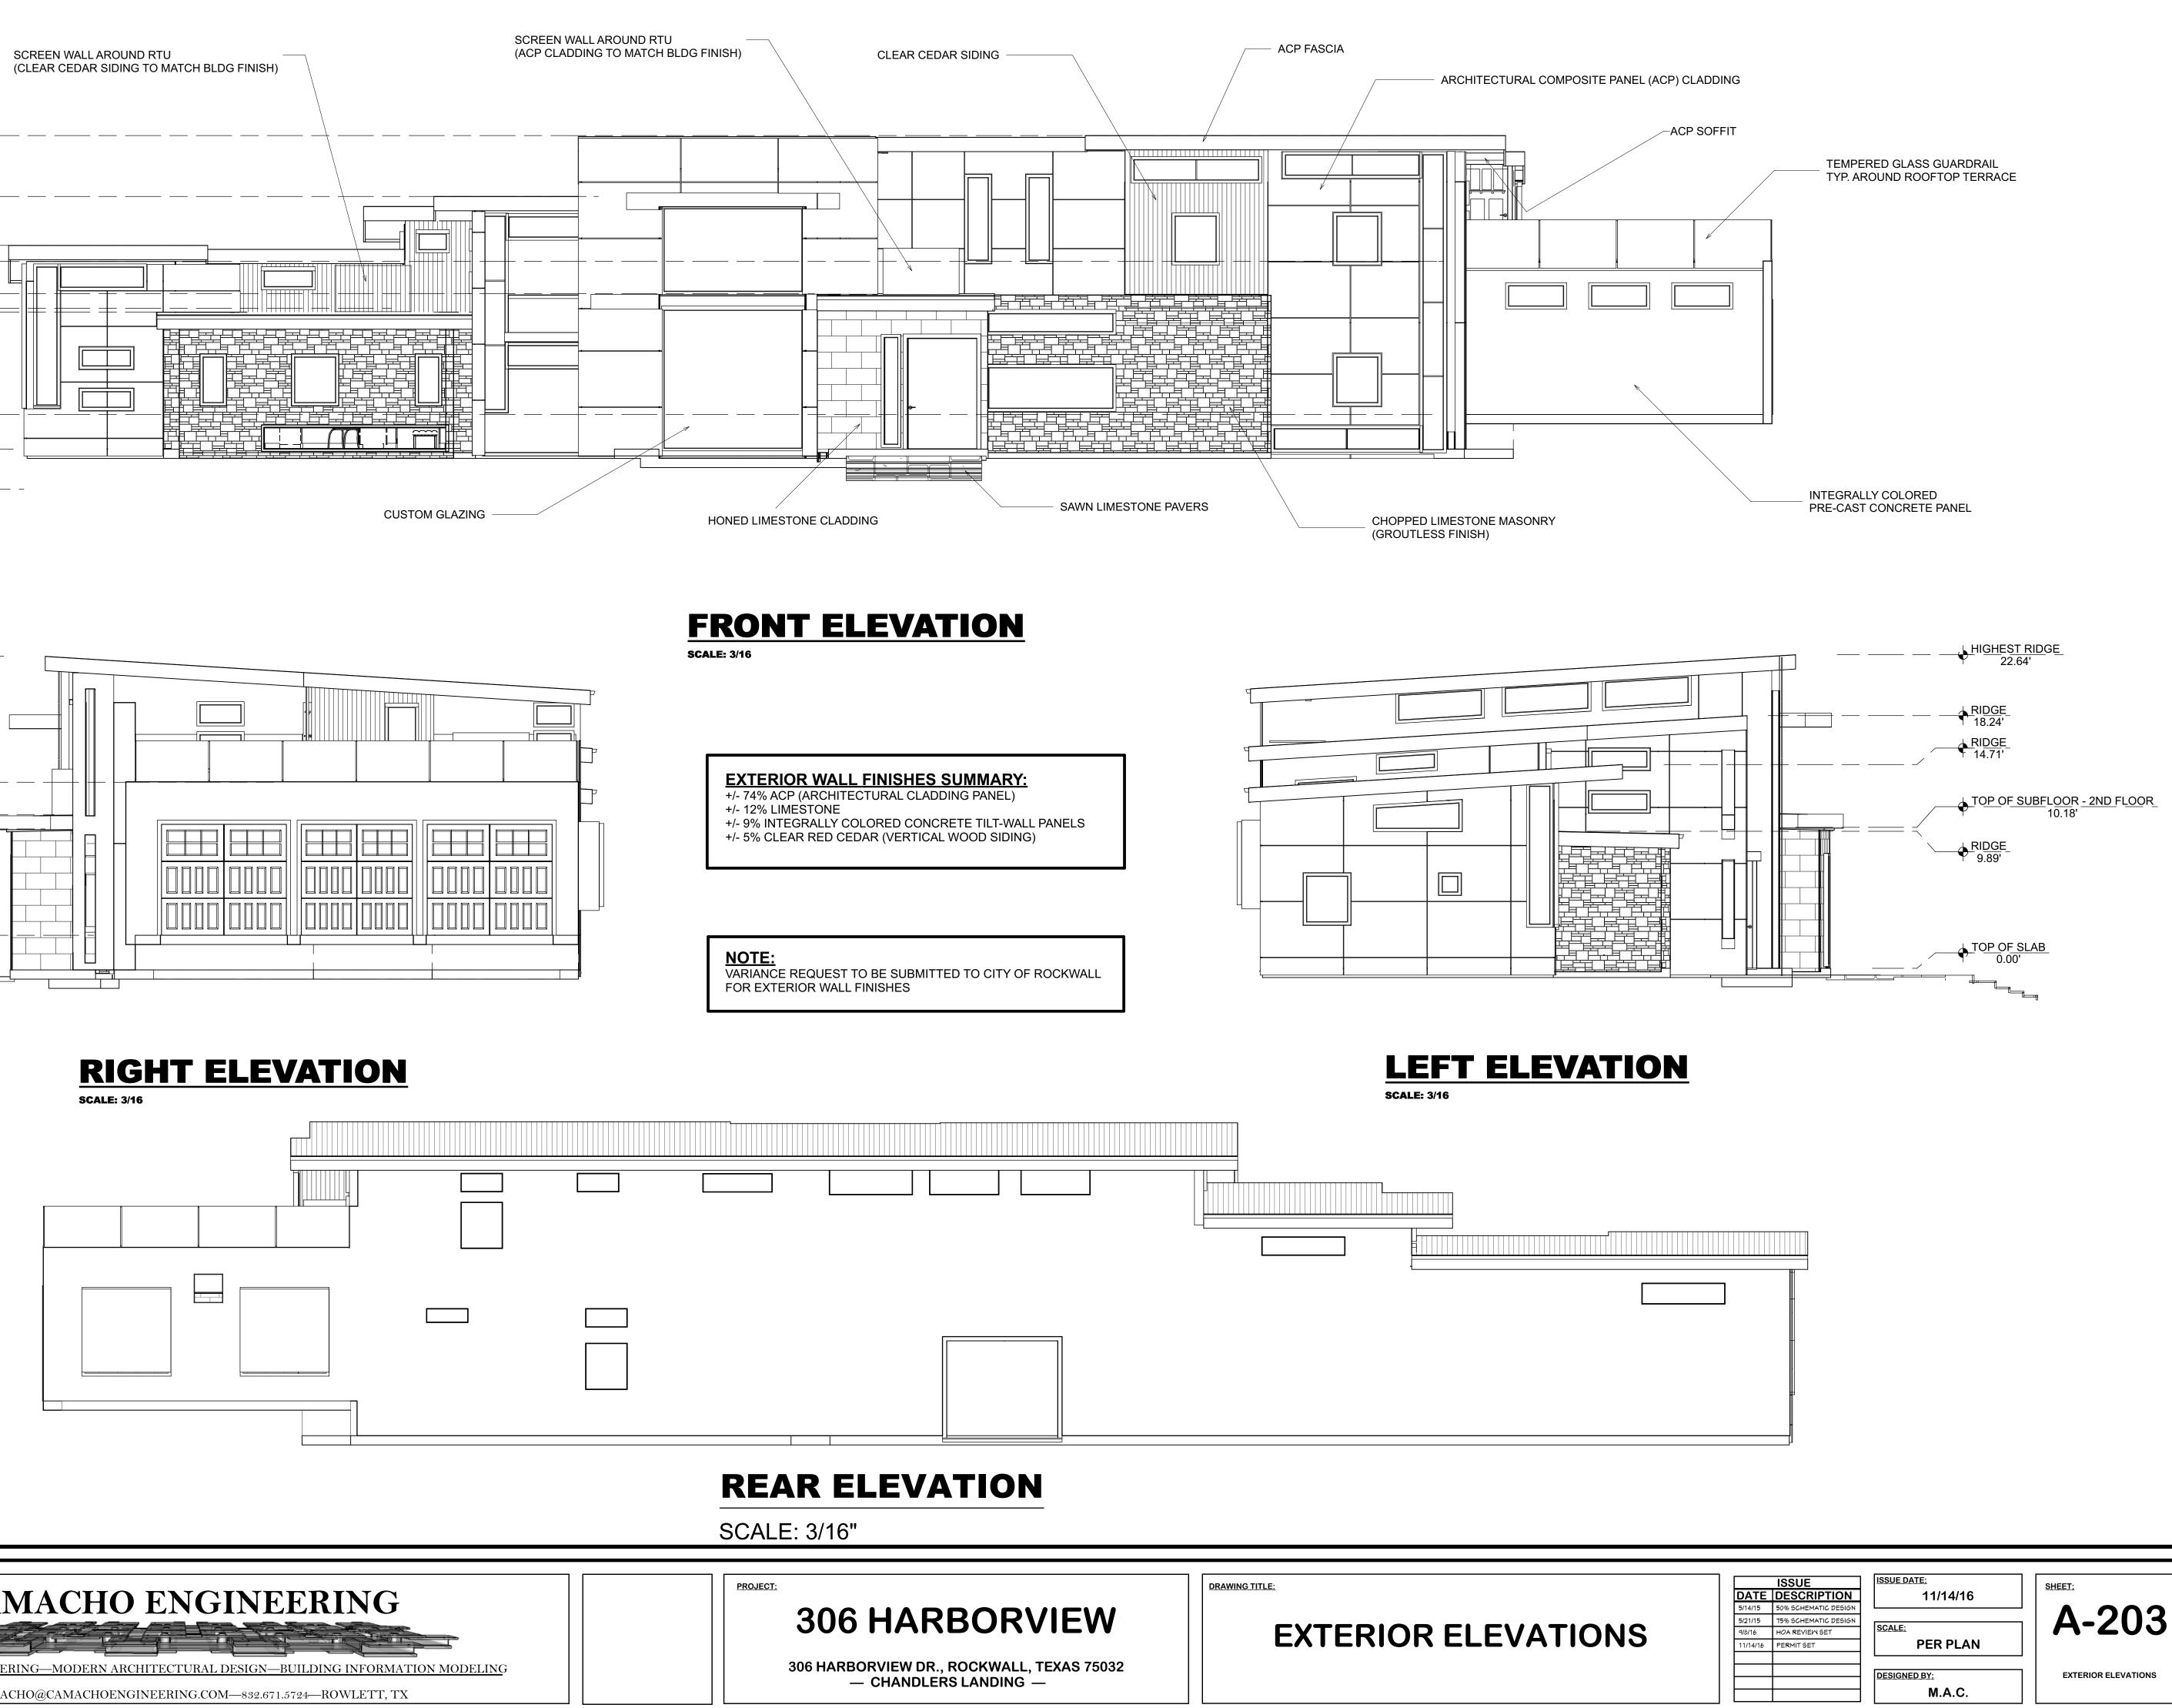


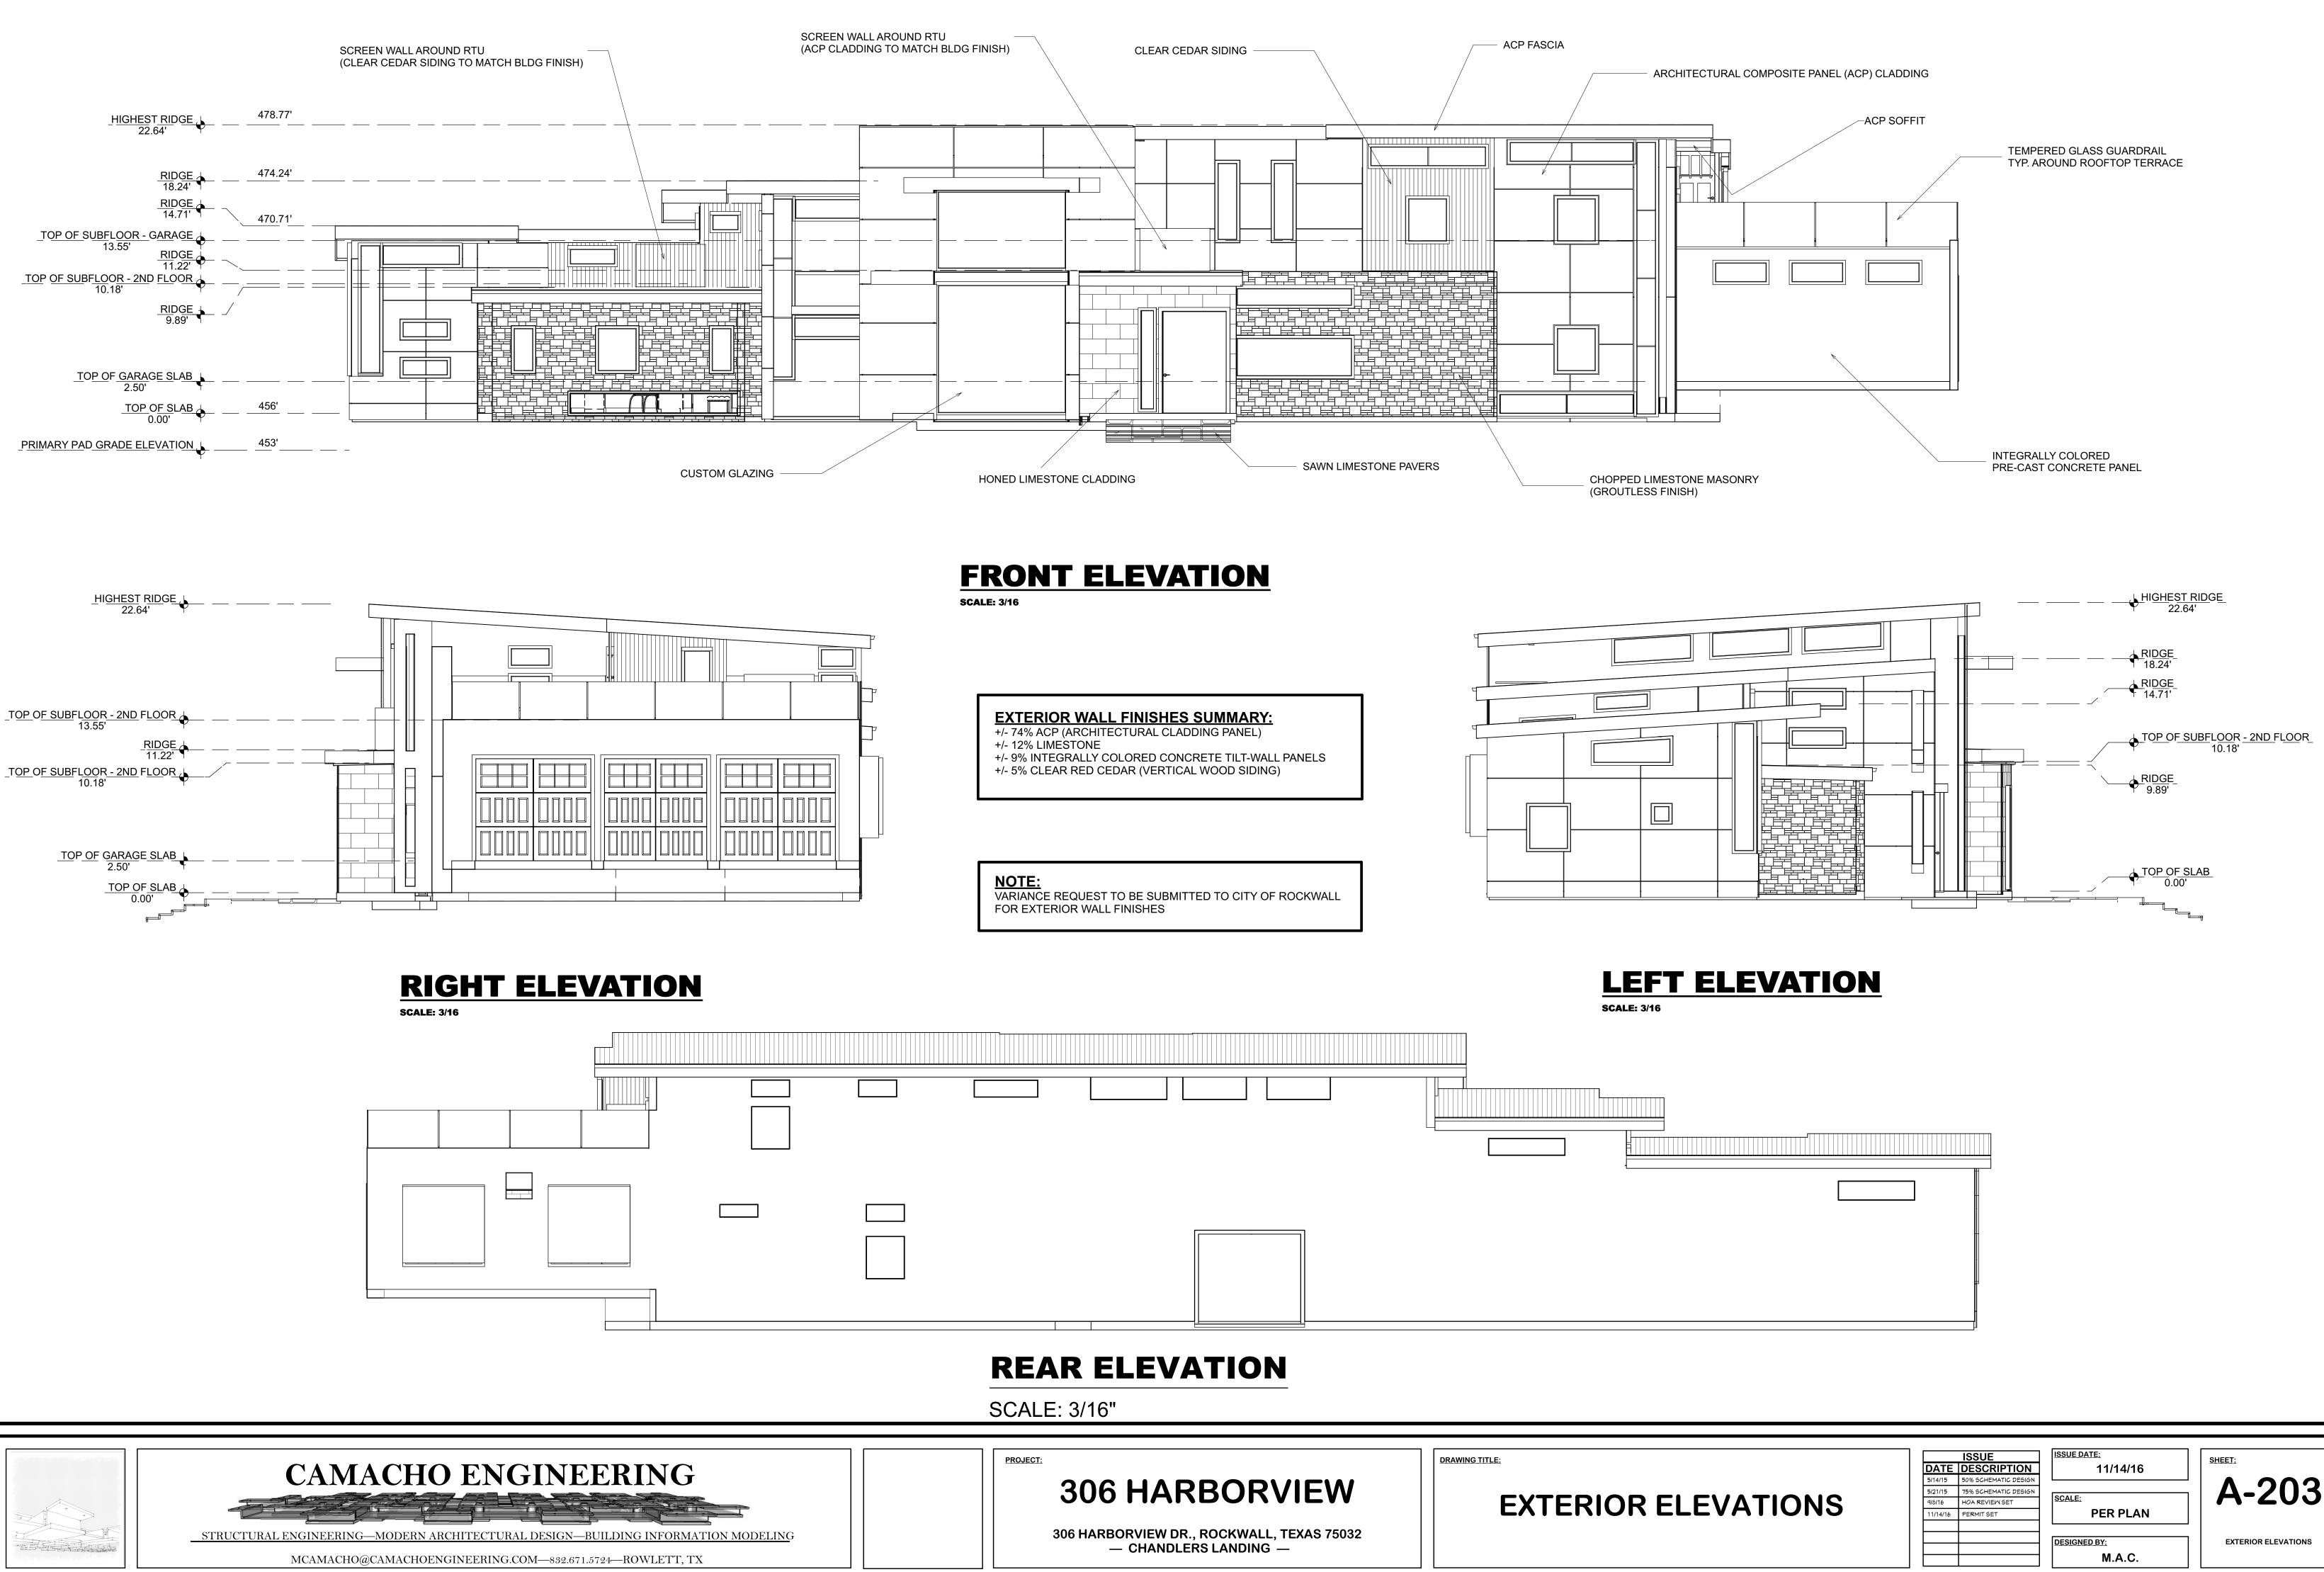


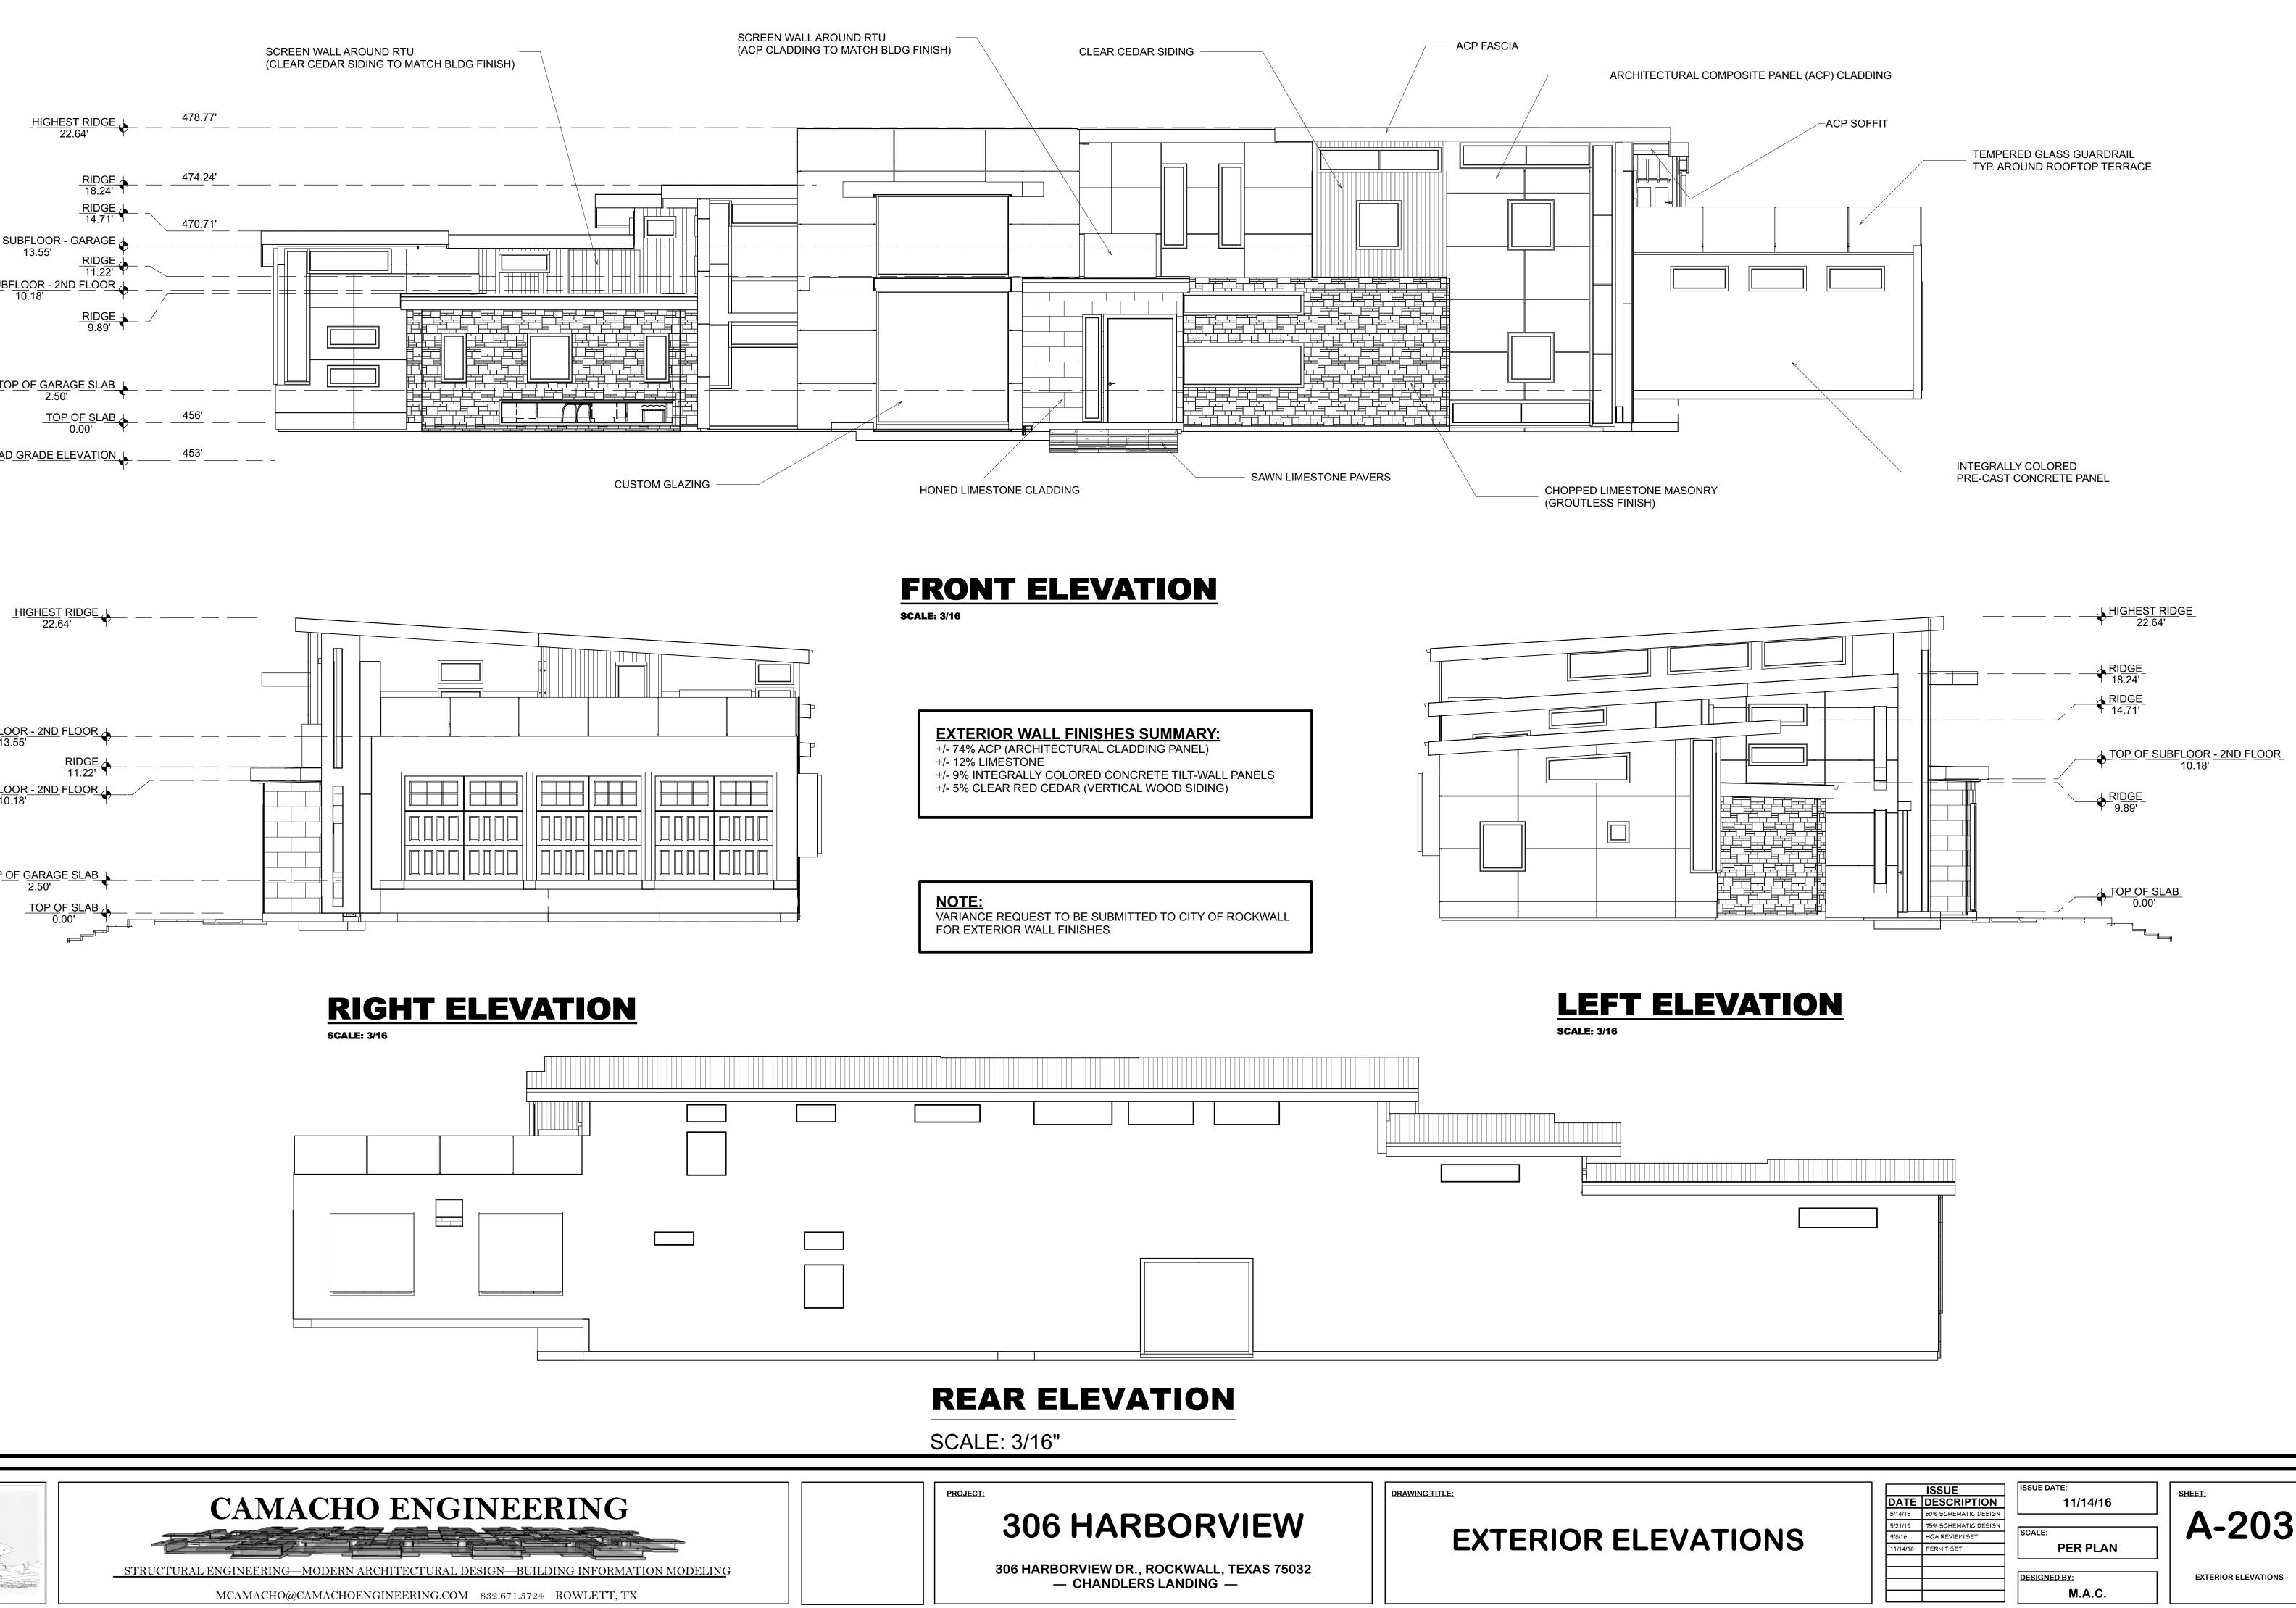

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OR ELEVATIONS	5/14/15 5/21/15 9/8/16 11/14/16	50% SCHEMATIC DESIGN 75% SCHEMATIC DESIGN HOA REVIEW SET PERMIT SET	SCALE: PER PLAN	<b>A-20</b>
			DESIGNED BY: M.A.C.	EXTERIOR ELEVA

EFT	ELEVA	TION
LE: 3/16		

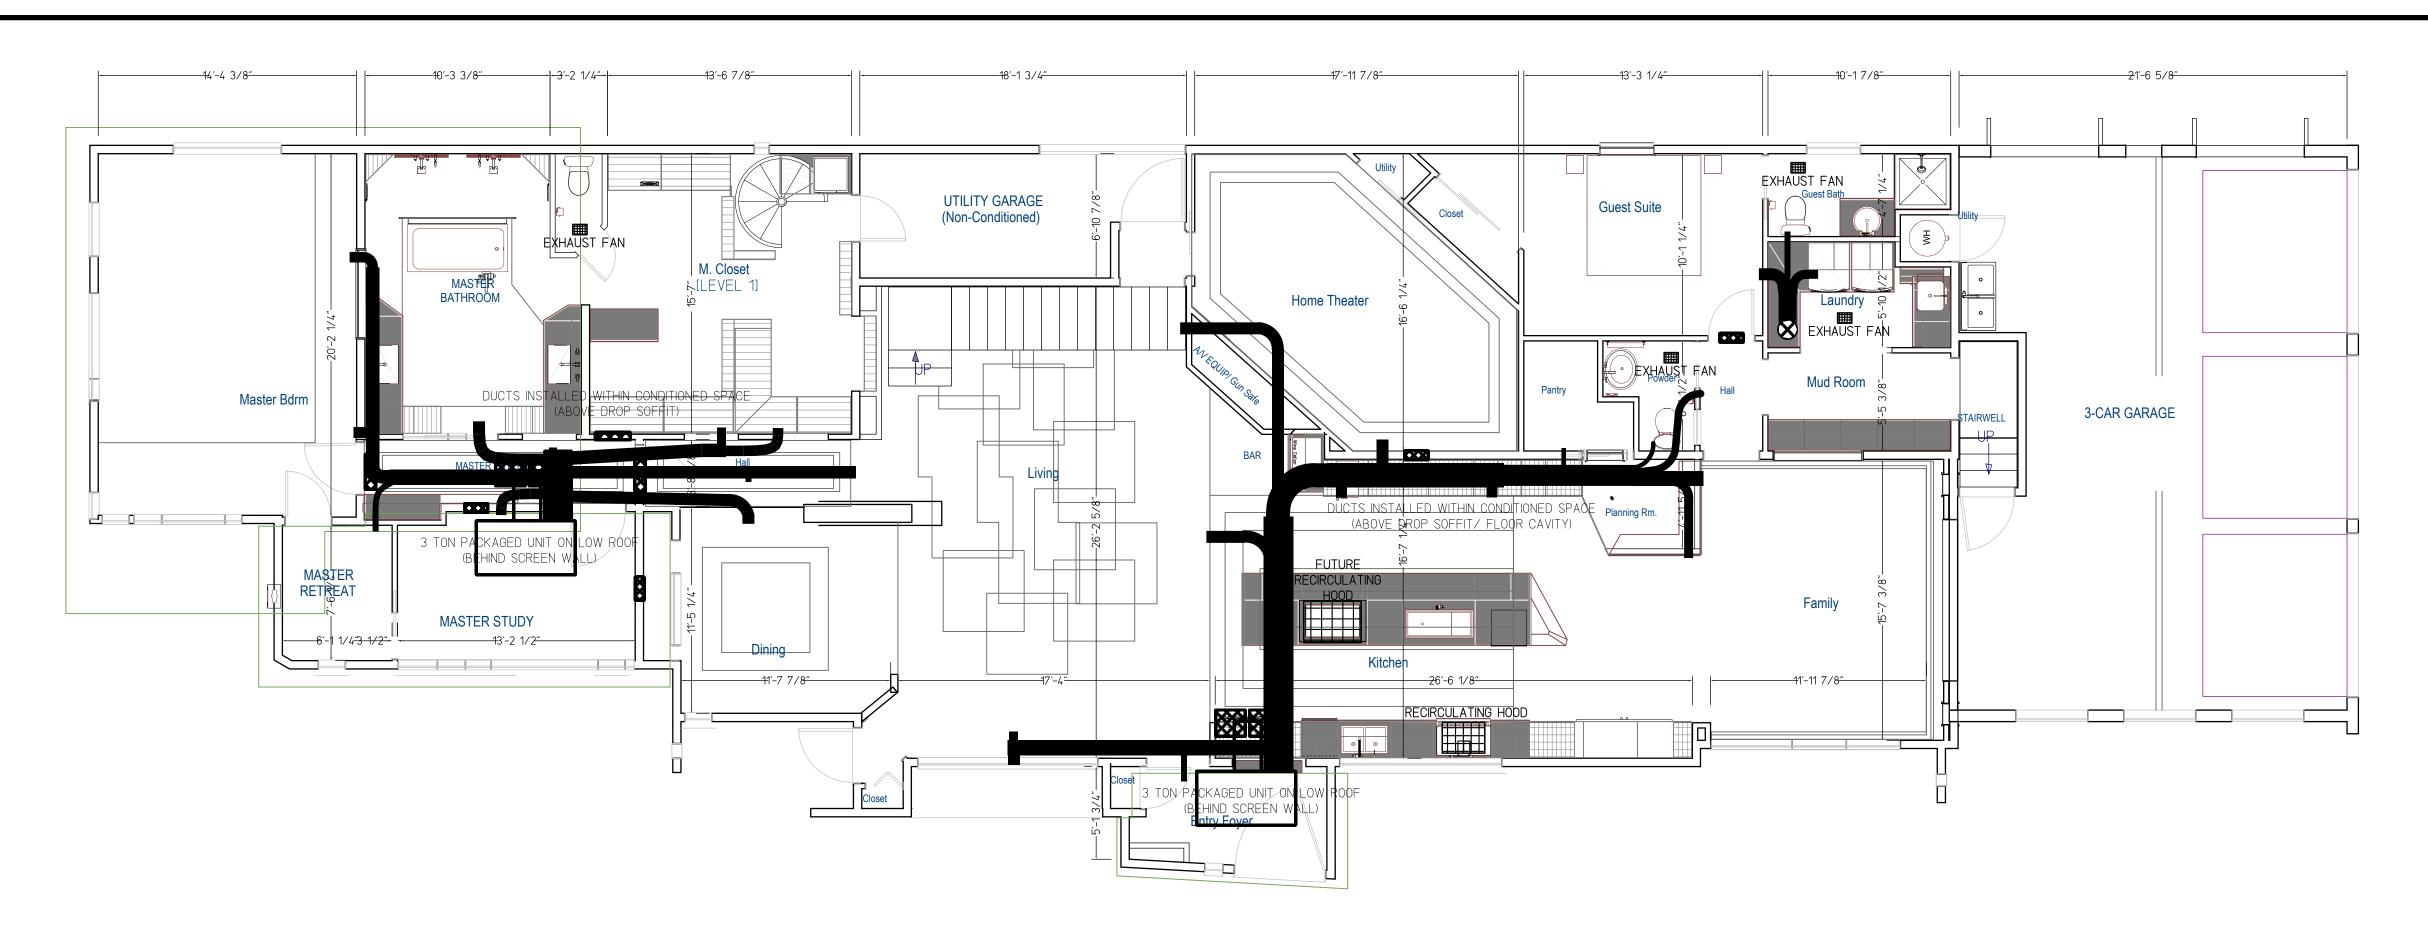

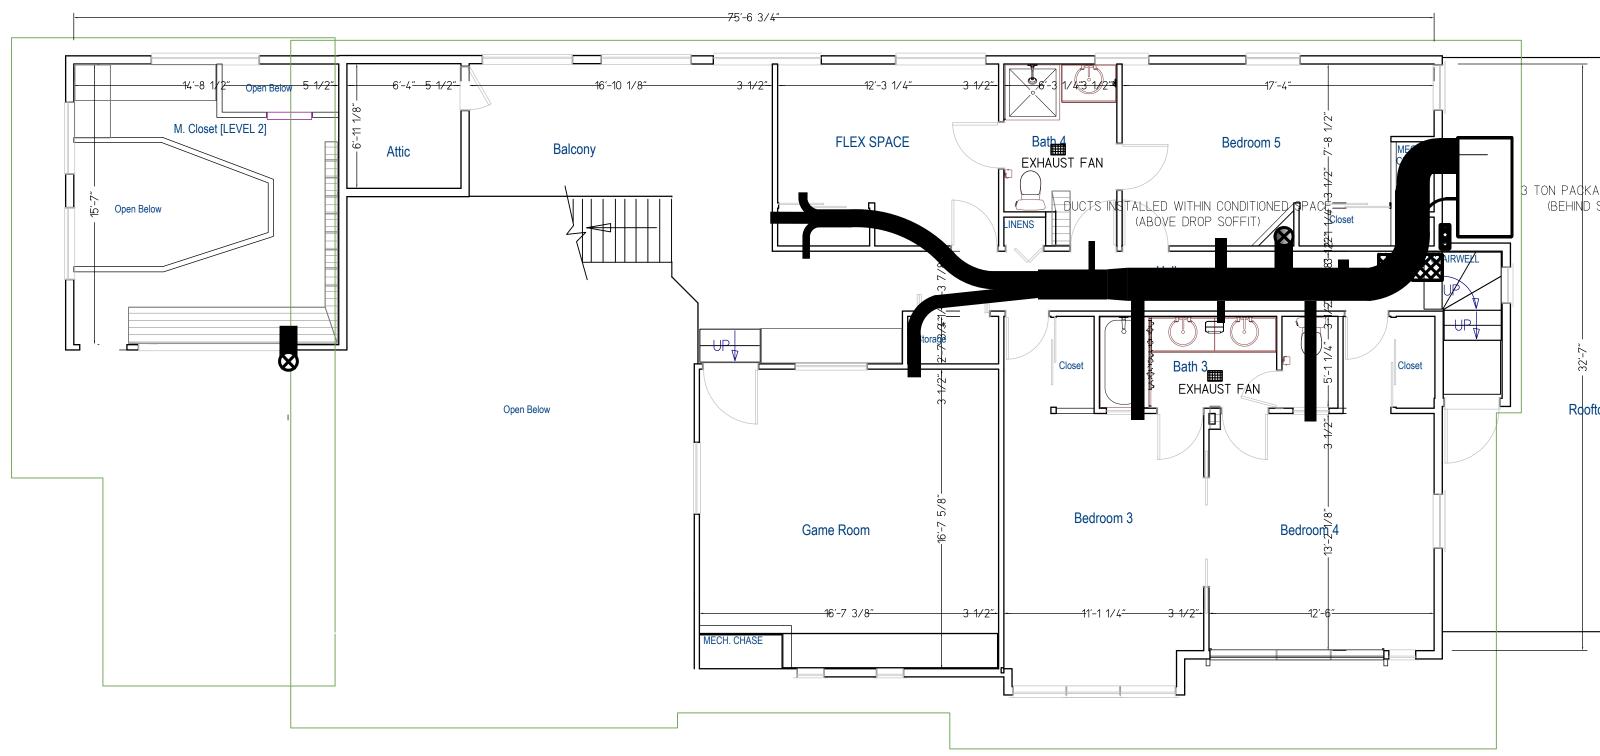

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## FIRST FLOOR MECHANICAL PLAN

SCALE: 3/16"

## SECOND FLOOR MECHANICAL PLAN


SCALE: 3/16"

PROJECT: DRAWING TITLE:	
NG SOG HARBORVIEW DR., ROCKWALL, TEXAS 75032 — CHANDLERS LANDING —	MECHA


3 TON PACKAGED UNIT ON ROOF (BEHIND SCREEN WALL)

Rooftop TERRACE

ANICAL PLAN	<b>DATE</b> 5/14/15 5/21/15 9/8/16 11/14/16	ISSUE DESCRIPTION 50% SCHEMATIC DESIGN 75% SCHEMATIC DESIGN HOA REVIEW SET PERMIT SET	ISSUE DATE: 11/14/16 SCALE: PER PLAN	<sup>SHEET:</sup> <b>M-101</b>
			DESIGNED BY: M.A.C.	MECHANICAL PLAN

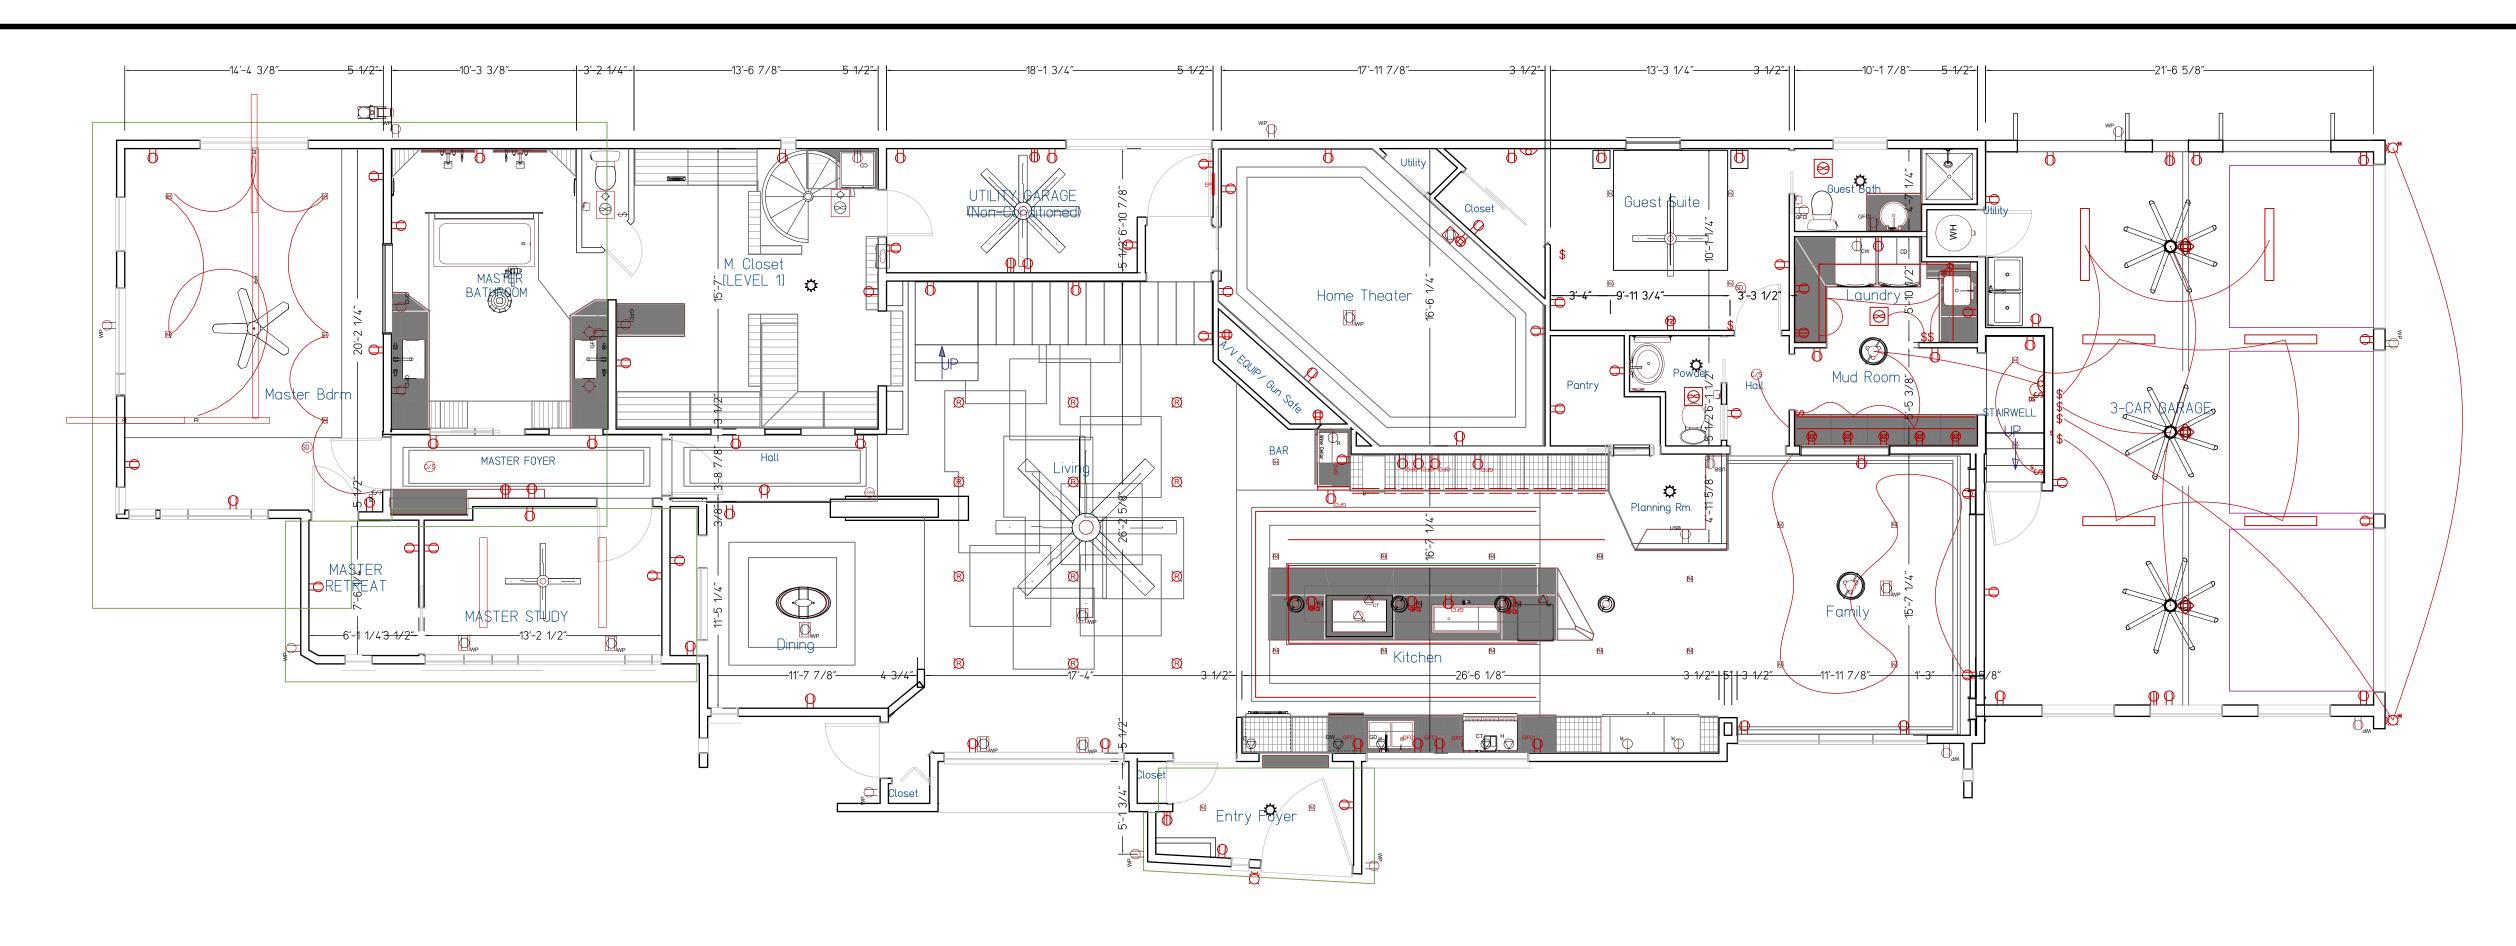

SCALE: 3/16"

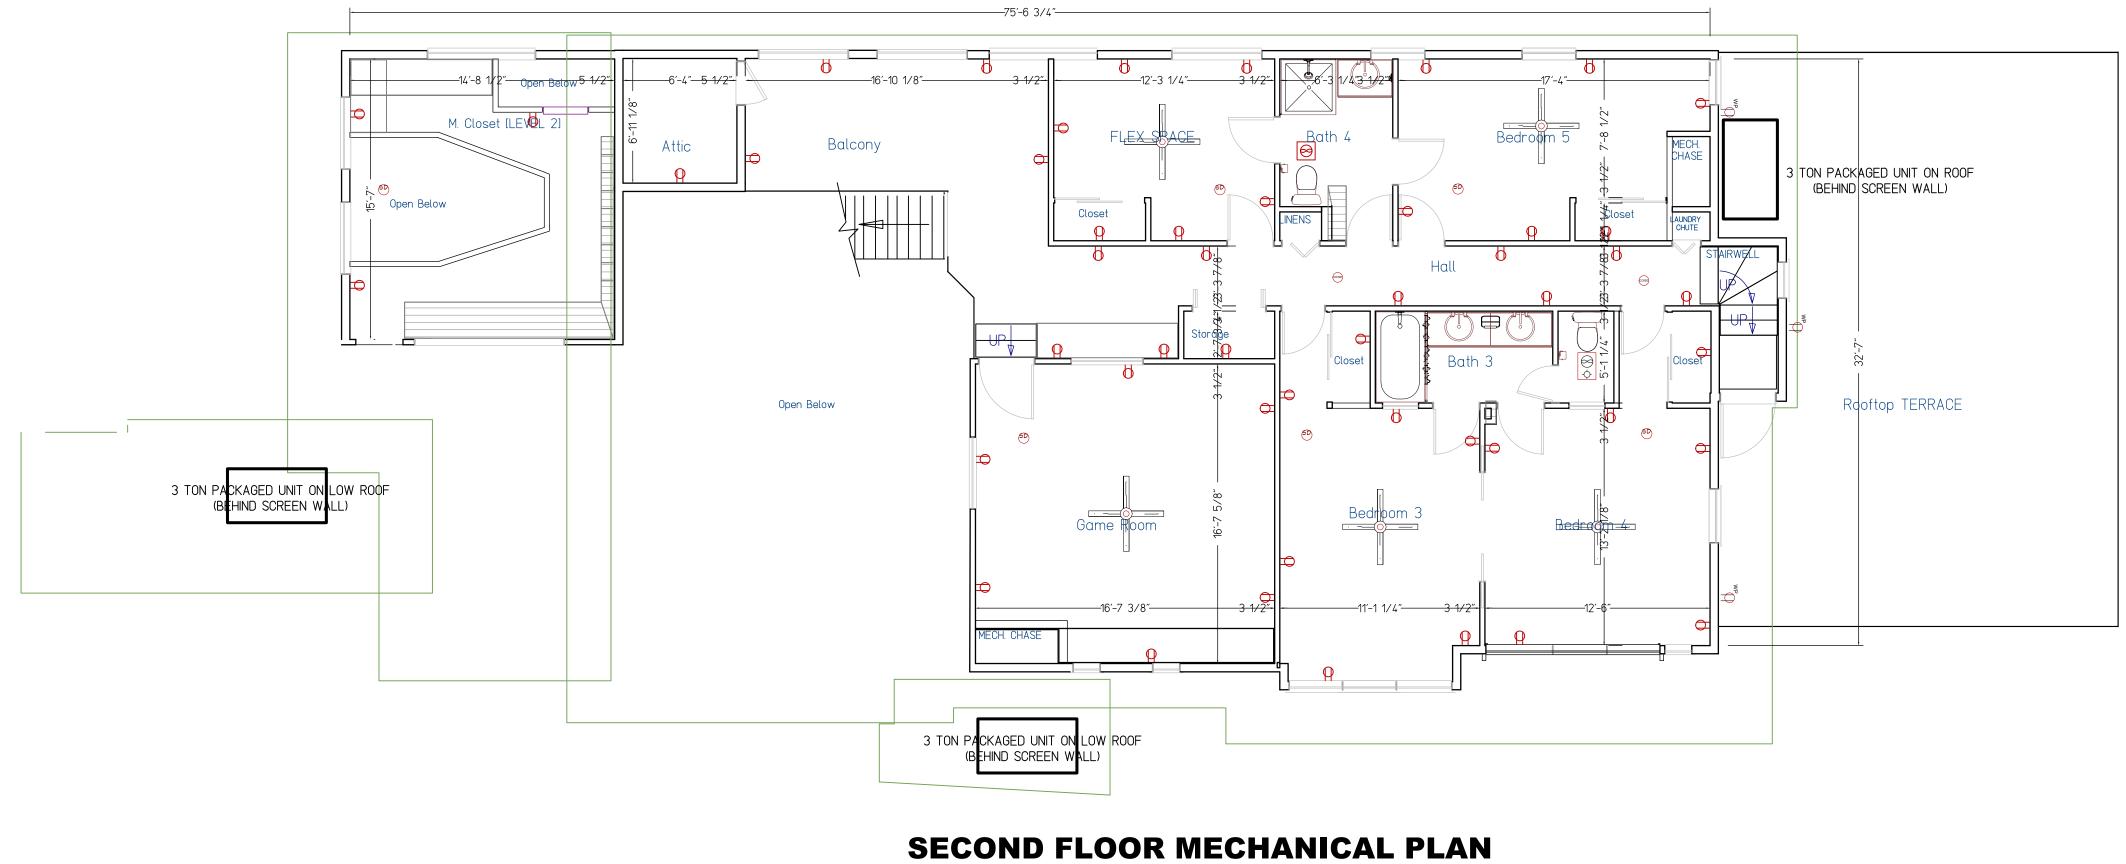

SCALE: 3/16"

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ACTENT OF

## FIRST FLOOR MECHANICAL PLAN

ING	PROJECT: <b>306 HARBORVIEW DR., ROCKWALL, TEXAS 75032</b> — CHANDLERS LANDING —	DRAWING TITLE: ELECTRICAL PLAN	ISSUE DATE DESCRIPTION 5/14/15 50% SCHEMATIC DESIGN 5/21/15 75% SCHEMATIC DESIGN 9/8/16 HOA REVIEW SET 11/14/16 PERMIT SET	ISSUE DATE: 11/14/16 SCALE: PER PLAN DESIGNED BY: M.A.C.	sheet: <b>E-101</b> electrical plan

## ELECTRICAL, DATA, & AUDIO NOTES:

HOME OWNER SHALL DO A WALK-THRU WITH RELEVANT INSTALLERS TO VERIFY THE EXACT LOCATION FOR OUTLETS, LIGHTS, SWITCHES, CABLE, DATA, PHONE, AUDIO, ETC.

## ELECTRICAL NOTES:

- 1. ELECTRICAL RECEPTACLES IN BATHROOMS, KITCHENS AND GARAGES SHALL BE G.F.I. ORG.F.I.C. PER NATIONAL ELECTRICAL CODE REQUIREMENTS.
- 2. PROVIDE ONE SMOKE DETECTOR IN EACH ROOM AND ONE IN EACH CORRIDOR ACCESSING BEDROOMS. CONNECT SMOKE DETECTORS TO HOUSE POWER AND INTER-CONNECT SMOKE DETECTORS SO THAT, WHEN ANY ONE IS TRIPPED, THEY ALL WILL SOUND. PROVIDE BATTERY BACKUP FOR ALL UNITS.
- 3. CIRCUITS SHALL BE VERIFIED WITH HOME OWNER PRIOR TO WIRE INSTALLATION.
- 4. FINAL SWITCHES FOR TIMERS AND DIMMERS SHALL BE VERIFIED
- WITH HOME OWNER. 5. FIXTURES TO BE SELECTED BY HOME OWNER.


AUDIO:

- 1. LOCATE SPEAKERS AND AUDIO CONTROLS AS INDICATED IN THE PLAN; RUN CIRCUIT OF SPEAKER WIRING TO AUDIO HOME PANEL SPECIFIED BY FLOOR;
- 2. AUDIO SPEAKERS TO BE APPROVED BY HOME OWNER; 3. LOCATE JACKS AS INDICATED IN THE PLAN; INSTALL DATA / CABLE PANEL SIMILAR TO "ON Q". SYSTEM TO BE APPROVED BY HOME OWNER.

DATA / CABLE:

LOCATE SECURITY PANELS AS INDICATED IN THE PLAN; SYSTEM TO BE APPROVED BY HOME OWNER.

ELECTRICAL LE	GEND
SYMBOL	DESCRIPTION
K	<u>Ceiling Fan</u>
፼	Ventilation Fans Ceiling Mounted II Wall Mounted
<mark>  🗘 🗘</mark> 🖻 🖻	<u>Ceiling Mounted Light Fixtures</u> Surface II Pendant II 6" Recessed II 4" Recessed
₽ Q Q	Wall Mounted Light Fixtures Flush Mounted II Wall Sconce II Motion Sensing Security Light
	<u>Chandelier Light Fixture</u> Small II Medium II Large
	Fluorescent Light Fixture
$\square$	240V Receptacle
	110V Receptacles : Duplex, Quadruplex, Weather Proof, GFCI, Ceiling Mounted Duplex/Quad [Note: All kitchen outlets to be 20amp GFCI hard wired circuits]
	<u>110V Receptacles (con't)</u> Soffit Mounted WP II Ground Mounted WP (Yard) II Floor Mounted WP (Pop-Up) II Counter Mounted GFCI/WP (Pop-Up)
	<u>Hard Wired:</u> Hard Wired: Double Oven II Dishwasher II Cook Top II Hood II USB Outlet
\$ <sup>₩₽</sup> \$³\$ <sup>4</sup> \$	<u>Switches:</u> Switches: Single Pole (Double/Tripple Combination where applicable), Weather Proof, 3-Way, 4-Way
<sup>D</sup> S <sup>DR</sup> S <sup>S</sup> \$ <sup>DS</sup>	<u>Switches (con't)</u> Switches: Dimmer, Dimmer with Remote, Senser(Motion/Occupancy/Daylight Sensor + Timer, TYP.), Dimmer with Sensor
® 🛎 🕼	Smoke Detectors (Ceiling Mounted/ Wall Mounted II Combo Carbon Monoxide/ Smoke Detectors
EP	Electrical Breaker Panel
0	Tankless Water Heater

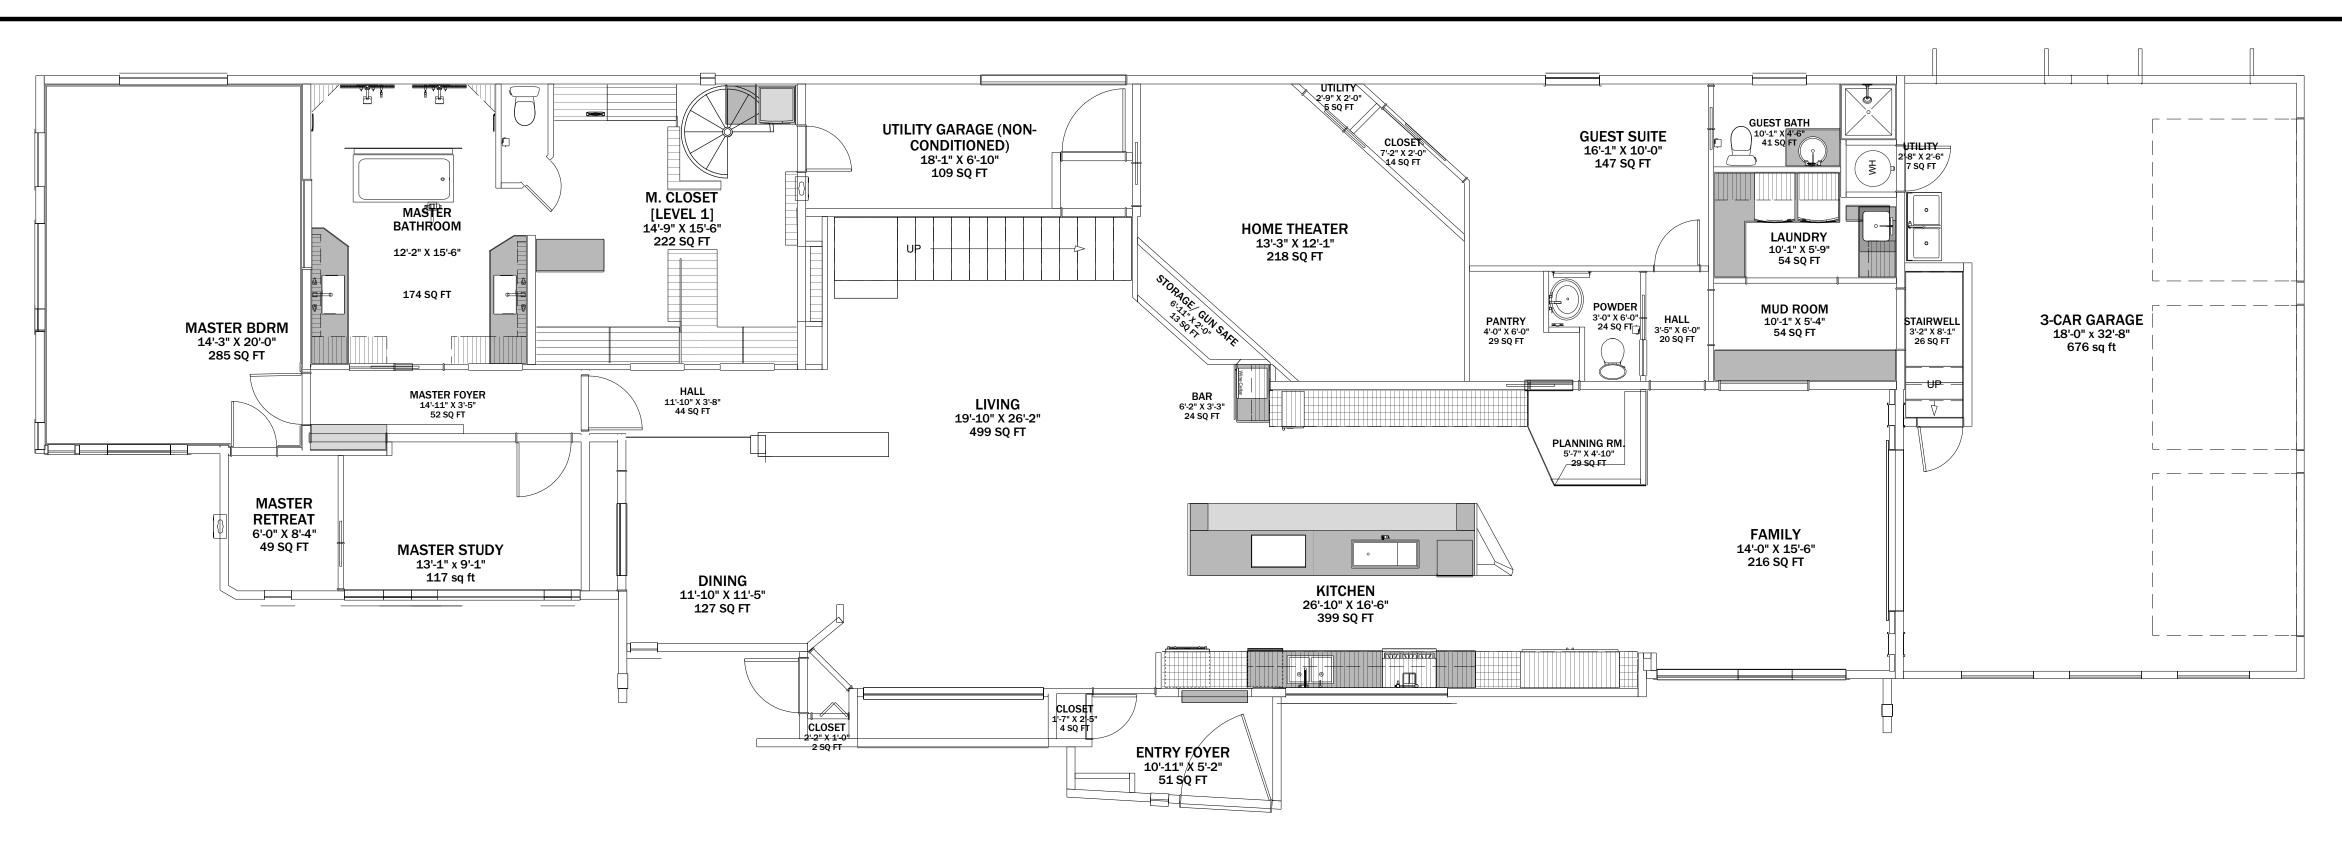




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DRAWING TITLE: PROJECT: **CAMACHO ENGINEERING 306 HARBORVIEW** PLUN 306 HARBORVIEW DR., ROCKWALL, TEXAS 75032 — CHANDLERS LANDING — STRUCTURAL ENGINEERING—MODERN ARCHITECTURAL DESIGN—BUILDING INFORMATION MODELING MCAMACHO@CAMACHOENGINEERING.COM—832.671.5724—ROWLETT, TX

## **FIRST FLOOR FIXTURE LAYOUT** SCALE: 3/16"

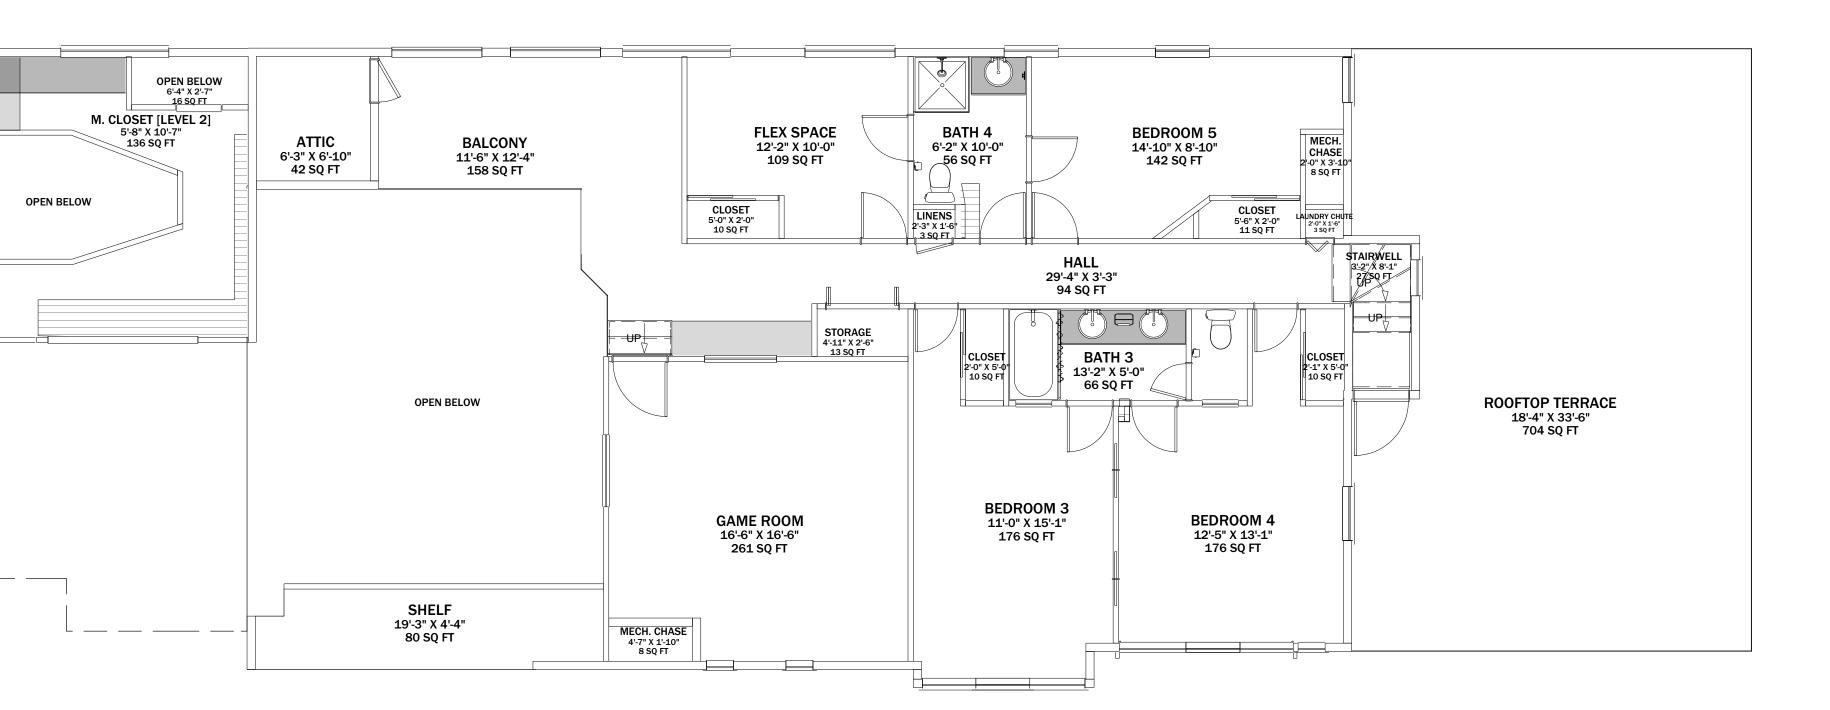

# **SECOND FLOOR FIXTURE LAYOUT**

SCALE: 3/16"

			] [	ISSUE DATE:		SHEET:		
		DESCRIPTION		11/14/16				
	5/14/15			<b>P-101</b>				
MBING PLAN	9/8/16	HOA REVIEW SET		SCALE:				
	11/14/16	PERMIT SET		PER PLAN				
				DESIGNED BY:		PLUMBING PLAN		
				M.A.C.				







