

PLANNING & ZONING CASE NO.

PLANNING & ZONING FEE

PLATTING APPLICATION

MASTER PLAT PRELIMINARY PLAT FINAL PLAT REPLAT

AMENDING OR MINOR PLAT PLAT REINSTATEMENT REQUEST

SITE PLAN APPLICATION

SITE PLAN

AMENDED SITE PLAN/ELEVATIONS/LANDSCAPING

ZONING APPLICATION

ZONING CHANGE SPECIFIC USE PERMIT PD DEVELOPMENT PLAN

OTHER APPLICATION

TREE REMOVAL

VARIANCE REQUEST/SPECIAL EXCEPTIONS

RECORD OF RECOMMENDATIONS, VOTING RECORDS, AND CONDITIONS OF APPROVAL

ARCHITECTURE REVIEW BOARD	CITY COUNCIL READING #2
PLANNING AND ZONING COMMISSION	CONDITIONS OF APPROVAL
CITY COUNCIL READING #1	NOTES



NOTARY PUBLIC IN AND FOR THE STATE OF TEXAS

DEVELOPMENT APPLICATION

City of Rockwall Planning and Zoning Department 385 S. Goliad Street Rockwall, Texas 75087

TAFF (USE OI	NLY -
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PLANNING & ZONING CASE NO.


<u>NOTE:</u> THE APPLICATION IS NOT CONSIDERED ACCEPTED BY THE CITY UNTIL THE PLANNING DIRECTOR AND CITY ENGINEER HAVE SIGNED BELOW.

DIRECTOR OF PLANNING:

CITY ENGINEER:


PLEASE CHECK THE	APPROPRIATE BOX BELOW TO INDICATE THE TYPE	OF DEVELOPMENT RE	QUEST [SELECT ONLY ONE BOX]:
☐ PRELIMINARY ☐ FINAL PLAT (\$ ☐ REPLAT (\$300 ☐ AMENDING OF ☐ PLAT REINSTA SITE PLAN APPL ☐ SITE PLAN (\$2	(\$100.00 + \$15.00 ACRE) 1 PLAT (\$200.00 + \$15.00 ACRE) 1 300.00 + \$20.00 ACRE) 1 .00 + \$20.00 ACRE) 1 R MINOR PLAT (\$150.00) ATEMENT REQUEST (\$100.00)	☐ SPECIFIC US ☐ PD DEVELO OTHER APPLIC ☐ TREE REMO ☐ VARIANCE F NOTES: ¹: IN DETERMINING T PER ACRE AMOUNT. ²: A \$1,000.00 FEE ¹	ANGE (\$200.00 + \$15.00 ACRE) 1 SE PERMIT (\$200.00 + \$15.00 ACRE) 1 8 2 PMENT PLANS (\$200.00 + \$15.00 ACRE) 1 CATION FEES:
DDODEDTY INC	ORMATION [PLEASE PRINT]		
ADDRES		all TX 75032	
SUBDIVISIO		an, 17 70002	LOT 1 PLOOF 1
			LOT 1 BLOCK 1
GENERAL LOCATIO	Tract East of John King Blvd. bet	ween Discovery	Blvd. & State Highway 276
ZONING, SITE P	LAN AND PLATTING INFORMATION [PLEA	SE PRINT]	
CURRENT ZONIN	G Light Industrial	CURRENT USE	Light Industrial
PROPOSED ZONIN	G Light Industrial	PROPOSED USE	Light Industrial
ACREAG	E 18.48 LOTS [CURREN	T] 1	LOTS [PROPOSED] 1
REGARD TO ITS RESULT IN THE	D PLATS: BY CHECKING THIS BOX YOU ACKNOWLEDGE APPROVAL PROCESS, AND FAILURE TO ADDRESS ANY OF DENIAL OF YOUR CASE. CANT/AGENT INFORMATION [PLEASE PRINT/C	STAFF'S COMMENTS BY	GAGE OF <u>HB3167</u> THE CITY NO LONGER HAS FLEXIBILITY WIT. THE DATE PROVIDED ON THE DEVELOPMENT CALENDAR WIL
	Reserve Capital - Rockwall Industrial SPE LLC		Industrial Reserve
CONTACT PERSON		CONTACT PERSON	Justin Toon
ADDRESS	15110 Dallas Pkwy	ADDRESS	15110 Dallas Pkwy
	P O Box 670551		P O Box 670551
CITY, STATE & ZIP	Dallas, TX 75367	CITY, STATE & ZIP	Dallas, TX 75367
PHONE	214-577-6789	PHONE	214-577-6789
E-MAIL	justin@industrialreserve.net	E-MAIL	justin@industrialreserve.net
BEFORE ME, THE UNDE	CATION [REQUIRED] RSIGNED AUTHORITY, ON THIS DAY PERSONALLY APPEARE ION ON THIS APPLICATION TO BE TRUE AND CERTIFIED TH		[OWNER] THE UNDERSIGNED, WHO
NFORMATION CONTAINS	, TO COVER THE COST OF THIS APPLICATION, H. 20 24 . BY SIGNING THIS APPLICATION. I AGR	AS BEEN PAID TO THE CITY REE THAT THE CITY OF RO S ALSO AUTHORIZED ANL	TED HEREIN IS TRUE AND CORRECT: AND THE APPLICATION FEE OF OF ROCKWALL ON THIS THE 11 35 115 DAY OF OCKWALL (I.E. "CITY") IS AUTHORIZED AND PERMITTED TO PROVID O PERMITTED TO REPRODUCE ANY COPYRIGHTED INFORMATION TO A REQUEST TO A PROPERTY OF TO A REQUEST.
GIVEN UNDER MY HANL	O AND SEAL OF OFFICE ON THIS THE I LITTLE DAY OF M.	arch 2021	JACKSON FREDERICK Notary ID #134687908 My Commission Expires December 20, 2027

MY COMMISSION EXPIRES

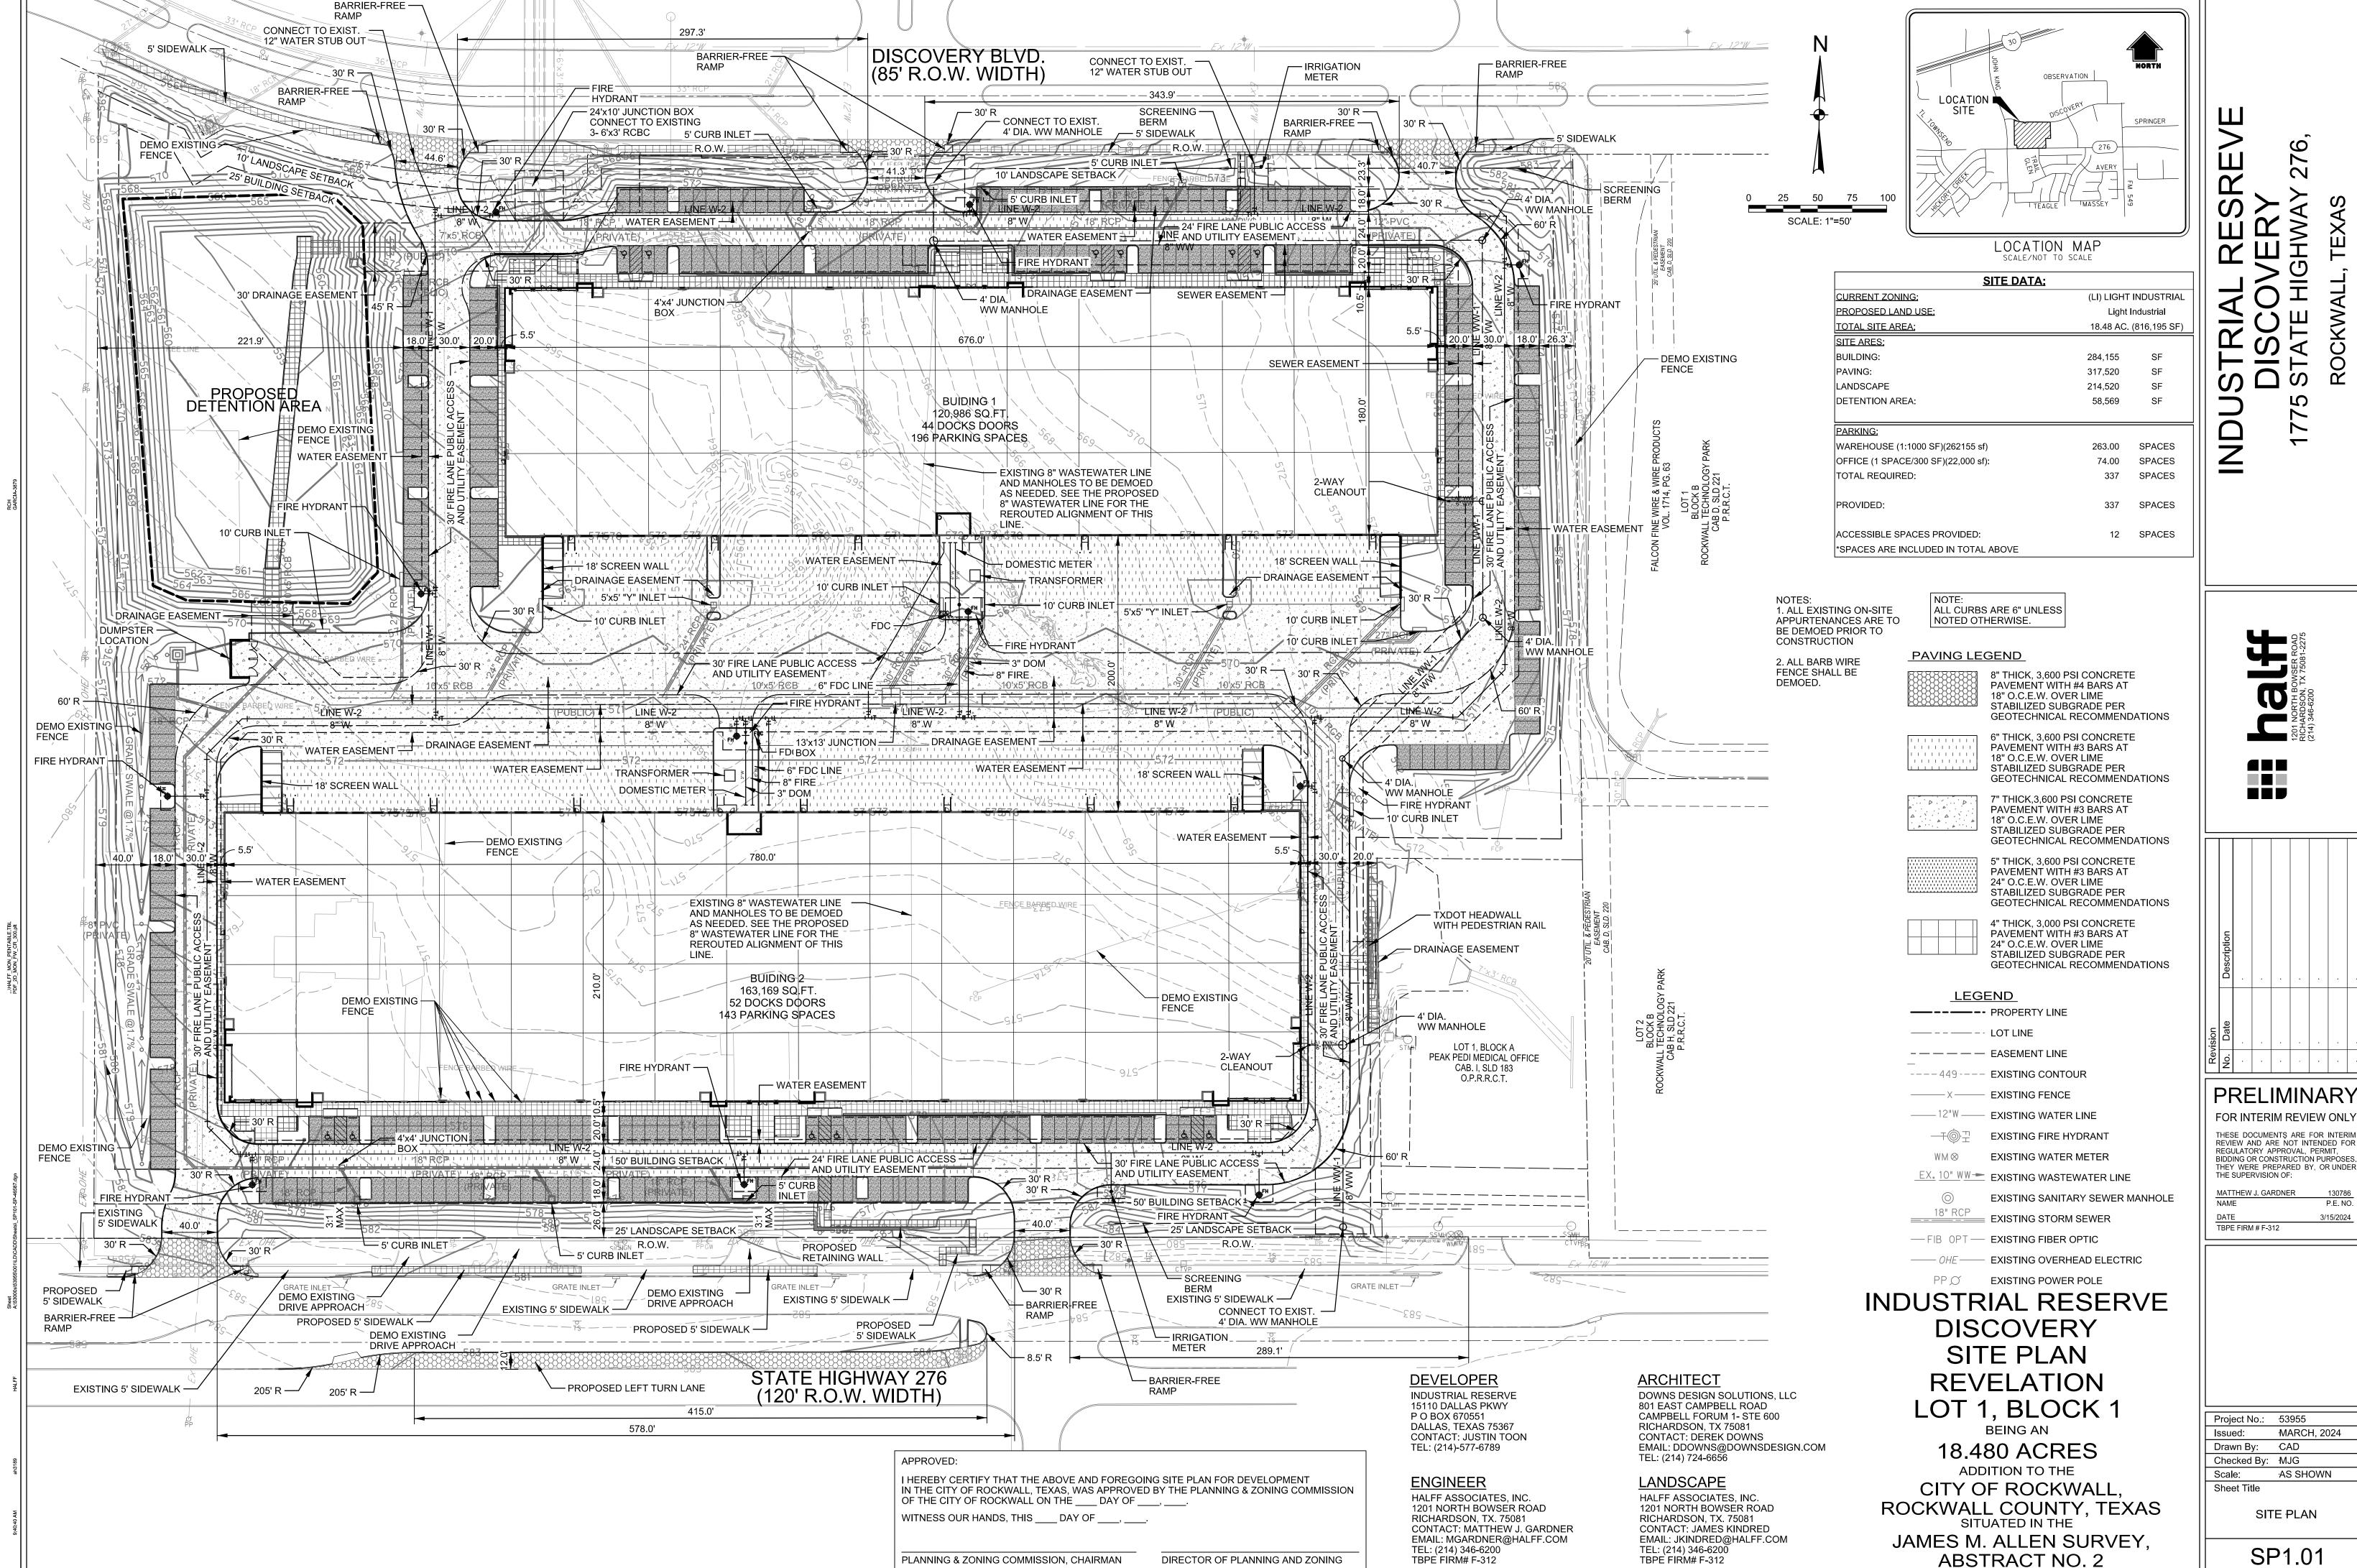

PRELIMINARY THESE DOCUMENTS ARE FOR INTERIM REVIEW AND ARE NOT INTENDED FOR BIDDING OR CONSTRUCTION PURPOSES.
THEY WERE PREPARED BY, OR UNDER
THE SUPERVISION OF:

Sheet Number CASE NUMBER: SPXXXX-XXX

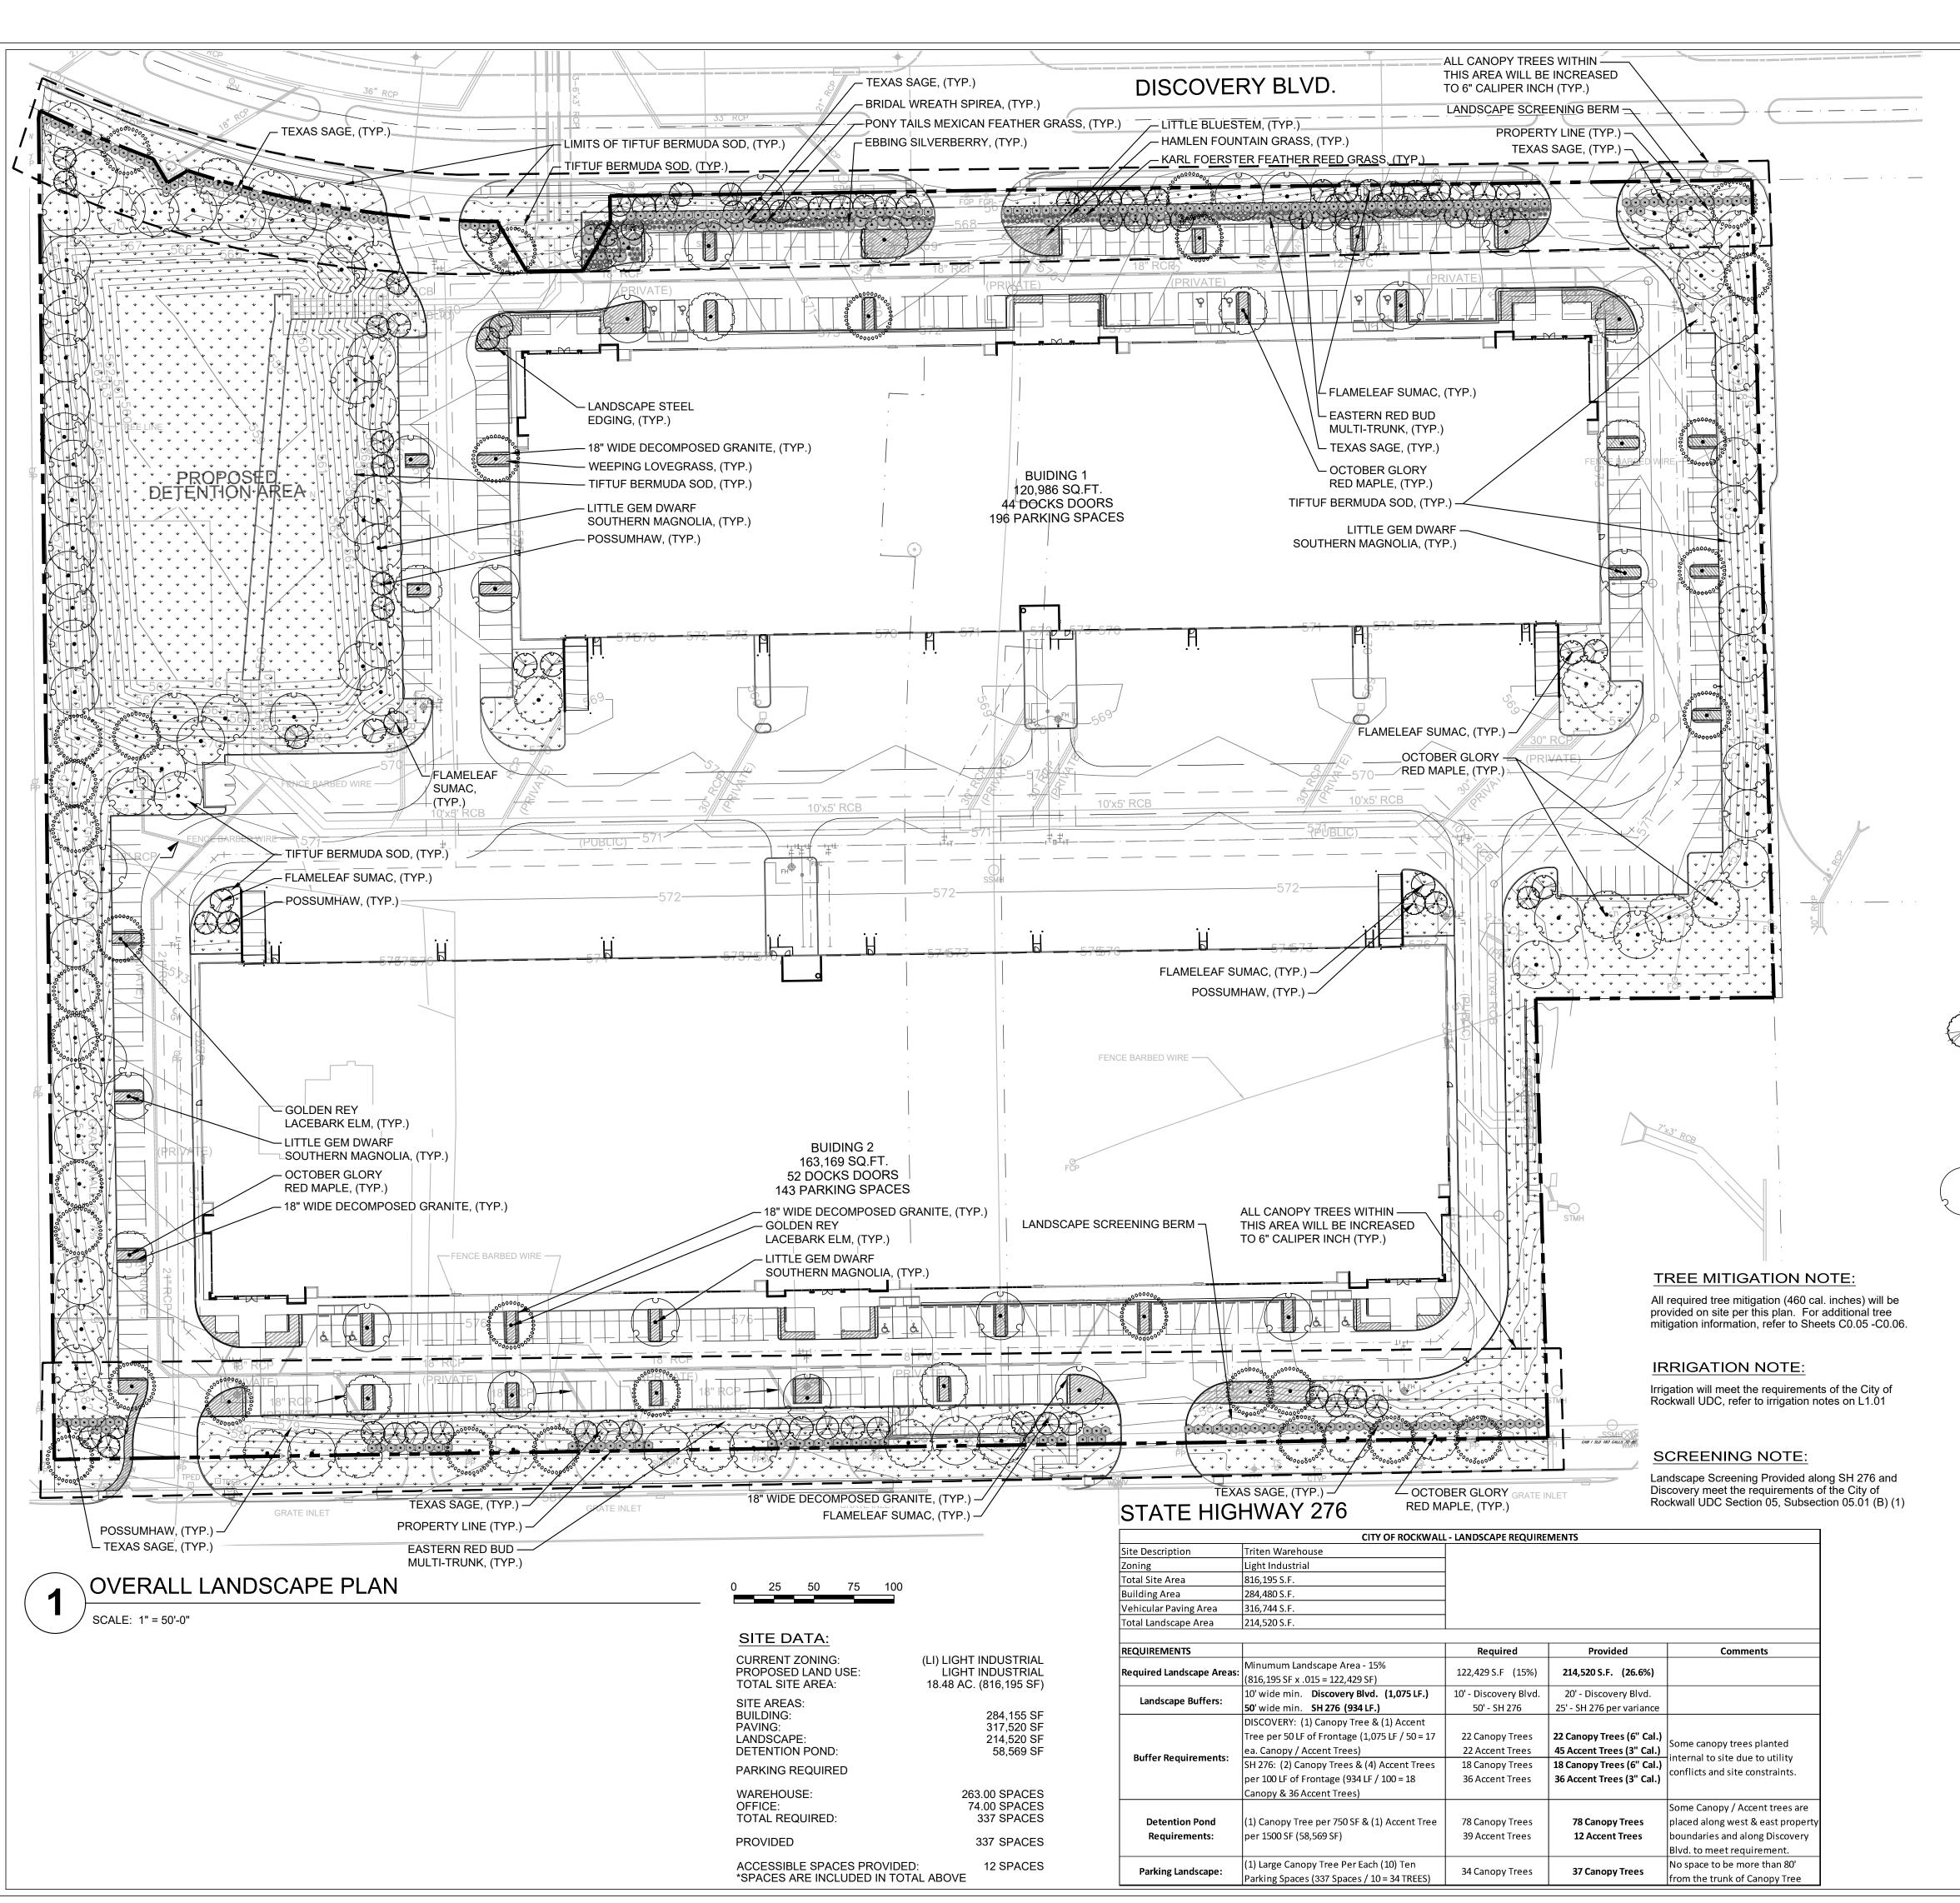

LANDSCAPE REQUIREMENTS for the City of Rockwall, TX

ARTICLE 08: LANDSCAPE AND FENCE STANDARDS

SECTION 05: LANDSCAPE STANDARDS

SUBSECTION 05.01: LANDSCAPE BUFFERS

The minimum requirements for landscape buffers shall be as follows:

(B) <u>Non-Residential Landscape Buffers.</u> (see Figure 3: Commercial Landscape Buffers Example)) Abutting a Public Right-of-Way. A minimum of a ten (10) foot wide landscape buffer shall be required along the entire length of any non-residential lot that abuts a public right-of-way (i.e. collector street, arterial roadway, or alleyway) or a residentially zoned or used property that is located directly across a public street (regardless of the size of the street). All landscapebuffers adjacent to a public right-of-way shall incorporate ground cover, a built-up berm and shrubbery along the entire length of the frontage. Berms and shrubbery shall have a total minimum height of 30-inches. In these areas a minimum of one (1) canopy tree and one (1) accent tree shall be incorporated into the landscape buffer per 50-linear feet of frontage along the adjacency. Clustering of trees shall be permitted as long as all required trees are situated within the landscape buffer.

SUBSECTION 05.02: LANDSCAPE SCREENING

- (A) <u>Loading Docks and Outside Storage Areas.</u> Off-street loading docks and outside storage areas shall bE screened from all public streets, open space, adjacent properties and any residential zoning districts or residentially used properties that abut or are directly across a public street or alley from the loading dock or outside storage area in accordance with the requirements of Subsection 01.05, Screening Standards, of Article 05, District Development Standards (Screening Wall with Canopy Trees every 20' o.c.).
- (C) <u>Headlight Screening.</u> Head-in parking adjacent to a street shall incorporate one (1) of the following screening methods to mitigate the potential hazard that headlights may pose for on-street vehicular traffic:
- (1) Alternative #1. A minimum of a two (2) foot berm with mature evergreen shrubs along the entire adjacency of the parking areas.
- (2) Alternative #2. A wrought iron fence with a mix of two (2) rows of staggered mature evergreen trees and one (1) row of deciduous canopy trees (a minimum six [6] caliper inches) along the entire length of the adjacency. All trees will be planted on 20-foot centers.

SUBSECTION 05.03: LANDSCAPE REQUIREMENTS

- (A) <u>Amount of Landscaping.</u> The following landscaping percentages shall be required and shall apply to the total site area to be developed: Light Industrial (LI) District - Required Landscaping 15%.
- (B) Location of Landscaping. A minimum of 100% of the total required landscaping shall be located in front of and along the side of buildings with street frontages in the Heavy Commercial (HC), Light Industrial (LI), and Heavy Industrial (HI) Districts.
- (E) Parking Lot Landscaping. The following landscape requirements will apply to parking lots:
- (1) Parking lots with more than two (2) rows of parking spaces (i.e. one [1] drive isle with rows of parking on either side) shall have a minimum for five (5) percent or 200 SF of landscaping -- whichever is greater -- in the interior of the parking lot area. Such landscaping shall be counted toward the total required landscaping.
- (2) If the parking and maneuvering space exceeds 20,000 SF, one (1) large canopy tree for every ten (10) parking spaces shall be required to be planted internal to the parking areas. (3) No tree shall be planted closer than five (5) feet to the edge of pavement or five (5) feet from any water or wastewater line that is less than 12-inches. Water and wastewater lines that are 12-inches and greater require trees to be planted a minimum of ten (10) feet from the centerline of the pipe. (4) No required parking spaces may be located more than 80-feet from the trunk of a canopy tree.
- (G) <u>Landscaping in Landscape Buffers and Public Right-of-Way.</u> All landscape buffers and public right-of-way located adjacent to a proposed development shall be improved with grass (i.e. sod -- hydro mulch shall be prohibited in these areas) prior to the issuance of a Certificate of Occupancy (CO). In addition, it shall be the responsibility of the developer to design the irrigation system within the lot to ensure that the grass placed in public right-of-way is watered and maintained, and to ensure that minimal water will be shed on to the street. The designer of the irrigation system shall base the systems design on the ultimate proposed width of the street. The plans for design of the irrigation system shall be approved by the Building Inspections Department prior to installation and acceptance of the project.

LEGEND

SHADE TREE

ORNAMENTAL TREES COMMON / BOTANICAL NAME

Eastern Redbud Multi-trunk / Cercis canadensis

Flameleaf Sumac / Rhus Laneolata

October Glory Red Maple / Acer rubrum 'October Glory'

COMMON / BOTANICAL NAME

Possumhaw / Ilex decidua

Little Gem Dwarf Southern Magnolia / Magnolia grandiflora 'Little Gem'

Golden Rey Lacebark Elm / Ulmus parvifolia 'Golden Rey'

<u>SHRUBS</u> COMMON / BOTANICAL NAME

Ebbing Silverberry / Elaeagnus x ebbingei

Texas Sage / Leucophyllum frutescens Bridal Wreath Spirea / Spiraea prunifolia 'Bridalwreath'

ORNAMENTAL GRASSES COMMON / BOTANICAL NAME

Karl Foerster Feather Reed Grass / Calamagrostis x acutiflora 'Karl Foerster'

Hameln Fountain Grass / Pennisetum alopecuroides 'Hameln'

Little Bluestem / Schizachyrium scoparium

Pony Tails Mexican Feather Grass / Stipa tenuissima 'Pony Tails'

GROUND COVERS

Tiftuf Bermuda Grass / Cynodon dactylon (L.) Pers. × Cynodon transvaalensis Burtt Davy

COMMON / BOTANICAL NAME

COMMON / BOTANICAL NAME

Weeping Lovegrass / Eragrostis curvula

MISCELLANEOUS

Decomposed Granite / -Native decompsed granite

Landscape Steel Edging

NORTH

LANDSCAPE PLAN

CASE NUMBER: SPXXXX-XXX

PRELIMINARY FOR INTERIM REVIEW ONLY THESE DOCUMENTS ARE FOR INTERIM REVIEW AND ARE NOT INTENDED FOR REGULATORY APPROVAL, PERMIT, BIDDING OR CONSTRUCTION PURPOSES. THEY WERE PREPARED BY OR UNDER THE SUPERVISION OF:

JAMES R. KINDRED R.L.A. NO.

03/15/2024

Project No.: 46587 MARCH, 2024 Issued: Drawn By: Checked By: JRK Scale: AS SHOWN Sheet Title

Sheet Number

- 1. INSTALL STEEL EDGING TO UTILIZE FULL SECTIONS UNLESS CONTROLLED OTHERWISE WITH PLAN SHEET DIMENSIONS.
- 2. CUT STEEL EDGING AT AN ANGLE TO ACHIEVE A FINISHED STEEL EDGE HEIGHT OF 1/2" BELOW THE TOP OF ADJACENT HARDSCAPE.
- 3. IF STAKING IS NOT AVAILABLE WITHIN 12" OF THE EDGING TERMINATION, INSTALL A SPLICING EDGING STAKE WITHIN 6" OF THE TERMINATING EDGE AS SHOWN WITH OPTION 'B'
- 4. WHERE POSSIBLE, EDGE TERMINATION SHALL BE INSTALLED AS SHOWN IN TERMINUS OPTION 'A'.

D = DIMENSION OF PLANT SPACING (SHRUB AND GROUNDCOVER AS INDICATED ON DRAWINGS) - IF SHRUB IS BALL AND BURLAP, THEN REMOVE BURLAP AND ROPE FROM TOP 1/3 OF ROOTBALL - AMENDED SOIL BACKFILL TO REMOVE ALL 3" LAYER OF - DECOMPOSED GRANITE 4" LAYER OF MULCH

OVER WEED BLOCK OVER WEED BLOCK PIT PLANTED UNDISTURBED SUBGRADE 4" STEEL EDGE - AS SHOWN BREAK THROUGH AND REMOVE ANY EXISTING IN LANDSCAPE PLAN -

1. SEE LANDSCAPE NOTES FOR THE TYPE OF WEED BLOCK AND MULCH MATERIAL TO USE. 2. OMIT WEED BLOCK WHEN PLANT SPACING IS 18" O.C. OR LESS

"HARDPAN" AS NECESSARY TO PROVIDE GOOD PERCOLATION AND POSITIVE DRAINAGE

N.T.S.

SHRUB PLANTING AND SPACING

(REF. LANDSCAPE PROJECT NOTES)

TREE PLANTING


*FOR ALL MAPLE TREE INSTALLATIONS:

MAXIMUM OF 24 MONTHS.

WRAP TRUNKS WITH A BURLAP TREE BARK WRAP


TO PREVENT SUN SCALD. WRAP IS TO REMAIN IN PLACE FOR A MINIMUM OF 12 MONTHS AND A

STEEL EDGE TERMINATION

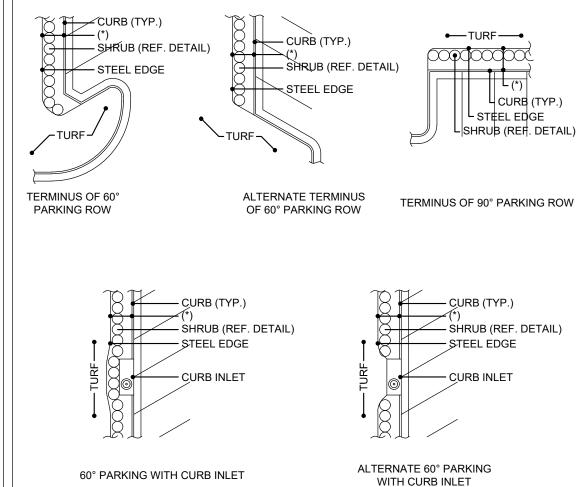


(*) SEE SHRUB PLANTING DETAIL FOR DIMENSIONS. REFERENCE PLANT MATERIAL LIST FOR PLANT TYPES AND LOCATIONS.


GENERAL STEEL EDGE ALIGNMENT EXAMPLES

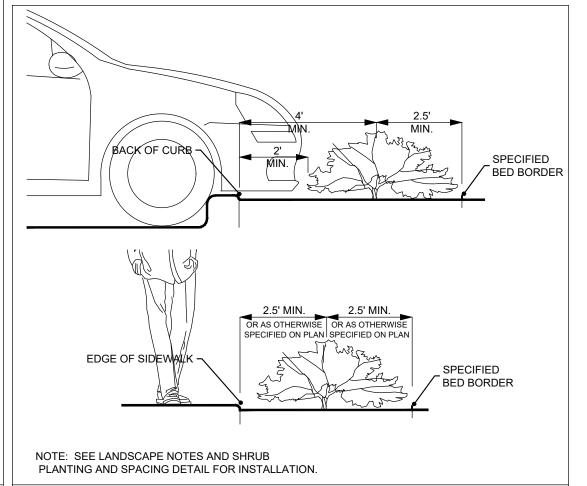

N.T.S.

SHRUB DISTANCE FROM EDGE OF BED

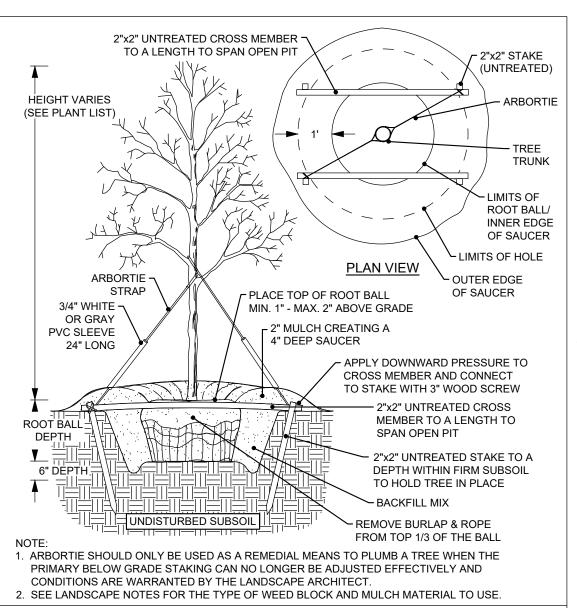

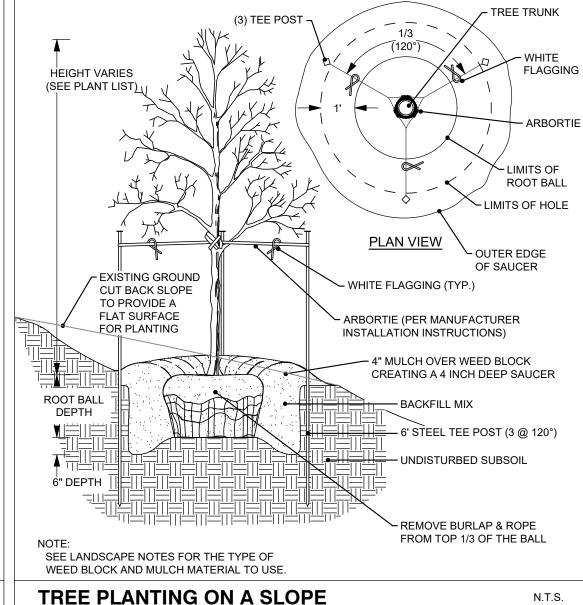

IRRIGATION NOTES SUBSECTION 05.04: IRRIGATION REQUIREMENTS (A) <u>General Irrigation Requirements.</u> The owner shall be responsible for the health and vitality of plant material through the irrigation of all landscaped areas, turf and plant materials, and shall: (1) Provide a moisture level in an amount and frequency adequate to sustain growth of the plant materials on a permanent basis. (2) Be in place and operational at the time of the landscape inspection for Certificate of Occupancy (CO). (3) Be maintained and kept operational at all times to provide for efficient water distribution. (1) <u>Landscaped Areas.</u> One (1) of the following irrigation methods shall be used to ensure adequate watering of plant material in landscaped areas: (a) <u>Conventional System.</u> An automatic or manual underground irrigation system that may be a onventional spray or bubbler type heads. (b) <u>Drip or Leaky-Pipe System.</u> An automatic or manual underground irrigation system in conjunction with a watersaving system such as a drip or a leaky pipe system. (c) <u>Temporary and Aboveground Watering</u>. Landscape areas utilizing xeriscape plants and installation techniques, including areas planted with native grasses and wildflowers, may use a temporary and above ground system, and shall be required to provide irrigation for the first two (2) growing seasons only. (2) <u>Natural and Undisturbed Areas.</u> No irrigation shall be required for undisturbed natural areas or (3) <u>Compliance with State Law.</u> All irrigation systems shall comply with the irrigation code of <u>Chapter 10</u>, Buildings and Building Regulations, Article XVI, Irrigation Code, of the City of Rockwall Code of Ordinances, and all applicable state laws, as may be amended.

ORNAMENTAL TREES	QTY	BOTANICAL / COMMON NAME	CONT	CAL	REMARKS
	28	Cercis canadensis / Eastern Redbud Multi-trunk	B&B/Cont.	3" Cal	8' HT Minimum, Full Canopy, Healthy, Good Form, Strong Central Leader.
	38	Rhus lanceolota / Flameleaf Sumac	B&B/Cont.	3" Cal	8' HT Minimum, Full Canopy, Healthy, Good Form, Strong Central Leader.
	27	Ilex decidua / Possumhaw	B&B/Cont.	3" Cal	8' HT Minimum, Full Canopy, Healthy, Good Form, Strong Central Leader.
SHADE TREE	QTY	BOTANICAL / COMMON NAME	CONT	CAL	REMARKS
	27	Acer rubrum 'October Glory' / October Glory Red Maple	B&B/Cont.	4" Cal 6" Cal in Buffer Zone	12' HT Minimum, Full Canopy, Healthy, Good Form, Strong Central Leader.
	90	Magnolia grandiflora 'Little Gem' / Little Gem Dwarf Southern Magnolia	B&B/Cont.	4" Cal 6" Cal in Buffer Zone	12' HT Minimum, Full Canopy, Healthy, Good Form, Strong Central Leader.
0000000000000000000000000000000000000	33	Ulmus parvifolia 'Golden Rey' / Golden Rey Lacebark Elm	B&B/Cont.	4" Cal 6" Cal in Buffer Zone	12' HT Minimum, Full Canopy, Healthy, Good Form, Strong Central Leader.
SHRUBS	QTY	BOTANICAL / COMMON NAME	CONT	SIZE	REMARKS
	24	Elaeagnus x ebbingei / Ebbing Silverberry	5 gal	4`-8` HT 6`-8` SPD	
	268	Leucophyllum frutescens / Texas Sage	5 gal	4`-8` HT 4`-6` SPD	
•	16	Spiraea prunifolia 'Bridalwreath' / Bridal Wreath Spirea	5 gal	4`-8` HT 6`-8` SPD	
ORNAMENTAL GRASSES	QTY	BOTANICAL / COMMON NAME	CONT	SIZE	REMARKS
mure market	48	Calamagrostis x acutiflora 'Karl Foerster' / Karl Foerster Feather Reed Grass	5 gal	2`-6` HT 36" O.C.	
*	81	Pennisetum alopecuroides 'Hameln' / Hameln Fountain Grass	5 gal	2`-3` 1`-3` Spd	
Hard Hard Hard Hard Hard Hard Hard Hard	77	Schizachyrium scoparium / Little Bluestem	5 gal	3`-4` 12"-18" Spd	
	38	Stipa tenuissima 'Pony Tails' / Pony Tails Mexican Feather Grass	5 gal	1`-2` Ht 36" O.C	
GROUND COVERS	QTY	BOTANICAL / COMMON NAME	CONT	SIZE	
· · · · · · · · · · · · · · · · · · ·	197,277 sf	Cynodon dactylon (L.) Pers. × Cynodon transvaalensis Burtt Davy / Tiftuf Bermuda Grass	Sod		
	9,930 sf	Eragrostis curvula / Weeping Lovegrass	3 gal		
MISCELLANEOUS	QTY	BOTANICAL / COMMON NAME	CONT	SIZE	
######################################	1,520 sf	-Native decompsed granite / Decomposed Granite	flat		
	2,442 LF	Landscape Steel Edging			

LANDSCAPE PROJECT NOTES

Refer to Sitework Specifications for all information needed for landscape work.

Notify Landscape Architect or designated representative of any layout discrepancies or any condition which may prohibit the installation as shown.

Verify and locate all utilities and site lighting conduits before landscape construction begins. Protection of all utilities is the responsibility of the Contractor.

All landscape planting areas illustrated shall be graded smooth with three inches (3") of topsoil and three inches (3") of compost applied and consistently blended (tilled) to a depth of nine inches (9"). If adequate or sufficient topsoil is not available on site, the Contractor shall provide topsoil per the specifications and approved by the Owner. To obtain final grade, excavation may be necessary to accept the required depth of opsoil/compost mix with surface dressing or mulch. All beds shall be crowned to anticipate settlement and ensure drainage without disrupting surrounding planned drainage paths. Any areas disturbed for any reason prior to final acceptance of the project shall be corrected by the Contractor at no additional expense to the Owner.

All landscaped areas will be irrigated with an underground automatic system.

Quantities shown on these plans are for reference only. Plant spacing is as indicated in the Plant Material List unless otherwise noted. The Contractor has full responsibility to provide coverage in all planting areas as specified.

All trees and shrubs shall be installed per planting details.

Trees shall be planted at least five feet (5') from any utility line or sidewalk, to the outside of utility easements with a clear ten feet (10') around fire hydrants and twenty feet (20') min. from all irrigation control zone meter boxes. Furthermore, planting within areas of turf shall give priority of location to irrigation. Trees, shall not be planted within five feet (5') of a spray head or ten feet (10') of a rotor. Remaining irrigation components shall respect the location of the illustrated landscape design. Shrubs, regardless of type, shall not be planted within thirty inches (30") of bed

All plant material shall be maintained in a healthy and growing condition, and must be replaced with similar variety and size if damaged or removed. Container grown plant material is preferred, however ball and burlap material may be substituted as indicated in the plant material list.

All planting beds as designated shall be bordered by Owner approved four inch (4") steel edging w/ $\frac{3}{16}$ " min. thickness unless bed is bordered by concrete. Steel edging adjacent to decomposed granite beds shall have a 1/4" min. thickness. Terminate edging flush with paved surface with no sharp corners exposed.

A four inch (4") dressing of Shredded hardwood mulch over a 4.1 oz, woven polypropylene, needle-punched fabric or equal weed barrier shall be used in all plant beds and around all trees and within all beds with plants spaced 18" o.c. or greater. Single trees or shrubs shall be mulched to the outside edge of the saucer or landscape island (See planting details).

Fertilize all plants at the time of planting with 10-10-10 time release fertilizer.

All areas of decomposed granite shall be over a 4.1 oz, woven polypropylene, needle-punched fabric or equal weed barrier of locally available material, installed to a compacted depth of three inches (3") to be flush with the top of curb, paved surface, and/or the top of steel edge.

TURF PROJECT NOTES

EROSION CONTROL:

Γhroughout the project and the maintenance period for turfgrass, it is the Contractor's responsibility to maintain the topsoil in place at specified grades. Topsoil and turfgrass losses due to erosion or any construction disturbance will be replaced by the Contractor until ESTABLISHMENT and ACCEPTANCE is

SOIL PREPARATION

All slopes and areas disturbed by construction, except those occupied by buildings, structures, or paving shall be graded smooth and four (4") inches of topsoil applied. If adequate topsoil is not available onsite, the Contractor shall provide topsoil as approved by the Owner. The area shall be dressed to typical sections and plowed to a depth of five (5") inches. Soil shall be further prepared by the removal of debris, weeds and stones larger than 3/4 inch in diameter. After tillage and cleaning, all areas to receive turf shall be leveled, fine graded, and drug with a weighted spike harrow or float drag. The top two (2") inches shall be pulverized to provide a uniform bed for seeding or sod as described below.

At a minimum, three feet (3') of solid sod shall be installed along all impervious edges. This includes, but is not limited to: curbing, sidewalks, building foundation, storm water inlets, manholes, and planting bed perimeter treatments. Additional areas of sod installation will be as indicated on the design plans. All areas from back of curb within the roadway ROWs and 10' Landscape Buffer shall be sod. Should installation occur between November and March, sod shall include an over-seed of Annual Rye for a grown-in appearance.

SPRING AND SUMMER PERMANENT GRASSING (May 15 through September 15): Hydromulch seed with hulled Common Bermuda at a rate of 4 lbs/1000 sf. Seeding shall be accomplished immediately after bed preparation. Hydroseed mixture shall contain cellulose mulch applied at a rate of 2000 lbs/acre, with a maximum of 50 lbs/100 gallons of water. If seeding is delayed after mixing 0.5 - 2 hours, add 50% seed mix. If delay is longer than 2 hours, begin with new mixture.

FALL AND WINTER TEMPORARY GRASSING (September 15 through May 15): Seed with annual rye at a rate of 10 lbs/1000 sf. After May 15, Contractor shall remove rye to effectively establish permanent seeding.

IRRIGATION:
In the absence of an irrigation system or areas beyond the coverage limits of a permanent irrigation system, Contractor shall water sod/seed temporarily to develop adequate growth and establishment before regular maintenance begins. Turf shall be watered until firmly established.

Water shall be furnished by the Contractor with means and methods available to achieve acceptable turf. The water source shall be clean and free of industrial wastes or other substances harmful to the growth of the turf.

MAINTENANCE REQUIREMENTS:

Vegetation should be inspected regularly to ensure that plant material is established properly and remains healthy. Mowing, trimming and supervision of water applications shall be the responsibility of the Contractor until the Owner or Owner's Representative accepts and assumes regular maintenance.

ESTABLISHMENT AND ACCEPTANCE:

All disturbed areas being seeded shall receive topsoil as specified and be adequately established with turf such that any absence of water will not kill the turf, but promote a state of turf dormancy, until the next rainfall event.

Regardless of unseasonable climatic conditions or other adverse conditions affecting planting operations and the growth of the turf grass, it shall be the sole responsibility of the Contractor to establish a uniform stand of grass. UNIFORM STAND OF GRASS is defined as minimum 80% coverage per square foot (no bare areas).

Contractor to make a written request for inspection to Owner or Owner's representative a minimum of 5 days prior to the anticipated inspection date.



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WERE PREPARED BY OR UNDER THE

SUPERVISION OF: JAMES R. KINDRED 2255 R.L.A. NO.

03/15/2024


Project No.: 46587 MARCH, 2024 СP

Issued: Drawn By: Checked By: JRK Scale: AS SHOWN

Sheet Title LANDSCAPE NOTES AND DETAILS

Sheet Number

CASE NUMBER: SPXXXX-XXX

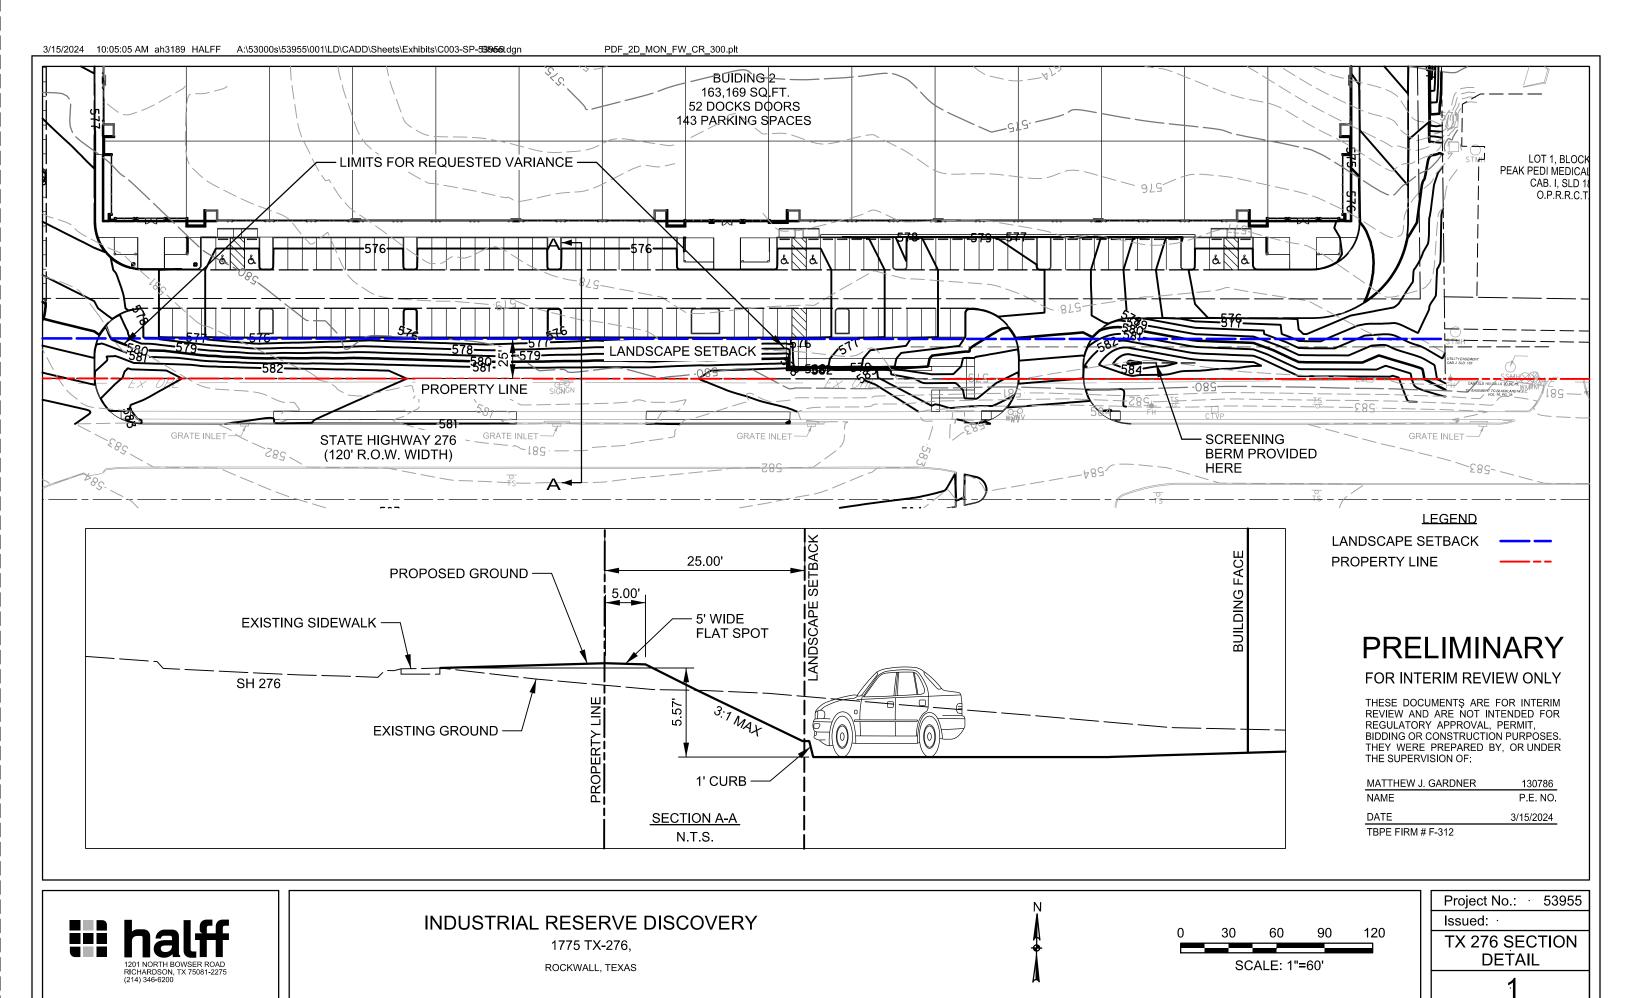



March 15, 2024 AVO 53955

City of Rockwall Planning and Zoning 385 S Goliad St Rockwall, TX 75087

RE: VARIANCE REQUEST: Industrial Reserve Discovery Rockwall

Rockwall, TX

Dear reviewer.

Industrial Reserve would like to request a variance to the minimum ground cover requirements within landscape buffers adjacent to Primary Roadways and specific to the SH-276 Overlay District, as detailed in Subsection 06.02 (E) of the City of Rockwall Unified Development Code. The Unified Development Code requires a built-up berm and shrubbery, or combination thereof, along the length of the frontage where the berm is 30 - 48 inches in height as measured from the primary roadway elevation. Based on our interpretation of the code requirements we believe that the intent and purpose of the required ground cover screening can be met with an alternative landscaping layout that still provides the required shrubbery and trees but eliminates the built-up berm. Below are key points to the proposed site conditions and proposed justification to providing the variance as requested.

Proposed Site Conditions:

- 1) Please refer to the included amended "Site Plan".
- 2) The car parking for this proposed site development is several feet lower in elevation when compared to the existing primary roadway (SH-276). The parking is on average about 5.5 ft lower that SH-276. Due to this height difference, providing a minimum 30-inch-tall berm along the frontage road creates the need to add over 400 ft of retaining wall that averages 7 ft in height. The additional height difference created by the berm and limited space to make up the grades is what drives the need for the wall.
- The reason the car parking sits several feet lower than SH-276 is due to grading requirements of the intended site layout and the intent to provide a balanced site for dirt import/export.

Proposed Variance

- 1) Please refer to the included attachment labeled "TX 276 SECTION DETAIL".
- 2) The proposed variance to the code requirement is to eliminate the built-up berm. The shrubbery and trees would still be provided as required. It is our interpretation of the code that the landscape berm provides ground cover for both screening and aesthetic purposes. The requirement as detailed within the code has a more practical application to sites that are at or above the adjacent roadway elevation. This site sits several feet below and per this site's conditions, we believe the intent of the requirement can be met without the berm.
- 3) Any vehicles navigating within this site's car parking and facing towards SH-276 would have their headlights screened with the over 5 ft elevation difference between the car parking and the public roadway. This elevation difference is already greater than the 30-inch berm height denoted in the code requirement and thus already provides more screening than is needed. The addition of the 30" berm does not increase the functionality for the screening intent as over 30" of screening are already being provided.

If you have any questions or need any additional information, please call me at your convenience 214-217-6622.

Sincerely,

HALFF

Jose Garcia, PE

facl Loris fo

Halff Phone: 214.346.6200 Fax: 214.739.0095



NOTARY PUBLIC IN AND FOR THE STATE OF TEXAS

DEVELOPMENT APPLICATION

City of Rockwall Planning and Zoning Department 385 S. Goliad Street Rockwall, Texas 75087

TAFF (USE OI	NLY -
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PLANNING & ZONING CASE NO.


<u>NOTE:</u> THE APPLICATION IS NOT CONSIDERED ACCEPTED BY THE CITY UNTIL THE PLANNING DIRECTOR AND CITY ENGINEER HAVE SIGNED BELOW.

DIRECTOR OF PLANNING:

CITY ENGINEER:

PLEASE CHECK THE	APPROPRIATE BOX BELOW TO INDICATE THE TYPE	OF DEVELOPMENT RE	QUEST [SELECT ONLY ONE BOX]:
☐ PRELIMINARY ☐ FINAL PLAT (\$ ☐ REPLAT (\$300 ☐ AMENDING OF ☐ PLAT REINSTA SITE PLAN APPL ☐ SITE PLAN (\$2	(\$100.00 + \$15.00 ACRE) 1 PLAT (\$200.00 + \$15.00 ACRE) 1 300.00 + \$20.00 ACRE) 1 .00 + \$20.00 ACRE) 1 R MINOR PLAT (\$150.00) ATEMENT REQUEST (\$100.00)	☐ SPECIFIC US ☐ PD DEVELO OTHER APPLIC ☐ TREE REMO ☐ VARIANCE F NOTES: ¹: IN DETERMINING T PER ACRE AMOUNT. ²: A \$1,000.00 FEE ¹	ANGE (\$200.00 + \$15.00 ACRE) 1 SE PERMIT (\$200.00 + \$15.00 ACRE) 1 8 2 PMENT PLANS (\$200.00 + \$15.00 ACRE) 1 CATION FEES:
DDODEDTY INC	ORMATION [PLEASE PRINT]		
ADDRES		all TX 75032	
SUBDIVISIO		an, 17 70002	LOT 1 PLOOF 1
			LOT 1 BLOCK 1
GENERAL LOCATIO	Tract East of John King Blvd. bet	ween Discovery	Blvd. & State Highway 276
ZONING, SITE P	LAN AND PLATTING INFORMATION [PLEA	SE PRINT]	
CURRENT ZONIN	G Light Industrial	CURRENT USE	Light Industrial
PROPOSED ZONIN	G Light Industrial	PROPOSED USE	Light Industrial
ACREAG	E 18.48 LOTS [CURREN	T] 1	LOTS [PROPOSED] 1
REGARD TO ITS RESULT IN THE	D PLATS: BY CHECKING THIS BOX YOU ACKNOWLEDGE APPROVAL PROCESS, AND FAILURE TO ADDRESS ANY OF DENIAL OF YOUR CASE. CANT/AGENT INFORMATION [PLEASE PRINT/C	STAFF'S COMMENTS BY	GAGE OF <u>HB3167</u> THE CITY NO LONGER HAS FLEXIBILITY WIT. THE DATE PROVIDED ON THE DEVELOPMENT CALENDAR WIL
	Reserve Capital - Rockwall Industrial SPE LLC		Industrial Reserve
CONTACT PERSON		CONTACT PERSON	Justin Toon
ADDRESS	15110 Dallas Pkwy	ADDRESS	15110 Dallas Pkwy
	P O Box 670551		P O Box 670551
CITY, STATE & ZIP	Dallas, TX 75367	CITY, STATE & ZIP	Dallas, TX 75367
PHONE	214-577-6789	PHONE	214-577-6789
E-MAIL	justin@industrialreserve.net	E-MAIL	justin@industrialreserve.net
BEFORE ME, THE UNDE	CATION [REQUIRED] RSIGNED AUTHORITY, ON THIS DAY PERSONALLY APPEARE ION ON THIS APPLICATION TO BE TRUE AND CERTIFIED TH		[OWNER] THE UNDERSIGNED, WHO
NFORMATION CONTAINS	, TO COVER THE COST OF THIS APPLICATION, H. 20 24 . BY SIGNING THIS APPLICATION. I AGR	AS BEEN PAID TO THE CITY REE THAT THE CITY OF RO S ALSO AUTHORIZED ANL	TED HEREIN IS TRUE AND CORRECT: AND THE APPLICATION FEE OF OF ROCKWALL ON THIS THE 11 35 115 DAY OF OCKWALL (I.E. "CITY") IS AUTHORIZED AND PERMITTED TO PROVID O PERMITTED TO REPRODUCE ANY COPYRIGHTED INFORMATION TO A REQUEST TO A PROPERTY OF TO A REQUEST.
GIVEN UNDER MY HANL	O AND SEAL OF OFFICE ON THIS THE I LITTLE DAY OF M.	arch 2021	JACKSON FREDERICK Notary ID #134687908 My Commission Expires December 20, 2027

MY COMMISSION EXPIRES

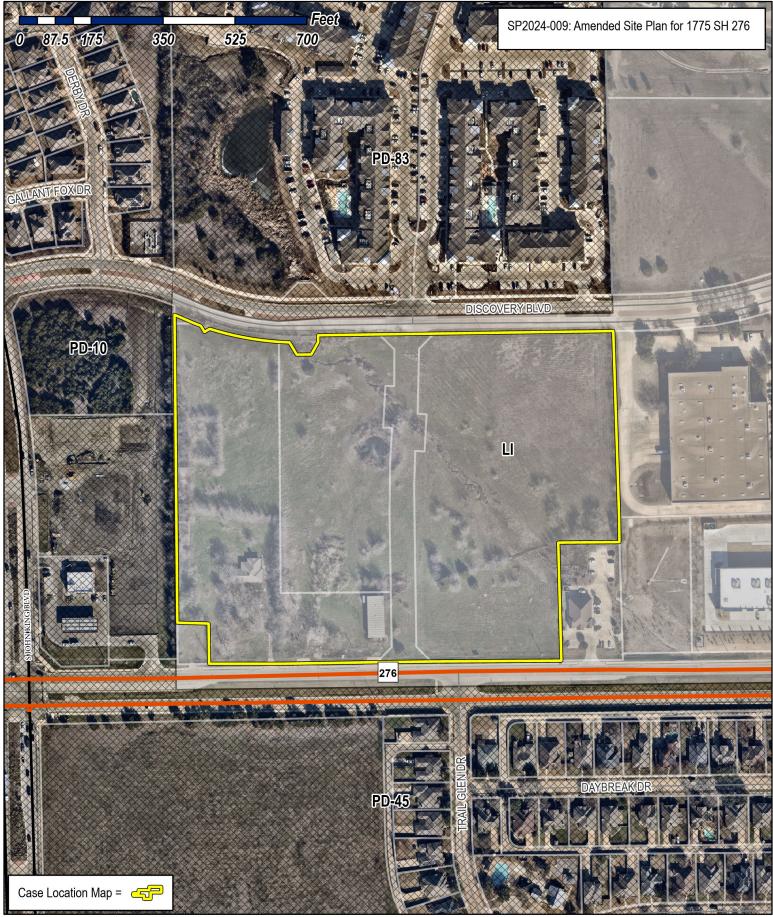




City of Rockwall Planning & Zoning Department 385 S. Goliad Street Rockwall, Texas 75087 (P): (972) 774 7745

(P): (972) 771-7745 (W): www.rockwall.com


The City of Rockwall GIS maps are continually under development and therefore subject to change without notice. While we endeavor to provide timely and accurate information, we make no guarantees. The City of Rockwall makes no warranty, express or implied, including warranties of merchantability and fitness for a particular purpose. Use of the information is the sole responsibility of the user.



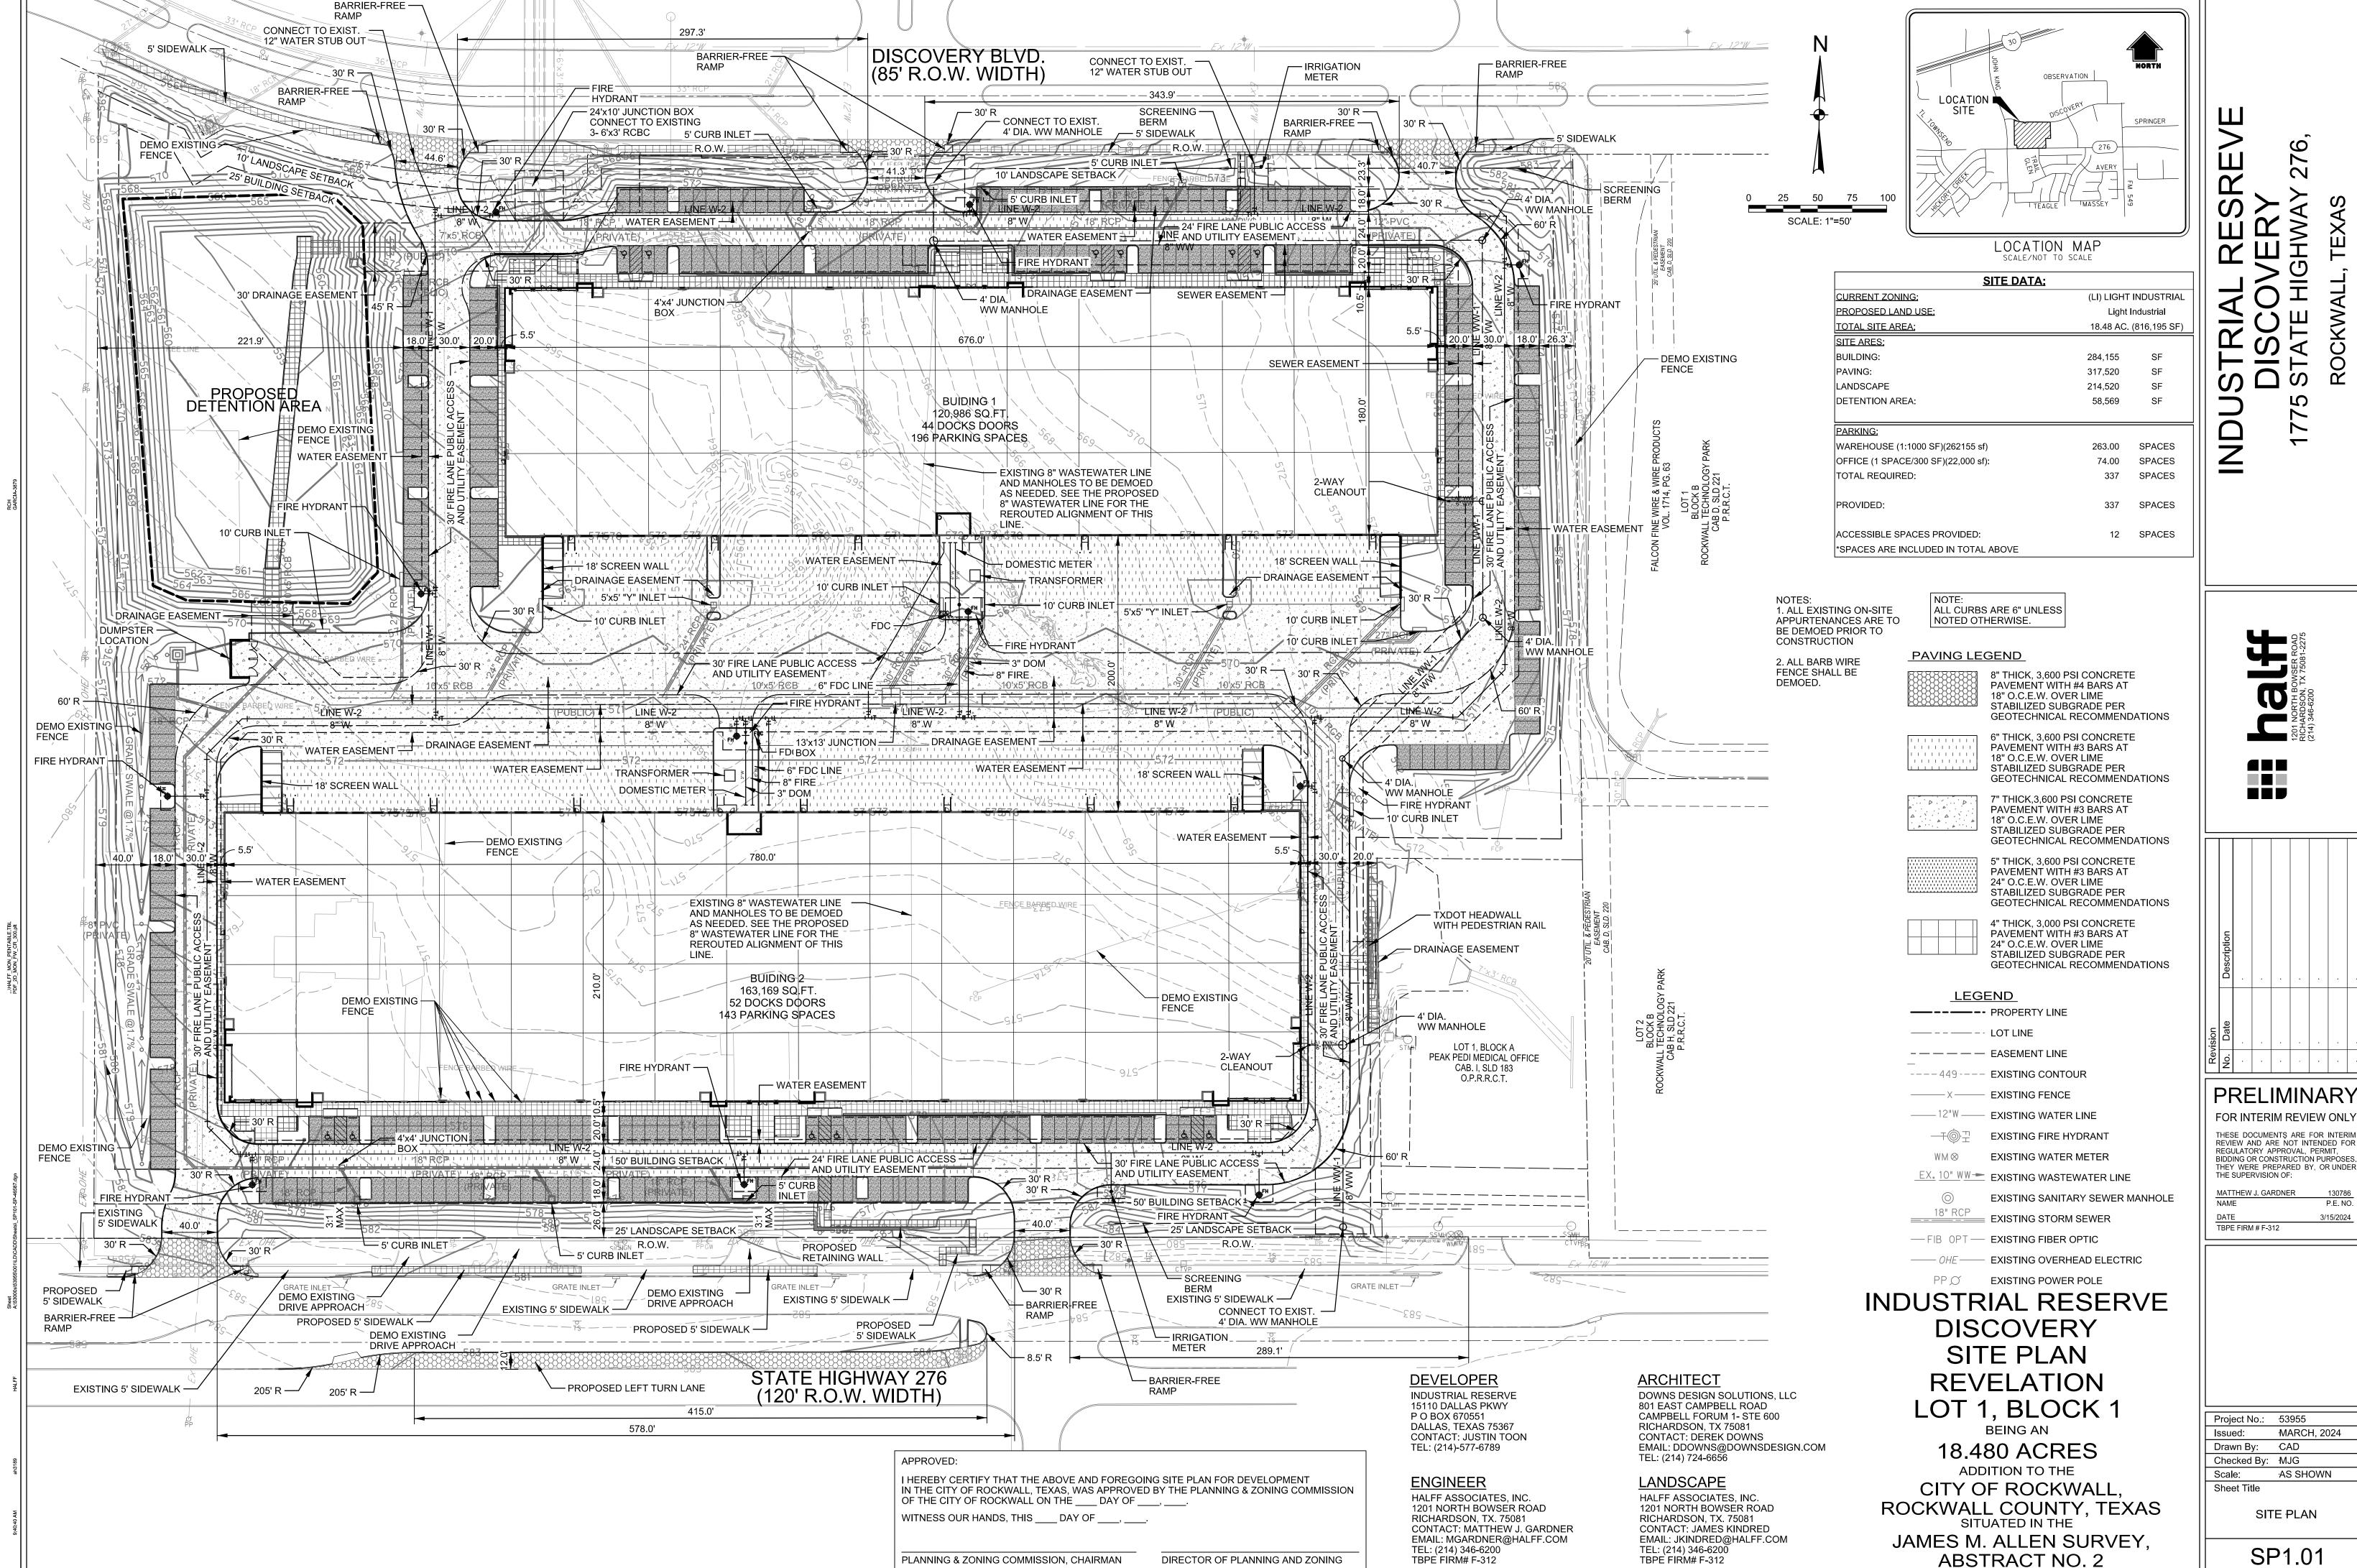

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THEY WERE PREPARED BY, OR UNDER
THE SUPERVISION OF:

Sheet Number CASE NUMBER: SPXXXX-XXX

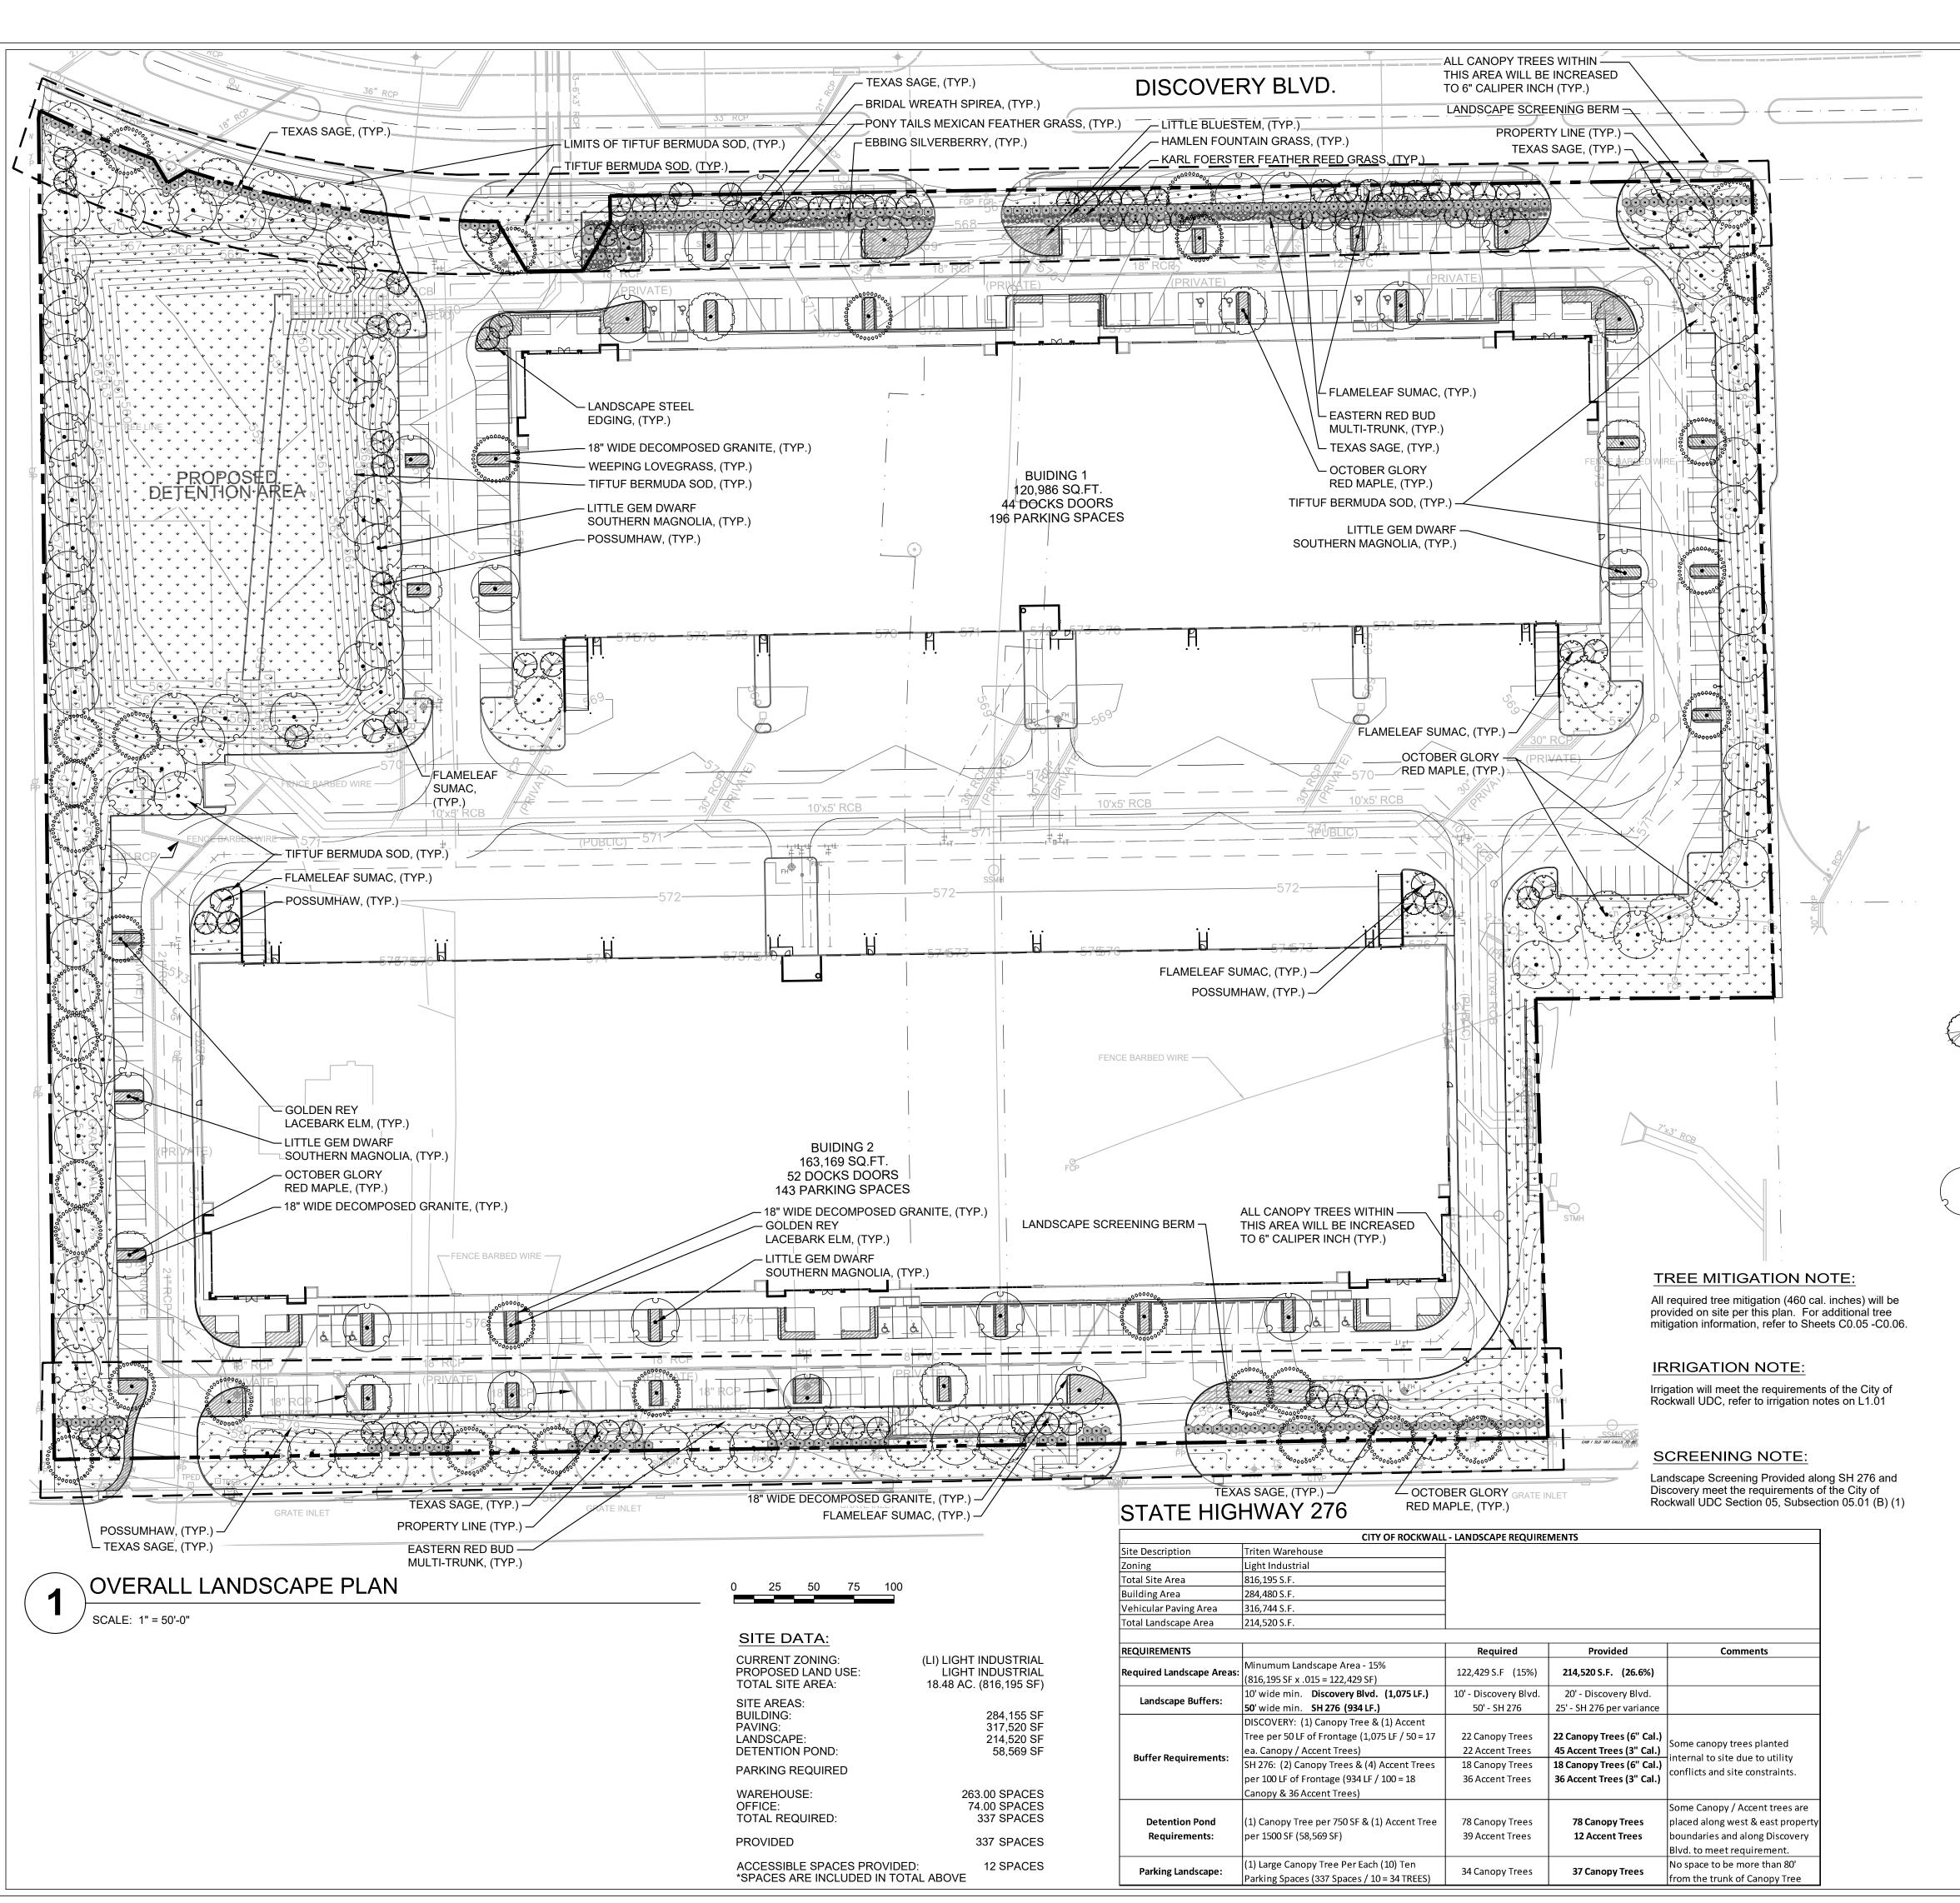

LANDSCAPE REQUIREMENTS for the City of Rockwall, TX

ARTICLE 08: LANDSCAPE AND FENCE STANDARDS

SECTION 05: LANDSCAPE STANDARDS

SUBSECTION 05.01: LANDSCAPE BUFFERS

The minimum requirements for landscape buffers shall be as follows:

(B) <u>Non-Residential Landscape Buffers.</u> (see Figure 3: Commercial Landscape Buffers Example)) Abutting a Public Right-of-Way. A minimum of a ten (10) foot wide landscape buffer shall be required along the entire length of any non-residential lot that abuts a public right-of-way (i.e. collector street, arterial roadway, or alleyway) or a residentially zoned or used property that is located directly across a public street (regardless of the size of the street). All landscapebuffers adjacent to a public right-of-way shall incorporate ground cover, a built-up berm and shrubbery along the entire length of the frontage. Berms and shrubbery shall have a total minimum height of 30-inches. In these areas a minimum of one (1) canopy tree and one (1) accent tree shall be incorporated into the landscape buffer per 50-linear feet of frontage along the adjacency. Clustering of trees shall be permitted as long as all required trees are situated within the landscape buffer.

SUBSECTION 05.02: LANDSCAPE SCREENING

- (A) <u>Loading Docks and Outside Storage Areas.</u> Off-street loading docks and outside storage areas shall bE screened from all public streets, open space, adjacent properties and any residential zoning districts or residentially used properties that abut or are directly across a public street or alley from the loading dock or outside storage area in accordance with the requirements of Subsection 01.05, Screening Standards, of Article 05, District Development Standards (Screening Wall with Canopy Trees every 20' o.c.).
- (C) <u>Headlight Screening.</u> Head-in parking adjacent to a street shall incorporate one (1) of the following screening methods to mitigate the potential hazard that headlights may pose for on-street vehicular traffic:
- (1) Alternative #1. A minimum of a two (2) foot berm with mature evergreen shrubs along the entire adjacency of the parking areas.
- (2) Alternative #2. A wrought iron fence with a mix of two (2) rows of staggered mature evergreen trees and one (1) row of deciduous canopy trees (a minimum six [6] caliper inches) along the entire length of the adjacency. All trees will be planted on 20-foot centers.

SUBSECTION 05.03: LANDSCAPE REQUIREMENTS

- (A) <u>Amount of Landscaping.</u> The following landscaping percentages shall be required and shall apply to the total site area to be developed: Light Industrial (LI) District - Required Landscaping 15%.
- (B) Location of Landscaping. A minimum of 100% of the total required landscaping shall be located in front of and along the side of buildings with street frontages in the Heavy Commercial (HC), Light Industrial (LI), and Heavy Industrial (HI) Districts.
- (E) Parking Lot Landscaping. The following landscape requirements will apply to parking lots:
- (1) Parking lots with more than two (2) rows of parking spaces (i.e. one [1] drive isle with rows of parking on either side) shall have a minimum for five (5) percent or 200 SF of landscaping -- whichever is greater -- in the interior of the parking lot area. Such landscaping shall be counted toward the total required landscaping.
- (2) If the parking and maneuvering space exceeds 20,000 SF, one (1) large canopy tree for every ten (10) parking spaces shall be required to be planted internal to the parking areas. (3) No tree shall be planted closer than five (5) feet to the edge of pavement or five (5) feet from any water or wastewater line that is less than 12-inches. Water and wastewater lines that are 12-inches and greater require trees to be planted a minimum of ten (10) feet from the centerline of the pipe. (4) No required parking spaces may be located more than 80-feet from the trunk of a canopy tree.
- (G) <u>Landscaping in Landscape Buffers and Public Right-of-Way.</u> All landscape buffers and public right-of-way located adjacent to a proposed development shall be improved with grass (i.e. sod -- hydro mulch shall be prohibited in these areas) prior to the issuance of a Certificate of Occupancy (CO). In addition, it shall be the responsibility of the developer to design the irrigation system within the lot to ensure that the grass placed in public right-of-way is watered and maintained, and to ensure that minimal water will be shed on to the street. The designer of the irrigation system shall base the systems design on the ultimate proposed width of the street. The plans for design of the irrigation system shall be approved by the Building Inspections Department prior to installation and acceptance of the project.

LEGEND

SHADE TREE

ORNAMENTAL TREES COMMON / BOTANICAL NAME

Eastern Redbud Multi-trunk / Cercis canadensis

Flameleaf Sumac / Rhus Laneolata

October Glory Red Maple / Acer rubrum 'October Glory'

COMMON / BOTANICAL NAME

Possumhaw / Ilex decidua

Little Gem Dwarf Southern Magnolia / Magnolia grandiflora 'Little Gem'

Golden Rey Lacebark Elm / Ulmus parvifolia 'Golden Rey'

<u>SHRUBS</u> COMMON / BOTANICAL NAME

Ebbing Silverberry / Elaeagnus x ebbingei

Texas Sage / Leucophyllum frutescens Bridal Wreath Spirea / Spiraea prunifolia 'Bridalwreath'

ORNAMENTAL GRASSES COMMON / BOTANICAL NAME

Karl Foerster Feather Reed Grass / Calamagrostis x acutiflora 'Karl Foerster'

Hameln Fountain Grass / Pennisetum alopecuroides 'Hameln'

Little Bluestem / Schizachyrium scoparium

Pony Tails Mexican Feather Grass / Stipa tenuissima 'Pony Tails'

GROUND COVERS

Tiftuf Bermuda Grass / Cynodon dactylon (L.) Pers. × Cynodon transvaalensis Burtt Davy

COMMON / BOTANICAL NAME

COMMON / BOTANICAL NAME

Weeping Lovegrass / Eragrostis curvula

MISCELLANEOUS

Decomposed Granite / -Native decompsed granite

Landscape Steel Edging

NORTH

LANDSCAPE PLAN

CASE NUMBER: SPXXXX-XXX

PRELIMINARY FOR INTERIM REVIEW ONLY THESE DOCUMENTS ARE FOR INTERIM REVIEW AND ARE NOT INTENDED FOR REGULATORY APPROVAL, PERMIT, BIDDING OR CONSTRUCTION PURPOSES. THEY WERE PREPARED BY OR UNDER THE SUPERVISION OF:

JAMES R. KINDRED R.L.A. NO.

03/15/2024

Project No.: 46587 MARCH, 2024 Issued: Drawn By: Checked By: JRK Scale: AS SHOWN Sheet Title

Sheet Number

- 1. INSTALL STEEL EDGING TO UTILIZE FULL SECTIONS UNLESS CONTROLLED OTHERWISE WITH PLAN SHEET DIMENSIONS.
- 2. CUT STEEL EDGING AT AN ANGLE TO ACHIEVE A FINISHED STEEL EDGE HEIGHT OF 1/2" BELOW THE TOP OF ADJACENT HARDSCAPE.
- 3. IF STAKING IS NOT AVAILABLE WITHIN 12" OF THE EDGING TERMINATION, INSTALL A SPLICING EDGING STAKE WITHIN 6" OF THE TERMINATING EDGE AS SHOWN WITH OPTION 'B'
- 4. WHERE POSSIBLE, EDGE TERMINATION SHALL BE INSTALLED AS SHOWN IN TERMINUS OPTION 'A'.

D = DIMENSION OF PLANT SPACING (SHRUB AND GROUNDCOVER AS INDICATED ON DRAWINGS) - IF SHRUB IS BALL AND BURLAP, THEN REMOVE BURLAP AND ROPE FROM TOP 1/3 OF ROOTBALL - AMENDED SOIL BACKFILL TO REMOVE ALL 3" LAYER OF - DECOMPOSED GRANITE 4" LAYER OF MULCH

OVER WEED BLOCK OVER WEED BLOCK PIT PLANTED UNDISTURBED SUBGRADE 4" STEEL EDGE - AS SHOWN BREAK THROUGH AND REMOVE ANY EXISTING IN LANDSCAPE PLAN -

1. SEE LANDSCAPE NOTES FOR THE TYPE OF WEED BLOCK AND MULCH MATERIAL TO USE. 2. OMIT WEED BLOCK WHEN PLANT SPACING IS 18" O.C. OR LESS

"HARDPAN" AS NECESSARY TO PROVIDE GOOD PERCOLATION AND POSITIVE DRAINAGE

N.T.S.

SHRUB PLANTING AND SPACING

(REF. LANDSCAPE PROJECT NOTES)

TREE PLANTING


*FOR ALL MAPLE TREE INSTALLATIONS:

MAXIMUM OF 24 MONTHS.

WRAP TRUNKS WITH A BURLAP TREE BARK WRAP


TO PREVENT SUN SCALD. WRAP IS TO REMAIN IN PLACE FOR A MINIMUM OF 12 MONTHS AND A

STEEL EDGE TERMINATION

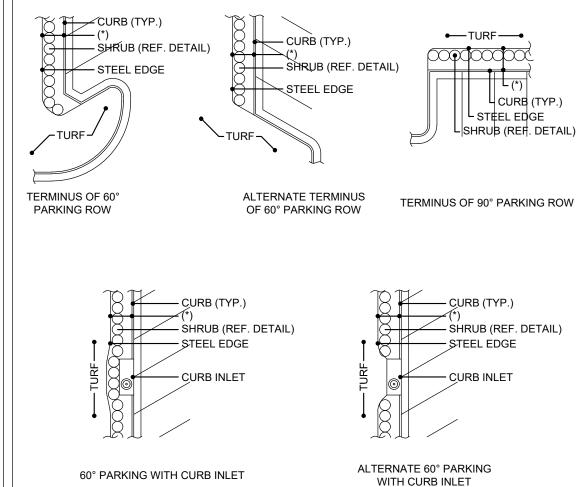


(*) SEE SHRUB PLANTING DETAIL FOR DIMENSIONS. REFERENCE PLANT MATERIAL LIST FOR PLANT TYPES AND LOCATIONS.


GENERAL STEEL EDGE ALIGNMENT EXAMPLES

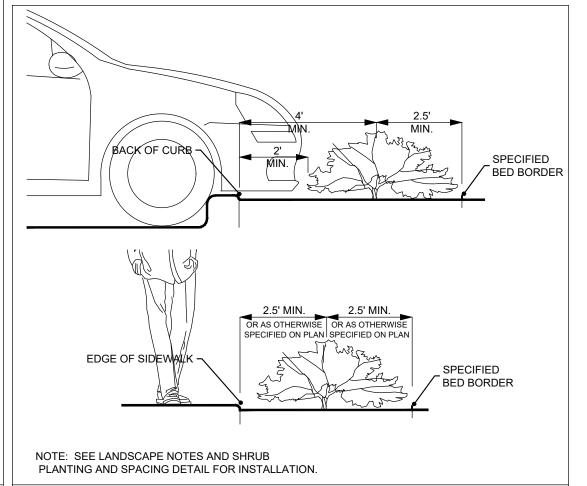

N.T.S.

SHRUB DISTANCE FROM EDGE OF BED

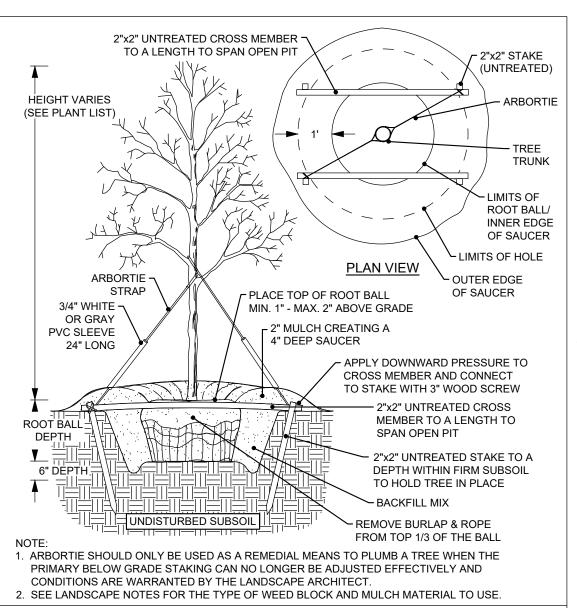

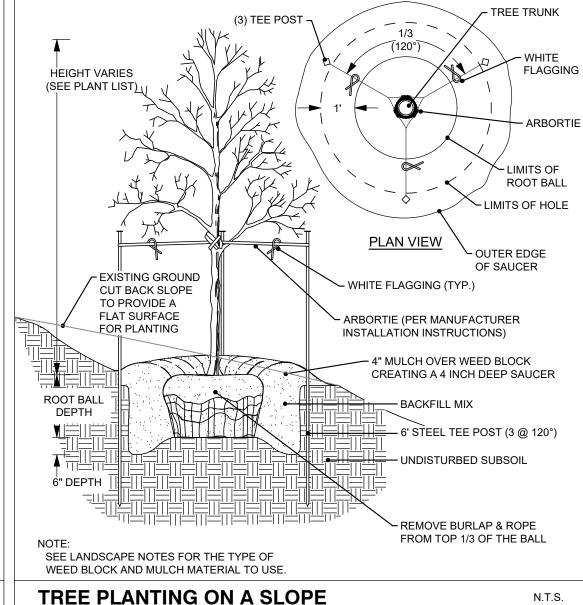

IRRIGATION NOTES SUBSECTION 05.04: IRRIGATION REQUIREMENTS (A) <u>General Irrigation Requirements.</u> The owner shall be responsible for the health and vitality of plant material through the irrigation of all landscaped areas, turf and plant materials, and shall: (1) Provide a moisture level in an amount and frequency adequate to sustain growth of the plant materials on a permanent basis. (2) Be in place and operational at the time of the landscape inspection for Certificate of Occupancy (CO). (3) Be maintained and kept operational at all times to provide for efficient water distribution. (1) <u>Landscaped Areas.</u> One (1) of the following irrigation methods shall be used to ensure adequate watering of plant material in landscaped areas: (a) <u>Conventional System.</u> An automatic or manual underground irrigation system that may be a onventional spray or bubbler type heads. (b) <u>Drip or Leaky-Pipe System.</u> An automatic or manual underground irrigation system in conjunction with a watersaving system such as a drip or a leaky pipe system. (c) <u>Temporary and Aboveground Watering</u>. Landscape areas utilizing xeriscape plants and installation techniques, including areas planted with native grasses and wildflowers, may use a temporary and above ground system, and shall be required to provide irrigation for the first two (2) growing seasons only. (2) <u>Natural and Undisturbed Areas.</u> No irrigation shall be required for undisturbed natural areas or (3) <u>Compliance with State Law.</u> All irrigation systems shall comply with the irrigation code of <u>Chapter 10</u>, Buildings and Building Regulations, Article XVI, Irrigation Code, of the City of Rockwall Code of Ordinances, and all applicable state laws, as may be amended.

ORNAMENTAL TREES	QTY	BOTANICAL / COMMON NAME	CONT	CAL	REMARKS
	28	Cercis canadensis / Eastern Redbud Multi-trunk	B&B/Cont.	3" Cal	8' HT Minimum, Full Canopy, Healthy, Good Form, Strong Central Leader.
	38	Rhus lanceolota / Flameleaf Sumac	B&B/Cont.	3" Cal	8' HT Minimum, Full Canopy, Healthy, Good Form, Strong Central Leader.
	27	Ilex decidua / Possumhaw	B&B/Cont.	3" Cal	8' HT Minimum, Full Canopy, Healthy, Good Form, Strong Central Leader.
SHADE TREE	QTY	BOTANICAL / COMMON NAME	CONT	CAL	REMARKS
	27	Acer rubrum 'October Glory' / October Glory Red Maple	B&B/Cont.	4" Cal 6" Cal in Buffer Zone	12' HT Minimum, Full Canopy, Healthy, Good Form, Strong Central Leader.
	90	Magnolia grandiflora 'Little Gem' / Little Gem Dwarf Southern Magnolia	B&B/Cont.	4" Cal 6" Cal in Buffer Zone	12' HT Minimum, Full Canopy, Healthy, Good Form, Strong Central Leader.
0000000000000000000000000000000000000	33	Ulmus parvifolia 'Golden Rey' / Golden Rey Lacebark Elm	B&B/Cont.	4" Cal 6" Cal in Buffer Zone	12' HT Minimum, Full Canopy, Healthy, Good Form, Strong Central Leader.
SHRUBS	QTY	BOTANICAL / COMMON NAME	CONT	SIZE	REMARKS
	24	Elaeagnus x ebbingei / Ebbing Silverberry	5 gal	4`-8` HT 6`-8` SPD	
	268	Leucophyllum frutescens / Texas Sage	5 gal	4`-8` HT 4`-6` SPD	
•	16	Spiraea prunifolia 'Bridalwreath' / Bridal Wreath Spirea	5 gal	4`-8` HT 6`-8` SPD	
ORNAMENTAL GRASSES	QTY	BOTANICAL / COMMON NAME	CONT	SIZE	REMARKS
mure market	48	Calamagrostis x acutiflora 'Karl Foerster' / Karl Foerster Feather Reed Grass	5 gal	2`-6` HT 36" O.C.	
*	81	Pennisetum alopecuroides 'Hameln' / Hameln Fountain Grass	5 gal	2`-3` 1`-3` Spd	
Hard Hard Hard Hard Hard Hard Hard Hard	77	Schizachyrium scoparium / Little Bluestem	5 gal	3`-4` 12"-18" Spd	
	38	Stipa tenuissima 'Pony Tails' / Pony Tails Mexican Feather Grass	5 gal	1`-2` Ht 36" O.C	
GROUND COVERS	QTY	BOTANICAL / COMMON NAME	CONT	SIZE	
· · · · · · · · · · · · · · · · · · ·	197,277 sf	Cynodon dactylon (L.) Pers. × Cynodon transvaalensis Burtt Davy / Tiftuf Bermuda Grass	Sod		
	9,930 sf	Eragrostis curvula / Weeping Lovegrass	3 gal		
MISCELLANEOUS	QTY	BOTANICAL / COMMON NAME	CONT	SIZE	
######################################	1,520 sf	-Native decompsed granite / Decomposed Granite	flat		
	2,442 LF	Landscape Steel Edging			

LANDSCAPE PROJECT NOTES

Refer to Sitework Specifications for all information needed for landscape work.

Notify Landscape Architect or designated representative of any layout discrepancies or any condition which may prohibit the installation as shown.

Verify and locate all utilities and site lighting conduits before landscape construction begins. Protection of all utilities is the responsibility of the Contractor.

All landscape planting areas illustrated shall be graded smooth with three inches (3") of topsoil and three inches (3") of compost applied and consistently blended (tilled) to a depth of nine inches (9"). If adequate or sufficient topsoil is not available on site, the Contractor shall provide topsoil per the specifications and approved by the Owner. To obtain final grade, excavation may be necessary to accept the required depth of opsoil/compost mix with surface dressing or mulch. All beds shall be crowned to anticipate settlement and ensure drainage without disrupting surrounding planned drainage paths. Any areas disturbed for any reason prior to final acceptance of the project shall be corrected by the Contractor at no additional expense to the Owner.

All landscaped areas will be irrigated with an underground automatic system.

Quantities shown on these plans are for reference only. Plant spacing is as indicated in the Plant Material List unless otherwise noted. The Contractor has full responsibility to provide coverage in all planting areas as specified.

All trees and shrubs shall be installed per planting details.

Trees shall be planted at least five feet (5') from any utility line or sidewalk, to the outside of utility easements with a clear ten feet (10') around fire hydrants and twenty feet (20') min. from all irrigation control zone meter boxes. Furthermore, planting within areas of turf shall give priority of location to irrigation. Trees, shall not be planted within five feet (5') of a spray head or ten feet (10') of a rotor. Remaining irrigation components shall respect the location of the illustrated landscape design. Shrubs, regardless of type, shall not be planted within thirty inches (30") of bed

All plant material shall be maintained in a healthy and growing condition, and must be replaced with similar variety and size if damaged or removed. Container grown plant material is preferred, however ball and burlap material may be substituted as indicated in the plant material list.

All planting beds as designated shall be bordered by Owner approved four inch (4") steel edging w/ $\frac{3}{16}$ " min. thickness unless bed is bordered by concrete. Steel edging adjacent to decomposed granite beds shall have a 1/4" min. thickness. Terminate edging flush with paved surface with no sharp corners exposed.

A four inch (4") dressing of Shredded hardwood mulch over a 4.1 oz, woven polypropylene, needle-punched fabric or equal weed barrier shall be used in all plant beds and around all trees and within all beds with plants spaced 18" o.c. or greater. Single trees or shrubs shall be mulched to the outside edge of the saucer or landscape island (See planting details).

Fertilize all plants at the time of planting with 10-10-10 time release fertilizer.

All areas of decomposed granite shall be over a 4.1 oz, woven polypropylene, needle-punched fabric or equal weed barrier of locally available material, installed to a compacted depth of three inches (3") to be flush with the top of curb, paved surface, and/or the top of steel edge.

TURF PROJECT NOTES

EROSION CONTROL:

Γhroughout the project and the maintenance period for turfgrass, it is the Contractor's responsibility to maintain the topsoil in place at specified grades. Topsoil and turfgrass losses due to erosion or any construction disturbance will be replaced by the Contractor until ESTABLISHMENT and ACCEPTANCE is

SOIL PREPARATION

All slopes and areas disturbed by construction, except those occupied by buildings, structures, or paving shall be graded smooth and four (4") inches of topsoil applied. If adequate topsoil is not available onsite, the Contractor shall provide topsoil as approved by the Owner. The area shall be dressed to typical sections and plowed to a depth of five (5") inches. Soil shall be further prepared by the removal of debris, weeds and stones larger than 3/4 inch in diameter. After tillage and cleaning, all areas to receive turf shall be leveled, fine graded, and drug with a weighted spike harrow or float drag. The top two (2") inches shall be pulverized to provide a uniform bed for seeding or sod as described below.

At a minimum, three feet (3') of solid sod shall be installed along all impervious edges. This includes, but is not limited to: curbing, sidewalks, building foundation, storm water inlets, manholes, and planting bed perimeter treatments. Additional areas of sod installation will be as indicated on the design plans. All areas from back of curb within the roadway ROWs and 10' Landscape Buffer shall be sod. Should installation occur between November and March, sod shall include an over-seed of Annual Rye for a grown-in appearance.

SPRING AND SUMMER PERMANENT GRASSING (May 15 through September 15): Hydromulch seed with hulled Common Bermuda at a rate of 4 lbs/1000 sf. Seeding shall be accomplished immediately after bed preparation. Hydroseed mixture shall contain cellulose mulch applied at a rate of 2000 lbs/acre, with a maximum of 50 lbs/100 gallons of water. If seeding is delayed after mixing 0.5 - 2 hours, add 50% seed mix. If delay is longer than 2 hours, begin with new mixture.

FALL AND WINTER TEMPORARY GRASSING (September 15 through May 15): Seed with annual rye at a rate of 10 lbs/1000 sf. After May 15, Contractor shall remove rye to effectively establish permanent seeding.

IRRIGATION:
In the absence of an irrigation system or areas beyond the coverage limits of a permanent irrigation system, Contractor shall water sod/seed temporarily to develop adequate growth and establishment before regular maintenance begins. Turf shall be watered until firmly established.

Water shall be furnished by the Contractor with means and methods available to achieve acceptable turf. The water source shall be clean and free of industrial wastes or other substances harmful to the growth of the turf.

MAINTENANCE REQUIREMENTS:

Vegetation should be inspected regularly to ensure that plant material is established properly and remains healthy. Mowing, trimming and supervision of water applications shall be the responsibility of the Contractor until the Owner or Owner's Representative accepts and assumes regular maintenance.

ESTABLISHMENT AND ACCEPTANCE:

All disturbed areas being seeded shall receive topsoil as specified and be adequately established with turf such that any absence of water will not kill the turf, but promote a state of turf dormancy, until the next rainfall event.

Regardless of unseasonable climatic conditions or other adverse conditions affecting planting operations and the growth of the turf grass, it shall be the sole responsibility of the Contractor to establish a uniform stand of grass. UNIFORM STAND OF GRASS is defined as minimum 80% coverage per square foot (no bare areas).

Contractor to make a written request for inspection to Owner or Owner's representative a minimum of 5 days prior to the anticipated inspection date.



THESE DOCUMENTS ARE FOR INTERIM REVIEW AND ARE NOT INTENDED FOR REGULATORY APPROVAL, PERMIT, BIDDING OR CONSTRUCTION PURPOSES. THEY

WERE PREPARED BY OR UNDER THE

SUPERVISION OF: JAMES R. KINDRED 2255 R.L.A. NO.

03/15/2024


Project No.: 46587 MARCH, 2024 СP

Issued: Drawn By: Checked By: JRK Scale: AS SHOWN

Sheet Title LANDSCAPE NOTES AND DETAILS

Sheet Number

CASE NUMBER: SPXXXX-XXX

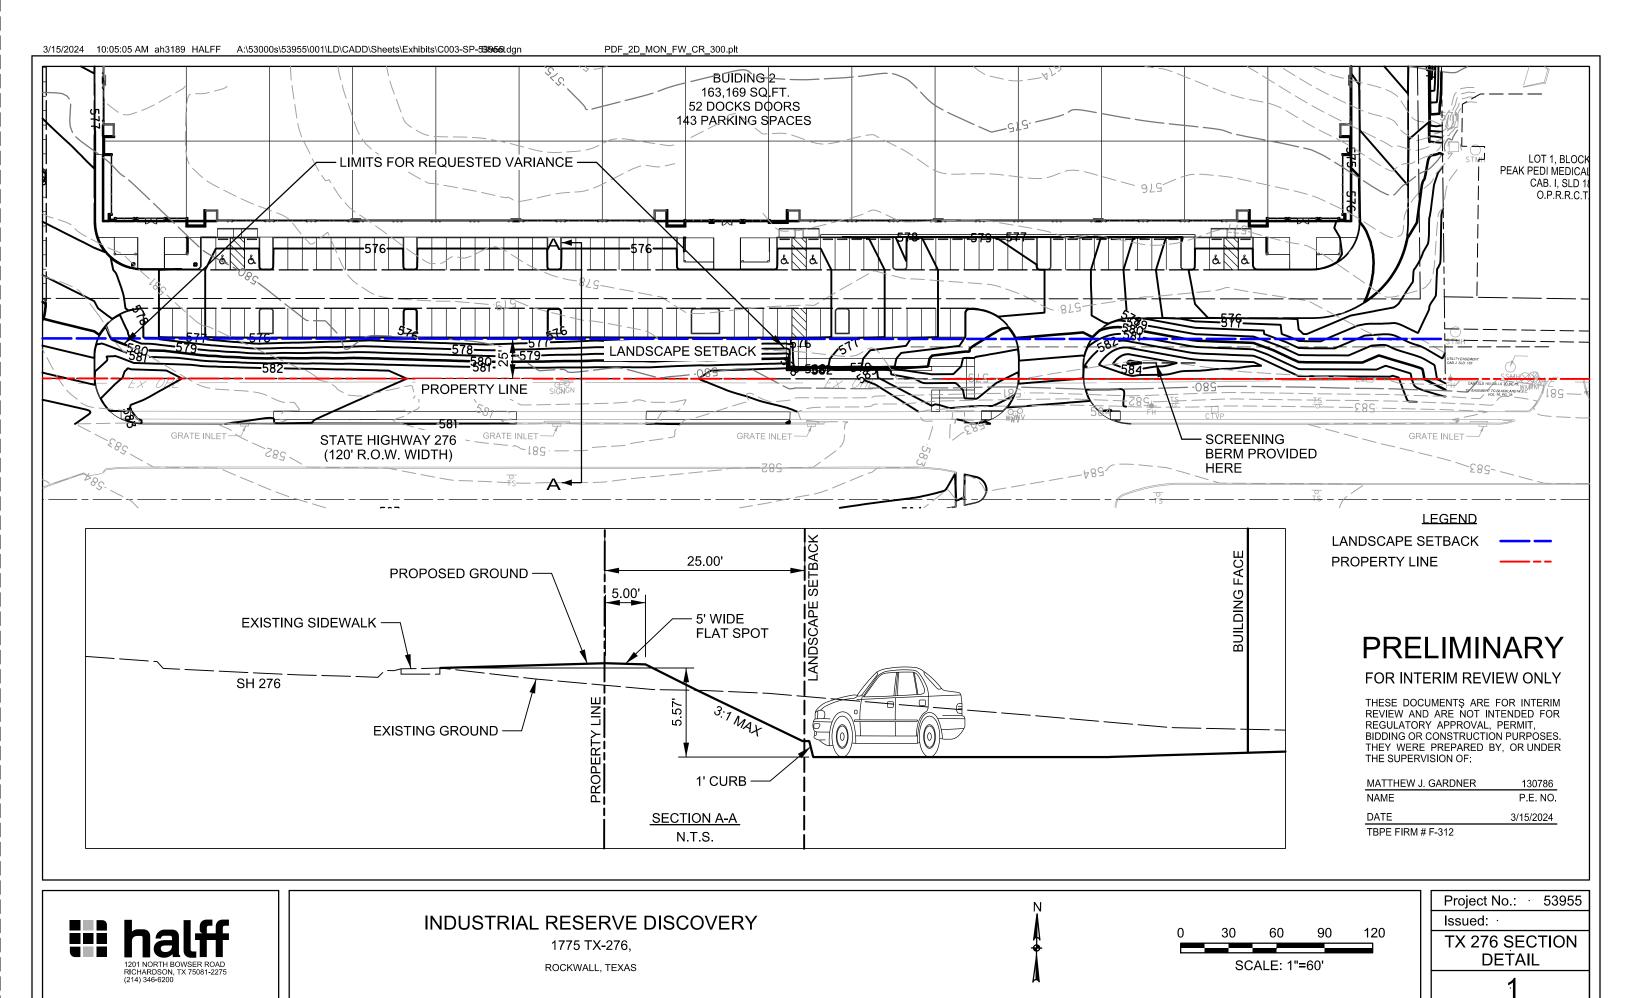



March 15, 2024 AVO 53955

City of Rockwall Planning and Zoning 385 S Goliad St Rockwall, TX 75087

RE: VARIANCE REQUEST: Industrial Reserve Discovery Rockwall

Rockwall, TX

Dear reviewer.

Industrial Reserve would like to request a variance to the minimum ground cover requirements within landscape buffers adjacent to Primary Roadways and specific to the SH-276 Overlay District, as detailed in Subsection 06.02 (E) of the City of Rockwall Unified Development Code. The Unified Development Code requires a built-up berm and shrubbery, or combination thereof, along the length of the frontage where the berm is 30 - 48 inches in height as measured from the primary roadway elevation. Based on our interpretation of the code requirements we believe that the intent and purpose of the required ground cover screening can be met with an alternative landscaping layout that still provides the required shrubbery and trees but eliminates the built-up berm. Below are key points to the proposed site conditions and proposed justification to providing the variance as requested.

Proposed Site Conditions:

- 1) Please refer to the included amended "Site Plan".
- 2) The car parking for this proposed site development is several feet lower in elevation when compared to the existing primary roadway (SH-276). The parking is on average about 5.5 ft lower that SH-276. Due to this height difference, providing a minimum 30-inch-tall berm along the frontage road creates the need to add over 400 ft of retaining wall that averages 7 ft in height. The additional height difference created by the berm and limited space to make up the grades is what drives the need for the wall.
- The reason the car parking sits several feet lower than SH-276 is due to grading requirements of the intended site layout and the intent to provide a balanced site for dirt import/export.

Proposed Variance

- 1) Please refer to the included attachment labeled "TX 276 SECTION DETAIL".
- 2) The proposed variance to the code requirement is to eliminate the built-up berm. The shrubbery and trees would still be provided as required. It is our interpretation of the code that the landscape berm provides ground cover for both screening and aesthetic purposes. The requirement as detailed within the code has a more practical application to sites that are at or above the adjacent roadway elevation. This site sits several feet below and per this site's conditions, we believe the intent of the requirement can be met without the berm.
- 3) Any vehicles navigating within this site's car parking and facing towards SH-276 would have their headlights screened with the over 5 ft elevation difference between the car parking and the public roadway. This elevation difference is already greater than the 30-inch berm height denoted in the code requirement and thus already provides more screening than is needed. The addition of the 30" berm does not increase the functionality for the screening intent as over 30" of screening are already being provided.

If you have any questions or need any additional information, please call me at your convenience 214-217-6622.

Sincerely,


HALFF

Jose Garcia, PE

facl Loris fo

Halff Phone: 214.346.6200 Fax: 214.739.0095

PROJECT COMMENTS

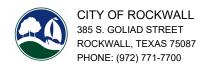

DATE: 3/22/2024

PROJECT NUMBER: SP2024-009

PROJECT NAME: Amended Site Plan for 1775 State Highway 276
SITE ADDRESS/LOCATIONS: 1775 STATE HIGHWAY 276, ROCKWALL, 75032

CASE CAPTION: Discuss and consider a request by Justin Toon of Industrial Reserve on behalf Reserve Capital – Rockwall Industrial SPE, LLC for

the approval of an Amended Site Plan for a Warehouse/Distribution Center on an 18.48-acre tract of land identified as Tracts 1, 1-3 & 1-7 of the J. M. Allen Survey, Abstract No. 2, City of Rockwall, Rockwall County, Texas, zoned Light Industrial (LI) District, situated

within the SH-276 Overlay (SH-276 OV) District, addressed as 1725 SH-276, and take any action necessary.

DEPARTMENT	REVIEWER	DATE OF REVIEW	STATUS OF PROJECT	
PLANNING	Bethany Ross	03/20/2024	Approved w/ Comments	

03/20/2024: SP2024-009; Amended Site Plan for 1775 SH-276

Please address the following comments (M= Mandatory Comments; I = Informational Comments)

- I.1 This is a request by Justin Toon of Industrial Reserve on behalf Reserve Capital Rockwall Industrial SPE, LLC for the approval of an Amended Site Plan for a Warehouse/Distribution Center on an 18.48-acre tract of land identified as Tracts 1, 1-3 & 1-7 of the J. M. Allen Survey, Abstract No. 2, City of Rockwall, Rockwall County, Texas, zoned Light Industrial (LI) District, situated within the SH-276 Overlay (SH-276 OV) District, and addressed as 1725 SH-276.
- 1.2 For guestions or comments concerning this case please contact Bethany Ross in the Planning Department at (972) 772-6488 or email bross@rockwall.com.
- I.3 On July 26, 2022, the Planning and Zoning Commission approved a site plan [Case No. SP2022-037] allowing the construction of a Warehouse/Distribution Center consisting of two (2) buildings (i.e. a 163,500 SF building and a 121,680 SF building) on the subject property.
- I.4 According to Section 06.06, General Overlay District Standards, of Article 05, District Development Standards, of the Unified Development Code (UDC), "...(a)|| landscape buffers shall incorporate ground cover, a built-up berm and shrubbery or a combination thereof along the entire length of the frontage. Berms and shrubbery shall each have a minimum height of 30-inches and a maximum height of 48- inches. In addition, two (2) canopy trees and four (4) accent trees shall be planted per 100-feet of linear frontage along the Primary Roadway."
- 1.5 Please note the scheduled meetings for this case:
- (1) Planning & Zoning Work Session meeting will be held on March 26, 2024.
- (2) Planning & Zoning meeting/public hearing meeting will be held on April 9, 2024.
- 1.6 The City requires that a representative(s) be present for these meetings. During the upcoming meeting with the Planning and Zoning Commission, representative(s) are required to present their case and answer any questions the Planning Commission may have regarding this request.

DEPARTMENT	REVIEWER	DATE OF REVIEW	STATUS OF PROJECT	
ENGINEERING	Madelyn Price	03/21/2024	Approved w/ Comments	

03/21/2024: 1. 18' spaces require a 2' clear overhang. A 1' curb and slopes won't allow this. If these were 20' spaces, there isn't an issue

- 2. Please highlight on this site plan anything that has changed from the Industrial Reserve Discovery Civil Engineering Plans. At a glance, it does not appear anything has changed from the Civil Engineering side. Please confirm.
- 3. Show tree 5' from sewer manhole/line and don't install landscaping on top of manhole
- 4. 18' parking spaces to have 2' clear overhang

General Comments:

General Items:

- Must meet City 2023 Standards of Design and Construction
- 4% Engineering Inspection Fees
- Impact Fees (Water, Sewer, Roadway).
- Minimum easement width is 20' for new easements. No structures, including walls, allowed in easements.
- Retaining walls 3' and over must be engineered.
- All retaining walls (18" or taller) must be rock or stone face. No smooth concrete walls.
- No signage is allowed within easements or ROW.
- Tree mitigation will be required for the removal of any existing trees on site.
- No structures or fences with easements.
- The site will need to be platted.
- All utilities must be underground.
- Additional comments may be provided at the time of Engineering review.

Drainage Items:

- The property owner will be responsible for maintaining, repair, and replacement of the drainage systems.
- No vertical walls allowed in detention easement. 4:1 maximum side slopes for detention pond.
- No public water or sanitary sewer allowed in detention easement.
- FFE for all buildings must be called out when adjacent to a detention system. FEE must be a minimum 2' above the 100-year WSEL for the detention system.
- Existing site flow patterns must be maintained.
- Grate inlets are not allowed.
- Dumpster areas to drain to oil/water separator and then to the storm lines.

Water and Wastewater Items:

- Public sewer to be 8" minimum.
- Commercial sanitary sewer service line size is minimum 6" and must connect to an existing or proposed manhole.
- Any public water lines must be a minimum of 8", looped, and must be in a 20' wide easement.
- Pavement cut for utility connections must be full panel replacement.
- Any utility connection made underneath of an existing roadway must be completed by dry bore. Opening cutting will not be allowed.
- Only one "use" off a dead-end line (domestic, irrigation, fire sprinkler, fire hydrant, etc.)
- Min 20' utility easements.
- Water to be 10' separated from storm and sewer lines.
- All public utilities must be centered in easement.

Roadway Paving Items:

- Must meet City driveway spacing requirements.
- All parking, storage, drive aisles must be reinforced concrete. (No rock, gravel, or asphalt allowed).
- All Parking to be 20'x9' minimum. Parking may not be off a public Roadway. Vehicle must not be required to back onto a public roadway, including trash trucks.
- No dead-end parking allowed without an City approved turnaround.
- Drive isles to be 24' wide.
- Fire lane (if needed) to be 24' wide and in a platted easement.

- Fire lane (if needed) to have 20' min radius if buildings are less than 30' tall. If any of the buildings are 30' or more, the fire lane will be 30' radius minimum.

Landscaping:

- No trees to be with 10' of any public water, sewer or storm line that is 10" in diameter or larger.
- No trees to be with 5' of any public water, sewer, or storm line that is less than 10".


DEPARTMENT	REVIEWER	DATE OF REVIEW	STATUS OF PROJECT
BUILDING	Craig Foshee	03/21/2024	Approved w/ Comments

03/21/2024: DUMPSTER ENCLOSURE TO MEET THE MINIMUM DESIGN/SIZE REQUIREMENTENTS OF THE UDC.

DUMPSTER ENCLOSURE IS REQUIRED TO HAVE A DRAIN THAT SHALL FLOW THROUGH AN OIL/WATER SEPARATOR (THAT IS SIZED BY AN ENGINEER) AND MUST DISCHARGE TO THE STORM WATER LINE AND NOT TO THE SANITARY SEWER

DEPARTMENT	REVIEWER	DATE OF REVIEW	STATUS OF PROJECT	
FIRE	Ariana Kistner	03/18/2024	Approved	
No Comments				
DEPARTMENT	REVIEWER	DATE OF REVIEW	STATUS OF PROJECT	
GIS	Lance Singleton	03/18/2024	Approved	
No Comments				
DEPARTMENT	REVIEWER	DATE OF REVIEW	STATUS OF PROJECT	
POLICE	Chris Cleveland	03/18/2024	Approved	
No Comments				
DEPARTMENT	REVIEWER	DATE OF REVIEW	STATUS OF PROJECT	
PARKS	Travis Sales	03/18/2024	Approved	

No Comments

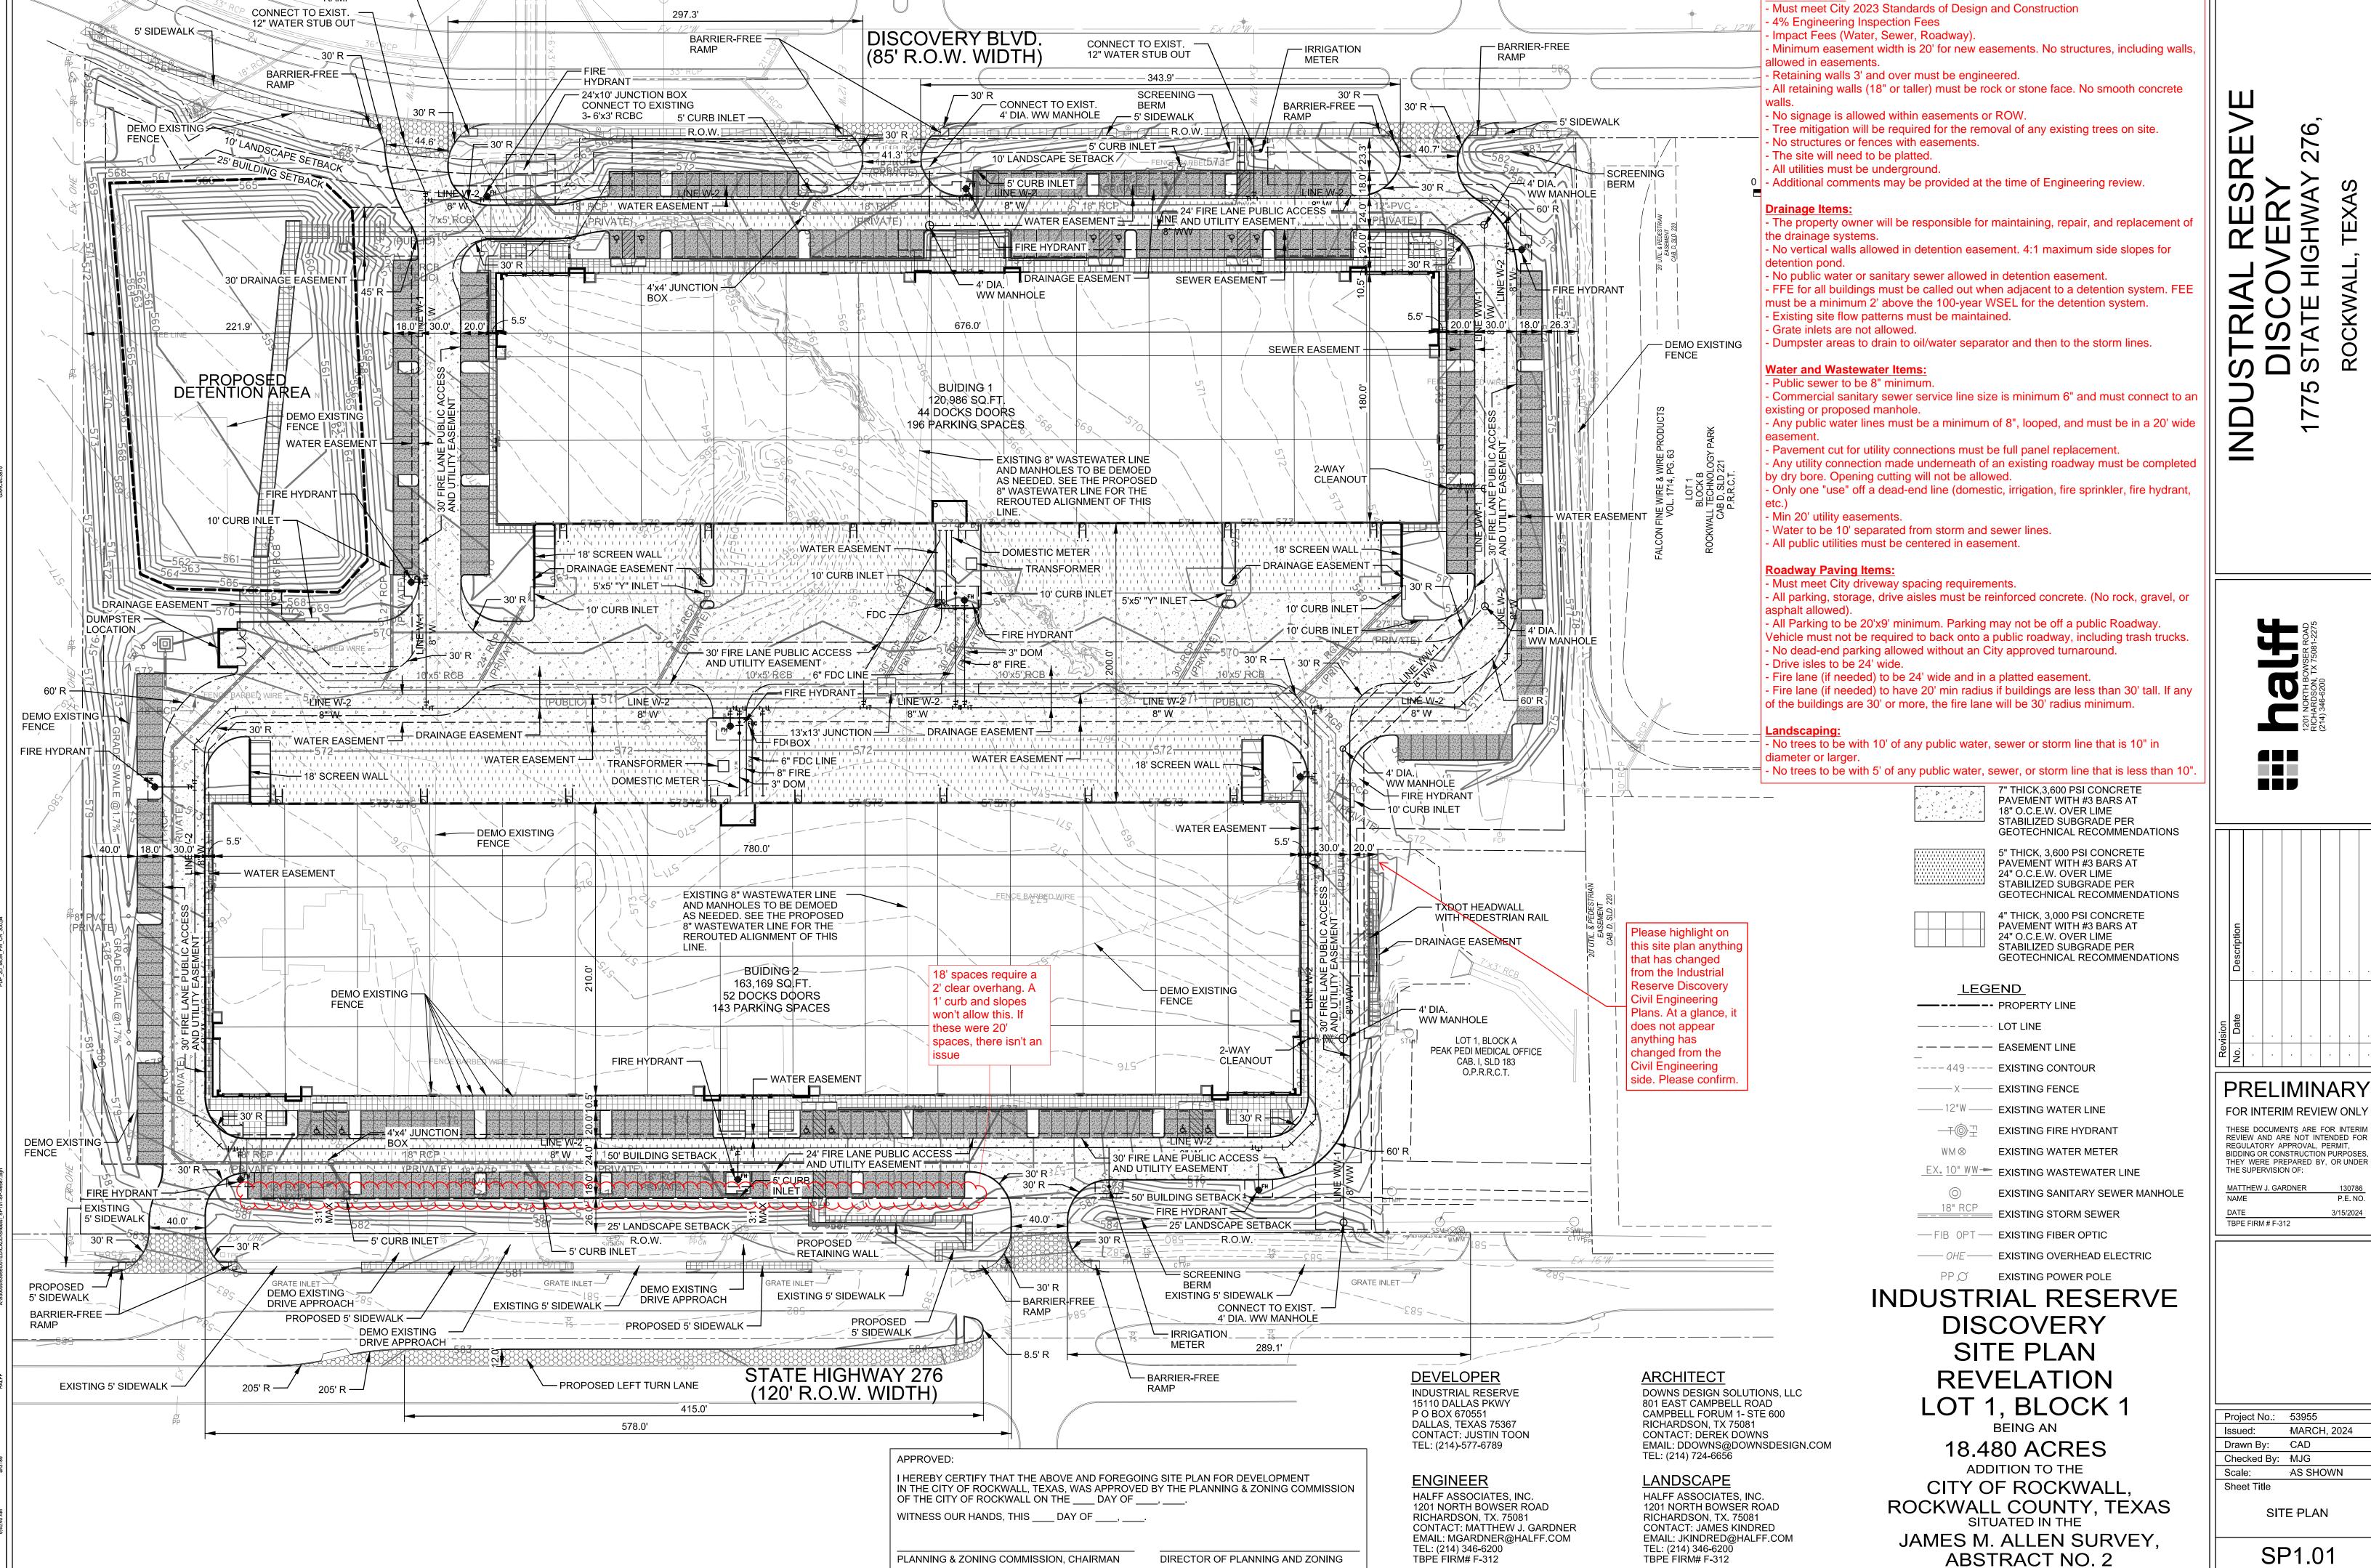

BARRIER-FREE -

PRELIMINARY

FOR INTERIM REVIEW ONLY


THEY WERE PREPARED BY, OR UNDER THE SUPERVISION OF:

Project No.: 53955 CAD

MARCH, 2024 AS SHOWN

SP1.01

Sheet Number CASE NUMBER: SPXXXX-XXX

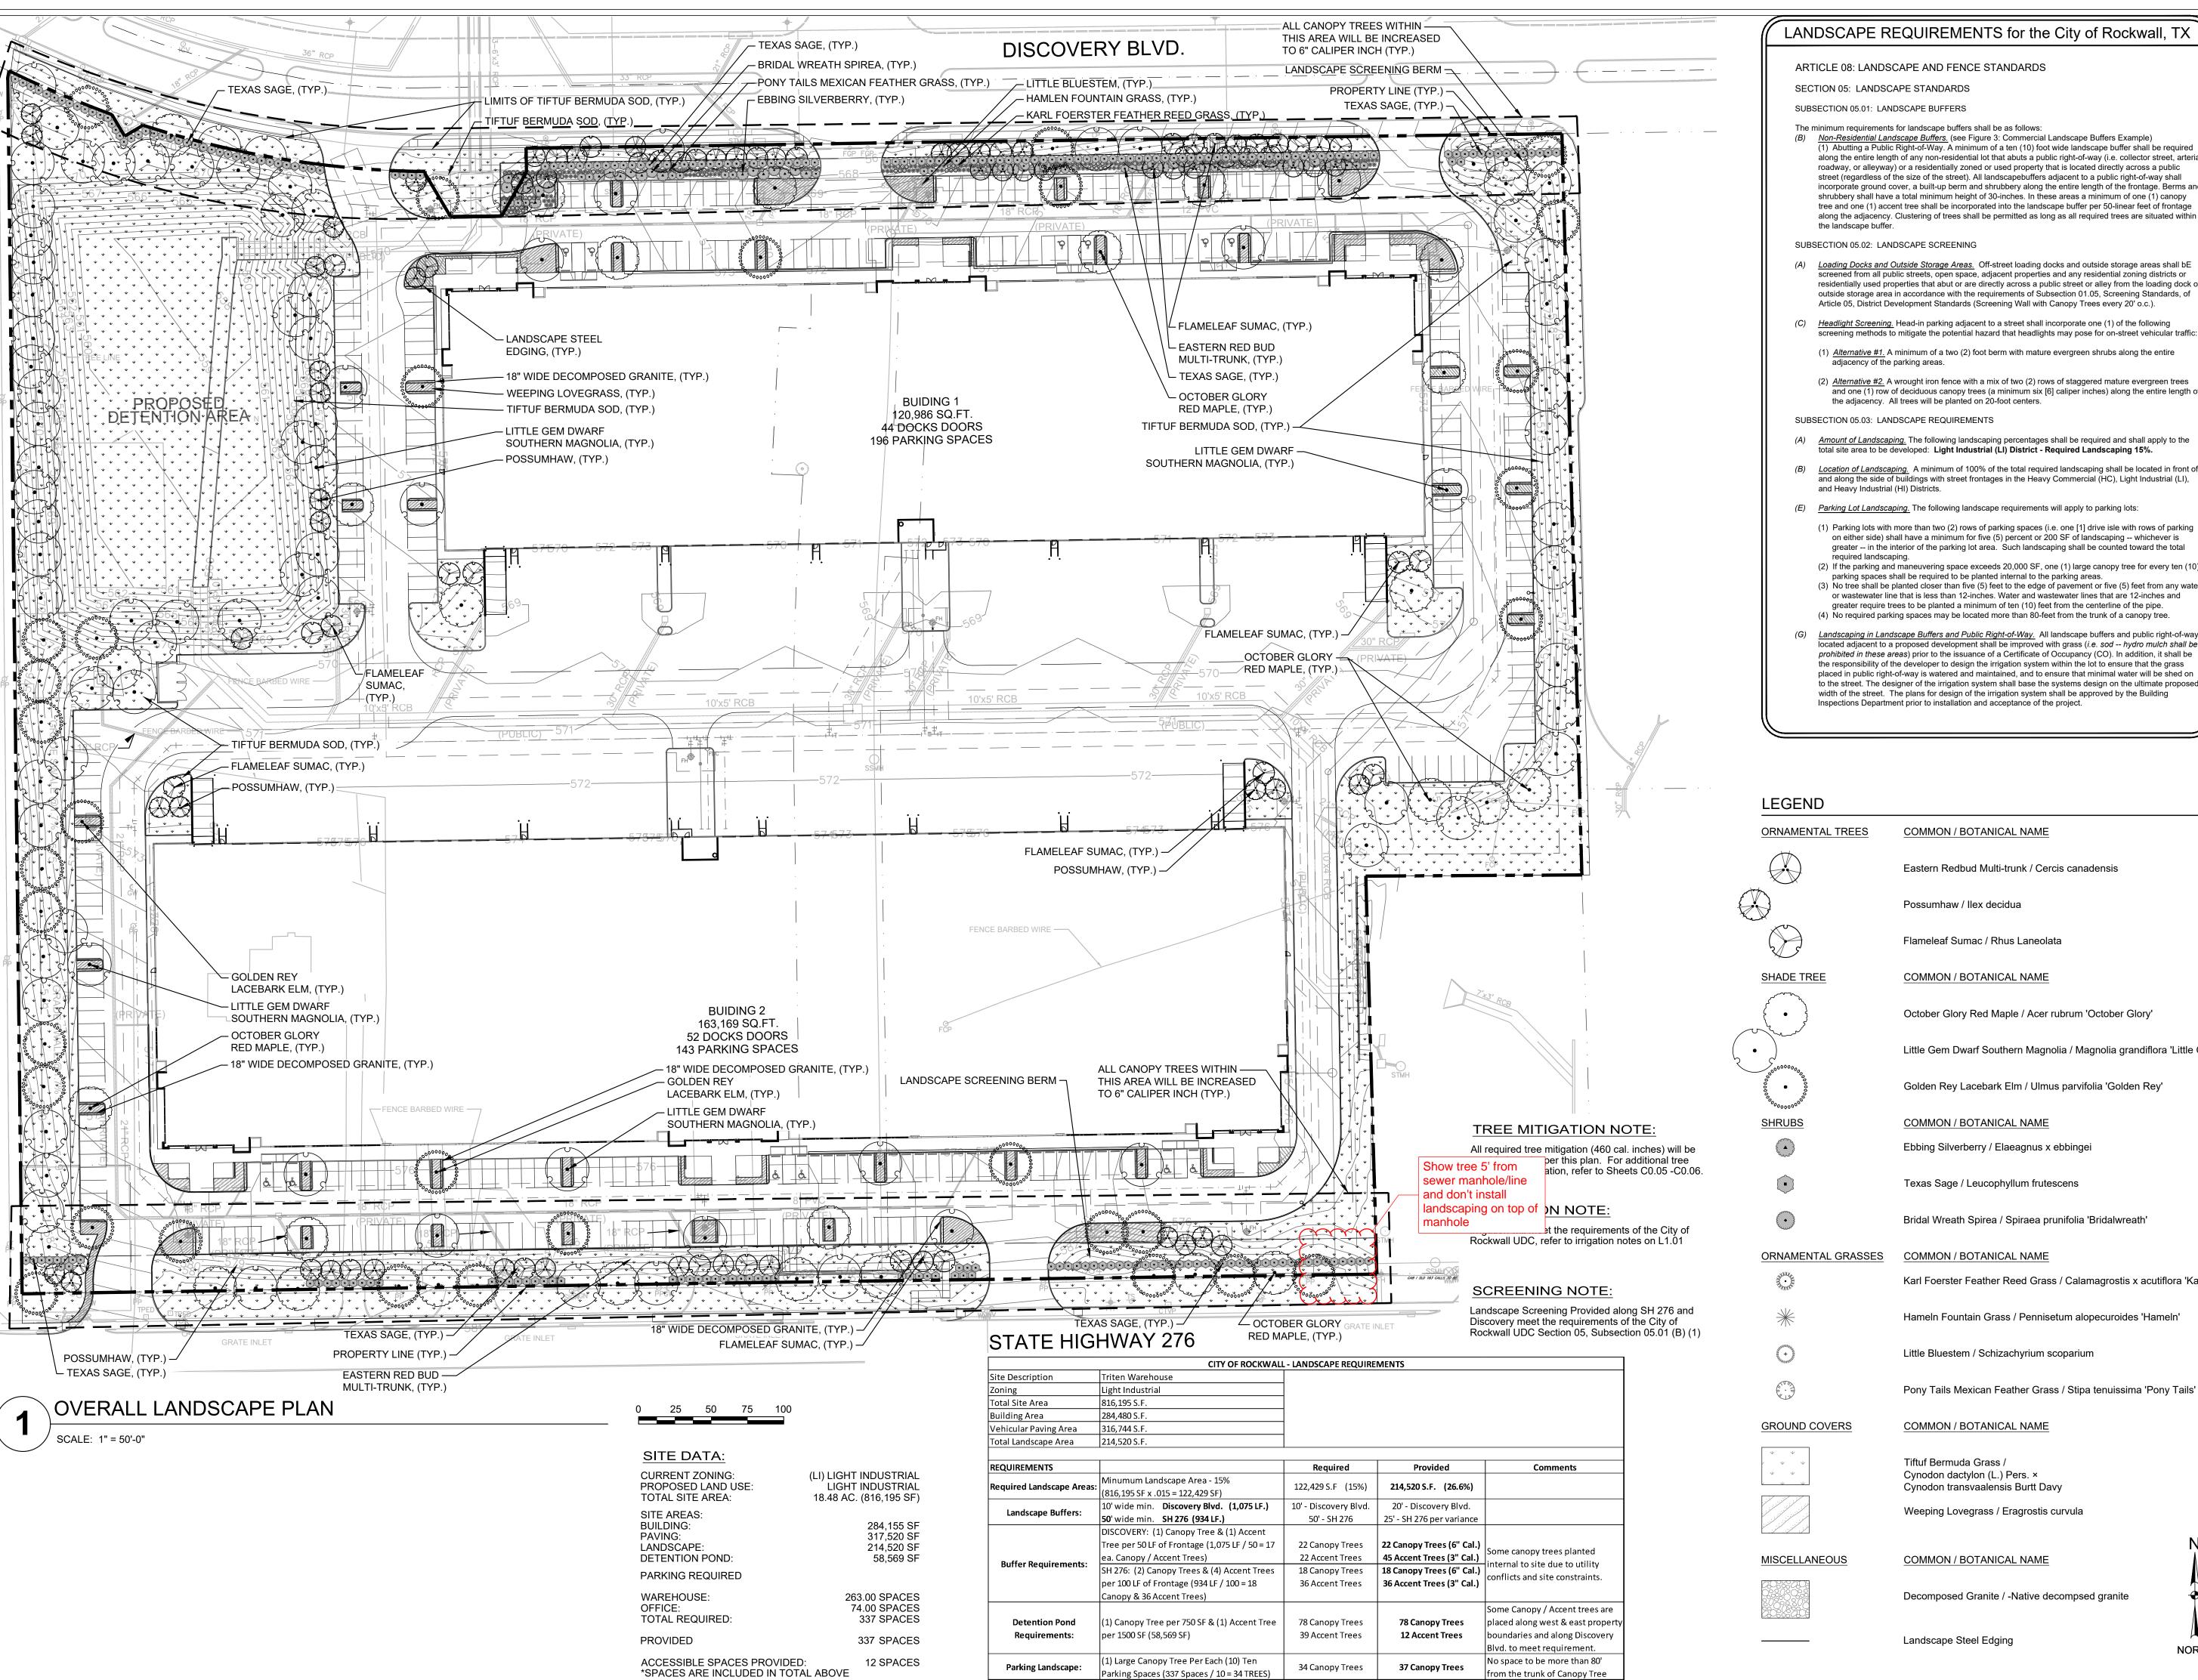

LANDSCAPE REQUIREMENTS for the City of Rockwall, TX

(B) <u>Non-Residential Landscape Buffers.</u> (see Figure 3: Commercial Landscape Buffers Example)) Abutting a Public Right-of-Way. A minimum of a ten (10) foot wide landscape buffer shall be required along the entire length of any non-residential lot that abuts a public right-of-way (i.e. collector street, arterial roadway, or alleyway) or a residentially zoned or used property that is located directly across a public street (regardless of the size of the street). All landscapebuffers adjacent to a public right-of-way shall incorporate ground cover, a built-up berm and shrubbery along the entire length of the frontage. Berms and shrubbery shall have a total minimum height of 30-inches. In these areas a minimum of one (1) canopy tree and one (1) accent tree shall be incorporated into the landscape buffer per 50-linear feet of frontage along the adjacency. Clustering of trees shall be permitted as long as all required trees are situated within

- (A) <u>Loading Docks and Outside Storage Areas.</u> Off-street loading docks and outside storage areas shall bE screened from all public streets, open space, adjacent properties and any residential zoning districts or residentially used properties that abut or are directly across a public street or alley from the loading dock or outside storage area in accordance with the requirements of Subsection 01.05, Screening Standards, of
- (C) <u>Headlight Screening.</u> Head-in parking adjacent to a street shall incorporate one (1) of the following screening methods to mitigate the potential hazard that headlights may pose for on-street vehicular traffic:
- (1) Alternative #1. A minimum of a two (2) foot berm with mature evergreen shrubs along the entire
- (2) Alternative #2. A wrought iron fence with a mix of two (2) rows of staggered mature evergreen trees and one (1) row of deciduous canopy trees (a minimum six [6] caliper inches) along the entire length of the adjacency. All trees will be planted on 20-foot centers.
- (A) <u>Amount of Landscaping.</u> The following landscaping percentages shall be required and shall apply to the total site area to be developed: Light Industrial (LI) District - Required Landscaping 15%.
- (B) Location of Landscaping. A minimum of 100% of the total required landscaping shall be located in front of and along the side of buildings with street frontages in the Heavy Commercial (HC), Light Industrial (LI),
- (E) Parking Lot Landscaping. The following landscape requirements will apply to parking lots:
- (1) Parking lots with more than two (2) rows of parking spaces (i.e. one [1] drive isle with rows of parking on either side) shall have a minimum for five (5) percent or 200 SF of landscaping -- whichever is greater -- in the interior of the parking lot area. Such landscaping shall be counted toward the total
- parking spaces shall be required to be planted internal to the parking areas. (3) No tree shall be planted closer than five (5) feet to the edge of pavement or five (5) feet from any water or wastewater line that is less than 12-inches. Water and wastewater lines that are 12-inches and greater require trees to be planted a minimum of ten (10) feet from the centerline of the pipe. (4) No required parking spaces may be located more than 80-feet from the trunk of a canopy tree.
- (G) <u>Landscaping in Landscape Buffers and Public Right-of-Way.</u> All landscape buffers and public right-of-way located adjacent to a proposed development shall be improved with grass (i.e. sod -- hydro mulch shall be prohibited in these areas) prior to the issuance of a Certificate of Occupancy (CO). In addition, it shall be the responsibility of the developer to design the irrigation system within the lot to ensure that the grass placed in public right-of-way is watered and maintained, and to ensure that minimal water will be shed on to the street. The designer of the irrigation system shall base the systems design on the ultimate proposed width of the street. The plans for design of the irrigation system shall be approved by the Building

Eastern Redbud Multi-trunk / Cercis canadensis

Flameleaf Sumac / Rhus Laneolata

October Glory Red Maple / Acer rubrum 'October Glory'

Little Gem Dwarf Southern Magnolia / Magnolia grandiflora 'Little Gem'

Golden Rey Lacebark Elm / Ulmus parvifolia 'Golden Rey'

Ebbing Silverberry / Elaeagnus x ebbingei

Texas Sage / Leucophyllum frutescens

Karl Foerster Feather Reed Grass / Calamagrostis x acutiflora 'Karl Foerster'

Hameln Fountain Grass / Pennisetum alopecuroides 'Hameln'

Little Bluestem / Schizachyrium scoparium

Pony Tails Mexican Feather Grass / Stipa tenuissima 'Pony Tails'

COMMON / BOTANICAL NAME

Cynodon dactylon (L.) Pers. × Cynodon transvaalensis Burtt Davy

Weeping Lovegrass / Eragrostis curvula

Decomposed Granite / -Native decompsed granite

NORTH

Sheet Number

MARCH, 2024

AS SHOWN

CASE NUMBER: SPXXXX-XXX

LANDSCAPE PLAN

PRELIMINARY

FOR INTERIM REVIEW ONLY

THESE DOCUMENTS ARE FOR INTERIM

REVIEW AND ARE NOT INTENDED FOR

REGULATORY APPROVAL, PERMIT, BIDDING

OR CONSTRUCTION PURPOSES. THEY WERE PREPARED BY OR UNDER THE

R.L.A. NO.

03/15/2024

SUPERVISION OF:

JAMES R. KINDRED

Project No.: 46587


Checked By: JRK

Issued:

Scale:

Drawn By:

Sheet Title

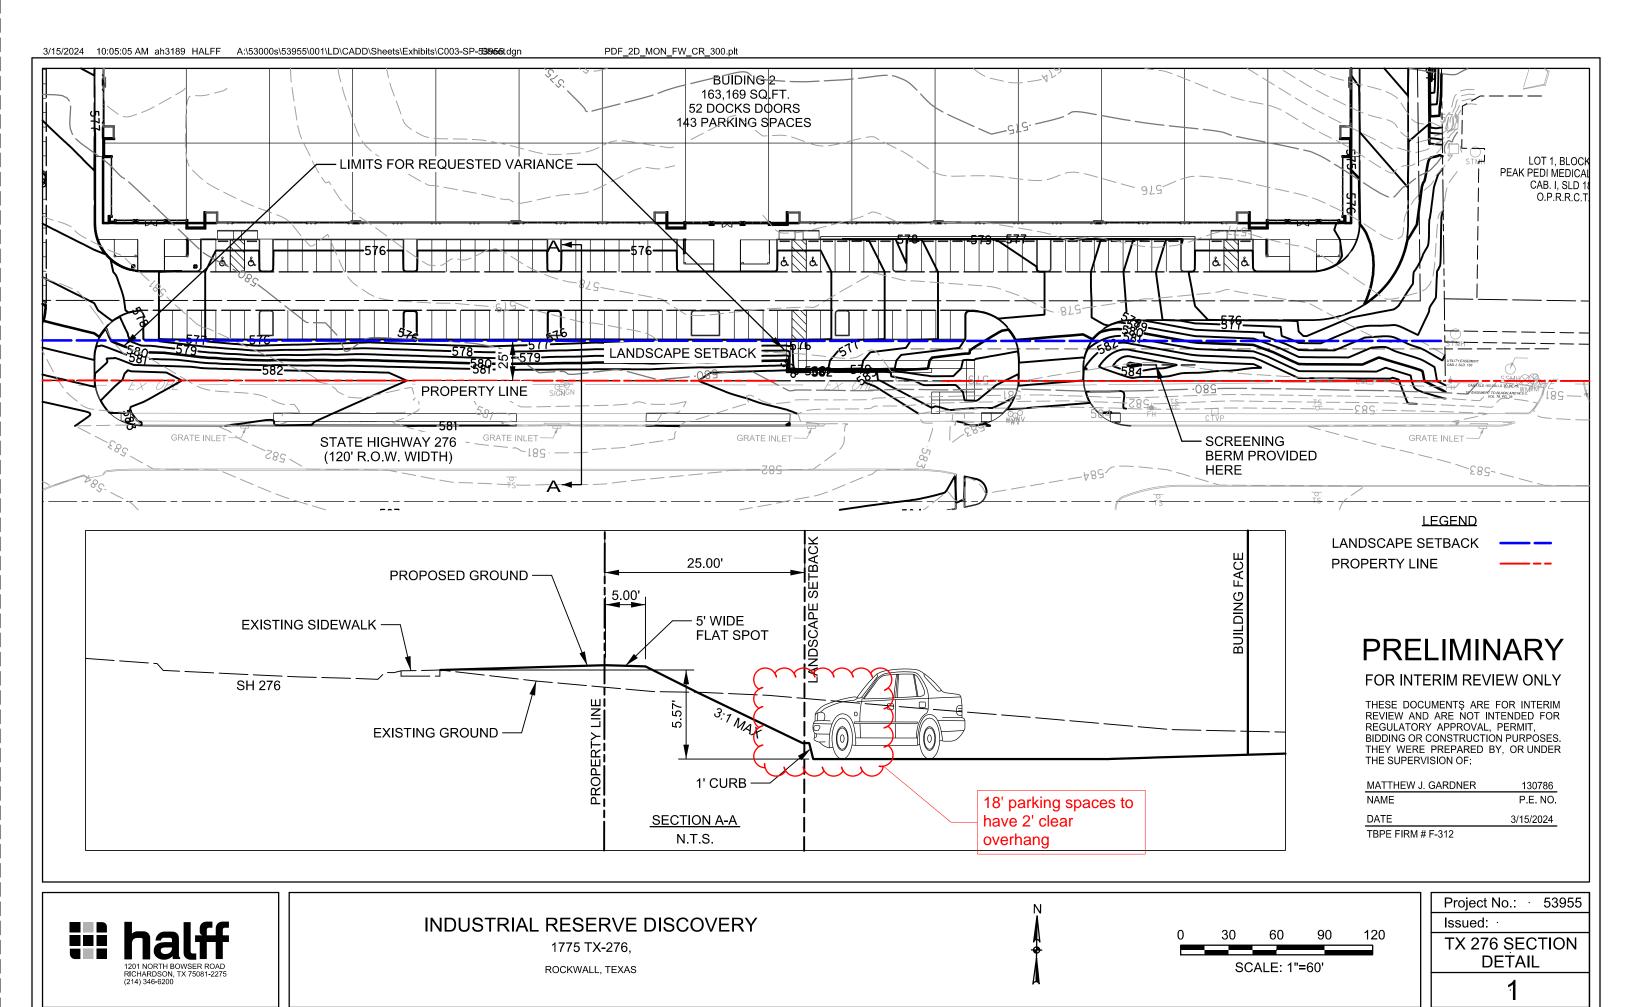



DEVELOPMENT APPLICATION

City of Rockwall Planning and Zoning Department 385 S. Goliad Street Rockwall, Texas 75087

TAFF U	SE ON	LY -
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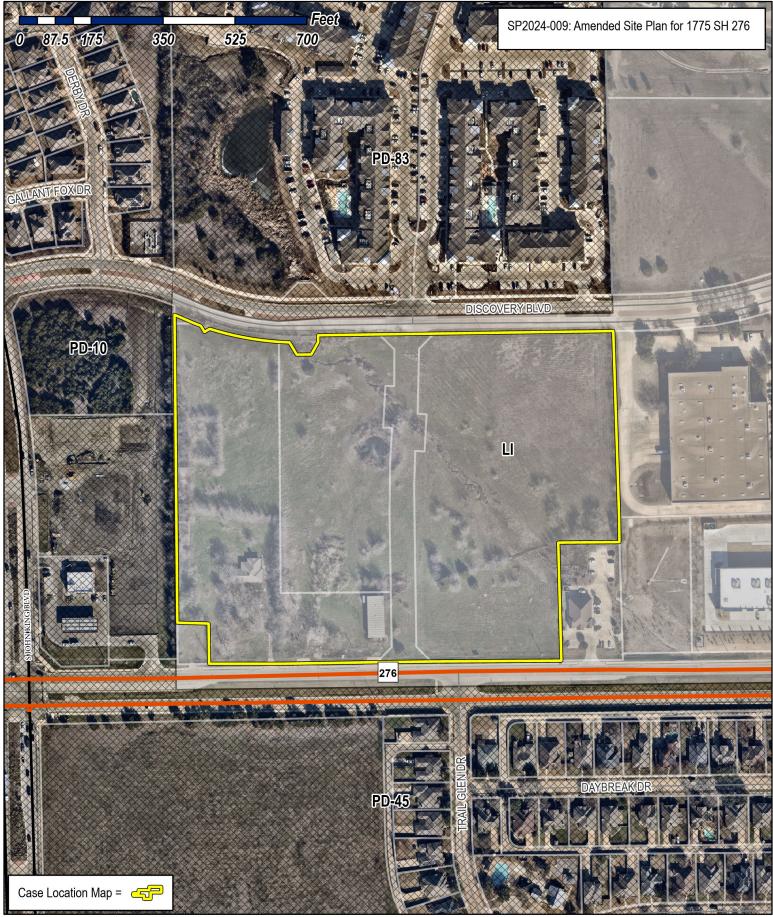
PLANNING & ZONING CASE NO.

<u>NOTE:</u> THE APPLICATION IS NOT CONSIDERED ACCEPTED BY THE CITY UNTIL THE PLANNING DIRECTOR AND CITY ENGINEER HAVE SIGNED BELOW.

DIRECTOR OF PLANNING:

CITY ENGINEER:

PLEASE CHECK THE	APPROPRIATE BOX BELOW TO INDICATE THE TYPE C	F DEVELOPMENT REC	QUEST [SELECT ONLY ONE BOX]:	
☐ PRELIMINARY F ☐ FINAL PLAT (\$30.0 ☐ REPLAT (\$300.0 ☐ AMENDING OR ☐ PLAT REINSTAT SITE PLAN APPLIC ☐ SITE PLAN (\$250	\$100.00 + \$15.00 ACRE) 1 PLAT (\$200.00 + \$15.00 ACRE) 1 00.00 + \$20.00 ACRE) 1 10 + \$20.00 ACRE) 1 MINOR PLAT (\$150.00) FEMENT REQUEST (\$100.00)	☐ SPECIFIC US ☐ PD DEVELOP OTHER APPLICA ☐ TREE REMON ☐ VARIANCE R NOTES: ¹: IN DETERMINING TH PER ACRE AMOUNT. ²: A \$1,000.00 FEE V	NGE (\$200.00 + \$15.00 ACRE) ¹ SE PERMIT (\$200.00 + \$15.00 ACRE) ^{1 & 2} PMENT PLANS (\$200.00 + \$15.00 ACRE) ¹ ATION FEES:	(1) ACRE. EST THAT
PROPERTY INFO	DRMATION [PLEASE PRINT]			
ADDRESS	1775 State Highway 276, Rockwa	II, TX 75032		
SUBDIVISION	Revelation		LOT 1 BLOCK	1
GENERAL LOCATION	Tract East of John King Blvd. betv	veen Discovery	Blvd. & State Highway 276	
ZONING, SITE PL	AN AND PLATTING INFORMATION [PLEAS	SE PRINT]		
CURRENT ZONING	Light Industrial	CURRENT USE	Light Industrial	
PROPOSED ZONING	Light Industrial	PROPOSED USE	Light Industrial	
ACREAGE	18.48 LOTS [CURRENT	1 1	LOTS [PROPOSED] 1	
REGARD TO ITS A	D <u>PLATS</u> : BY CHECKING THIS BOX YOU ACKNOWLEDGE T APPROVAL PROCESS, AND FAILURE TO ADDRESS ANY OF IENIAL OF YOUR CASE.	HAT DUE TO THE PASS, STAFF'S COMMENTS BY	AGE OF <u>HB3167</u> THE CITY NO LONGER HAS FLEXII THE DATE PROVIDED ON THE DEVELOPMENT CALE	3ILITY WITH ENDAR WILL
OWNER/APPLICA	ANT/AGENT INFORMATION [PLEASE PRINT/CF			
	Reserve Capital - Rockwall Industrial SPE LLC	▼ APPLICANT		
	Justin Toon	CONTACT PERSON	Justin Toon	
ADDRESS	15110 Dallas Pkwy	ADDRESS	15110 Dallas Pkwy	
	P O Box 670551		P O Box 670551	
	Dallas, TX 75367	CITY, STATE & ZIP	Dallas, TX 75367	
	214-577-6789	PHONE	214-577-6789	
E-MAIL	justin@industrialreserve.net	E-MAIL	justin@industrialreserve.net	
	CATION [REQUIRED] RSIGNED AUTHORITY, ON THIS DAY PERSONALLY APPEARE ON ON THIS APPLICATION TO BE TRUE AND CERTIFIED THE		[OWNER] THE UNDERSIG	NED, WHO
S 100.00 March INFORMATION CONTAINE	I AM THE OWNER FOR THE PURPOSE OF THIS APPLICATION; A , TO COVER THE COST OF THIS APPLICATION, HA , 20 14. BY SIGNING THIS APPLICATION, I AGR D WITHIN THIS APPLICATION TO THE PUBLIC. THE CITY IS TION WITH THIS APPLICATION, IF SUCH REPRODUCTION IS ASSO	AS BEEN PAID TO THE CITY EE THAT THE CITY OF RO S ALSO AUTHORIZED AND	OF ROCKWALL ON THIS THE 1974 SHIFT OF THE 1974 OF THE	DAY OF
GIVEN UNDER MY HAND .	AND SEAL OF OFFICE ON THIS THE I UM DAY OF	reh 2021	JACKSON FREDERIC Notary ID #1346879 My Commission Exp December 20, 202	908 ires
NOTARY PUBLIC IN AND	FOR THE STATE OF TEXAS	ric		0/27






City of Rockwall Planning & Zoning Department 385 S. Goliad Street Rockwall, Texas 75087 (P): (972) 774 7745


(P): (972) 771-7745 (W): www.rockwall.com

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Sheet Number CASE NUMBER: SPXXXX-XXX

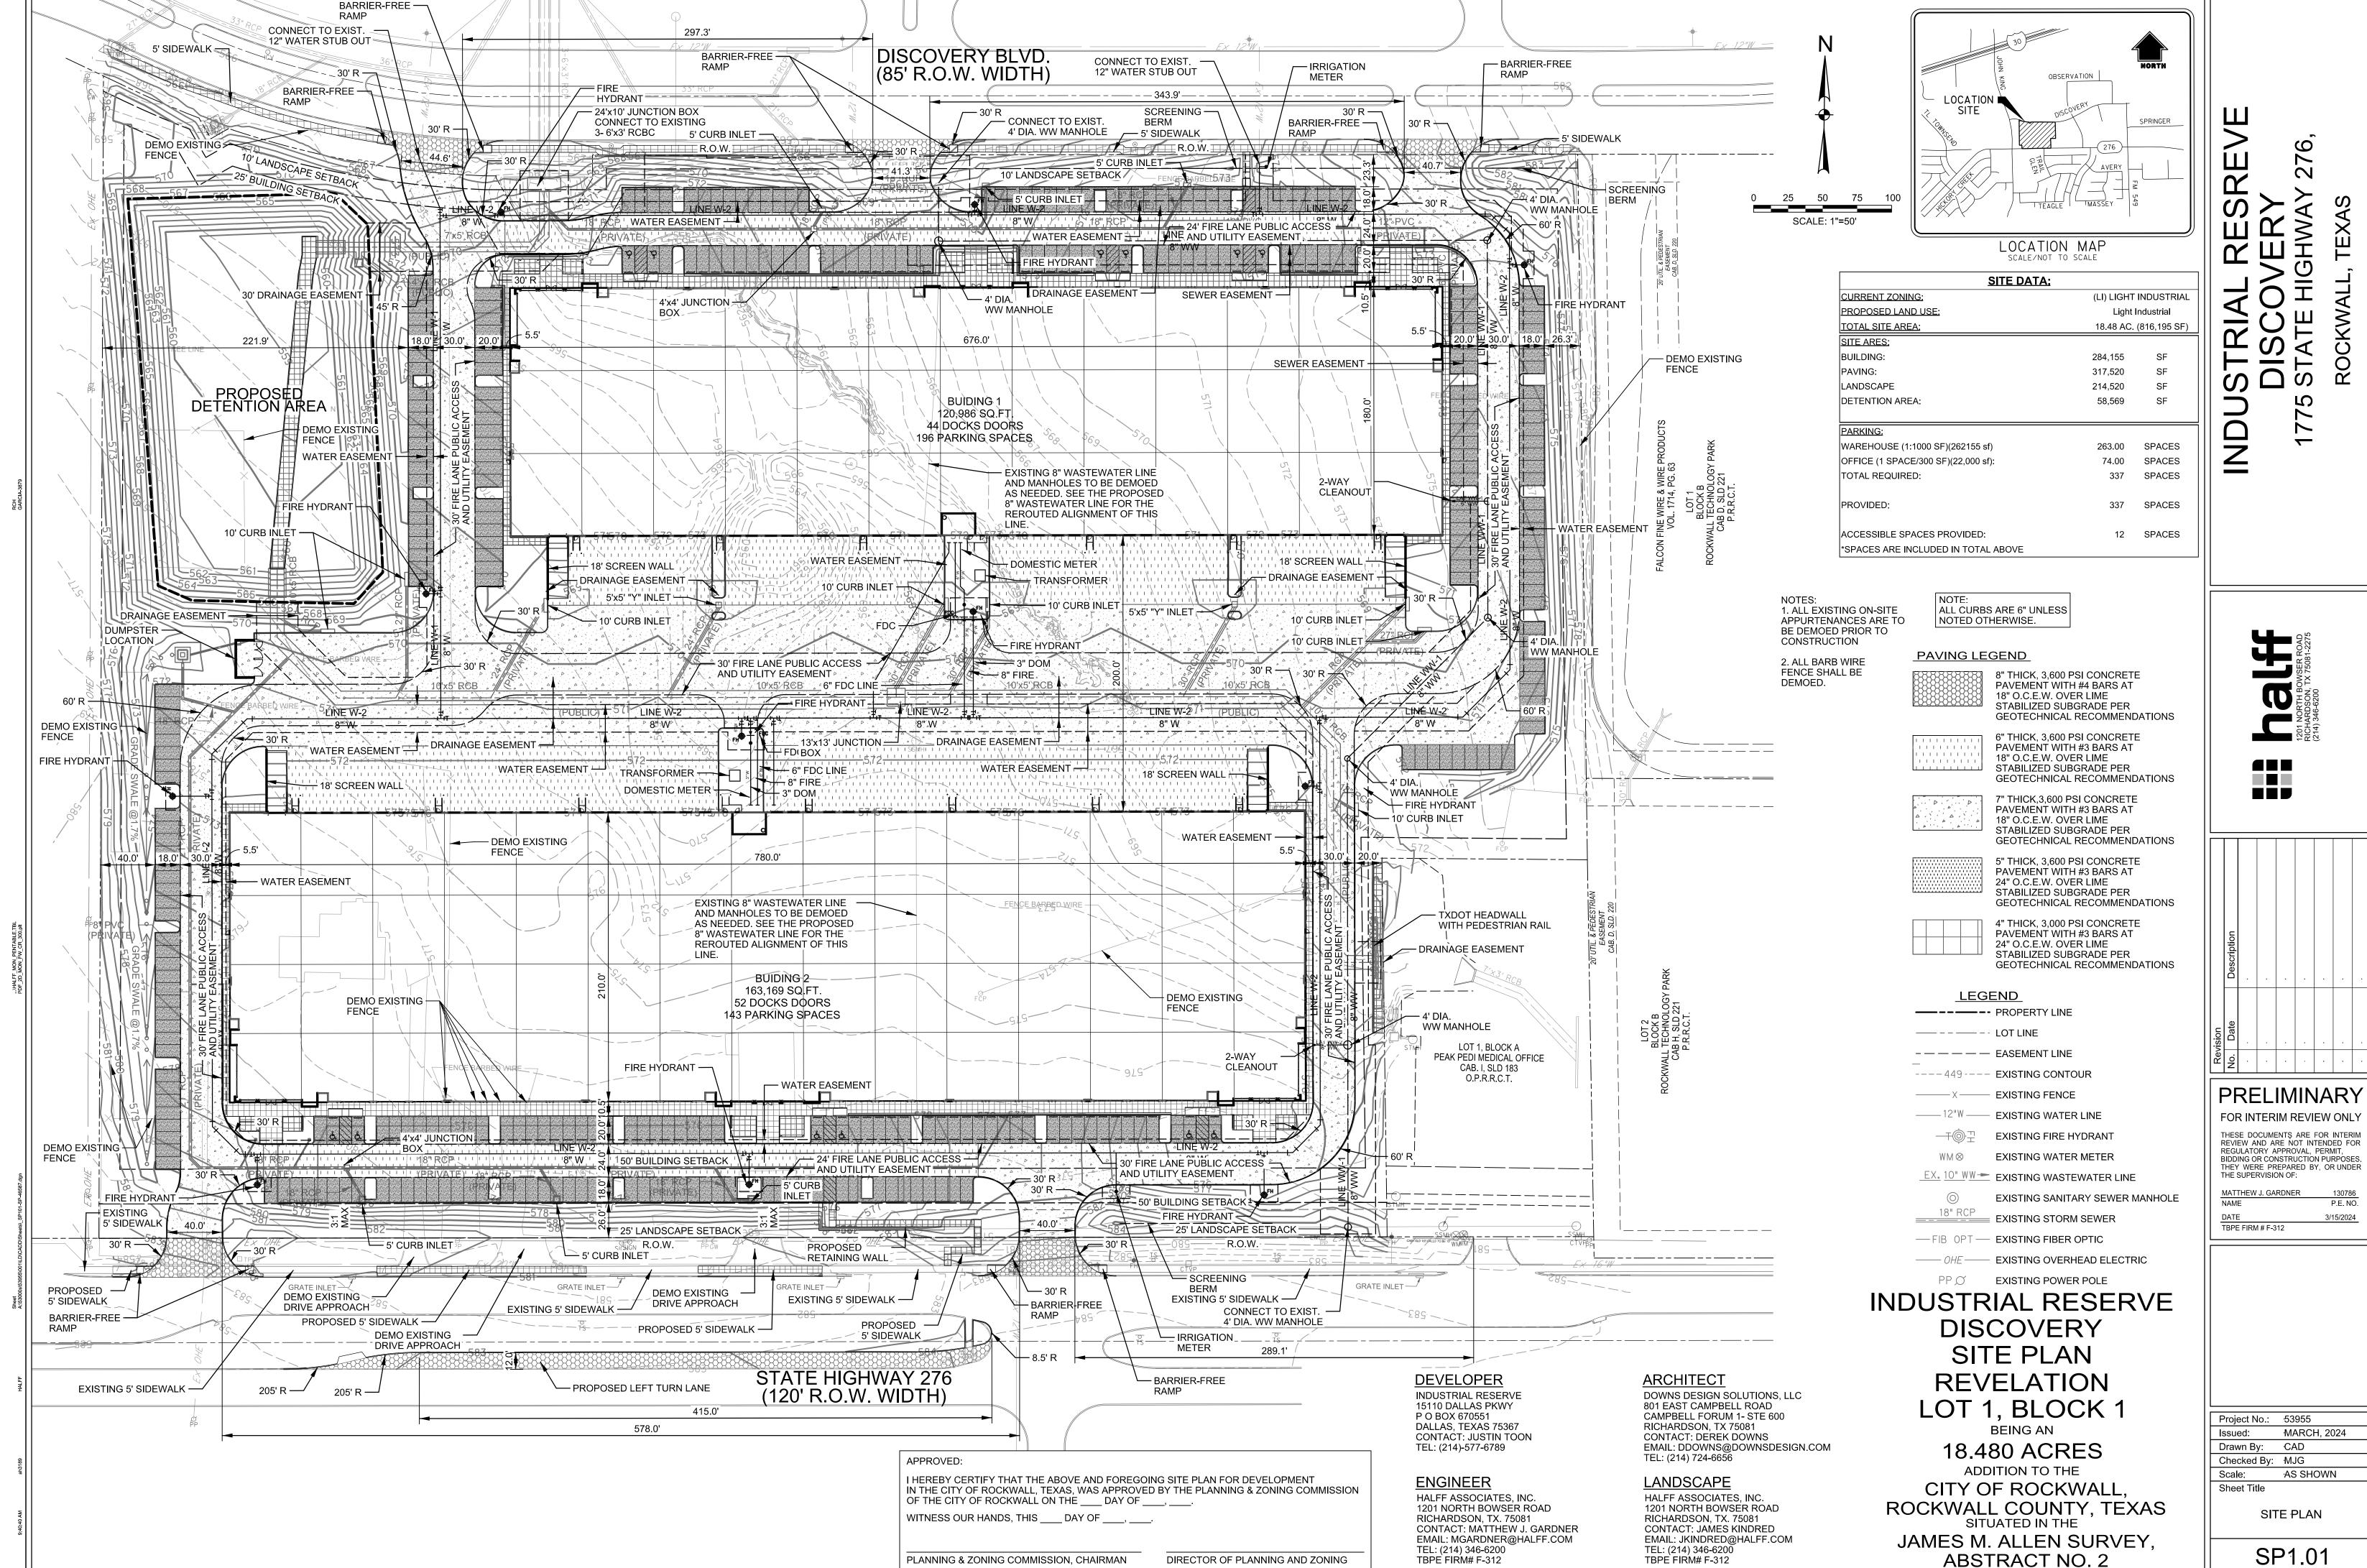

LANDSCAPE REQUIREMENTS for the City of Rockwall, TX

ARTICLE 08: LANDSCAPE AND FENCE STANDARDS

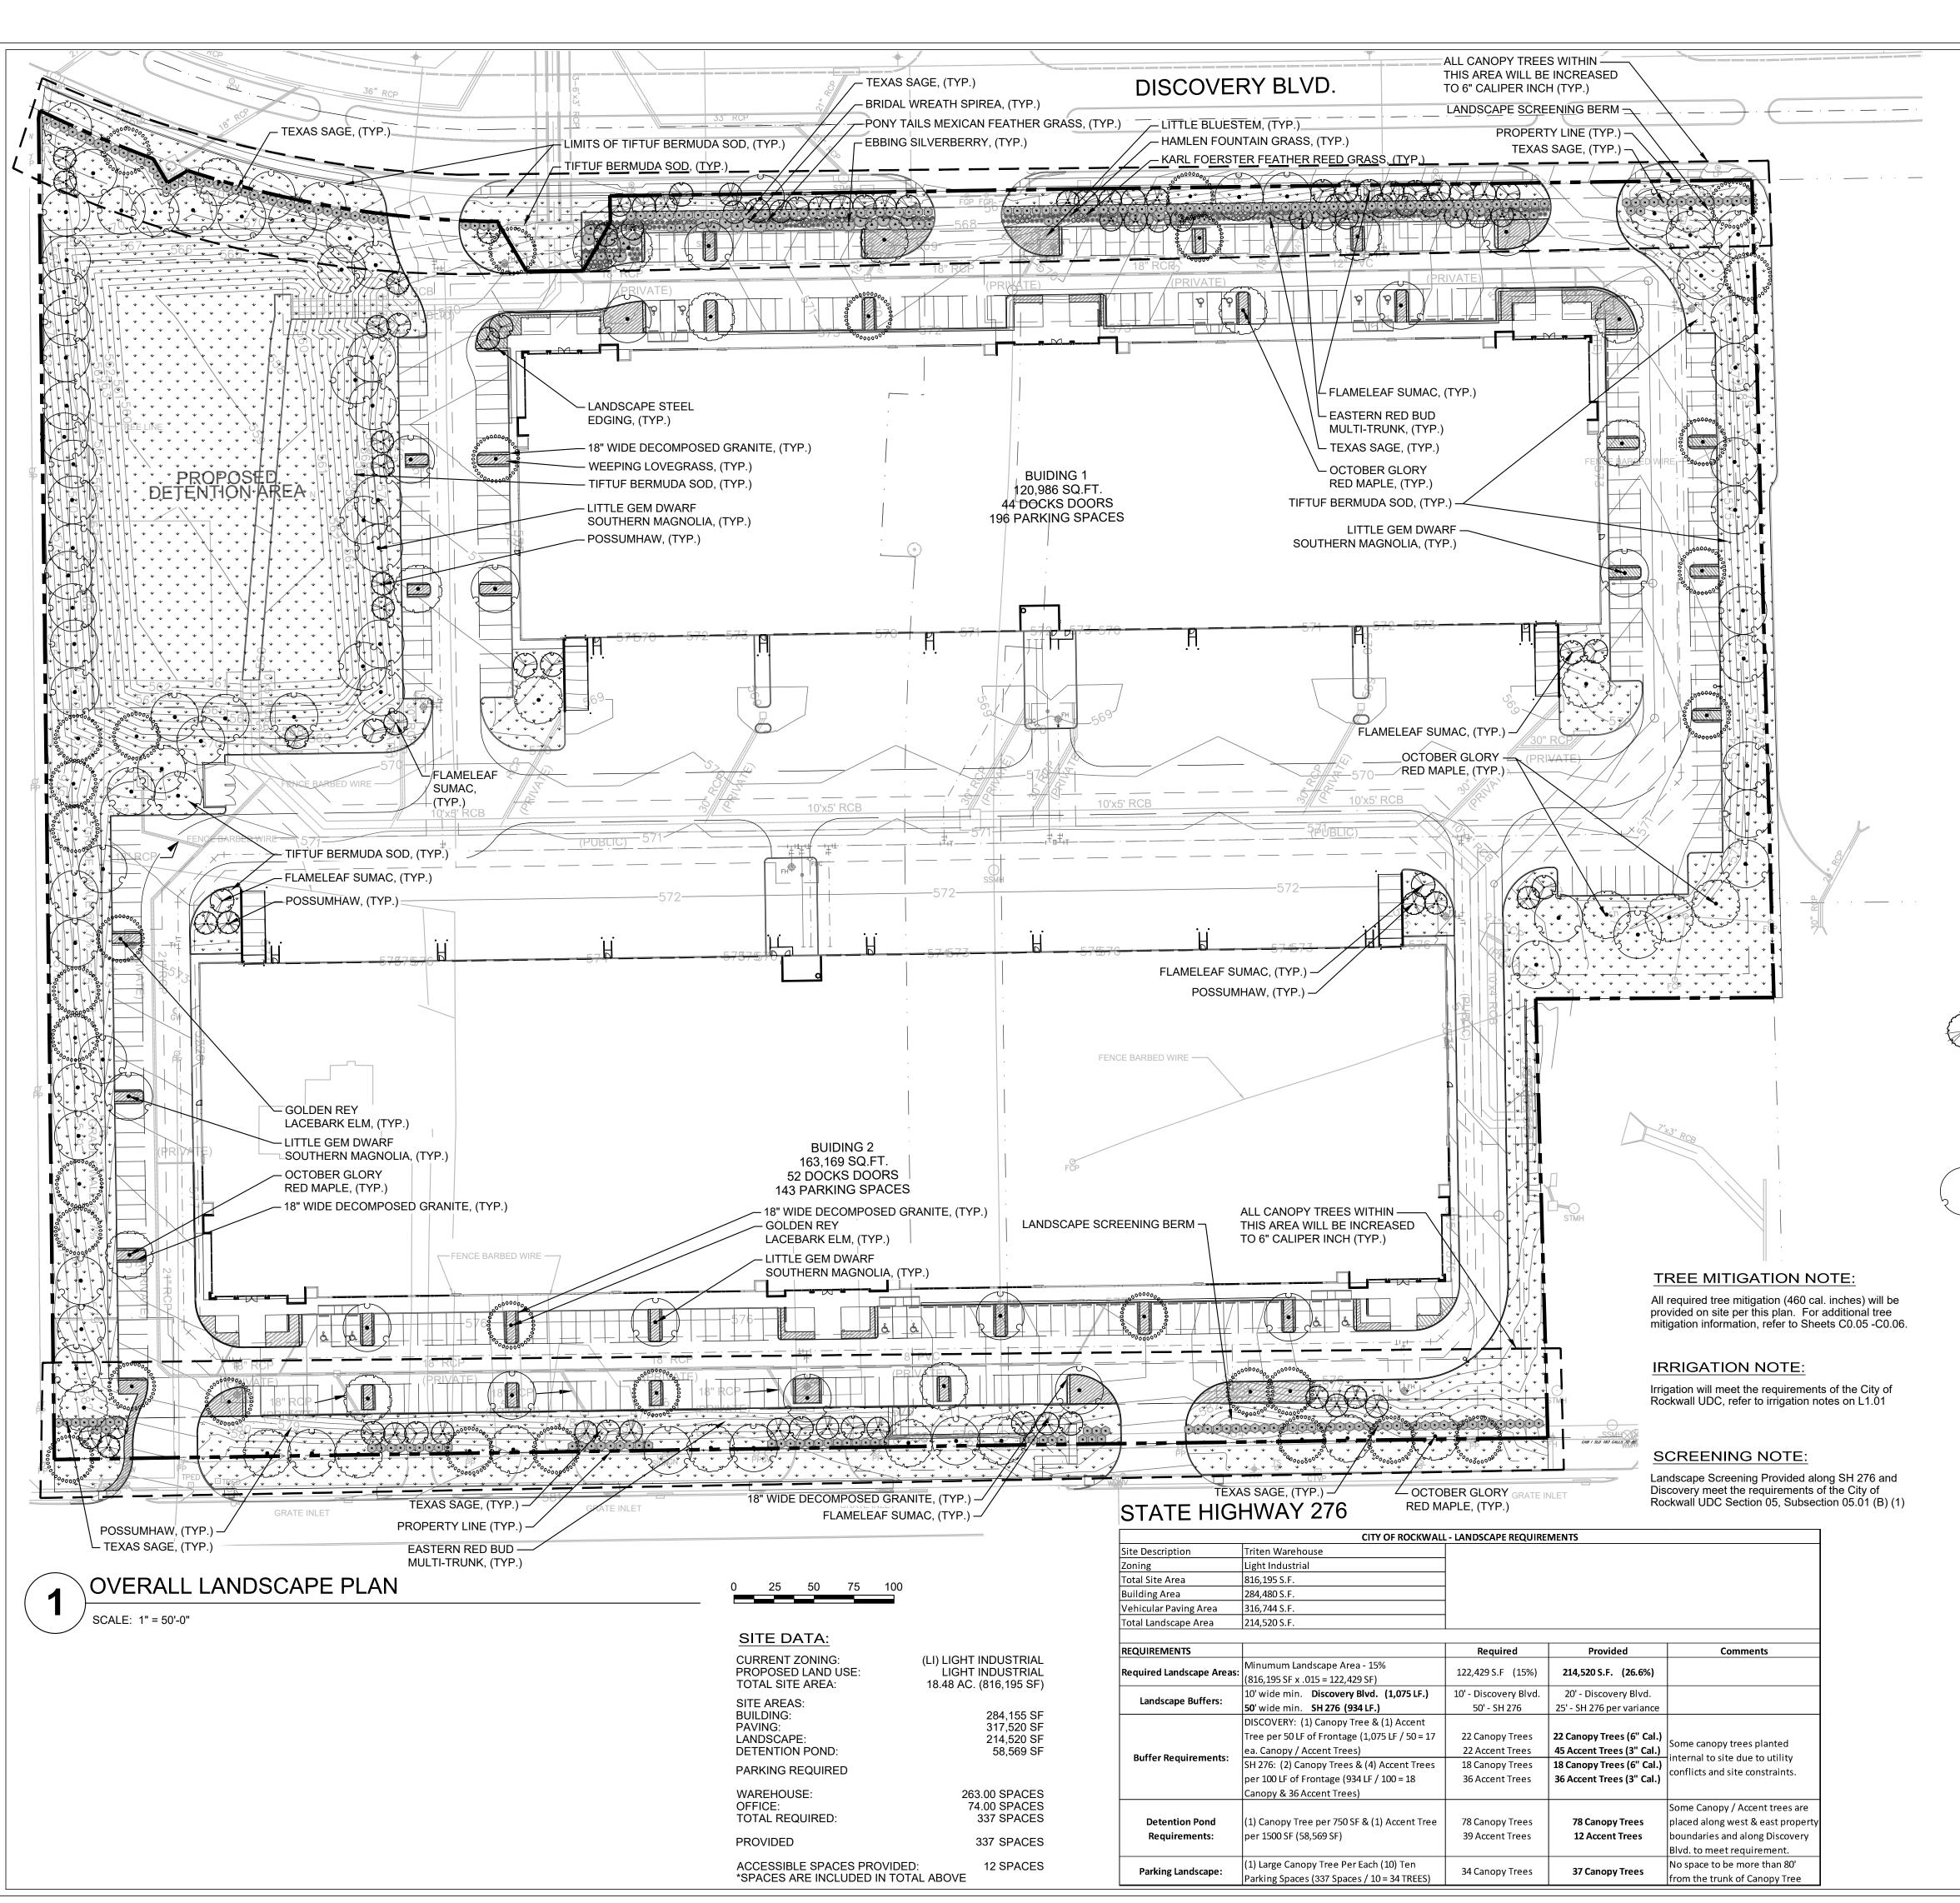SECTION 05: LANDSCAPE STANDARDS

SUBSECTION 05.01: LANDSCAPE BUFFERS

The minimum requirements for landscape buffers shall be as follows:

(B) <u>Non-Residential Landscape Buffers.</u> (see Figure 3: Commercial Landscape Buffers Example)) Abutting a Public Right-of-Way. A minimum of a ten (10) foot wide landscape buffer shall be required along the entire length of any non-residential lot that abuts a public right-of-way (i.e. collector street, arterial roadway, or alleyway) or a residentially zoned or used property that is located directly across a public street (regardless of the size of the street). All landscapebuffers adjacent to a public right-of-way shall incorporate ground cover, a built-up berm and shrubbery along the entire length of the frontage. Berms and shrubbery shall have a total minimum height of 30-inches. In these areas a minimum of one (1) canopy tree and one (1) accent tree shall be incorporated into the landscape buffer per 50-linear feet of frontage along the adjacency. Clustering of trees shall be permitted as long as all required trees are situated within the landscape buffer.

SUBSECTION 05.02: LANDSCAPE SCREENING

- (A) <u>Loading Docks and Outside Storage Areas.</u> Off-street loading docks and outside storage areas shall bE screened from all public streets, open space, adjacent properties and any residential zoning districts or residentially used properties that abut or are directly across a public street or alley from the loading dock or outside storage area in accordance with the requirements of Subsection 01.05, Screening Standards, of Article 05, District Development Standards (Screening Wall with Canopy Trees every 20' o.c.).
- (C) <u>Headlight Screening.</u> Head-in parking adjacent to a street shall incorporate one (1) of the following screening methods to mitigate the potential hazard that headlights may pose for on-street vehicular traffic:
- (1) Alternative #1. A minimum of a two (2) foot berm with mature evergreen shrubs along the entire adjacency of the parking areas.
- (2) Alternative #2. A wrought iron fence with a mix of two (2) rows of staggered mature evergreen trees and one (1) row of deciduous canopy trees (a minimum six [6] caliper inches) along the entire length of the adjacency. All trees will be planted on 20-foot centers.

SUBSECTION 05.03: LANDSCAPE REQUIREMENTS

- (A) <u>Amount of Landscaping.</u> The following landscaping percentages shall be required and shall apply to the total site area to be developed: Light Industrial (LI) District - Required Landscaping 15%.
- (B) Location of Landscaping. A minimum of 100% of the total required landscaping shall be located in front of and along the side of buildings with street frontages in the Heavy Commercial (HC), Light Industrial (LI), and Heavy Industrial (HI) Districts.
- (E) Parking Lot Landscaping. The following landscape requirements will apply to parking lots:
- (1) Parking lots with more than two (2) rows of parking spaces (i.e. one [1] drive isle with rows of parking on either side) shall have a minimum for five (5) percent or 200 SF of landscaping -- whichever is greater -- in the interior of the parking lot area. Such landscaping shall be counted toward the total required landscaping.
- (2) If the parking and maneuvering space exceeds 20,000 SF, one (1) large canopy tree for every ten (10) parking spaces shall be required to be planted internal to the parking areas. (3) No tree shall be planted closer than five (5) feet to the edge of pavement or five (5) feet from any water or wastewater line that is less than 12-inches. Water and wastewater lines that are 12-inches and greater require trees to be planted a minimum of ten (10) feet from the centerline of the pipe. (4) No required parking spaces may be located more than 80-feet from the trunk of a canopy tree.
- (G) <u>Landscaping in Landscape Buffers and Public Right-of-Way.</u> All landscape buffers and public right-of-way located adjacent to a proposed development shall be improved with grass (i.e. sod -- hydro mulch shall be prohibited in these areas) prior to the issuance of a Certificate of Occupancy (CO). In addition, it shall be the responsibility of the developer to design the irrigation system within the lot to ensure that the grass placed in public right-of-way is watered and maintained, and to ensure that minimal water will be shed on to the street. The designer of the irrigation system shall base the systems design on the ultimate proposed width of the street. The plans for design of the irrigation system shall be approved by the Building Inspections Department prior to installation and acceptance of the project.

LEGEND

SHADE TREE

ORNAMENTAL TREES COMMON / BOTANICAL NAME

Eastern Redbud Multi-trunk / Cercis canadensis

Flameleaf Sumac / Rhus Laneolata

October Glory Red Maple / Acer rubrum 'October Glory'

COMMON / BOTANICAL NAME

Possumhaw / Ilex decidua

Little Gem Dwarf Southern Magnolia / Magnolia grandiflora 'Little Gem'

Golden Rey Lacebark Elm / Ulmus parvifolia 'Golden Rey'

<u>SHRUBS</u> COMMON / BOTANICAL NAME

Ebbing Silverberry / Elaeagnus x ebbingei

Texas Sage / Leucophyllum frutescens Bridal Wreath Spirea / Spiraea prunifolia 'Bridalwreath'

ORNAMENTAL GRASSES COMMON / BOTANICAL NAME

Karl Foerster Feather Reed Grass / Calamagrostis x acutiflora 'Karl Foerster'

Hameln Fountain Grass / Pennisetum alopecuroides 'Hameln'

Little Bluestem / Schizachyrium scoparium

Pony Tails Mexican Feather Grass / Stipa tenuissima 'Pony Tails'

GROUND COVERS

Tiftuf Bermuda Grass / Cynodon dactylon (L.) Pers. × Cynodon transvaalensis Burtt Davy

COMMON / BOTANICAL NAME

Weeping Lovegrass / Eragrostis curvula

MISCELLANEOUS

COMMON / BOTANICAL NAME Decomposed Granite / -Native decompsed granite

Landscape Steel Edging

NORTH

Sheet Number

CASE NUMBER: SPXXXX-XXX

PRELIMINARY FOR INTERIM REVIEW ONLY THESE DOCUMENTS ARE FOR INTERIM REVIEW AND ARE NOT INTENDED FOR REGULATORY APPROVAL, PERMIT, BIDDING OR CONSTRUCTION PURPOSES. THEY WERE PREPARED BY OR UNDER THE SUPERVISION OF:

JAMES R. KINDRED R.L.A. NO. 03/15/2024

Project No.: 46587

MARCH, 2024 Issued: Drawn By: Checked By: JRK Scale: AS SHOWN

Sheet Title

LANDSCAPE PLAN

- 1. INSTALL STEEL EDGING TO UTILIZE FULL SECTIONS UNLESS CONTROLLED OTHERWISE WITH PLAN SHEET DIMENSIONS.
- 2. CUT STEEL EDGING AT AN ANGLE TO ACHIEVE A FINISHED STEEL EDGE HEIGHT OF 1/2" BELOW THE TOP OF ADJACENT HARDSCAPE.
- 3. IF STAKING IS NOT AVAILABLE WITHIN 12" OF THE EDGING TERMINATION, INSTALL A SPLICING EDGING STAKE WITHIN 6" OF THE TERMINATING EDGE AS SHOWN WITH OPTION 'B'
- 4. WHERE POSSIBLE, EDGE TERMINATION SHALL BE INSTALLED AS SHOWN IN TERMINUS OPTION 'A'.

D = DIMENSION OF PLANT SPACING (SHRUB AND GROUNDCOVER AS INDICATED ON DRAWINGS) - IF SHRUB IS BALL AND BURLAP, THEN REMOVE BURLAP AND ROPE FROM TOP 1/3 OF ROOTBALL - AMENDED SOIL BACKFILL TO REMOVE ALL 3" LAYER OF - DECOMPOSED GRANITE 4" LAYER OF MULCH

OVER WEED BLOCK OVER WEED BLOCK PIT PLANTED UNDISTURBED SUBGRADE 4" STEEL EDGE - AS SHOWN BREAK THROUGH AND REMOVE ANY EXISTING IN LANDSCAPE PLAN -

1. SEE LANDSCAPE NOTES FOR THE TYPE OF WEED BLOCK AND MULCH MATERIAL TO USE. 2. OMIT WEED BLOCK WHEN PLANT SPACING IS 18" O.C. OR LESS

"HARDPAN" AS NECESSARY TO PROVIDE GOOD PERCOLATION AND POSITIVE DRAINAGE

N.T.S.

SHRUB PLANTING AND SPACING

(REF. LANDSCAPE PROJECT NOTES)

TREE PLANTING


*FOR ALL MAPLE TREE INSTALLATIONS:

MAXIMUM OF 24 MONTHS.

WRAP TRUNKS WITH A BURLAP TREE BARK WRAP


TO PREVENT SUN SCALD. WRAP IS TO REMAIN IN PLACE FOR A MINIMUM OF 12 MONTHS AND A

STEEL EDGE TERMINATION

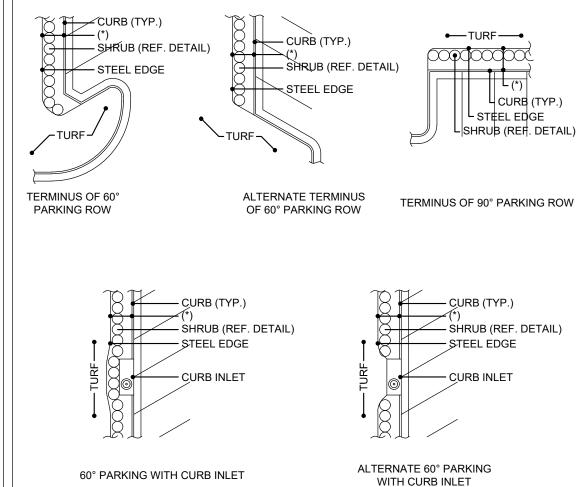


(*) SEE SHRUB PLANTING DETAIL FOR DIMENSIONS. REFERENCE PLANT MATERIAL LIST FOR PLANT TYPES AND LOCATIONS.


GENERAL STEEL EDGE ALIGNMENT EXAMPLES

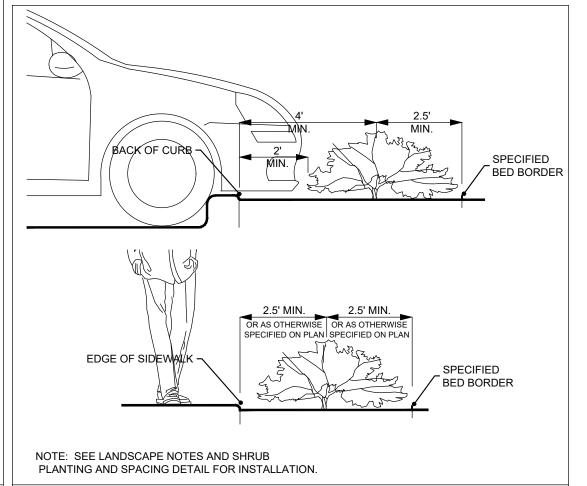

N.T.S.

SHRUB DISTANCE FROM EDGE OF BED

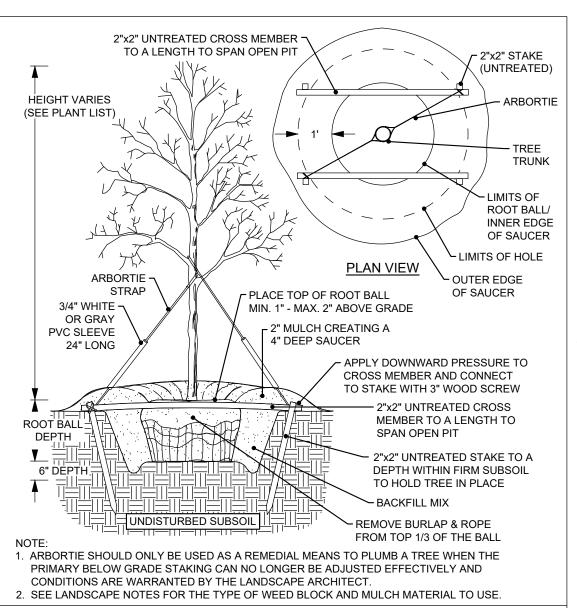

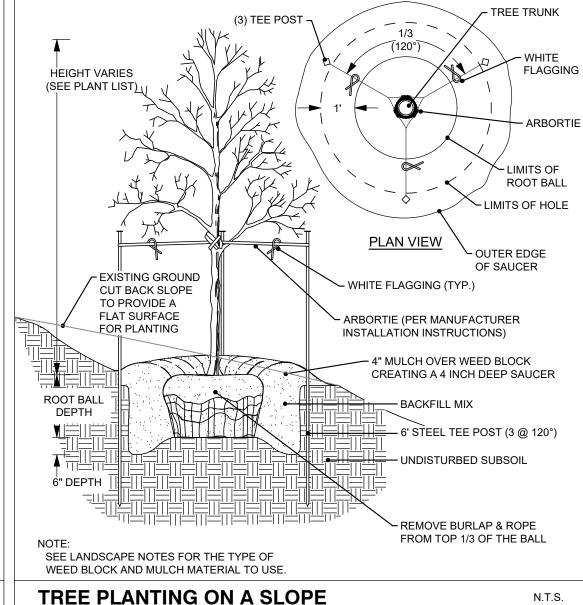

IRRIGATION NOTES SUBSECTION 05.04: IRRIGATION REQUIREMENTS (A) <u>General Irrigation Requirements.</u> The owner shall be responsible for the health and vitality of plant material through the irrigation of all landscaped areas, turf and plant materials, and shall: (1) Provide a moisture level in an amount and frequency adequate to sustain growth of the plant materials on a permanent basis. (2) Be in place and operational at the time of the landscape inspection for Certificate of Occupancy (CO). (3) Be maintained and kept operational at all times to provide for efficient water distribution. (1) <u>Landscaped Areas.</u> One (1) of the following irrigation methods shall be used to ensure adequate watering of plant material in landscaped areas: (a) <u>Conventional System.</u> An automatic or manual underground irrigation system that may be a onventional spray or bubbler type heads. (b) <u>Drip or Leaky-Pipe System.</u> An automatic or manual underground irrigation system in conjunction with a watersaving system such as a drip or a leaky pipe system. (c) <u>Temporary and Aboveground Watering</u>. Landscape areas utilizing xeriscape plants and installation techniques, including areas planted with native grasses and wildflowers, may use a temporary and above ground system, and shall be required to provide irrigation for the first two (2) growing seasons only. (2) <u>Natural and Undisturbed Areas.</u> No irrigation shall be required for undisturbed natural areas or (3) <u>Compliance with State Law.</u> All irrigation systems shall comply with the irrigation code of <u>Chapter 10</u>, Buildings and Building Regulations, Article XVI, Irrigation Code, of the City of Rockwall Code of Ordinances, and all applicable state laws, as may be amended.

ORNAMENTAL TREES	QTY	BOTANICAL / COMMON NAME	CONT	CAL	REMARKS
	28	Cercis canadensis / Eastern Redbud Multi-trunk	B&B/Cont.	3" Cal	8' HT Minimum, Full Canopy, Healthy, Good Form, Strong Central Leader.
	38	Rhus lanceolota / Flameleaf Sumac	B&B/Cont.	3" Cal	8' HT Minimum, Full Canopy, Healthy, Good Form, Strong Central Leader.
	27	Ilex decidua / Possumhaw	B&B/Cont.	3" Cal	8' HT Minimum, Full Canopy, Healthy, Good Form, Strong Central Leader.
SHADE TREE	QTY	BOTANICAL / COMMON NAME	CONT	CAL	REMARKS
	27	Acer rubrum 'October Glory' / October Glory Red Maple	B&B/Cont.	4" Cal 6" Cal in Buffer Zone	12' HT Minimum, Full Canopy, Healthy, Good Form, Strong Central Leader.
	90	Magnolia grandiflora 'Little Gem' / Little Gem Dwarf Southern Magnolia	B&B/Cont.	4" Cal 6" Cal in Buffer Zone	12' HT Minimum, Full Canopy, Healthy, Good Form, Strong Central Leader.
0000000000000000000000000000000000000	33	Ulmus parvifolia 'Golden Rey' / Golden Rey Lacebark Elm	B&B/Cont.	4" Cal 6" Cal in Buffer Zone	12' HT Minimum, Full Canopy, Healthy, Good Form, Strong Central Leader.
SHRUBS	QTY	BOTANICAL / COMMON NAME	CONT	SIZE	REMARKS
	24	Elaeagnus x ebbingei / Ebbing Silverberry	5 gal	4`-8` HT 6`-8` SPD	
	268	Leucophyllum frutescens / Texas Sage	5 gal	4`-8` HT 4`-6` SPD	
•	16	Spiraea prunifolia 'Bridalwreath' / Bridal Wreath Spirea	5 gal	4`-8` HT 6`-8` SPD	
ORNAMENTAL GRASSES	QTY	BOTANICAL / COMMON NAME	CONT	SIZE	REMARKS
mure market	48	Calamagrostis x acutiflora 'Karl Foerster' / Karl Foerster Feather Reed Grass	5 gal	2`-6` HT 36" O.C.	
*	81	Pennisetum alopecuroides 'Hameln' / Hameln Fountain Grass	5 gal	2`-3` 1`-3` Spd	
Hard Hard Hard Hard Hard Hard Hard Hard	77	Schizachyrium scoparium / Little Bluestem	5 gal	3`-4` 12"-18" Spd	
	38	Stipa tenuissima 'Pony Tails' / Pony Tails Mexican Feather Grass	5 gal	1`-2` Ht 36" O.C	
GROUND COVERS	QTY	BOTANICAL / COMMON NAME	CONT	SIZE	
· · · · · · · · · · · · · · · · · · ·	197,277 sf	Cynodon dactylon (L.) Pers. × Cynodon transvaalensis Burtt Davy / Tiftuf Bermuda Grass	Sod		
	9,930 sf	Eragrostis curvula / Weeping Lovegrass	3 gal		
MISCELLANEOUS	QTY	BOTANICAL / COMMON NAME	CONT	SIZE	
ADES ADES ADES ADES ADES DE 300 DE	1,520 sf	-Native decompsed granite / Decomposed Granite	flat		
	2,442 LF	Landscape Steel Edging			

LANDSCAPE PROJECT NOTES

Refer to Sitework Specifications for all information needed for landscape work.

Notify Landscape Architect or designated representative of any layout discrepancies or any condition which may prohibit the installation as shown.

Verify and locate all utilities and site lighting conduits before landscape construction begins. Protection of all utilities is the responsibility of the Contractor.

All landscape planting areas illustrated shall be graded smooth with three inches (3") of topsoil and three inches (3") of compost applied and consistently blended (tilled) to a depth of nine inches (9"). If adequate or sufficient topsoil is not available on site, the Contractor shall provide topsoil per the specifications and approved by the Owner. To obtain final grade, excavation may be necessary to accept the required depth of opsoil/compost mix with surface dressing or mulch. All beds shall be crowned to anticipate settlement and ensure drainage without disrupting surrounding planned drainage paths. Any areas disturbed for any reason prior to final acceptance of the project shall be corrected by the Contractor at no additional expense to the Owner.

All landscaped areas will be irrigated with an underground automatic system.

Quantities shown on these plans are for reference only. Plant spacing is as indicated in the Plant Material List unless otherwise noted. The Contractor has full responsibility to provide coverage in all planting areas as specified.

All trees and shrubs shall be installed per planting details.

Trees shall be planted at least five feet (5') from any utility line or sidewalk, to the outside of utility easements with a clear ten feet (10') around fire hydrants and twenty feet (20') min. from all irrigation control zone meter boxes. Furthermore, planting within areas of turf shall give priority of location to irrigation. Trees, shall not be planted within five feet (5') of a spray head or ten feet (10') of a rotor. Remaining irrigation components shall respect the location of the illustrated landscape design. Shrubs, regardless of type, shall not be planted within thirty inches (30") of bed

All plant material shall be maintained in a healthy and growing condition, and must be replaced with similar variety and size if damaged or removed. Container grown plant material is preferred, however ball and burlap material may be substituted as indicated in the plant material list.

All planting beds as designated shall be bordered by Owner approved four inch (4") steel edging w/ $\frac{3}{16}$ " min. thickness unless bed is bordered by concrete. Steel edging adjacent to decomposed granite beds shall have a 1/4" min. thickness. Terminate edging flush with paved surface with no sharp corners exposed.

A four inch (4") dressing of Shredded hardwood mulch over a 4.1 oz, woven polypropylene, needle-punched fabric or equal weed barrier shall be used in all plant beds and around all trees and within all beds with plants spaced 18" o.c. or greater. Single trees or shrubs shall be mulched to the outside edge of the saucer or landscape island (See planting details).

Fertilize all plants at the time of planting with 10-10-10 time release fertilizer.

All areas of decomposed granite shall be over a 4.1 oz, woven polypropylene, needle-punched fabric or equal weed barrier of locally available material, installed to a compacted depth of three inches (3") to be flush with the top of curb, paved surface, and/or the top of steel edge.

TURF PROJECT NOTES

EROSION CONTROL:

Γhroughout the project and the maintenance period for turfgrass, it is the Contractor's responsibility to maintain the topsoil in place at specified grades. Topsoil and turfgrass losses due to erosion or any construction disturbance will be replaced by the Contractor until ESTABLISHMENT and ACCEPTANCE is

SOIL PREPARATION

All slopes and areas disturbed by construction, except those occupied by buildings, structures, or paving shall be graded smooth and four (4") inches of topsoil applied. If adequate topsoil is not available onsite, the Contractor shall provide topsoil as approved by the Owner. The area shall be dressed to typical sections and plowed to a depth of five (5") inches. Soil shall be further prepared by the removal of debris, weeds and stones larger than 3/4 inch in diameter. After tillage and cleaning, all areas to receive turf shall be leveled, fine graded, and drug with a weighted spike harrow or float drag. The top two (2") inches shall be pulverized to provide a uniform bed for seeding or sod as described below.

At a minimum, three feet (3') of solid sod shall be installed along all impervious edges. This includes, but is not limited to: curbing, sidewalks, building foundation, storm water inlets, manholes, and planting bed perimeter treatments. Additional areas of sod installation will be as indicated on the design plans. All areas from back of curb within the roadway ROWs and 10' Landscape Buffer shall be sod. Should installation occur between November and March, sod shall include an over-seed of Annual Rye for a grown-in appearance.

SPRING AND SUMMER PERMANENT GRASSING (May 15 through September 15): Hydromulch seed with hulled Common Bermuda at a rate of 4 lbs/1000 sf. Seeding shall be accomplished immediately after bed preparation. Hydroseed mixture shall contain cellulose mulch applied at a rate of 2000 lbs/acre, with a maximum of 50 lbs/100 gallons of water. If seeding is delayed after mixing 0.5 - 2 hours, add 50% seed mix. If delay is longer than 2 hours, begin with new mixture.

FALL AND WINTER TEMPORARY GRASSING (September 15 through May 15): Seed with annual rye at a rate of 10 lbs/1000 sf. After May 15, Contractor shall remove rye to effectively establish permanent seeding.

IRRIGATION:
In the absence of an irrigation system or areas beyond the coverage limits of a permanent irrigation system, Contractor shall water sod/seed temporarily to develop adequate growth and establishment before regular maintenance begins. Turf shall be watered until firmly established.

Water shall be furnished by the Contractor with means and methods available to achieve acceptable turf. The water source shall be clean and free of industrial wastes or other substances harmful to the growth of the turf.

MAINTENANCE REQUIREMENTS:

Vegetation should be inspected regularly to ensure that plant material is established properly and remains healthy. Mowing, trimming and supervision of water applications shall be the responsibility of the Contractor until the Owner or Owner's Representative accepts and assumes regular maintenance.

ESTABLISHMENT AND ACCEPTANCE:

All disturbed areas being seeded shall receive topsoil as specified and be adequately established with turf such that any absence of water will not kill the turf, but promote a state of turf dormancy, until the next rainfall event.

Regardless of unseasonable climatic conditions or other adverse conditions affecting planting operations and the growth of the turf grass, it shall be the sole responsibility of the Contractor to establish a uniform stand of grass. UNIFORM STAND OF GRASS is defined as minimum 80% coverage per square foot (no bare areas).

Contractor to make a written request for inspection to Owner or Owner's representative a minimum of 5 days prior to the anticipated inspection date.



THESE DOCUMENTS ARE FOR INTERIM REVIEW AND ARE NOT INTENDED FOR REGULATORY APPROVAL, PERMIT, BIDDING OR CONSTRUCTION PURPOSES. THEY

SUPERVISION OF: JAMES R. KINDRED 2255 R.L.A. NO.

WERE PREPARED BY OR UNDER THE


03/15/2024

Project No.: 46587 MARCH, 2024 Issued:

Drawn By: СP Checked By: JRK Scale: AS SHOWN Sheet Title

LANDSCAPE NOTES AND DETAILS

Sheet Number CASE NUMBER: SPXXXX-XXX

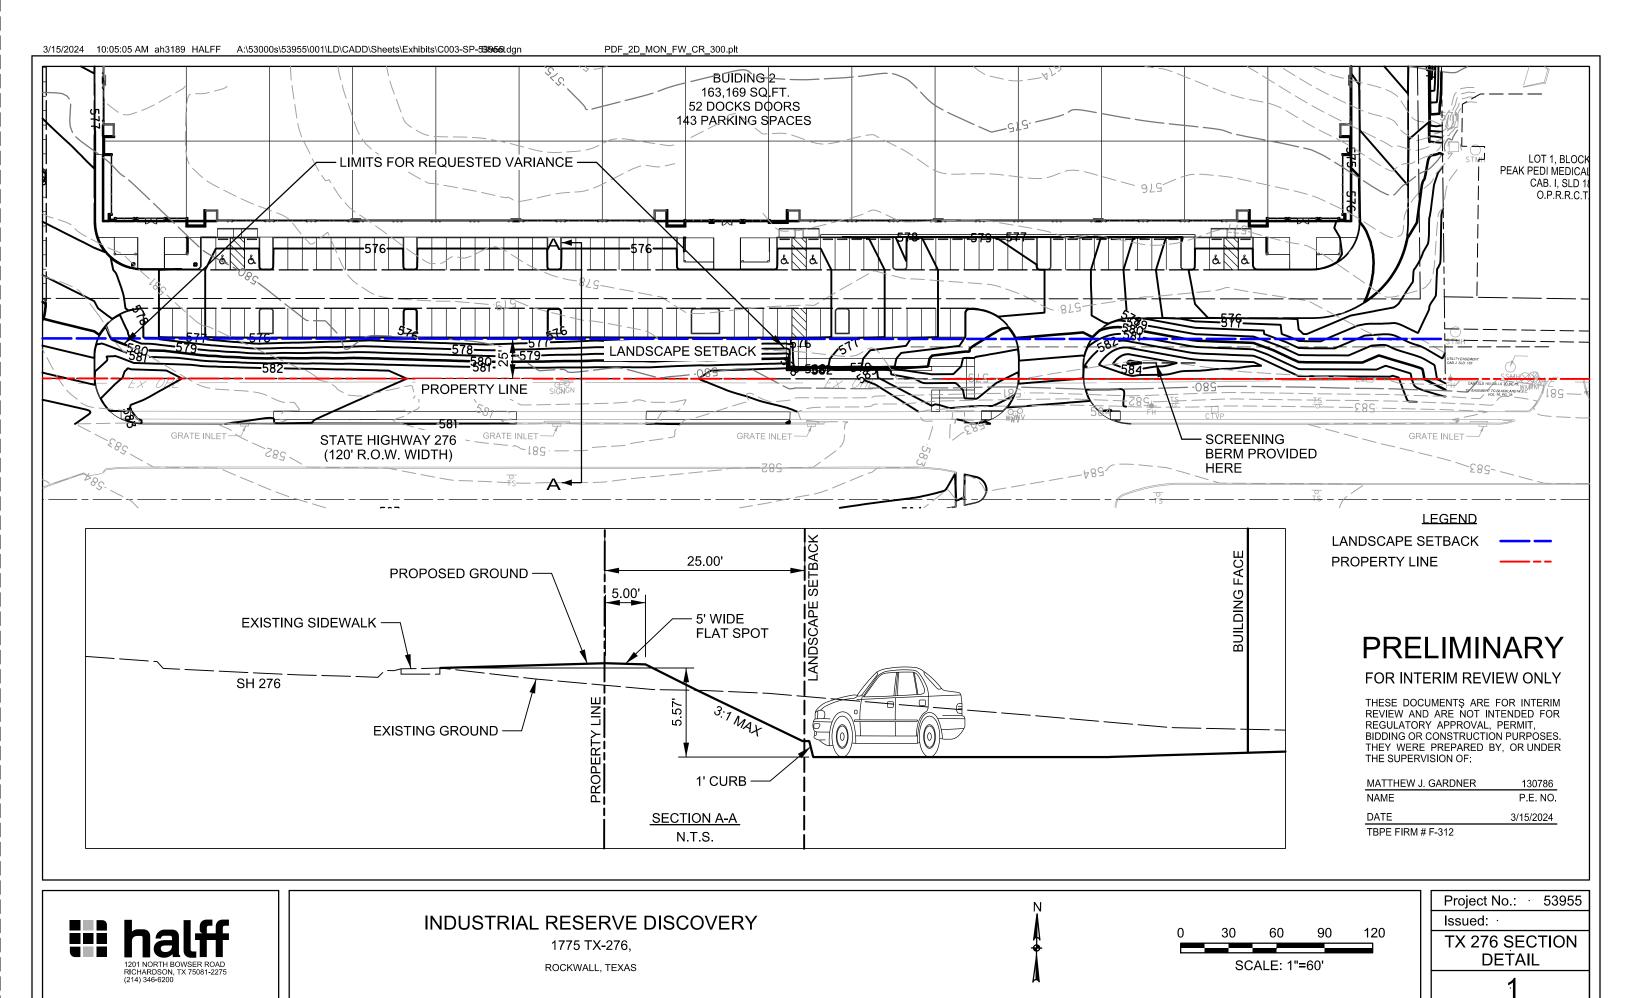



March 15, 2024 AVO 53955

City of Rockwall Planning and Zoning 385 S Goliad St Rockwall, TX 75087

RE: VARIANCE REQUEST: Industrial Reserve Discovery Rockwall

Rockwall, TX

Dear reviewer.

Industrial Reserve would like to request a variance to the minimum ground cover requirements within landscape buffers adjacent to Primary Roadways and specific to the SH-276 Overlay District, as detailed in Subsection 06.02 (E) of the City of Rockwall Unified Development Code. The Unified Development Code requires a built-up berm and shrubbery, or combination thereof, along the length of the frontage where the berm is 30 - 48 inches in height as measured from the primary roadway elevation. Based on our interpretation of the code requirements we believe that the intent and purpose of the required ground cover screening can be met with an alternative landscaping layout that still provides the required shrubbery and trees but eliminates the built-up berm. Below are key points to the proposed site conditions and proposed justification to providing the variance as requested.

Proposed Site Conditions:

- 1) Please refer to the included amended "Site Plan".
- 2) The car parking for this proposed site development is several feet lower in elevation when compared to the existing primary roadway (SH-276). The parking is on average about 5.5 ft lower that SH-276. Due to this height difference, providing a minimum 30-inch-tall berm along the frontage road creates the need to add over 400 ft of retaining wall that averages 7 ft in height. The additional height difference created by the berm and limited space to make up the grades is what drives the need for the wall.
- The reason the car parking sits several feet lower than SH-276 is due to grading requirements of the intended site layout and the intent to provide a balanced site for dirt import/export.

Proposed Variance

- 1) Please refer to the included attachment labeled "TX 276 SECTION DETAIL".
- 2) The proposed variance to the code requirement is to eliminate the built-up berm. The shrubbery and trees would still be provided as required. It is our interpretation of the code that the landscape berm provides ground cover for both screening and aesthetic purposes. The requirement as detailed within the code has a more practical application to sites that are at or above the adjacent roadway elevation. This site sits several feet below and per this site's conditions, we believe the intent of the requirement can be met without the berm.
- 3) Any vehicles navigating within this site's car parking and facing towards SH-276 would have their headlights screened with the over 5 ft elevation difference between the car parking and the public roadway. This elevation difference is already greater than the 30-inch berm height denoted in the code requirement and thus already provides more screening than is needed. The addition of the 30" berm does not increase the functionality for the screening intent as over 30" of screening are already being provided.

If you have any questions or need any additional information, please call me at your convenience 214-217-6622.

Sincerely,

HALFF

Jose Garcia, PE

facl Loris fo

Halff Phone: 214.346.6200 Fax: 214.739.0095



CITY OF ROCKWALL

PLANNING AND ZONING COMMISSION MEMORANDUM

PLANNING AND ZONING DEPARTMENT

385 S. GOLIAD STREET • ROCKWALL, TX 75087 PHONE: (972) 771-7745 • EMAIL: PLANNING@ROCKWALL.COM

TO: Planning and Zoning Commission

FROM: Bethany Ross, Planner

DATE: April 9, 2024

SUBJECT: SP2024-009; Amended Site Plan for 1775 SH-276

The applicant, Justin Toon of Industrial Reserve, is requesting the approval of an *Amended Site Plan* for the purpose of requesting a variance to the berm requirement along SH-276. The subject property is an 18.48-acre parcel of land located at 1775 SH-276, zoned Light Industrial (LI) District, and situated within the SH-276 Overlay (SH-276 OV) District. On July 26, 2022, the Planning and Zoning Commission approved a site plan [Case No. SP2022-037] allowing the construction of a Warehouse/Distribution Center consisting of two (2) buildings (i.e. a 163,500 SF building and a 121,680 SF building) on the subject property. On March 15, 2024, the applicant submitted an application for an amended site plan detailing an alternative to the required berm along SH-276.

According to Subsection 06.06, General Overlay District Standards, of Article 05, District Development Standards, of the Unified Development Code (UDC), "...(a)ll landscape buffers shall incorporate ground cover, a built-up berm and shrubbery or a combination thereof along the entire length of the frontage. Berms and shrubbery shall each have a minimum height of 30inches and a maximum height of 48- inches. In addition, two (2) canopy trees and four (4) accent trees shall be planted per 100-feet of linear frontage along the Primary Roadway." In this case, the elevation of the parking lot adjacent to SH-276 is an average of seven (7) foot lower than the elevation of SH-276. Subsection 09, Exceptions and Variances, of the Unified Development Code (UDC) does grant the Planning and Zoning Commission the ability to grant exceptions and variances where "...strict adherence to the technical requirements of the Unified Development Code (UDC) would create an undue hardship." Typically, the code requires that variances and exceptions be supported by a minimum of two (2) compensatory measures that directly off-set the impact of the proposed variance. In this case, the applicant is proposing that in lieu of the berm, the current conditions of the site will meet the intent of the requirement for a berm and is not proposing any additional compensatory measures. It should be noted that in conjunction with the previously approved site plan, the applicant has provided six (6) compensatory measures for the six (6) variances approved. These compensatory measures are [1] increased six (6) inch caliper trees along SH-276, [2] increased six (6) inch caliper trees along Discovery Boulevard, [3] a 20-foot landscape buffer along Discovery Boulevard in lieu of the required ten (10) foot landscape buffer. [4] a total landscaped area that exceeds the minimum requirements, [5] additional storefront windows/glass entrance doors in two (2) locations along the front façade, and [6] an additional architectural element over what is required. With this being said, requests for exceptions and variances are discretionary decisions for the Planning and Zoning Commission. Should the Planning and Zoning Commission have any questions concerning the applicant's request, staff and the applicant will be available at the April 9, 2024 Planning and Zoning Commission meeting.



DEVELOPMENT APPLICATION

City of Rockwall Planning and Zoning Department 385 S. Goliad Street Rockwall, Texas 75087

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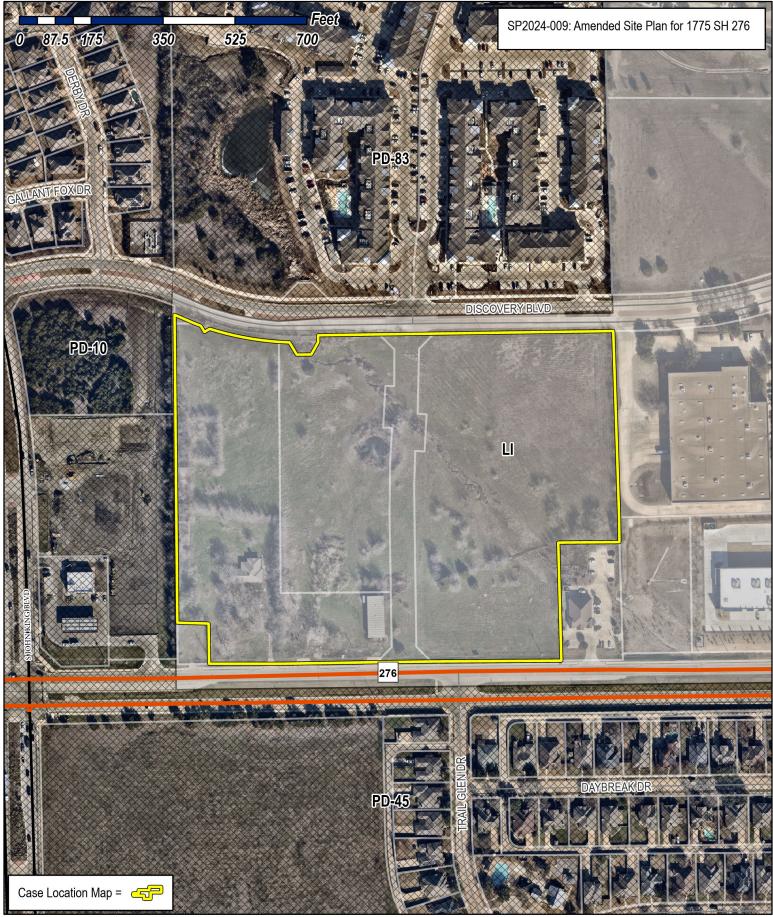
PLANNING & ZONING CASE NO.

<u>NOTE:</u> THE APPLICATION IS NOT CONSIDERED ACCEPTED BY THE CITY UNTIL THE PLANNING DIRECTOR AND CITY ENGINEER HAVE SIGNED BELOW.

DIRECTOR OF PLANNING:

CITY ENGINEER:

PLEASE CHECK THE	APPROPRIATE BOX BELOW TO INDICATE THE TYPE C	F DEVELOPMENT REC	QUEST [SELECT ONLY ONE BOX]:	
☐ PRELIMINARY F ☐ FINAL PLAT (\$30.0 ☐ REPLAT (\$300.0 ☐ AMENDING OR ☐ PLAT REINSTAT SITE PLAN APPLIC ☐ SITE PLAN (\$250	\$100.00 + \$15.00 ACRE) 1 PLAT (\$200.00 + \$15.00 ACRE) 1 00.00 + \$20.00 ACRE) 1 10 + \$20.00 ACRE) 1 MINOR PLAT (\$150.00) FEMENT REQUEST (\$100.00)	☐ SPECIFIC US ☐ PD DEVELOP OTHER APPLICA ☐ TREE REMON ☐ VARIANCE R NOTES: ¹: IN DETERMINING TH PER ACRE AMOUNT. ²: A \$1,000.00 FEE V	NGE (\$200.00 + \$15.00 ACRE) ¹ SE PERMIT (\$200.00 + \$15.00 ACRE) ^{1 & 2} PMENT PLANS (\$200.00 + \$15.00 ACRE) ¹ ATION FEES:	(1) ACRE. EST THAT
PROPERTY INFO	DRMATION [PLEASE PRINT]			
ADDRESS	1775 State Highway 276, Rockwa	II, TX 75032		
SUBDIVISION	Revelation		LOT 1 BLOCK	1
GENERAL LOCATION	Tract East of John King Blvd. betv	veen Discovery	Blvd. & State Highway 276	
ZONING, SITE PL	AN AND PLATTING INFORMATION [PLEAS	SE PRINT]		
CURRENT ZONING	Light Industrial	CURRENT USE	Light Industrial	
PROPOSED ZONING	Light Industrial	PROPOSED USE	Light Industrial	
ACREAGE	18.48 LOTS [CURRENT	1 1	LOTS [PROPOSED] 1	
REGARD TO ITS A	D <u>PLATS</u> : BY CHECKING THIS BOX YOU ACKNOWLEDGE T APPROVAL PROCESS, AND FAILURE TO ADDRESS ANY OF IENIAL OF YOUR CASE.	HAT DUE TO THE PASS, STAFF'S COMMENTS BY	AGE OF <u>HB3167</u> THE CITY NO LONGER HAS FLEXI THE DATE PROVIDED ON THE DEVELOPMENT CALE	3ILITY WITH ENDAR WILL
OWNER/APPLICA	ANT/AGENT INFORMATION [PLEASE PRINT/CF			
	Reserve Capital - Rockwall Industrial SPE LLC	▼ APPLICANT		
	Justin Toon	CONTACT PERSON	Justin Toon	
ADDRESS	15110 Dallas Pkwy	ADDRESS	15110 Dallas Pkwy	
	P O Box 670551		P O Box 670551	
	Dallas, TX 75367	CITY, STATE & ZIP	Dallas, TX 75367	
	214-577-6789	PHONE	214-577-6789	
E-MAIL	justin@industrialreserve.net	E-MAIL	justin@industrialreserve.net	
	CATION [REQUIRED] RSIGNED AUTHORITY, ON THIS DAY PERSONALLY APPEARE ON ON THIS APPLICATION TO BE TRUE AND CERTIFIED THE		[OWNER] THE UNDERSIG	NED, WHO
S 100.00 March INFORMATION CONTAINE	I AM THE OWNER FOR THE PURPOSE OF THIS APPLICATION; A , TO COVER THE COST OF THIS APPLICATION, HA , 20 14. BY SIGNING THIS APPLICATION, I AGR D WITHIN THIS APPLICATION TO THE PUBLIC. THE CITY IS TION WITH THIS APPLICATION, IF SUCH REPRODUCTION IS ASSO	AS BEEN PAID TO THE CITY EE THAT THE CITY OF RO S ALSO AUTHORIZED AND	OF ROCKWALL ON THIS THE 1974 SHIFT OF THE 1974 OF THE	DAY OF
GIVEN UNDER MY HAND .	AND SEAL OF OFFICE ON THIS THE I UM DAY OF	reh 2021	JACKSON FREDERIC Notary ID #1346879 My Commission Exp December 20, 202	908 ires
NOTARY PUBLIC IN AND	FOR THE STATE OF TEXAS	ric		0/27






City of Rockwall Planning & Zoning Department 385 S. Goliad Street Rockwall, Texas 75087 (P): (972) 774 7745


(P): (972) 771-7745 (W): www.rockwall.com

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Sheet Number CASE NUMBER: SPXXXX-XXX

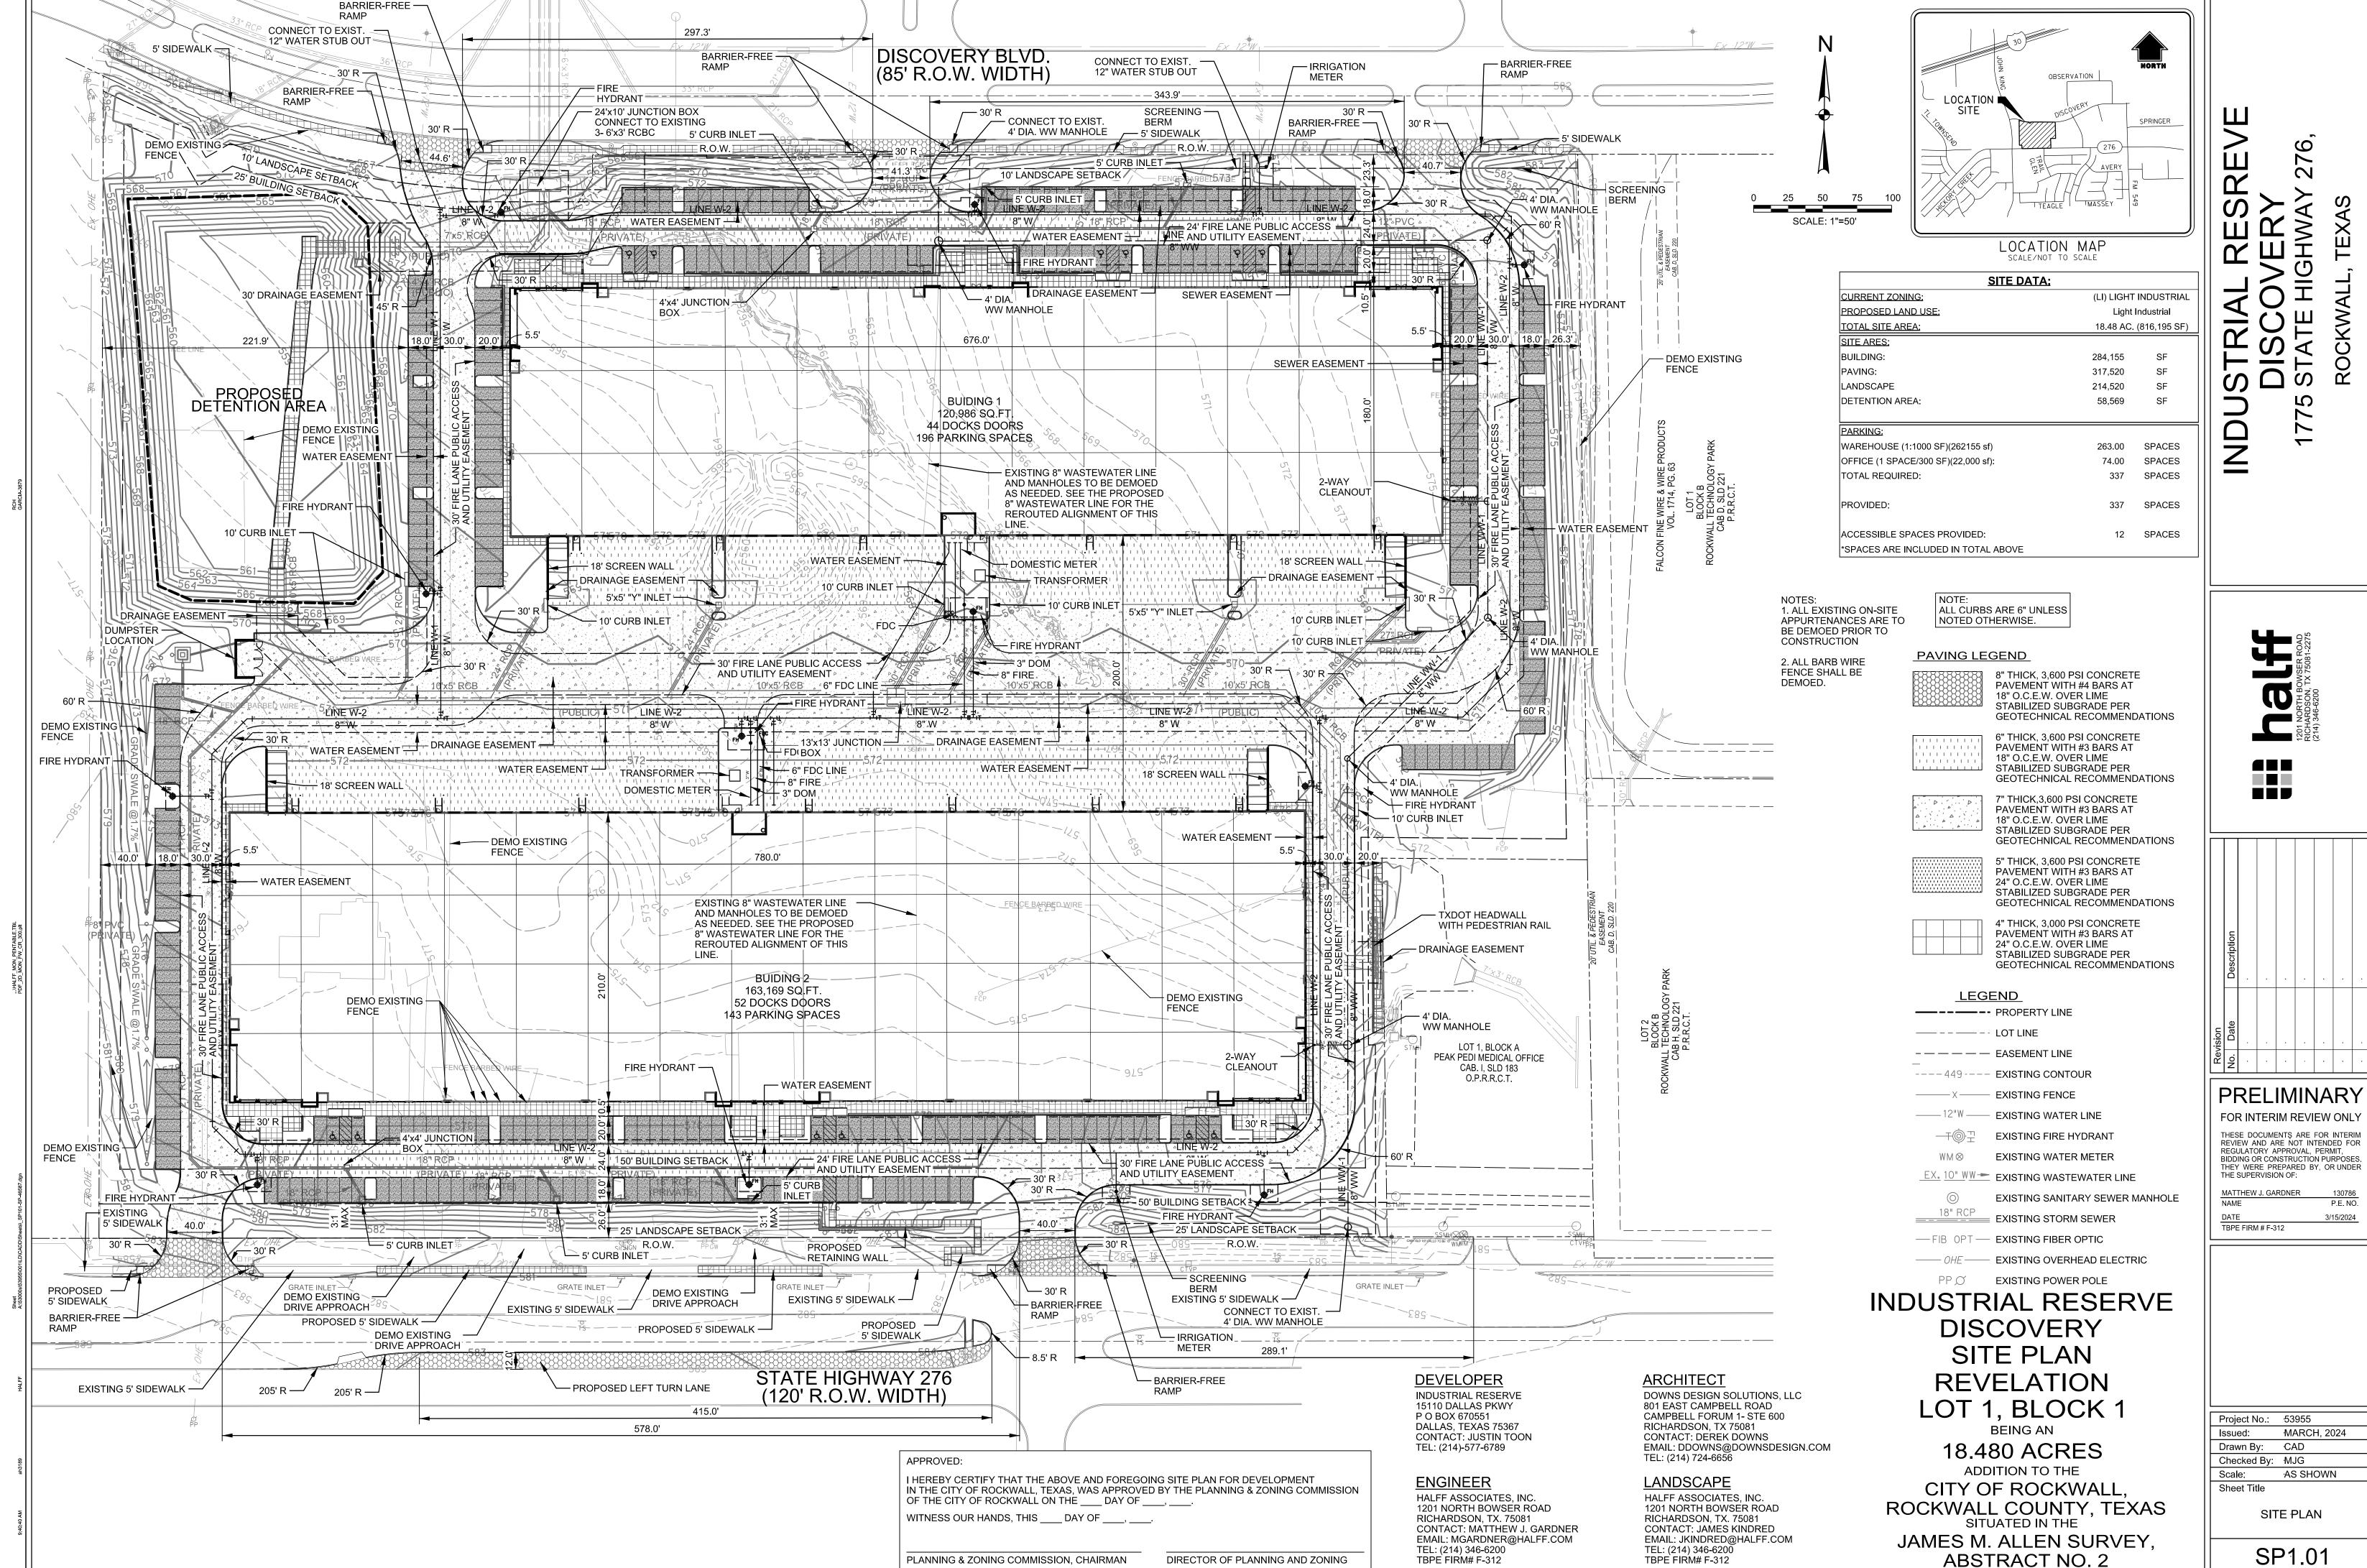

LANDSCAPE REQUIREMENTS for the City of Rockwall, TX

ARTICLE 08: LANDSCAPE AND FENCE STANDARDS

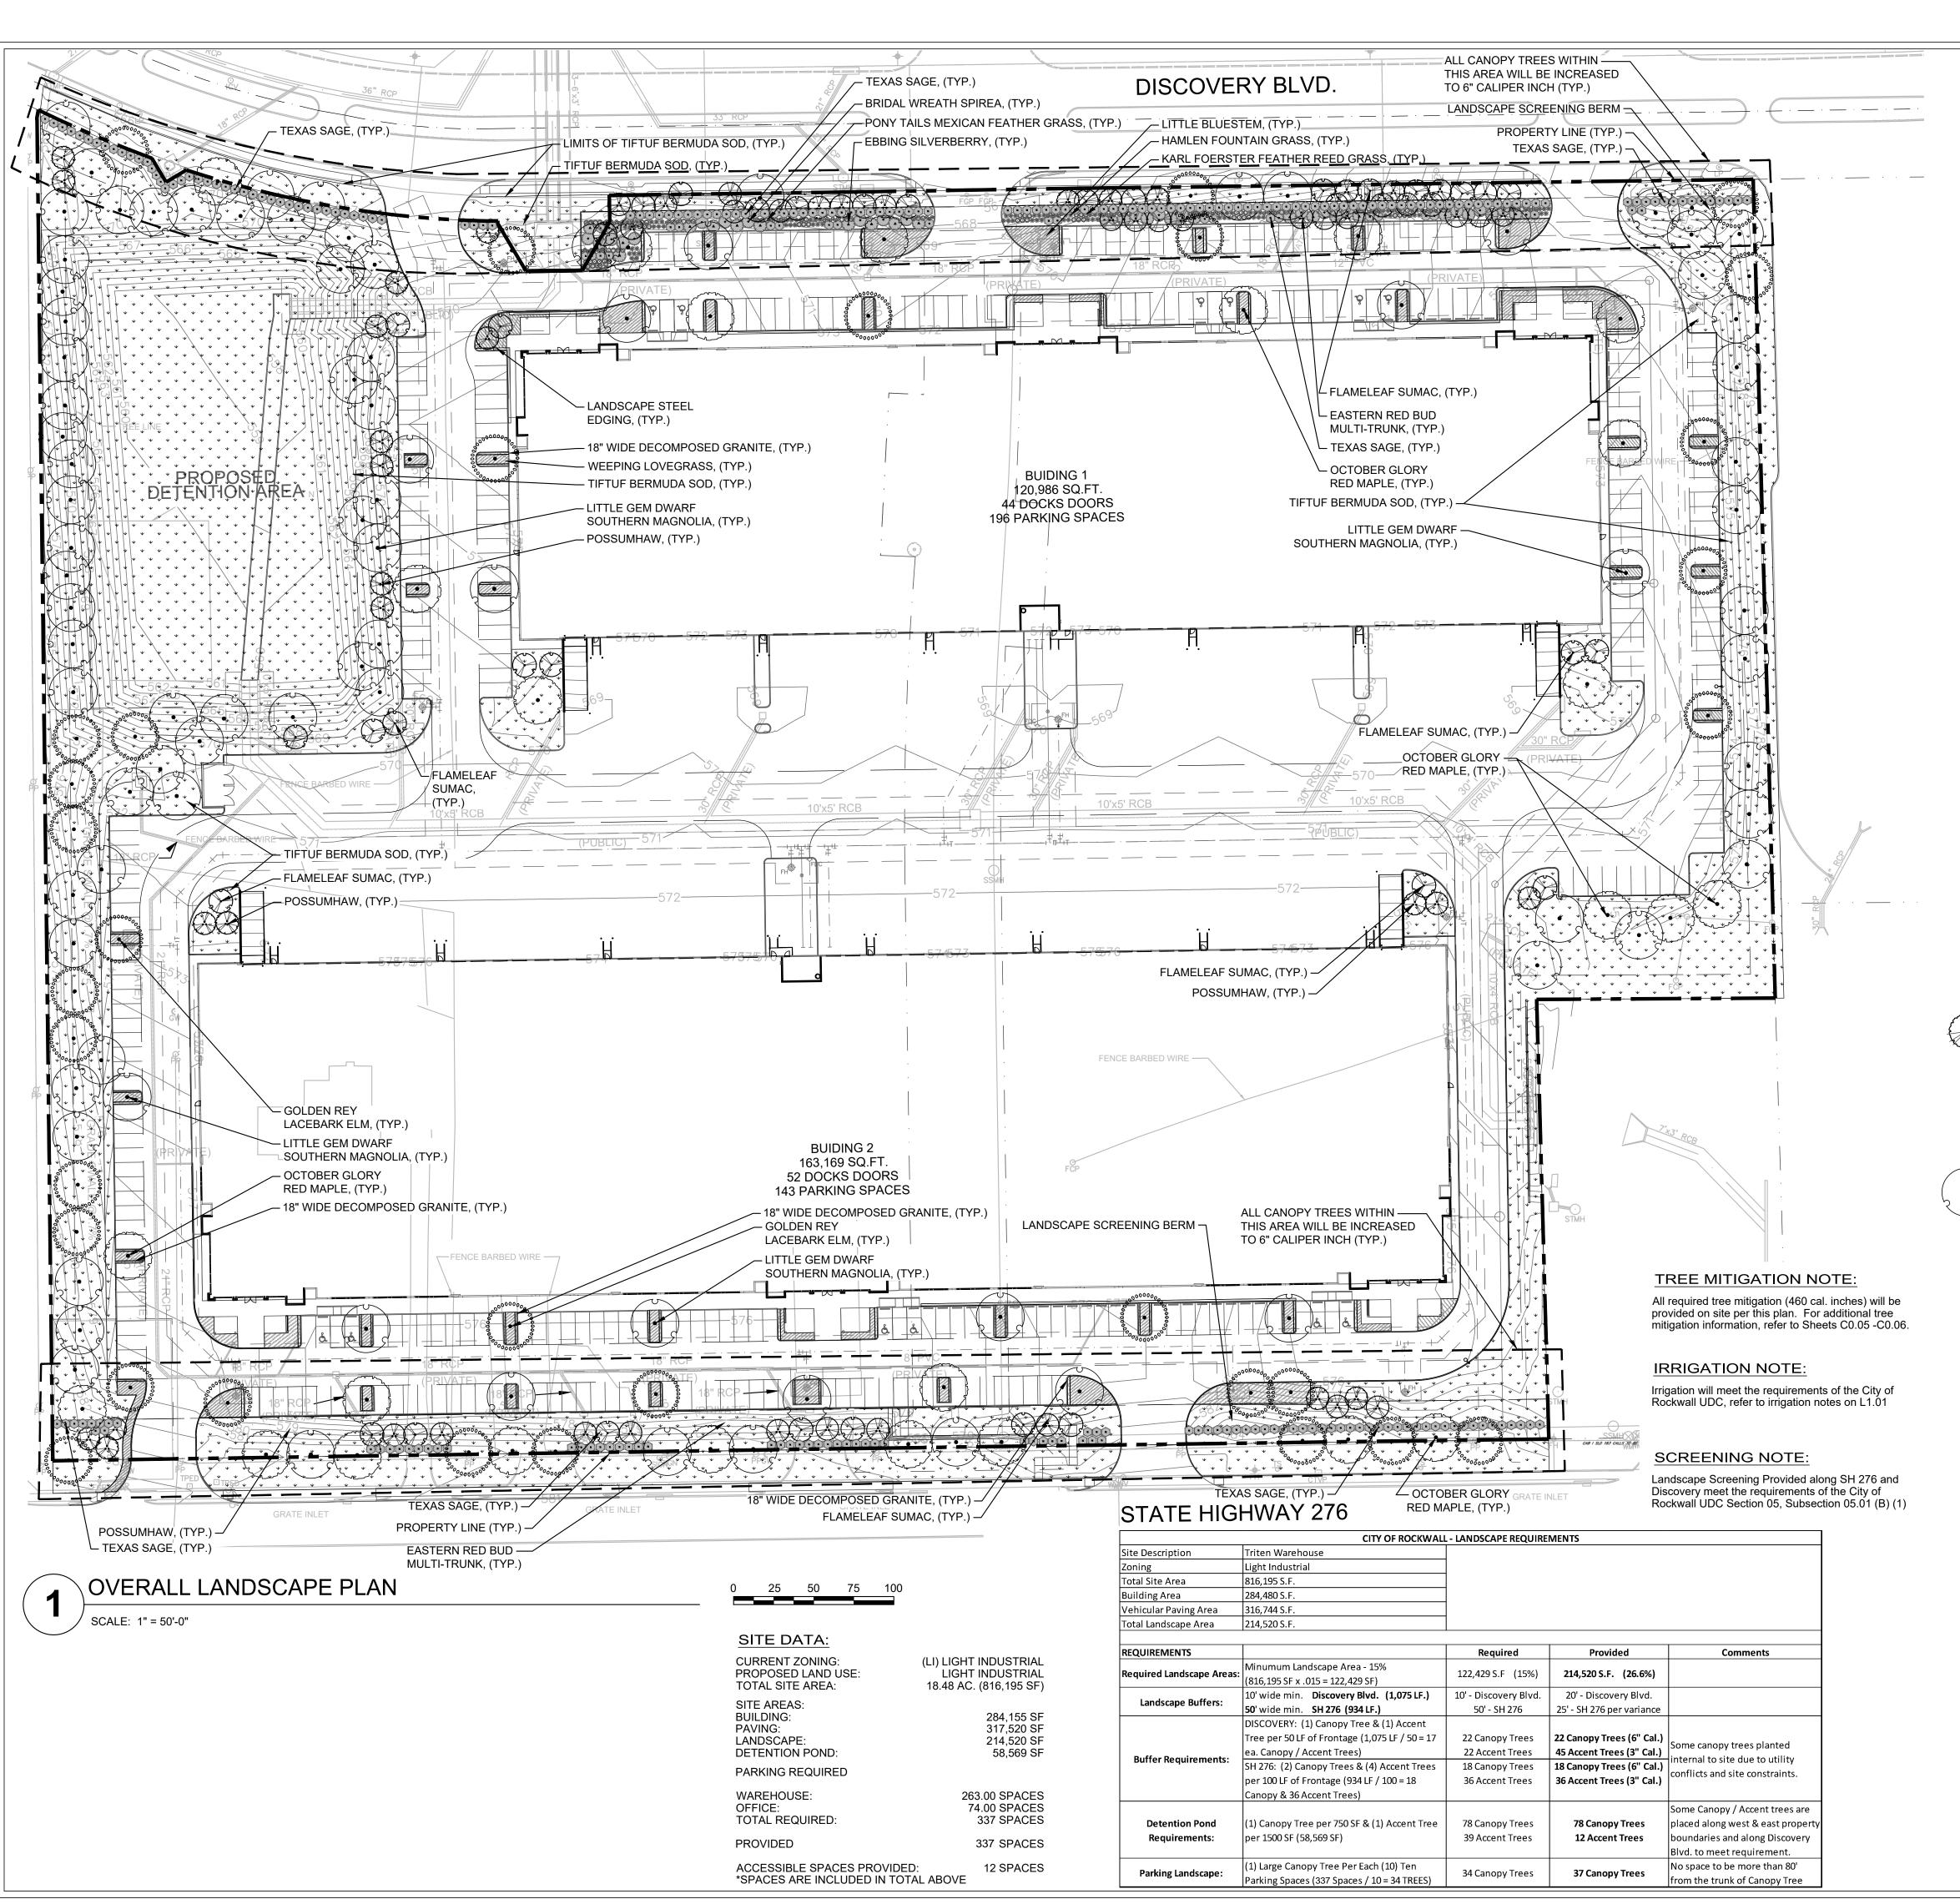SECTION 05: LANDSCAPE STANDARDS

SUBSECTION 05.01: LANDSCAPE BUFFERS

The minimum requirements for landscape buffers shall be as follows:

(B) <u>Non-Residential Landscape Buffers.</u> (see Figure 3: Commercial Landscape Buffers Example)) Abutting a Public Right-of-Way. A minimum of a ten (10) foot wide landscape buffer shall be required along the entire length of any non-residential lot that abuts a public right-of-way (i.e. collector street, arterial roadway, or alleyway) or a residentially zoned or used property that is located directly across a public street (regardless of the size of the street). All landscapebuffers adjacent to a public right-of-way shall incorporate ground cover, a built-up berm and shrubbery along the entire length of the frontage. Berms and shrubbery shall have a total minimum height of 30-inches. In these areas a minimum of one (1) canopy tree and one (1) accent tree shall be incorporated into the landscape buffer per 50-linear feet of frontage along the adjacency. Clustering of trees shall be permitted as long as all required trees are situated within the landscape buffer.

SUBSECTION 05.02: LANDSCAPE SCREENING

- (A) <u>Loading Docks and Outside Storage Areas.</u> Off-street loading docks and outside storage areas shall bE screened from all public streets, open space, adjacent properties and any residential zoning districts or residentially used properties that abut or are directly across a public street or alley from the loading dock or outside storage area in accordance with the requirements of Subsection 01.05, Screening Standards, of Article 05, District Development Standards (Screening Wall with Canopy Trees every 20' o.c.).
- (C) <u>Headlight Screening.</u> Head-in parking adjacent to a street shall incorporate one (1) of the following screening methods to mitigate the potential hazard that headlights may pose for on-street vehicular traffic:
- (1) Alternative #1. A minimum of a two (2) foot berm with mature evergreen shrubs along the entire adjacency of the parking areas.
- (2) Alternative #2. A wrought iron fence with a mix of two (2) rows of staggered mature evergreen trees and one (1) row of deciduous canopy trees (a minimum six [6] caliper inches) along the entire length of the adjacency. All trees will be planted on 20-foot centers.

SUBSECTION 05.03: LANDSCAPE REQUIREMENTS

- (A) <u>Amount of Landscaping.</u> The following landscaping percentages shall be required and shall apply to the total site area to be developed: Light Industrial (LI) District - Required Landscaping 15%.
- (B) Location of Landscaping. A minimum of 100% of the total required landscaping shall be located in front of and along the side of buildings with street frontages in the Heavy Commercial (HC), Light Industrial (LI), and Heavy Industrial (HI) Districts.
- (E) Parking Lot Landscaping. The following landscape requirements will apply to parking lots:
- (1) Parking lots with more than two (2) rows of parking spaces (i.e. one [1] drive isle with rows of parking on either side) shall have a minimum for five (5) percent or 200 SF of landscaping -- whichever is greater -- in the interior of the parking lot area. Such landscaping shall be counted toward the total required landscaping.
- (2) If the parking and maneuvering space exceeds 20,000 SF, one (1) large canopy tree for every ten (10) parking spaces shall be required to be planted internal to the parking areas. (3) No tree shall be planted closer than five (5) feet to the edge of pavement or five (5) feet from any water or wastewater line that is less than 12-inches. Water and wastewater lines that are 12-inches and greater require trees to be planted a minimum of ten (10) feet from the centerline of the pipe. (4) No required parking spaces may be located more than 80-feet from the trunk of a canopy tree.
- (G) <u>Landscaping in Landscape Buffers and Public Right-of-Way.</u> All landscape buffers and public right-of-way located adjacent to a proposed development shall be improved with grass (i.e. sod -- hydro mulch shall be prohibited in these areas) prior to the issuance of a Certificate of Occupancy (CO). In addition, it shall be the responsibility of the developer to design the irrigation system within the lot to ensure that the grass placed in public right-of-way is watered and maintained, and to ensure that minimal water will be shed on to the street. The designer of the irrigation system shall base the systems design on the ultimate proposed width of the street. The plans for design of the irrigation system shall be approved by the Building Inspections Department prior to installation and acceptance of the project.

LEGEND

SHADE TREE

ORNAMENTAL TREES COMMON / BOTANICAL NAME

Eastern Redbud Multi-trunk / Cercis canadensis

Flameleaf Sumac / Rhus Laneolata

October Glory Red Maple / Acer rubrum 'October Glory'

COMMON / BOTANICAL NAME

Possumhaw / Ilex decidua

Little Gem Dwarf Southern Magnolia / Magnolia grandiflora 'Little Gem'

Golden Rey Lacebark Elm / Ulmus parvifolia 'Golden Rey'

<u>SHRUBS</u> COMMON / BOTANICAL NAME

Ebbing Silverberry / Elaeagnus x ebbingei

Texas Sage / Leucophyllum frutescens Bridal Wreath Spirea / Spiraea prunifolia 'Bridalwreath'

ORNAMENTAL GRASSES COMMON / BOTANICAL NAME

Karl Foerster Feather Reed Grass / Calamagrostis x acutiflora 'Karl Foerster'

Hameln Fountain Grass / Pennisetum alopecuroides 'Hameln'

Little Bluestem / Schizachyrium scoparium

Pony Tails Mexican Feather Grass / Stipa tenuissima 'Pony Tails'

GROUND COVERS COMMON / BOTANICAL NAME

Tiftuf Bermuda Grass / Cynodon dactylon (L.) Pers. × Cynodon transvaalensis Burtt Davy

Weeping Lovegrass / Eragrostis curvula

MISCELLANEOUS

COMMON / BOTANICAL NAME

Decomposed Granite / -Native decompsed granite

Landscape Steel Edging



Sheet Number



	Description	·			·	
Revision	Date			•		
Rev	No.					

PRELIMINARY FOR INTERIM REVIEW ONLY THESE DOCUMENTS ARE FOR INTERIM REVIEW AND ARE NOT INTENDED FOR REGULATORY APPROVAL, PERMIT, BIDDING OR CONSTRUCTION PURPOSES. THEY WERE PREPARED BY OR UNDER THE SUPERVISION OF:

JAMES R. KINDRED R.L.A. NO.

03/15/2024

Project No.: 46587 MARCH, 2024 Issued: Drawn By: Checked By: JRK

Scale: AS SHOWN Sheet Title LANDSCAPE PLAN

CASE NUMBER: SPXXXX-XXX

- 1. INSTALL STEEL EDGING TO UTILIZE FULL SECTIONS UNLESS CONTROLLED OTHERWISE WITH PLAN SHEET DIMENSIONS.
- 2. CUT STEEL EDGING AT AN ANGLE TO ACHIEVE A FINISHED STEEL EDGE HEIGHT OF 1/2" BELOW THE TOP OF ADJACENT HARDSCAPE.
- 3. IF STAKING IS NOT AVAILABLE WITHIN 12" OF THE EDGING TERMINATION, INSTALL A SPLICING EDGING STAKE WITHIN 6" OF THE TERMINATING EDGE AS SHOWN WITH OPTION 'B'
- 4. WHERE POSSIBLE, EDGE TERMINATION SHALL BE INSTALLED AS SHOWN IN TERMINUS OPTION 'A'.

D = DIMENSION OF PLANT SPACING (SHRUB AND GROUNDCOVER AS INDICATED ON DRAWINGS) - IF SHRUB IS BALL AND BURLAP, THEN REMOVE BURLAP AND ROPE FROM TOP 1/3 OF ROOTBALL - AMENDED SOIL BACKFILL TO REMOVE ALL 3" LAYER OF - DECOMPOSED GRANITE 4" LAYER OF MULCH

OVER WEED BLOCK OVER WEED BLOCK PIT PLANTED UNDISTURBED SUBGRADE 4" STEEL EDGE - AS SHOWN BREAK THROUGH AND REMOVE ANY EXISTING IN LANDSCAPE PLAN -

1. SEE LANDSCAPE NOTES FOR THE TYPE OF WEED BLOCK AND MULCH MATERIAL TO USE. 2. OMIT WEED BLOCK WHEN PLANT SPACING IS 18" O.C. OR LESS


"HARDPAN" AS NECESSARY TO PROVIDE GOOD PERCOLATION AND POSITIVE DRAINAGE

N.T.S.

SHRUB PLANTING AND SPACING


(REF. LANDSCAPE PROJECT NOTES)

STEEL EDGE TERMINATION

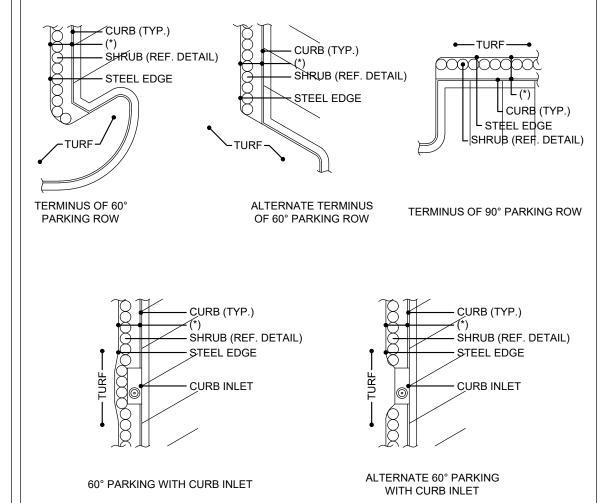


(*) SEE SHRUB PLANTING DETAIL FOR DIMENSIONS. REFERENCE PLANT MATERIAL LIST FOR PLANT TYPES AND LOCATIONS.

GENERAL STEEL EDGE ALIGNMENT EXAMPLES

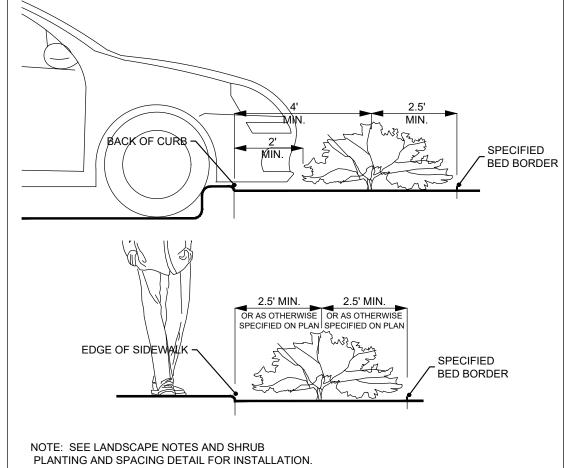

SHRUB DISTANCE FROM EDGE OF BED

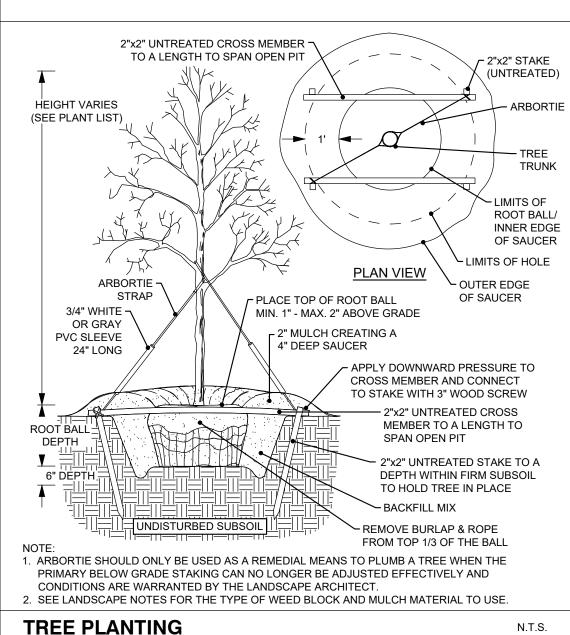


*FOR ALL MAPLE TREE INSTALLATIONS:

MAXIMUM OF 24 MONTHS.

WRAP TRUNKS WITH A BURLAP TREE BARK WRAP

TO PREVENT SUN SCALD. WRAP IS TO REMAIN IN PLACE FOR A MINIMUM OF 12 MONTHS AND A

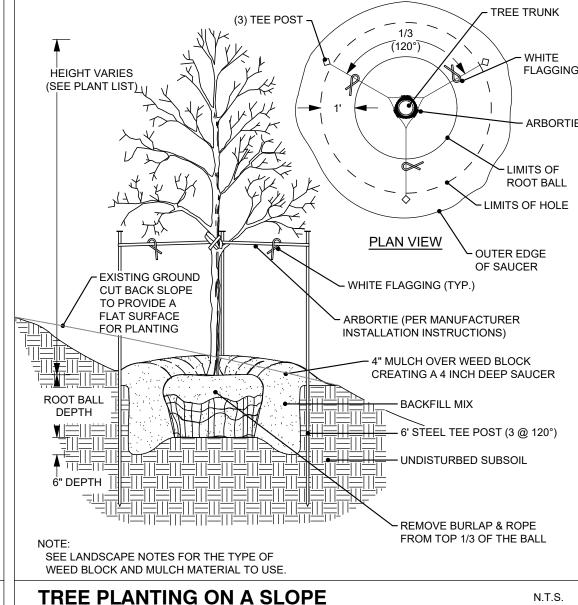

N.T.S. ARBORTIE

IRRIGATION NOTES

SUBSECTION 05.04: IRRIGATION REQUIREMENTS

- (A) <u>General Irrigation Requirements.</u> The owner shall be responsible for the health and vitality of plant material through the irrigation of all landscaped areas, turf and plant materials, and shall:
- (1) Provide a moisture level in an amount and frequency adequate to sustain growth of the plant
- materials on a permanent basis. (2) Be in place and operational at the time of the landscape inspection for Certificate of Occupancy (CO). (3) Be maintained and kept operational at all times to provide for efficient water distribution.

- (1) <u>Landscaped Areas.</u> One (1) of the following irrigation methods shall be used to ensure adequate watering of plant material in landscaped areas: (a) <u>Conventional System.</u> An automatic or manual underground irrigation system that may be a
- onventional spray or bubbler type heads. (b) <u>Drip or Leaky-Pipe System.</u> An automatic or manual underground irrigation system in conjunction with a watersaving system such as a drip or a leaky pipe system. (c) <u>Temporary and Aboveground Watering</u>. Landscape areas utilizing xeriscape plants and installation techniques, including areas planted with native grasses and wildflowers, may use a temporary and above ground system, and shall be required to provide irrigation for the first two (2) growing seasons only.
- (2) <u>Natural and Undisturbed Areas.</u> No irrigation shall be required for undisturbed natural areas or
- (3) <u>Compliance with State Law.</u> All irrigation systems shall comply with the irrigation code of <u>Chapter 10</u>, Buildings and Building Regulations, Article XVI, Irrigation Code, of the City of Rockwall Code of Ordinances, and all applicable state laws, as may be amended.

ORNAMENTAL TREES	QTY	BOTANICAL / COMMON NAME	CONT	CAL	REMARKS
			23.11		
	28	Cercis canadensis / Eastern Redbud Multi-trunk	B&B/Cont.	3" Cal	8' HT Minimum, Full Canopy, Healthy, Good Form, Strong Central Leader.
	38	Rhus lanceolota / Flameleaf Sumac	B&B/Cont.	3" Cal	8' HT Minimum, Full Canopy, Healthy, Good Form, Strong Central Leader.
	27	Ilex decidua / Possumhaw	B&B/Cont.	3" Cal	8' HT Minimum, Full Canopy, Healthy, Good Form, Strong Central Leader.
SHADE TREE	QTY	BOTANICAL / COMMON NAME	CONT	CAL	REMARKS
	27	Acer rubrum 'October Glory' / October Glory Red Maple	B&B/Cont.	4" Cal 6" Cal in Buffer Zone	12' HT Minimum, Full Canopy, Healthy, Good Form, Strong Central Leader.
•	90	Magnolia grandiflora 'Little Gem' / Little Gem Dwarf Southern Magnolia	B&B/Cont.	4" Cal 6" Cal in Buffer Zone	12' HT Minimum, Full Canopy, Healthy, Good Form, Strong Central Leader.
00000000000000000000000000000000000000	33	Ulmus parvifolia 'Golden Rey' / Golden Rey Lacebark Elm	B&B/Cont.	4" Cal 6" Cal in Buffer Zone	12' HT Minimum, Full Canopy, Healthy, Good Form, Strong Central Leader.
SHRUBS	QTY	BOTANICAL / COMMON NAME	CONT	SIZE	REMARKS
Exercise Services	24	Elaeagnus x ebbingei / Ebbing Silverberry	5 gal	4`-8` HT 6`-8` SPD	
•	268	Leucophyllum frutescens / Texas Sage	5 gal	4`-8` HT 4`-6` SPD	
0	16	Spiraea prunifolia 'Bridalwreath' / Bridal Wreath Spirea	5 gal	4`-8` HT 6`-8` SPD	
ORNAMENTAL GRASSES	QTY	BOTANICAL / COMMON NAME	CONT	SIZE	REMARKS
on the	48	Calamagrostis x acutiflora 'Karl Foerster' / Karl Foerster Feather Reed Grass	5 gal	2`-6` HT 36" O.C.	
*	81	Pennisetum alopecuroides 'Hameln' / Hameln Fountain Grass	5 gal	2`-3` 1`-3` Spd	
and the same	77	Schizachyrium scoparium / Little Bluestem	5 gal	3`-4` 12"-18" Spd	
	38	Stipa tenuissima 'Pony Tails' / Pony Tails Mexican Feather Grass	5 gal	1`-2` Ht 36" O.C	
GROUND COVERS	QTY	BOTANICAL / COMMON NAME	CONT	SIZE	
\(\psi\) \(\	197,277 sf	Cynodon dactylon (L.) Pers. × Cynodon transvaalensis Burtt Davy / Tiftuf Bermuda Grass	Sod		
	9,930 sf	Eragrostis curvula / Weeping Lovegrass	3 gal		
MISCELLANEOUS	QTY	BOTANICAL / COMMON NAME	CONT	SIZE	
######################################	1,520 sf	-Native decompsed granite / Decomposed Granite	flat		
	2,442 LF	Landscape Steel Edging			

LANDSCAPE PROJECT NOTES

Refer to Sitework Specifications for all information needed for landscape work.

Notify Landscape Architect or designated representative of any layout discrepancies or any condition which may prohibit the installation as shown.

Verify and locate all utilities and site lighting conduits before landscape construction begins. Protection of all utilities is the responsibility of the Contractor.

All landscape planting areas illustrated shall be graded smooth with three inches (3") of topsoil and three inches (3") of compost applied and consistently blended (tilled) to a depth of nine inches (9"). If adequate or sufficient topsoil is not available on site, the Contractor shall provide topsoil per the specifications and approved by the Owner. To obtain final grade, excavation may be necessary to accept the required depth of opsoil/compost mix with surface dressing or mulch. All beds shall be crowned to anticipate settlement and ensure drainage without disrupting surrounding planned drainage paths. Any areas disturbed for any reason prior to final acceptance of the project shall be corrected by the Contractor at no additional expense to the Owner.

All landscaped areas will be irrigated with an underground automatic system.

Quantities shown on these plans are for reference only. Plant spacing is as indicated in the Plant Material List unless otherwise noted. The Contractor has full responsibility to provide coverage in all planting areas as specified.

All trees and shrubs shall be installed per planting details.

Trees shall be planted at least five feet (5') from any utility line or sidewalk, to the outside of utility easements with a clear ten feet (10') around fire hydrants and twenty feet (20') min. from all irrigation control zone meter boxes. Furthermore, planting within areas of turf shall give priority of location to irrigation. Trees, shall not be planted within five feet (5') of a spray head or ten feet (10') of a rotor. Remaining irrigation components shall respect the location of the illustrated landscape design. Shrubs, regardless of type, shall not be planted within thirty inches (30") of bed

All plant material shall be maintained in a healthy and growing condition, and must be replaced with similar variety and size if damaged or removed. Container grown plant material is preferred, however ball and burlap material may be substituted as indicated in the plant material list.

All planting beds as designated shall be bordered by Owner approved four inch (4") steel edging w/ $\frac{1}{16}$ " min. thickness unless bed is bordered by concrete. Steel edging adjacent to decomposed granite beds shall have a 1/4" min. thickness. Terminate edging flush with paved surface with no sharp corners exposed.

A four inch (4") dressing of Shredded hardwood mulch over a 4.1 oz, woven polypropylene, needle-punched fabric or equal weed barrier shall be used in all plant beds and around all trees and within all beds with plants spaced 18" o.c. or greater. Single trees or shrubs shall be mulched to the outside edge of the saucer or landscape island (See planting details).

Fertilize all plants at the time of planting with 10-10-10 time release fertilizer.

All areas of decomposed granite shall be over a 4.1 oz, woven polypropylene, needle-punched fabric or equal weed barrier of locally available material, installed to a compacted depth of three inches (3") to be flush with the top of curb, paved surface, and/or the top of steel edge.

TURF PROJECT NOTES

EROSION CONTROL:

Γhroughout the project and the maintenance period for turfgrass, it is the Contractor's responsibility to maintain the topsoil in place at specified grades. Topsoil and turfgrass losses due to erosion or any construction disturbance will be replaced by the Contractor until ESTABLISHMENT and ACCEPTANCE is

SOIL PREPARATION

All slopes and areas disturbed by construction, except those occupied by buildings, structures, or paving shall be graded smooth and four (4") inches of topsoil applied. If adequate topsoil is not available onsite, the Contractor shall provide topsoil as approved by the Owner. The area shall be dressed to typical sections and plowed to a depth of five (5") inches. Soil shall be further prepared by the removal of debris, weeds and stones larger than 3/4 inch in diameter. After tillage and cleaning, all areas to receive turf shall be leveled, fine graded, and drug with a weighted spike harrow or float drag. The top two (2") inches shall be pulverized to provide a uniform bed for seeding or sod as described below.

At a minimum, three feet (3') of solid sod shall be installed along all impervious edges. This includes, but is not limited to: curbing, sidewalks, building foundation, storm water inlets, manholes, and planting bed perimeter treatments. Additional areas of sod installation will be as indicated on the design plans. All areas from back of curb within the roadway ROWs and 10' Landscape Buffer shall be sod. Should installation occur between November and March, sod shall include an over-seed of Annual Rye for a grown-in appearance.

SPRING AND SUMMER PERMANENT GRASSING (May 15 through September 15): Hydromulch seed with hulled Common Bermuda at a rate of 4 lbs/1000 sf. Seeding shall be accomplished immediately after bed preparation. Hydroseed mixture shall contain cellulose mulch applied at a rate of 2000 lbs/acre, with a maximum of 50 lbs/100 gallons of water. If seeding is delayed after mixing 0.5 - 2 hours, add 50% seed mix. If delay is longer than 2 hours, begin with new mixture.

FALL AND WINTER TEMPORARY GRASSING (September 15 through May 15): Seed with annual rye at a rate of 10 lbs/1000 sf. After May 15, Contractor shall remove rye to effectively establish permanent seeding.

IRRIGATION:
In the absence of an irrigation system or areas beyond the coverage limits of a permanent irrigation system, Contractor shall water sod/seed temporarily to develop adequate growth and establishment before regular maintenance begins. Turf shall be watered until firmly established.

Water shall be furnished by the Contractor with means and methods available to achieve acceptable turf. The water source shall be clean and free of industrial wastes or other substances harmful to the growth of the turf.

MAINTENANCE REQUIREMENTS:

ESTABLISHMENT AND ACCEPTANCE:

Vegetation should be inspected regularly to ensure that plant material is established properly and remains healthy. Mowing, trimming and supervision of water applications shall be the responsibility of the Contractor until the Owner or Owner's Representative accepts and assumes regular maintenance.

established with turf such that any absence of water will not kill the turf, but promote a state of turf dormancy, until the next rainfall event. Regardless of unseasonable climatic conditions or other adverse conditions affecting planting operations and the growth of the turf grass, it shall be the sole responsibility

of the Contractor to establish a uniform stand of grass. UNIFORM STAND OF

representative a minimum of 5 days prior to the anticipated inspection date.

All disturbed areas being seeded shall receive topsoil as specified and be adequately

GRASS is defined as minimum 80% coverage per square foot (no bare areas). Contractor to make a written request for inspection to Owner or Owner's

Scale: AS SHOWN Sheet Title LANDSCAPE NOTES AND DETAILS

СP

MARCH, 2024

Project No.: 46587


Checked By: JRK

Issued:

Drawn By:

Sheet Number

CASE NUMBER: SPXXXX-XXX

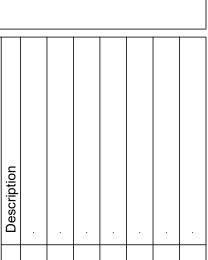

THESE DOCUMENTS ARE FOR INTERIM REVIEW AND ARE NOT INTENDED FOR REGULATORY APPROVAL, PERMIT, BIDDING OR CONSTRUCTION PURPOSES. THEY WERE PREPARED BY OR UNDER THE

2255

R.L.A. NO.

03/15/2024

SUPERVISION OF:

JAMES R. KINDRED

ROCKWALL, TEXAS

SCALE: 1"=60'



March 15, 2024 AVO 53955

City of Rockwall Planning and Zoning 385 S Goliad St Rockwall, TX 75087

RE: VARIANCE REQUEST: Industrial Reserve Discovery Rockwall

Rockwall, TX

Dear reviewer.

Industrial Reserve would like to request a variance to the minimum ground cover requirements within landscape buffers adjacent to Primary Roadways and specific to the SH-276 Overlay District, as detailed in Subsection 06.02 (E) of the City of Rockwall Unified Development Code. The Unified Development Code requires a built-up berm and shrubbery, or combination thereof, along the length of the frontage where the berm is 30 - 48 inches in height as measured from the primary roadway elevation. Based on our interpretation of the code requirements we believe that the intent and purpose of the required ground cover screening can be met with an alternative landscaping layout that still provides the required shrubbery and trees but eliminates the built-up berm. Below are key points to the proposed site conditions and proposed justification to providing the variance as requested.

Proposed Site Conditions:

- 1) Please refer to the included amended "Site Plan".
- 2) The car parking for this proposed site development is several feet lower in elevation when compared to the existing primary roadway (SH-276). The parking is on average about 5.5 ft lower that SH-276. Due to this height difference, providing a minimum 30-inch-tall berm along the frontage road creates the need to add over 400 ft of retaining wall that averages 7 ft in height. The additional height difference created by the berm and limited space to make up the grades is what drives the need for the wall.
- The reason the car parking sits several feet lower than SH-276 is due to grading requirements of the intended site layout and the intent to provide a balanced site for dirt import/export.

Proposed Variance

- 1) Please refer to the included attachment labeled "TX 276 SECTION DETAIL".
- 2) The proposed variance to the code requirement is to eliminate the built-up berm. The shrubbery and trees would still be provided as required. It is our interpretation of the code that the landscape berm provides ground cover for both screening and aesthetic purposes. The requirement as detailed within the code has a more practical application to sites that are at or above the adjacent roadway elevation. This site sits several feet below and per this site's conditions, we believe the intent of the requirement can be met without the berm.
- 3) Any vehicles navigating within this site's car parking and facing towards SH-276 would have their headlights screened with the over 5 ft elevation difference between the car parking and the public roadway. This elevation difference is already greater than the 30-inch berm height denoted in the code requirement and thus already provides more screening than is needed. The addition of the 30" berm does not increase the functionality for the screening intent as over 30" of screening are already being provided.

If you have any questions or need any additional information, please call me at your convenience 214-217-6622.

Sincerely,

HALFF

Jose Garcia, PE

facl Loris fo

Halff Phone: 214.346.6200 Fax: 214.739.0095



April 10, 2024

TO:

Justin Toon

PO Box 670551

Dallas, Texas 75367

FROM:

Bethany Ross

City of Rockwall Planning and Zoning Department

385 S. Goliad Street Rockwall, Texas 75087

SUBJECT:

SP2024-009; Amended Site Plan for 1775 SH-276

Justin:

This letter serves to notify you that the above referenced case (*i.e. Amended Site Plan*) that you submitted for consideration by the City of Rockwall was approved by the Planning and Zoning Commission on April 9, 2024. The following is a record of all recommendations, voting records and conditions of approval:

Staff Recommendations

- 1) All staff comments provided by the Planning, Engineering and Fire Department must be addressed prior to the submittal of engineering plans.
- 2) Any construction resulting from the approval of this Site Plan shall conform to the requirements set forth by the Unified Development Code (UDC), the International Building Code (IBC), the Rockwall Municipal Code of Ordinances, city adopted engineering and fire codes and with all other applicable regulatory requirements administered and/or enforced by the state and federal government

Planning and Zoning Commission

On April 9, 2024, the Planning and Zoning Commission approved a motion to approve the Amended Site Plan by a vote of 7-0.

Should you have any questions or concerns regarding your site plan case, please feel free to contact me a (972) 772-6488.

Sincerely,

Bethany Ross, Planner

City of Rockwall Planning and Zoning Department

Shany Korr