# RO

☐ TREESCAPE PLAN

### PLANNING AND ZONING CASE CHECKLIST

City of Rockwall Planning and Zoning Department 385 S. Goliad Street Rockwall, Texas 75087

P&Z CASE #50909-040 P&Z DATE 1	0/29/2019 9C DATE 11/12/2019 APPROVED/DENIED
	HPAB DATE PARK BOARD DATE
ZONING APPLICATION  SPECIFIC USE PERMIT ZONING CHANGE PD CONCEPT PLAN PD DEVELOPMENT PLAN  SITE PLAN LANDSCAPE PLAN TREESCAPE PLAN PHOTOMETRIC PLAN BUILDING ELEVATIONS MATERIAL SAMPLES COLOR RENDERING	☐ COPY OF ORDINANCE (ORD.#) ☐ APPLICATIONS ☐ RECEIPT ☐ LOCATION MAP ☐ HOA MAP ☐ PON MAP ☐ FLU MAP ☐ NEWSPAPER PUBLIC NOTICE ☐ 500-FT. BUFFER PUBLIC NOTICE ☐ PROJECT REVIEW ☐ STAFF REPORT ☐ CORRESPONDENCE ☐ COPY-ALL PLANS REQUIRED ☐ COPY-MARK-UPS ☐ CITY COUNCIL MINUTES-LASERFICHE ☐ MINUTES-LASERFICHE ☐ PLAT FILED DATE ☐ CABINET # ☐ SLIDE #
	NOTES:
PLATTING APPLICATION  MASTER PLAT PRELIMINARY PLAT FINAL PLAT	
☐ REPLAT ☐ ADMINISTRATIVE/MINOR PLAT ☐ VACATION PLAT ☐ LANDSCAPE PLAN	ZONING MAP UPDATED



### **DEVELOPMENT APPLICATION**

City of Rockwall Planning and Zoning Department 385 S. Goliad Street Rockwall, Texas 75087

PLANNING & ZONING CASE NO.	SP3019-040
<b>NOTE:</b> THE APPLICATION IS NOT	CONSIDERED ACCEPTED BY THE
CITY UNTIL THE PLANNING DIRECT	TOR AND CITY ENGINEER HAVE
SIGNED BELOW.	
DIRECTOR OF PLANNING:	IL

CITY ENGINEER:

Please check the appropriate box below to indicate the type of development request [SELECT ONLY ONE BOX]:

[ ] Preliminary P [ ] Final Plat (\$30 [ ] Replat (\$300. [ ] Amending or [ ] Plat Reinstate Site Plan Applica [ X ] Site Plan (\$25	\$100.00 + \$15.00 Acre) 1 lat (\$200.00 + \$15.00 Acre) 1 00.00 + \$20.00 Acre) 1 00 + \$20.00 Acre) 1 Minor Plat (\$150.00) ement Request (\$100.00)	[ ] Specific Use [ ] PD Develop Other Applica [ ] Tree Remode [ \sqrt{2}] Variance F Notes: 1: In determining	range (\$200.00 + \$15.00 Acre) <sup>1</sup> se Permit (\$200.00 + \$15.00 Acre) <sup>1</sup> sepment Plans (\$200.00 + \$15.00 Acre) <sup>1</sup> seption Fees:
PROPERTY INFO	ORMATION [PLEASE PRINT]		
Address			
Subdivision	Ellis Centic, Phase I we		Lot / Block
General Location			
ZONING, SITE P	LAN AND PLATTING INFORMATION [PLEASE	SE PRINT]	
Current Zoning	LF	Current Use	Vacant
Proposed Zoning	LI	Proposed Use	LI
Acreage	7,02 Lots [Current]	(	Lots [Proposed]
[ ] SITE PLANS AND	D PLATS: By checking this box you acknowledge that due to	the passage of <u>HB316</u>	67 the City no longer has flexibility with regard to its approval
	ure to address any of staff's comments by the date provided o		
	CANT/AGENT INFORMATION [PLEASE PRINT/O		A STATE OF THE PARTY OF THE PAR
	Rockwall Urbon Industrial, LA		Halff Associates
	Reid Caldwell		Matthew Gardner
Address	13150 G: + Rd Swite 205	Address	1201 North Bouse
City State & 7in		City State 9 7:-	2 1 1 = 7/201
Phone	Dallas, Tx 75240 214-457-8198		Richardson TX 75081
	reid @ longbow interests.com	E-Mail	214-346-6308
	,	C-IVIAII	Mg ardner@halff.com
Before me, the undersi	ICATION [REQUIRED] gned authority, on this day personally appeared Reid Ca ue and certified the following:	ldwell	_ [Owner] the undersigned, who stated the information on
cover the cost of this ap that the City of Rockwo	In the owner for the purpose of this application; all informatic oplication, has been paid to the City of Rockwall on this the self (i.e. "City") is authorized and permitted to provide information submitted in conjunction with the self conjunction with	day of Octob ation contained within	, 20 19 . By signing this application, I agree this application to the public. The City is also authorized and reproduction is a second of the control of th
Given under my hand a	nd seal of office on this the day of	, 20 <u></u>	Notary Public State of Texas ID # 12485265-9
	Owner's Signature Keid Cald	well	My Comm. Expires 03-09-2020
Notary Public in	and for the State of Texas	pdale	My Commission Expires 3.9.2020



# DEVELOPMENT REVIEW COMMITTEE (DRC) CITY OF ROCKWALL, PLANNING & ZONING DEPARTMENT

Phone: (972) 771-7745

Email: Planning@Rockwall.com

**External Review:** 

Wayne Carter, Charter Communications

Jim Friske, Charter Communications

Dinah Wood, Atmos Randy Voight, Oncor Phillip Dickerson, Oncor Brian Duncan, AT&T Javier Fernandez, RISD Brenda Callaway, TXDOT

Stephen Geiger, Farmer's Electric Frank Spataro, Farmer's Electric

Internal Review:

Amy Williams, Engineering

John Shannon, Building Inspections

Ariana Hargrove, Fire Andy Hesser, Parks Andy Villarreal, Police

From: Planning & Zoning Department

Date: 10/21/2019

To assist the Planning Department in evaluating the attached request, we are sending it to you for your review and comments. Please return any comments and/or plan mark-ups to us within five (5) days. Internal staff will also be required to have all comments input into CRW no later than Friday, 10/24/2019. Planning staff will assemble all comments received in time for our regularly scheduled DRC meeting on 10/29/2019 at 2:00 p.m. The Planning and Zoning Commission work session will be held on 10/29/2019 at 6:00 p.m. You are welcome to attend both meetings. If you have any questions, please contact us at (972) 771-7745.

**Project Number:** 

SP2019-040

**Project Name:** 

**Ellis Centre Phase 2 Addition** 

**Project Type:** 

SITE PLAN


**Applicant Name:** 

**HALFF ASSOCIATES** 

**Owner Name:** 

ROCKWALL URBAN INDUSTRIAL, LP

**Project Description:** 

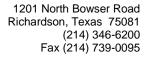



COPIES: X FILE

### **LETTER OF TRANSMITTAL**

TO:	City of Rockwall 385 S Goliad Rockwall, Texas 75807	DATE:	October 18, 2019	
Attn:	Korey Brooks	AVO:	35989	
FROM:	Matthew Gardner, PE Email: mgardner@halff.com	PROJECT:	Rockwall Urban +	Industrial Center
WE ARE	SENDING YOU   ATTACHED			
_ ·	Drawings ☐ Prints ☐ Plar of letter ☐ Change order ☐ Otl	ns ner:	Drawings	Specifications
	RE TRANSMITTED as checked below:			
☐ As red	<u></u>	□R	esubmit copi	ies for approval
	our use		ubmit copies	
☐ For sign	gnature	_	eturn correct	
☐ For re	eview/comment		other:	
ITEMS SI	ENT:			
• 1-	<ul> <li>Application and Application Fee</li> </ul>			
• 1-	- Site Plan Checklist			
• 1-	– Variance Letter			
• 4-	– Site Plan Packages			
• 1-	- Material Sample Board			
• 1-	– CD w/ files			
call me at	are the above referenced items for the Sit 214-346-6308. Thank you.			y questions, please
SIGNED.	Matthew Gardner, PE	Recipient Sig	gnatur <del>e</del> .	



### **CHECKLIST FOR SITE PLAN SUBMITTALS**

City of Rockwall Planning and Zoning Department 385 S. Goliad Street Rockwall, Texas 75087

CASE NUMBER:	RE	EVIEWED BY:
OVERLAY DISTRICT:	RE	EVIEW DATE:

# 1.1 GENERAL INFORMATION FOR ALL PLANS SUBMITTED

Requirements	<b>√</b> = 0K	N/A	Comments	UDC Reference
Items Necessary for Site Plan Review:  ✓ Site Plan  ✓ Landscape Plan  ✓ Treescape Plan  ✓ Photometric Plan  ✓ Building Elevations				Per Application
Building Material Sample Board and Color Rendering of Building Elevations	Ø	0	If required the sample board should detail all building materials, with each material clearly labeled and indicating manufacturer info, color, etc. Check with Planning Staff to see which is appropriate for the submitted project.	
Submittal Requirements	V		Four (4) large (24" x 36") <u>folded</u> copies and one (1) PDF digital copy of each plan is required at the time of submittal.	
Is the property properly platted?	<b>V</b>		Indicate if the property has been properly platted.	
Title Block (Project Name, Legal Description and/or Address)	$\Box$		The title block is to be located in the lower right-hand corner of all sheets and contain the project name, street address, and/or the lot and block designation.	12
Case Number			The case number should be placed in the lower right- hand corner below the title block of all sheets.	
Owners (Name, Address, and Phone Number)	V		The owners name, address, and phone number are required to be in the lower right-hand corner left of the title block.	
Developer (Name, Address, and Phone Number)	Ø		The name, address, and phone number of the person or company that prepared the plans are required in the lower right-hand corner left of the title block.	
North Point	Ø		The north point or north arrow must be facing true north (or straight up) on all plans, unless the scale of the drawings or scope of the project requires a different position.	
Numeric and Graphic Scale	Ø		The recommended engineering scales are $1'' = 20'$ , $1'' = 40'$ , etc with a maximum of $1'' = 100'$ .	
Vicinity Map	<b>∠</b>		The vicinity map should locate the site relative to the nearest major roadways in a one-half mile radius.	:•
Signature Block	₽		Standard signature block with signature space for the Planning & Zoning Chairman and Planning Director.	7 - N - 20
Date	<b>✓</b>		The date that the plans were prepared is required on all submittals.	•
Proposed Land Use:			Indicate the proposed use for this site. Additionally, indicate the proposed use for all structures.	
✓ Commercial			Land Uses Permitted in the RO, NS, GR, C, DT, RC & Designated Planned Development District Ordinances.	
✓Industrial	Д		Land Uses Permitted in the RT, LI, HI & Designated Planned Development District Ordinances.	

# 2.1 SITE PLAN: MISCELLANEOUS AND DENSITY & DIMENSIONAL INFORMATION

Requirements	<b>√</b> = 0K	N/A	Comments	UDC Reference
Total Lot or Site Area (Acreage and Square Footage)	Ø	0	If the site is part of a larger tract include a key map showing the entire tract of land and the location of the site being planned.	
Perimeter Dimensions of the Site			Indicate the perimeter dimensions of the site in feet.	-
Buildings (Square Footage)	V		Indicate the location and total square footage of all existing and planned buildings on the site.	
Perimeter Dimensions of all Buildings	$\square$		Indicate the wall lengths of all buildings on the site.	_
Distance Between Buildings			Indicate the distance between all existing and planned buildings located on the site.	100
Distance Between Buildings and Property Lines	വ		Indicate the distance between all property lines and existing and planned buildings located on the site.	-
Indicate all Property Lines	Q		Indicate all existing property lines. If the site plan requires a platting case that will alter the property lines show the proposed changes in a different line weight.	
Indicate all Building Setbacks	$\square$		Indicate all building setbacks adjacent to right-of-way.	:=1
Indicate all Easements			Additionally, indicate all utilities both existing and proposed.	
Indicate all Drive/Turning Radii	$\Box$			-
Indicate all Drive Widths	<b>☑</b>			
Indicate all Fire Lanes	Z		Indicate and label the widths of all fire lanes existing and proposed for the site.	-
Indicate location of all Fire Hydrants	Z			
Indicate all Sidewalks			Indicate and label the widths of all sidewalks existing and proposed for the site.	30
Adjacent Street Right-Of-Way			Reference the City's Master Transportation Plan for right-of-way information.	
Label all Adjacent Street Name	<b></b>		Label all adjacent existing and proposed street names.	588
Adjacent Street Centerlines	<b>Z</b>		Indicate the street centerline for all existing and proposed streets.	
Median Breaks in Adjacent Streets		Z		36

### 2.2 SITE PLAN: PARKING INFORMATION

Requirements	<b>√</b> = 0K	N/A	Comments	UDC Reference
Dimension of a Typical Parking Space		0	See the comment section in Adequate Parking and Maneuvering below.	
Parking Table	<b>⊡</b>		Provide parking table indicating the total number of required parking spaces by use, the total number of required handicapped parking spaces and the total parking provided.	
Handicap Parking Spaces Shown	$\mathbf{Z}$			Art. VI 5.04
Adequate Parking	Z		Reference Table 3 of Article VI.	Art. VI Table 3
Adequate Parking and Maneuvering	Ø		All parking spaces and aisle dimensions shall conform to the off-street parking requirements in section 2.19 of the City's Standards of Design and Construction (Check w/ the Engineering Department).	Art. VI 5.03.C
Adequate Loading Area	J		Loading spaces shall be a minimum of 12 feet in width, 65 feet in length, and 14 feet in height except as may otherwise be approved by the city engineer (Art. VI 6.5 Loading Requirements).	Art. VI 6.04
Adequate Loading Maneuvering				Art. VI 6
Type and Depth of Paving Material	Ø		Indicate the type and depth of the paving material and provide a detail or cut-sheet. All required parking and loading areas shall be constructed of concrete, but may have a surface treatment of brick, stone or other similar material.	Art. VI 3.02

2.2 CITE DI ANI. CICNIA CE				
2.3 SITE PLAN: SIGNAGE Requirements	<b>√</b> = 0K	N/A	Comments	UDC Reference
			pal Code of Ordinance, unless otherwise specified in ar	
District or Planned Development District with				, everial
Proposed or Existing Signage		X	Indicate the location and type of all proposed and/or existing signage on the site plan. Additionally, provide a detail or cut-sheet showing the elevations, lighting and dimensions of the proposed signage.	
2.4 SITE PLAN: SCREENING				
Requirements	√= OK	N/A	Comments	UDC Reference
Indicate the Type and Location of any	×		Label the height and type of fence proposed or existing.	Art. VIII 8
Existing and/or Proposed Fences				
Utility Equipment Screening (Pad or Ground Mounted)			Pad mounted utility equipment, and air conditioning units, shall be screened from horizontal view from any adjacent public street and from any adjacent property. Utility equipment and air conditioning units shall be screened utilizing plantings, berms, or walls matching the main structure.	Art. V 1,05.3
Utility Equipment Screening (Roof Mounted)	Ø		All buildings must be designed such that no roof mounted mechanical equipment, HVAC, or satellite dishes shall be visible from any direction.	
Above Ground Storage Tanks		<b> </b>	Aboveground storage tanks shall be screened utilizing plantings, berms, or walls matching the main structure.	Art. V 1.05.4
Dumpster Screening	K	0	Dumpster storage should be located to the rear of the buildings with proper access. Trash dumpster shall not be located in any required parking space and shall allow proper access by service trucks. The minimum enclosure area shall be 12'x10'. A minimum of 6" bollards will be required at potential impact zones and the pad site shall be paved to city standards.	Art. V 1.05.2
Outside Storage	K		Do pared to dity standards.	
Off-Street Loading Dock Screening	0	ĭ <b>X</b>	Off-street loading docks must be screened from all public streets and any residential district that abuts or is directly across a public street or alley from the lot. The screening must be at least six feet in height and may be provided by using a masonry fence, berms, plantings or a combination of the above.	Art. V 1.05.1
Residential Adjacency Standards		×	The director may require wing walls, landscape screens, changes in building orientation, and/or other architectural elements to minimize the impact of uses adjacent to residential property within 150 feet (also reference Art. VIII 5.2).	Art. V 1.06
3.1 LANDSCAPE PLAN		Ī		
Requirements	√= OK	N/A	Comments	UDC Reference
Provide Site Data	Ø		Provide the same site data information required in Section 2.1 Site Plan: Miscellaneous and Density and Dimensional Requirements of this checklist	

Impervious Area vs. Landscape/Open

Space Area Provided and Required

(As Per Zoning District)

¥

Indicate the applicable zoning district the percentage of

landscaping required and provided, and the impervious

area vs. the amount of landscaping and open spaces

required and provided.

Irrigation Requirements Note	<b>A</b>		of UDC.	Art. VIII 5.04
Tree Locations	<b>Q</b>		Trees must be planted at least five (5) feet from water, sewer and storm sewer lines.  Provide note indicating irrigation will meet requirements	Art. VIII 5.03.E
Street Trees	1		Large trees (a species which normally reaches a height of 30 feet or more upon maturity) shall be provided in the required street landscape buffer in numbers equal to one (1) tree for every 50 feet of street frontage.	Art. V 5.01
Identify Visibility Triangles		D <b>S</b>	Identify visibility triangles on all lots for all driveway intersections and public streets.	Art. V 1.08
Location of all Site Amenities	<b>☑</b>		Identify the size, height, location, and material of proposed seating, lighting, planter's sculptures, water features and landscape paving and other public amenities.	ile:
Parking Lot Landscaping	ch	0	Complete description of landscaping and screening to be provided in or near off-street parking and loading areas, including the information as to the amount (in sq. ft.) of landscape area to be provided internal to parking areas, the total square included in the parking area, and the number and location of required off-street parking and loading spaces.	Art. VIII 5.03.E
Protected Trees (To Remain On-Site)	<b>\</b>		Indicate the location and provide a description by type and size of all existing protected trees (4" or larger) proposed to be retained. Such trees shall be marked and a drip line of said tress shall be protected prior to and during all construction, including dirt work.	Art. IX 5.5
✓ Trees not allowed in Landscape Buffers	Ľ <b>Š</b>		Silver Maple, Box Elder, Mimosa, Catalpa, Hackberry, Sugarberry, Honey Locust, Tulip Tree, Chinaberry, Sycamore, Cottonwood, Willows, American Elm, Siberian Elm, Jerusalem Thorn/Petuma, Bois D'Arc, Flowering Crabapple Tree, Ginko Tree, Peach/Plum, Mulberry, Texas Mountain Laurel, Lilac Chaste Tree, and Pine Tree.	Appendix F
✓ Trees allowed in Street Landscape Buffers	¥		Cedar Elm, Texas Red Oak, Homestead Elm, Lace Bark Elm, Bald Cypress, Chinese Pistachio, October Glory Maple, Pecan, Texas Ash, Live Oak, Chinquapin Oak, and Burr Oak (Understory Trees: Texas Redbud, Mexican Plum, Downy Hawthorn, Wax Myrtle, Yaupon, and Deciduous Yaupon)	Appendix F
Acceptable Landscape Materials:	rese Tourn		landscape buffers.	Art. VIII 4
Drainage Features Indicate all Landscape Buffers	<b>A</b>		proposed significant drainage features.  Indicate the locations and dimensions of the required	Art. VIII 5.01
Location of Water Courses and Significant	(X)		Indicate the locations of all existing and/or proposed water courses and the location of any existing and/or	
Indicate all Landscaping	<b>\sqrt</b>		plan. Indicate the locations of all existing and proposed landscaping.	
Landscape Table	<b>IX</b> I		Provide a landscape table showing plant materials, quantities, size and spacing for existing and proposed landscaping. Complete description of plant materials shown on the plan, including names, locations, qualities, container or caliper sizes at installation, heights, spread, and spacing requirements should also be listed on the	

Requirements	✓= OK	N/A	Comments	UDC Reference
Provide Site Data	ī <b>s</b>		Provide the same site data information required in Section 2.1 Site Plan: Miscellaneous and Density and Dimensional Requirements of this checklist.	1975
Buildings	囟		Indicate the location of all existing or proposed structures, and/or the building pads as shown on the grading plan.	

Indicate all Site Elevations, Grades, Major Contours and the Limits of Construction	<b>I3</b> 9		Art. IX 3
Protected Trees (To Remain On Site)	ď	Indicate the location and provide a description by type and size of all existing protected trees (4" or larger) proposed to be retained. Such trees shall be marked and a drip line of said tress shall be protected prior to and during all construction, including dirt work.	Art. IX 3
Protected Trees (To be Removed from the Site)	团	Indicate the location of all protected trees (4" or larger) that are to be removed from the site and the proposed locations of all replacement trees.	Art. IX 3
Treescape Table	政	Provide a table showing the total inches of trees to be removed and the total inches of trees to be replaced.	Art. IX 3

### **5.1 PHOTOMETRIC AND LIGHTING PLANS**

Requirements	<b>√</b> = OK	N/A	Comments	UDC Reference
Provide Site Data Table Section 2.1 Site Plan: Miscellaneo		Provide the same site data information required in Section 2.1 Site Plan: Miscellaneous and Density and Dimensional Requirements of this checklist.		
Indicate Lighting Levels (in Foot Candles [FC])	Ø		Show lighting levels in foot-candles (FC) measured throughout the site and extended to all property lines of the subject property.	Art. VII 3.4
Adjacent Property with Common Lot Lines:				Art. VII 3.3
✓ Residential Use			The allowable maximum light intensity measured at the property line of a residential property shall be 0.2 of one foot candle.	Art. VII 3.3.B
✓ Commercial Use	<b>I</b>		The allowable maximum light intensity measured at the property line of a non-residential property shall be 0.2 of one foot candle. Subject to requirements in Art. VII 3.3.C.	Art. VII 3.3.C
Under-Canopy Lighting		À	Under canopy lighting (i.e. fuel stations, drive through lanes and covered parking structures) shall not exceed 35 foot candles (with the exception below).	Art. VII 3.3.G.1
Lighting for Motor Vehicle Dealerships		[3]	Shall not exceed 0.3 of one foot candle within the front yard of the development. The remainder will comply with the 0.2 of one foot candle.	Art. VII 3.3.G.2
Lighting in Parking Areas	☑		Non-residential properties shall distribute not more than 0.2 of one foot candle of light upon any adjacent property.	Art. VII 3.4.A
Indicate all Exterior Lighting	K		Indicate the location and type of all exterior lighting, including pole mounted, wall-mounted, signage, etc.	
Indicate the Mounting Height for all Proposed Light Fixtures	ď		No light pole, base or combination thereof shall exceed 30 feet, unless further restricted within an Overlay District.	Art. VII 3.3.D
Indicate the Wattage of all Light Sources	<b>I</b>			
Proposed Light Fixtures	Ø		Provide elevation drawings and/or cut-sheets of proposed light fixtures on/with photometric plan.	æ

### 6.1 BUILDING ELEVATIONS: NON-INDUSTRIAL

Requirements	✓= OK	N/A	Comments	UDC Reference
Provide Exterior Elevations	<b>M</b>		North South East West (Circle all that apply)	
Indicate Exterior Elevations Adjacent to Public Right-of-Way		×	North South East West (Circle all that apply)	æ
90% Masonry Requirement  OVERLAY DISTRICTS ONLY		X	Exterior walls should consist of 90% masonry materials excluding doors and windows.	Art. V 6.02.C
Indicate Amount and Location of the 20% Stone Requirement OVERLAY DISTRICTS ONLY		K	Applies to $\underline{f}$ acades that are visible from a public right-ofway and/or open space.	Art. V 6.02.C
Indicate the Surface Area of Each Facade	Ø		Indicate the surface area (square feet) of each façade and the percentage and square footage of each material used on that façade.	


Proposed Building Materials	<u>V</u>		Specifications and description of all proposed building materials, on all proposed buildings.	*
Indicate the Roofing Materials and Color		X		
Indicate Parapet Wall Height (If Applicable)	₩		If applicable indicate the parapet wall by dashing in the top of roof deck.	
Indicate all Roof Mounted Mechanical Equipment (If Applicable)		<b>L</b> §	If applicable indicate any proposed roof mounted mechanical equipment and indicate how these will be screened from view.	
Indicate Any Additional Design Elements Proposed (If Applicable)		ø	Indicate any additional design elements for the base, walls, or parapets (such as cornice, arcades, and covered walkways/windows). Be sure to include the location, size, color, and material of any proposed structure.	¥
Indicate Building Height(s)	<b>□</b>		The height of the building shall be measured from the average elevation of the finished grade along the front of the building to the highest point of the roof or parapet of the building if it is a flat, mansard or shed roof; or to the midpoint of the roof if it is gable, hip or gambrel roof.	Art. V 4.01.B
Minimum Standards for Articulation:				
Primary Facades (i.e. facades visible from a public ROW, open space/green space, public/private park, and or residential zoning district or residentially used property)		<b>1</b> 29	<ol> <li>Wall Height [H] = H</li> <li>Wall Length [L] = 3 x H</li> <li>Secondary Entry/Arch. Element Length = 25% x L</li> <li>Wall Projection = 25% x H</li> <li>Primary Entry/Arch. Element Width = 2 x (25% x L)</li> <li>Projection Height = 25% x H</li> <li>Primary Entry/Arch. Element Length = 2 x (25% x L)</li> </ol>	Art. V 4.01.C
Secondary Facades		Ø	1. Wall Height [H] = H 2. Wall Length [L] = 3 x H 3. Secondary Entry/Arch. Element Length = 15% x L 4. Secondary Entry/Arch. Element Width = 15% x H 5. Projection Height = 15% x H	Art. V 4.01.C

### 6.2 BUILDING ELEVATIONS: INDUSTRIAL

Requirements	✓= OK	N/A	Comments	<b>UDC</b> Reference
<b>NOTE:</b> Industrial buildings are subject to all the the following standards.	e elements liste	d in Secti	on 6.1 Building Elevations: Non-Industrial with the exc	eption of
90% Masonry Requirement		<b>136</b>	Exterior walls should consist of 90% masonry materials excluding doors and windows.	Art. V 5.01.A
Indicate Amount and Location of the 20% (of the 90%) Stone Requirement	- 0=		Applies to facades that are visible from a public right-of- way and/or open space.	Art. V 5.01.A
Minimum Standards for Articulation: Primary Facades (i.e. facades visible from a public ROW, open space/green space, public/private park, and or residential zoning district or residentially used property)	<b>D</b>		1. Wall Height [H] = H 2. Wall Length [L] = 4 x H 3. Wall Projection = 25% x H 4. Entry/Arch. Element Length = 33% x L 5. Projection Height = 25% x H 6. Entry/Arch. Element Width = 2 x (25% x H)	Art. V 5.01,C
Secondary Facades	4		<ol> <li>Wall Height [H] = H</li> <li>Wall Length [L] = 3 x H</li> <li>Entry/Arch. Element Length = 15% x L</li> <li>Entry/Arch. Element Width = 15% x H</li> <li>Projection Height = 15% x H</li> </ol>	Art. V 5.01.C

Date: 7 / 25 / 19		
Administrative Site Plan/Public Hearing Site Pla	n	
City of Rockwall: Site Plan Review Checklist	Page 6	Last Update: June 3, 2013

1) Is the property located within an Overlay District or a Planned Development District? YES NO  2) If was which Overlay District or Planned Development District?
2) If yes which Overlay District or Planned Development District?
4) If yes note the appeals:
Planning & Zoning Work Session (Packet Due//:):  Date://
ARB Meeting
Date://
Planning and Zoning Meeting (Packet Due /):
Date: / /
1 <sup>st</sup>
2 <sup>nd</sup>
Vote: For, Against; Abstaining, Absent ().
City Council Meeting (Packet Due /):
Date: / /
1 <sup>st</sup>
Vote: For, Against; Abstaining, Absent ().
GENERAL NOTES:

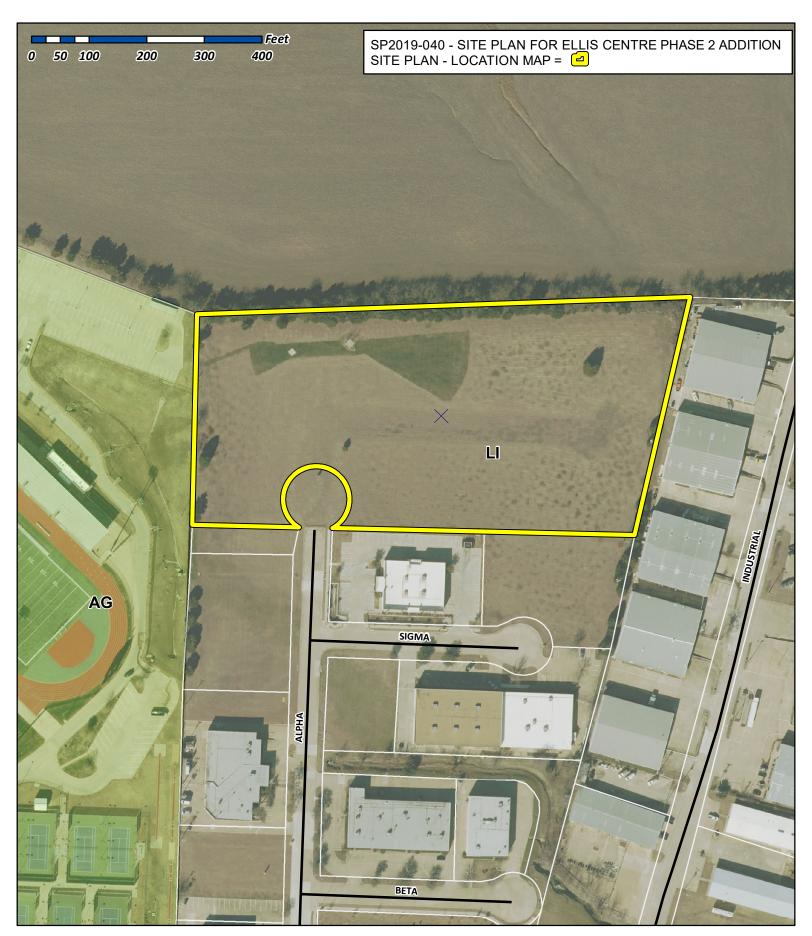



# City of Rockwall

Planning & Zoning Department 385 S. Goliad Street Rockwall, Texas 75032 (P): (972) 771-7745 (W): www.rockwall.com The City of Rockwall GIS maps are continually under development and therefore subject to change without notice. While we endeavor to provide timely and accurate information, we make no guarantees. The City of Rockwall makes no warranty, express or implied, including warranties of merchantability and fitness for a particular purpose. Use of the information is the sole responsibility of the user.





October 18, 2019 AVO 35989

Korey Brooks, AICP Senior Planner Planning and Zoning City of Rockwall 385 S. Goliad St Rockwall, Texas 75087

RE: Detention Pond Slope Variance for Rockwall Urban + Industrial Center

Dear Mr. Brooks:

On behalf of Reid Caldwell and Rockwall Urban Industrial, LP we request a variance to section 3.3.4A of the City of Rockwall Standards of Design and Construction that states "Detention ponds shall have a side slope 4:1 or flatter." Based on maximizing the value of this property and the proposed site layout the detention pond will need to have retaining walls in order to meet the City of Rockwall drainage design.

We believe this variance request is reasonable because it is consistent with the developments directly around our site. The site located directly to our south at the NE Corner of Alpha Dr. and Sigma Ct. has retaining walls built as part of its detention system. If there are any questions or concerns please do not hesitate to contact me.

Sincerely,

Matthew Gardner, P.E.


Civil Engineer


mgardner@halff.com

214-346-6308


HALFF ASSOCIATES, INC.

Matthew Sandner

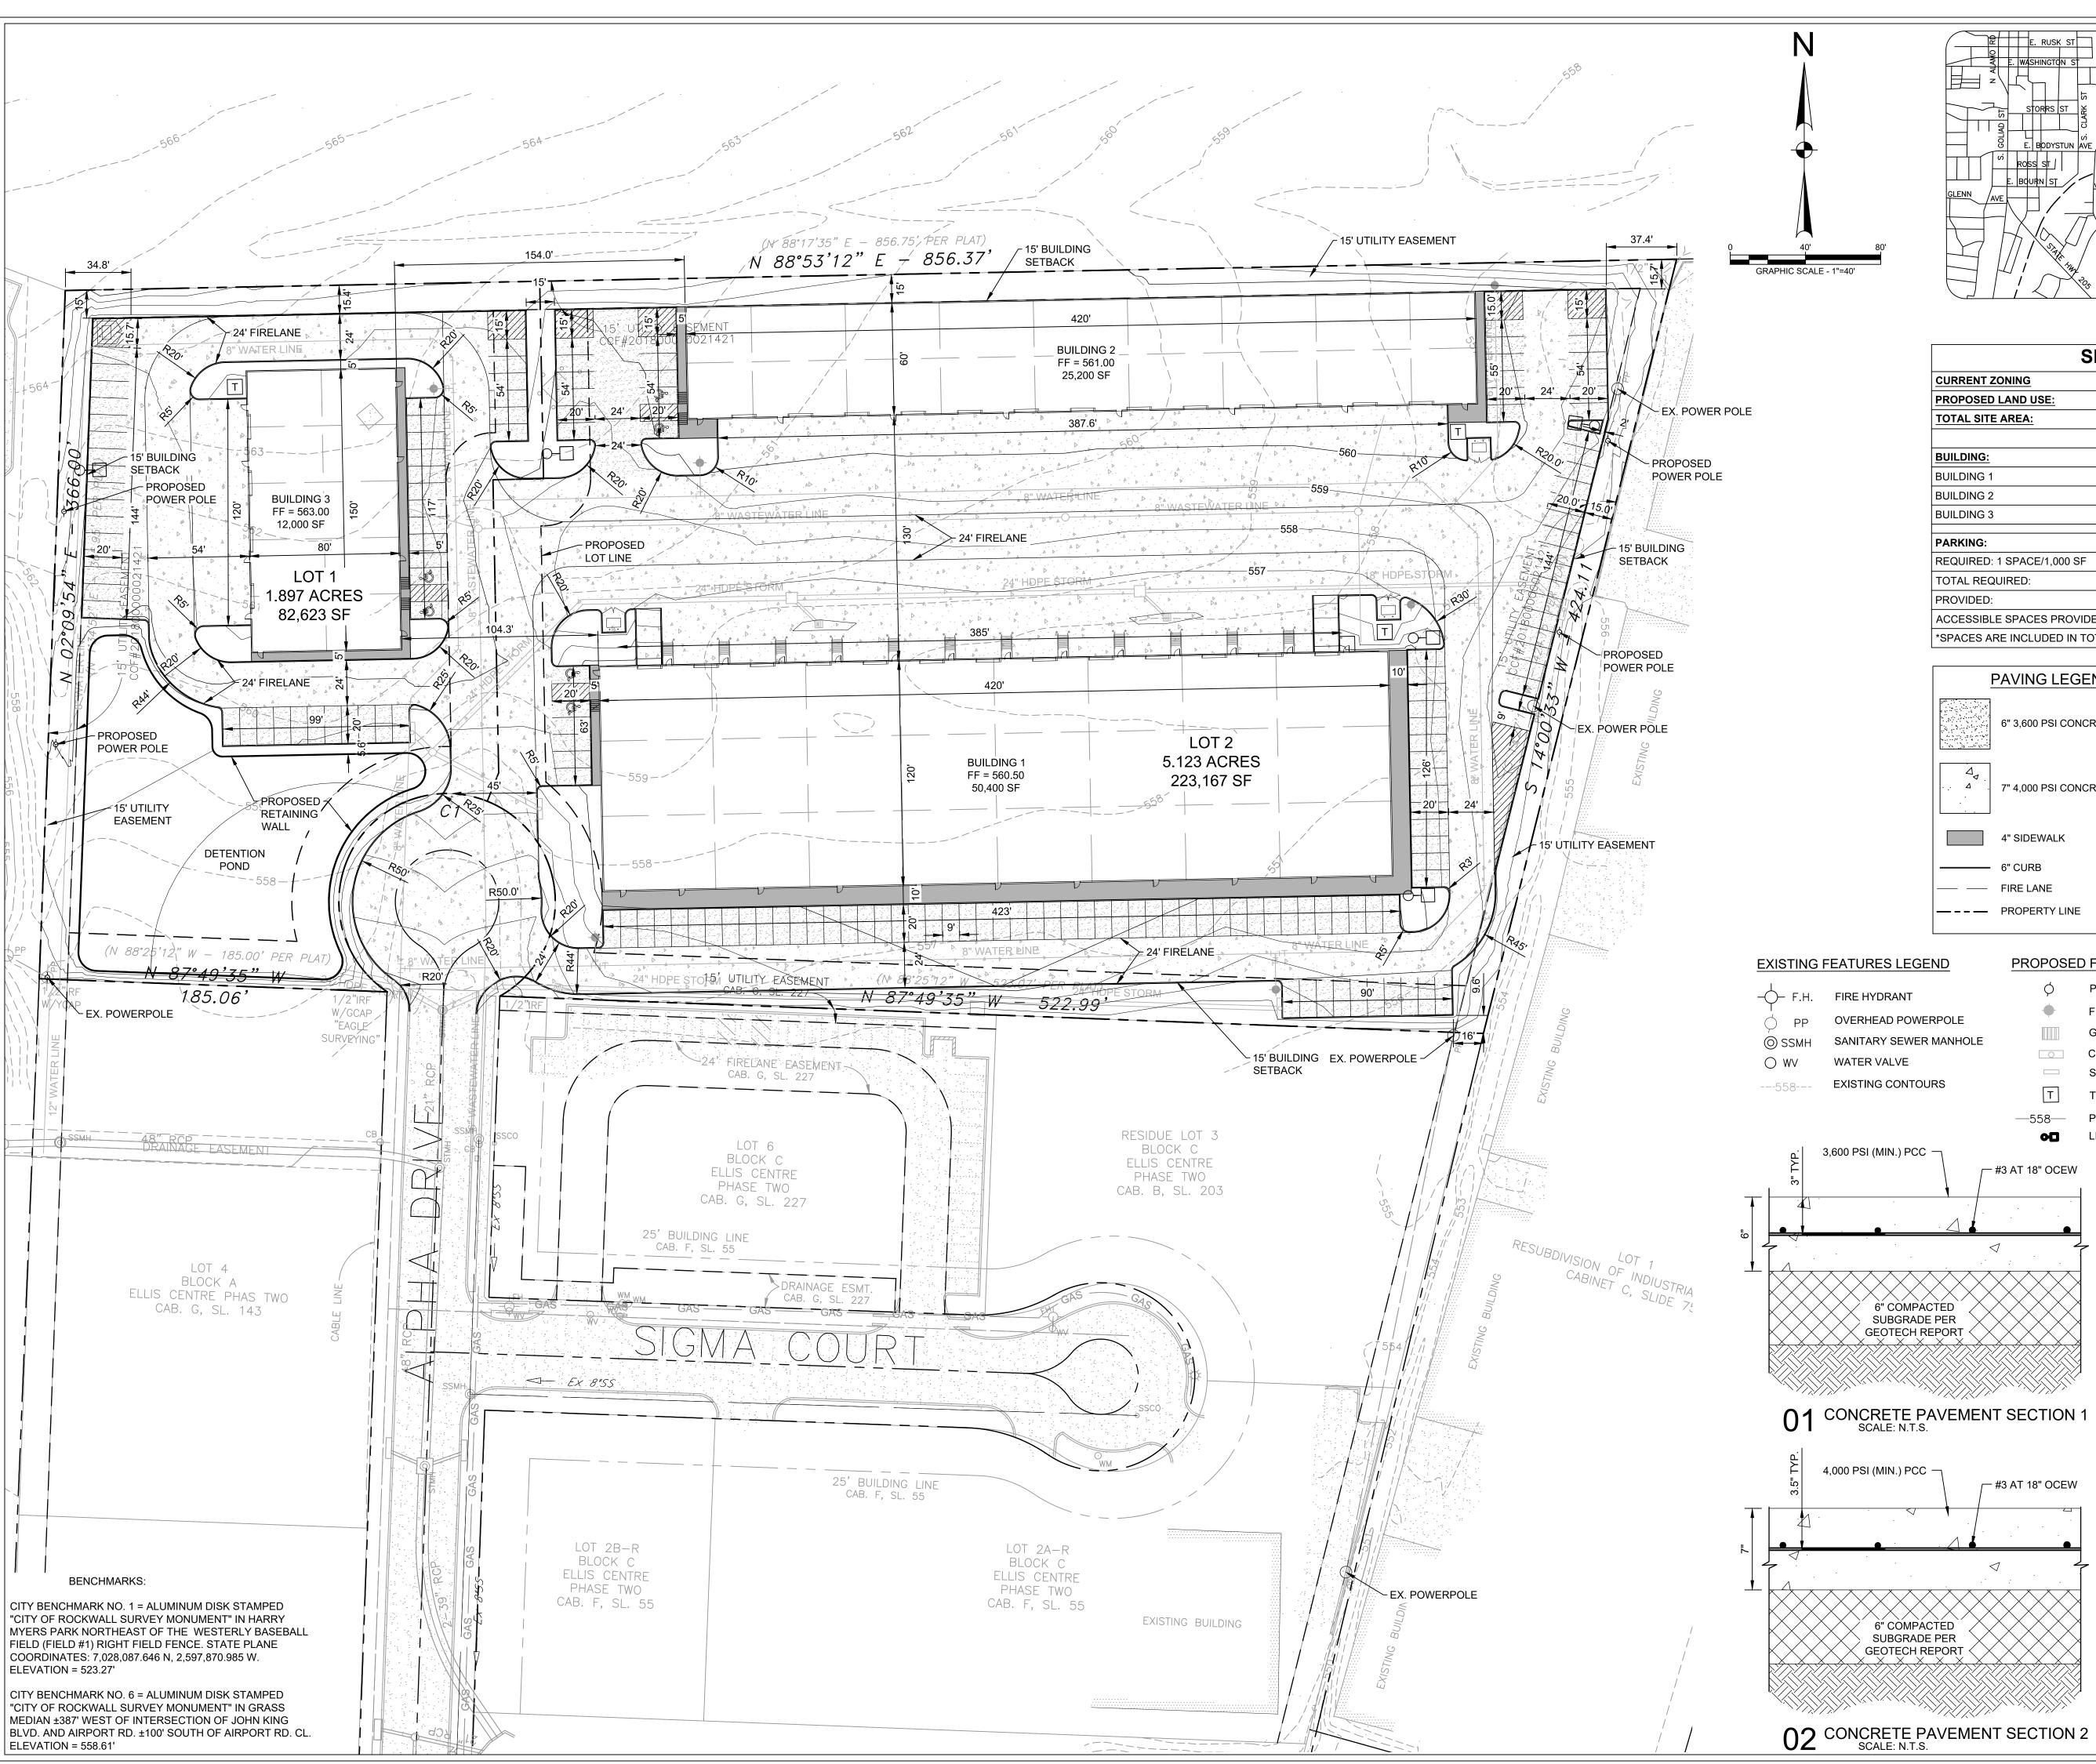

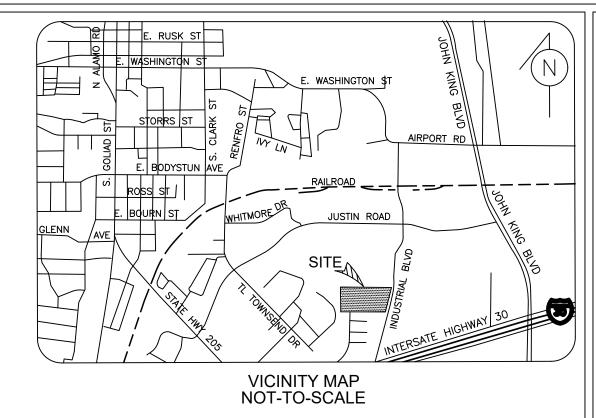


### **SHEET DATA: CURRENT ZONING** LIGHT INDUSTRIAL PROPOSED LAND USE: LIGHT INDUSTRIAL **TOTAL SITE AREA:** 7.02 ACRES **BUILDING**: **BUILDING 1** 50,400 SF BUILDING 2 25,200 SF 12,000 SF BUILDING 3 PARKING: REQUIRED: 1 SPACE/1,000 SF SPACES TOTAL REQUIRED: SPACES PROVIDED: SPACES ACCESSIBLE SPACES PROVIDED: \*SPACES ARE INCLUDED IN TOTAL ABOVE

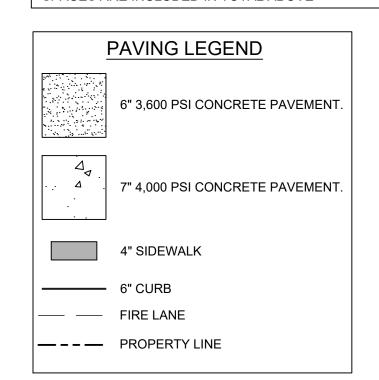


PROPOSED FEATURES LEGEND

	FIDE LIVED ANT	ø	POWER POLE
<b>)</b> − F.H.	FIRE HYDRANT	•	FIRE HYDRANT
→ PP  →	OVERHEAD POWERPOLE		
SSMH	SANITARY SEWER MANHOLE		GRATE INLET
$\bigcirc$ WV	WATER VALVE	0	CURB INLET
<b>O</b>	EXISTING CONTOURS		STORM HEADWALL
558	EXISTING CONTOURS	T	TRANSFORMER PAD
		<u> </u>	PROPOSED CONTOU

LIGHT POLE

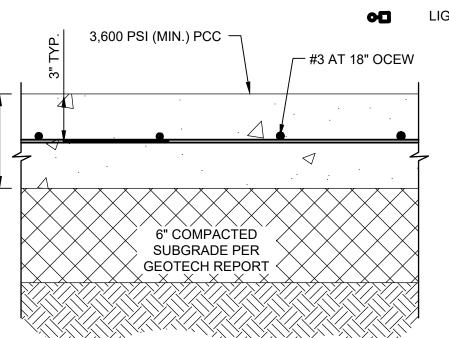

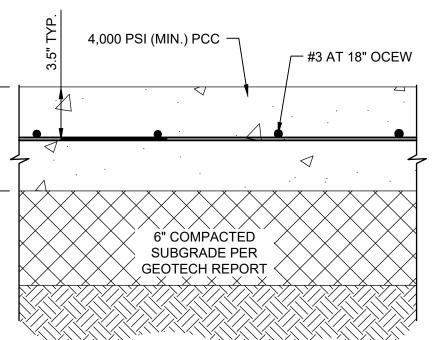

TEL: (214) 457-8198 **ENGINEER** HALFF ASSOCIATES, INC. 1201 NORTH BOWSER ROAD RICHARDSON, TX. 75081 CONTACT: DYLAN HEDRICK EMAIL: dhedrick@halff.com TEL: (214) 217-6426 TBPE FIRM# F-312

NOTES:

NOTED.

13150 COIT ROAD DALLAS, TX. 75240

ALL RESPONSIBILITY FOR ADEQUACY OF DESIGN REMAIN WITH THE DESIGN ENGINEER. THE CITY OF ROCKWALL, IN REVIEWING AND RELEASING PLANS FOR CONSTRUCTION, ASSUMES NO RESPONSIBILITY FOR ADEQUACY OF DESIGN.

1. ALL DIMENSIONS ARE TO FACE

ROCKWALL URBAN INDUSTRIAL, LP

OWNER/ DEVELOPER

CONTACT: REID CALDWELL

EMAIL: reid@longbowinterests.com

OF CURB UNLESS OTHERWISE

SHEET SIZE: 24" x 36" | Sheet Number

Case Number:

Industrial

Rockwall

DRIVE 75087

END


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DYLAN B. HEDRICK TBPE FIRM # F-312

Project No.: 35989 Issued: OCTOBER 2019 Drawn By: REP Checked By: DBH Scale: AS SHOWN

Sheet Title DETAILED SITE PLAN 1 OF 1



### PLANTING PLAN

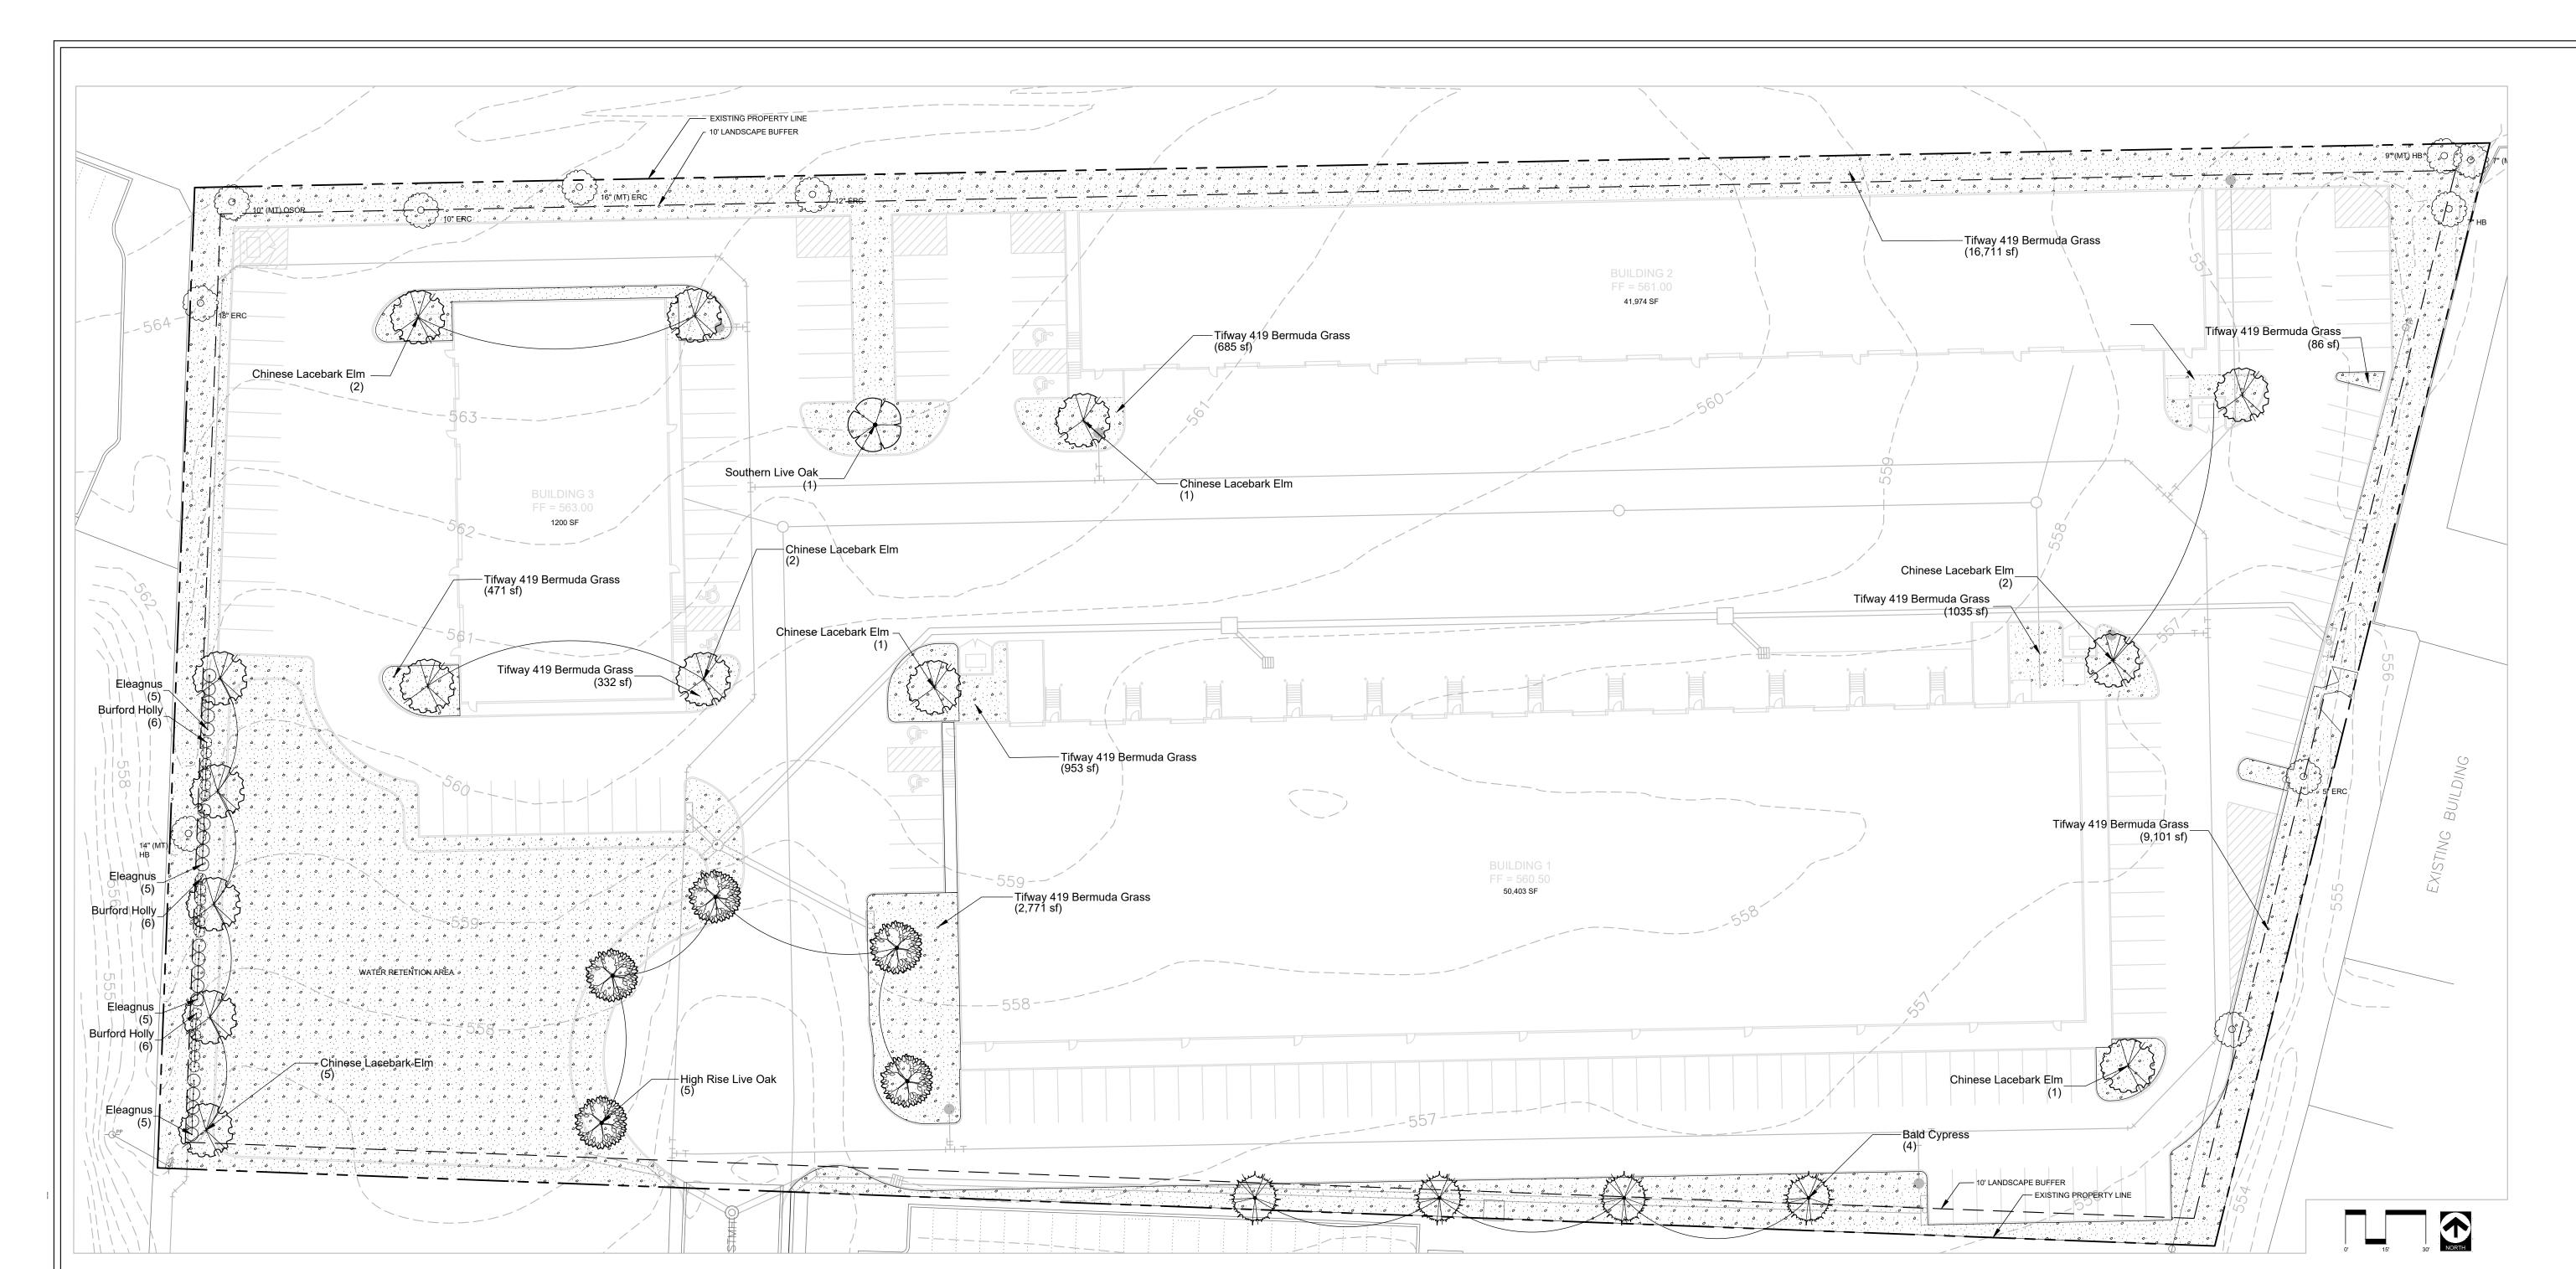rrees	BOTANICAL / COMMON NAME	CONT	CAL	HT	SPD	QTY
	Quercus virginiana / Southern Live Oak	45 gal	3" Cal	8`-10` Ht.	4`-6` Spd	1
	Quercus virginiana `High Rise` / High Rise Live Oak	45 gal	3" Cal	8`-10` Ht.	6`-7` Spd.	5
	Taxodium distichum / Bald Cypress	45 gal	3" Cal	10`-12` Ht.	4`-6` Spd	4
	Ulmus parvifolia / Chinese Lacebark Elm	45 gal	3" Cal	8`-10` Ht.	4`-6` Spd	14
SHRUBS	BOTANICAL / COMMON NAME	SIZE	CAL	HT	SPD	QTY
$\odot$	Elaeagnus x ebbingei / Eleagnus	5 gal		18"-24" Ht.	18"-24" Spd	20
$\odot$	llex cornuta `Burfordii` / Burford Holly	5 gal		18"-24" Ht.	18"-24" Spd	18
ROUND COVERS	BOTANICAL / COMMON NAME	CONT	SIZE			QTY
6 6 6 6 6	Cynodon dactylon `Tifway 419` / Tifway 419 Bermuda Grass	SOLID SOD				66,576 st

# **EXISTING TREES**

EXISTING TREE TO REMAIN

# LANDSCAPE REQUIREMENTS

REQUIRED LANDSCAPING		
REQUIRED LANDSCAPING		
ZONED LIGHT INDUSTRIAL	REQUIRED	PROVIDED
TOTAL LANDSCAPE AREA PROVIDED (%)	10% OF SITE	21% OF SITE
TOTAL LANDSCAPE AREA PROVIDED (SF)	31,598 SF	66,576 SF
TREE MITIGATION		
	REQUIRED	PROVIDED
MITIGATION REQUIREMENTS (inches)	59" CALIPER*	60" CALIPER
* See Sheet L 1.01 for calculations		
PARKING LOT LANDSCAPING		
17111111110 1201 12 11 12007 11 1110	1	
	REQUIRED	PROVIDED
200 SF MIN/ 2 ROWS OR MORE	REQUIRED	PROVIDED   √
	REQUIRED 600 SF	,
200 SF MIN/ 2 ROWS OR MORE	,	√ 
200 SF MIN/ 2 ROWS OR MORE 3 AREAS 200 FT/SQ X 3	,	√ 
200 SF MIN/ 2 ROWS OR MORE 3 AREAS 200 FT/SQ X 3 ONE TREE WITHIN 80' OF REQ. PARKING	,	\frac{1}{}
200 SF MIN/ 2 ROWS OR MORE 3 AREAS 200 FT/SQ X 3 ONE TREE WITHIN 80' OF REQ. PARKING PERMIABLE LANDSCAPE PROVIDED	,	\frac{1}{}
200 SF MIN/ 2 ROWS OR MORE 3 AREAS 200 FT/SQ X 3 ONE TREE WITHIN 80' OF REQ. PARKING PERMIABLE LANDSCAPE PROVIDED	600 SF	√ √ √ 3,756 SF

REQUIRED PROVIDED

STREET TREES

1 TREE /50' FRONTAGE

# PLANTING NOTES

LANDSCAPE CONTRACTOR SHALL BE RESPONSIBLE FOR VERIFYING THE CORRECT LOCATION OF ALL UNDERGROUND UTILITIES, PIPES, STRUCTURES, AND LINE RUNS IN THE FIELD PRIOR TO THE INSTALLATION OF ANY PLANT MATERIALS.

REFER TO PLANTING PLAN FOR PlaNTING LOCATION AND PLANT MATERIAL LEGEND FOR SPECIFICATIONS. PLANT MATERIAL LOCATION TO BE STAKED IN THE FIELD AND APPROVED BY LANDSCAPE ARCHITECT PRIOR TO PLANTING.

LANDSCAPE CONTRACTOR SHALL BE RESPONSIBLE FOR ANY COORDINATION WITH OTHER CONTRACTORS ON SITE AS REQUIRED TO ACCOMPLISH ALL PLANTING OPERATIONS.

LANDSCAPE CONTRACTOR SHALL BE RESPONSIBLE FOR MAINTAINING ALL PLANTING BEDS IN A WEED AND DEBRIS FREE CONDITION AND SHALL ACCOMPLISH WATERING BY HAND AS DEEMED NECESSARY UNTIL SUBSTANTIAL

30 DAYS AFTER SUBSTANTIAL COMPLETION AND ACCEPTANCE. LANDSCAPE CONTRACTOR SHALL BE RESPONSIBLE FOR ALL QUANTITIES PER DRAWINGS AND SPECIFICATION BY IANDSCAPE ARCHITECT. PLANT QUANTITIES HAVE BEEN PROVIDED AS A CONVENIENCE ONLY AND SHALL NOT BE CONSIDERED ABSOLUTE. LANDSCAPE ARCHITECT TO BE NOTIFIED IF DISCREPANCIES OCCUR. OTHERWISE, THE

COMPLETION AND ACCEPTANCE BY THE OWNER. THE CONTRACTOR SHALL MAINTAIN ALL WORK FOR A PERIOD OF

ALL BED AREAS ARE TO BE FLUSH WITH FINISHED GRADE AT ADJACENT PAVEMENT. ALL BED AREAS SHALL BE ROTOTILLED TO BE A DEPTH OF 6", ADDING PREPARED SOIL MIXTURE AS REQUIRED.


CONTRACTOR IS TO BID THEIR OWN VERIFIED QUANTITIES PER LANDSCAPE PLAN.

MULCH
AFTER SETTLEMENT, ALL PLANTING BED MULCH DEPTHS SHALL BE A MIN. OF 3". ALL AREAS DISTURBED BY PLANTING OPERATIONS SHALL BE FINE GRADED AND REPLANTED. MULCH SHALL BE TEXAS NATIVE CEDAR

ALL PLANT MATERIAL SHALL CONFORM TO THE SIZES GIVEN IN THE PLANT LIST AND SHALL BE NURSERY GROWN IN ACCORDANCE WITH THE "AMERICAN STANDARD FOR NURSERY STOCK", LATEST EDITION. ALL PLANTING SHALL BE IN ACCORDANCE WITH STANDARD AMERICAN ASSOCIATION OF NURSERYMEN PROCEDURES AND SPECIFICATIONS.

PROTECTED TREES SHALL BE MARKED AND THE DRIP LINE OF SAID TREES SHALL BE PROTECTED PRIOR TO AND DURING ALL CONSTRUCTION, INCLUDING EARTHWORK.

IRRIGATION WILL MEET ALL TCEQ AND UDC REQUIREMENTS.

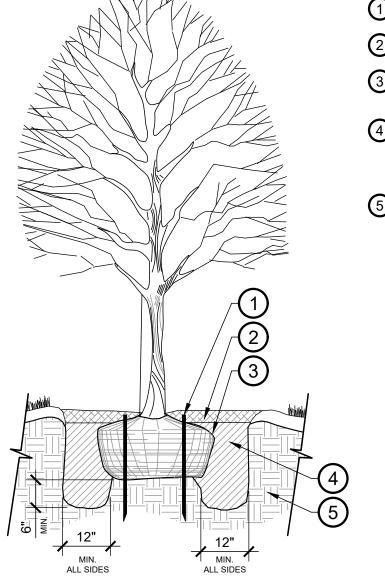

**NEW TREE PLANTING** 

NEVER CUT LEADER

(3) ARBOR STAKES. INSTALL PER MANUFACTURE'S SPECIFICATIONS

2 SPECIFIED MULCH - 3" MIN. DEPTH ENTIRE TREE BASIN 3 SET TOP OF ROOT BALL 3" ABOVE FINISH GRADE. BUILD 3" HT. SAUCER AROUND PLANTING PIT WITH TOPSOIL.

4 LIVING EARTH PLANTING MIX OR APPROVED EQUAL BY LANDSCAPE ARCHITECT. WATER AND TAMP TO REMOVE SIDE AND BOTTOM AIR POCKETS 6" MIN.

5 UNCOMPACTED NATIVE SOIL/UNDISTURBED SUBGRADE

FOR BALL & BURLAP REMOVE WIRE/TWINE FROM AROUND BURLAP, FOLD TOP THIRD DOWN OR CUT/REMOVE PRIOR TO BACKFILL.

> Project No.: 35989 Issued: Drawn By: CAP Checked By: MAW AS SHOWN Scale:

LANDSCAPE PLAN


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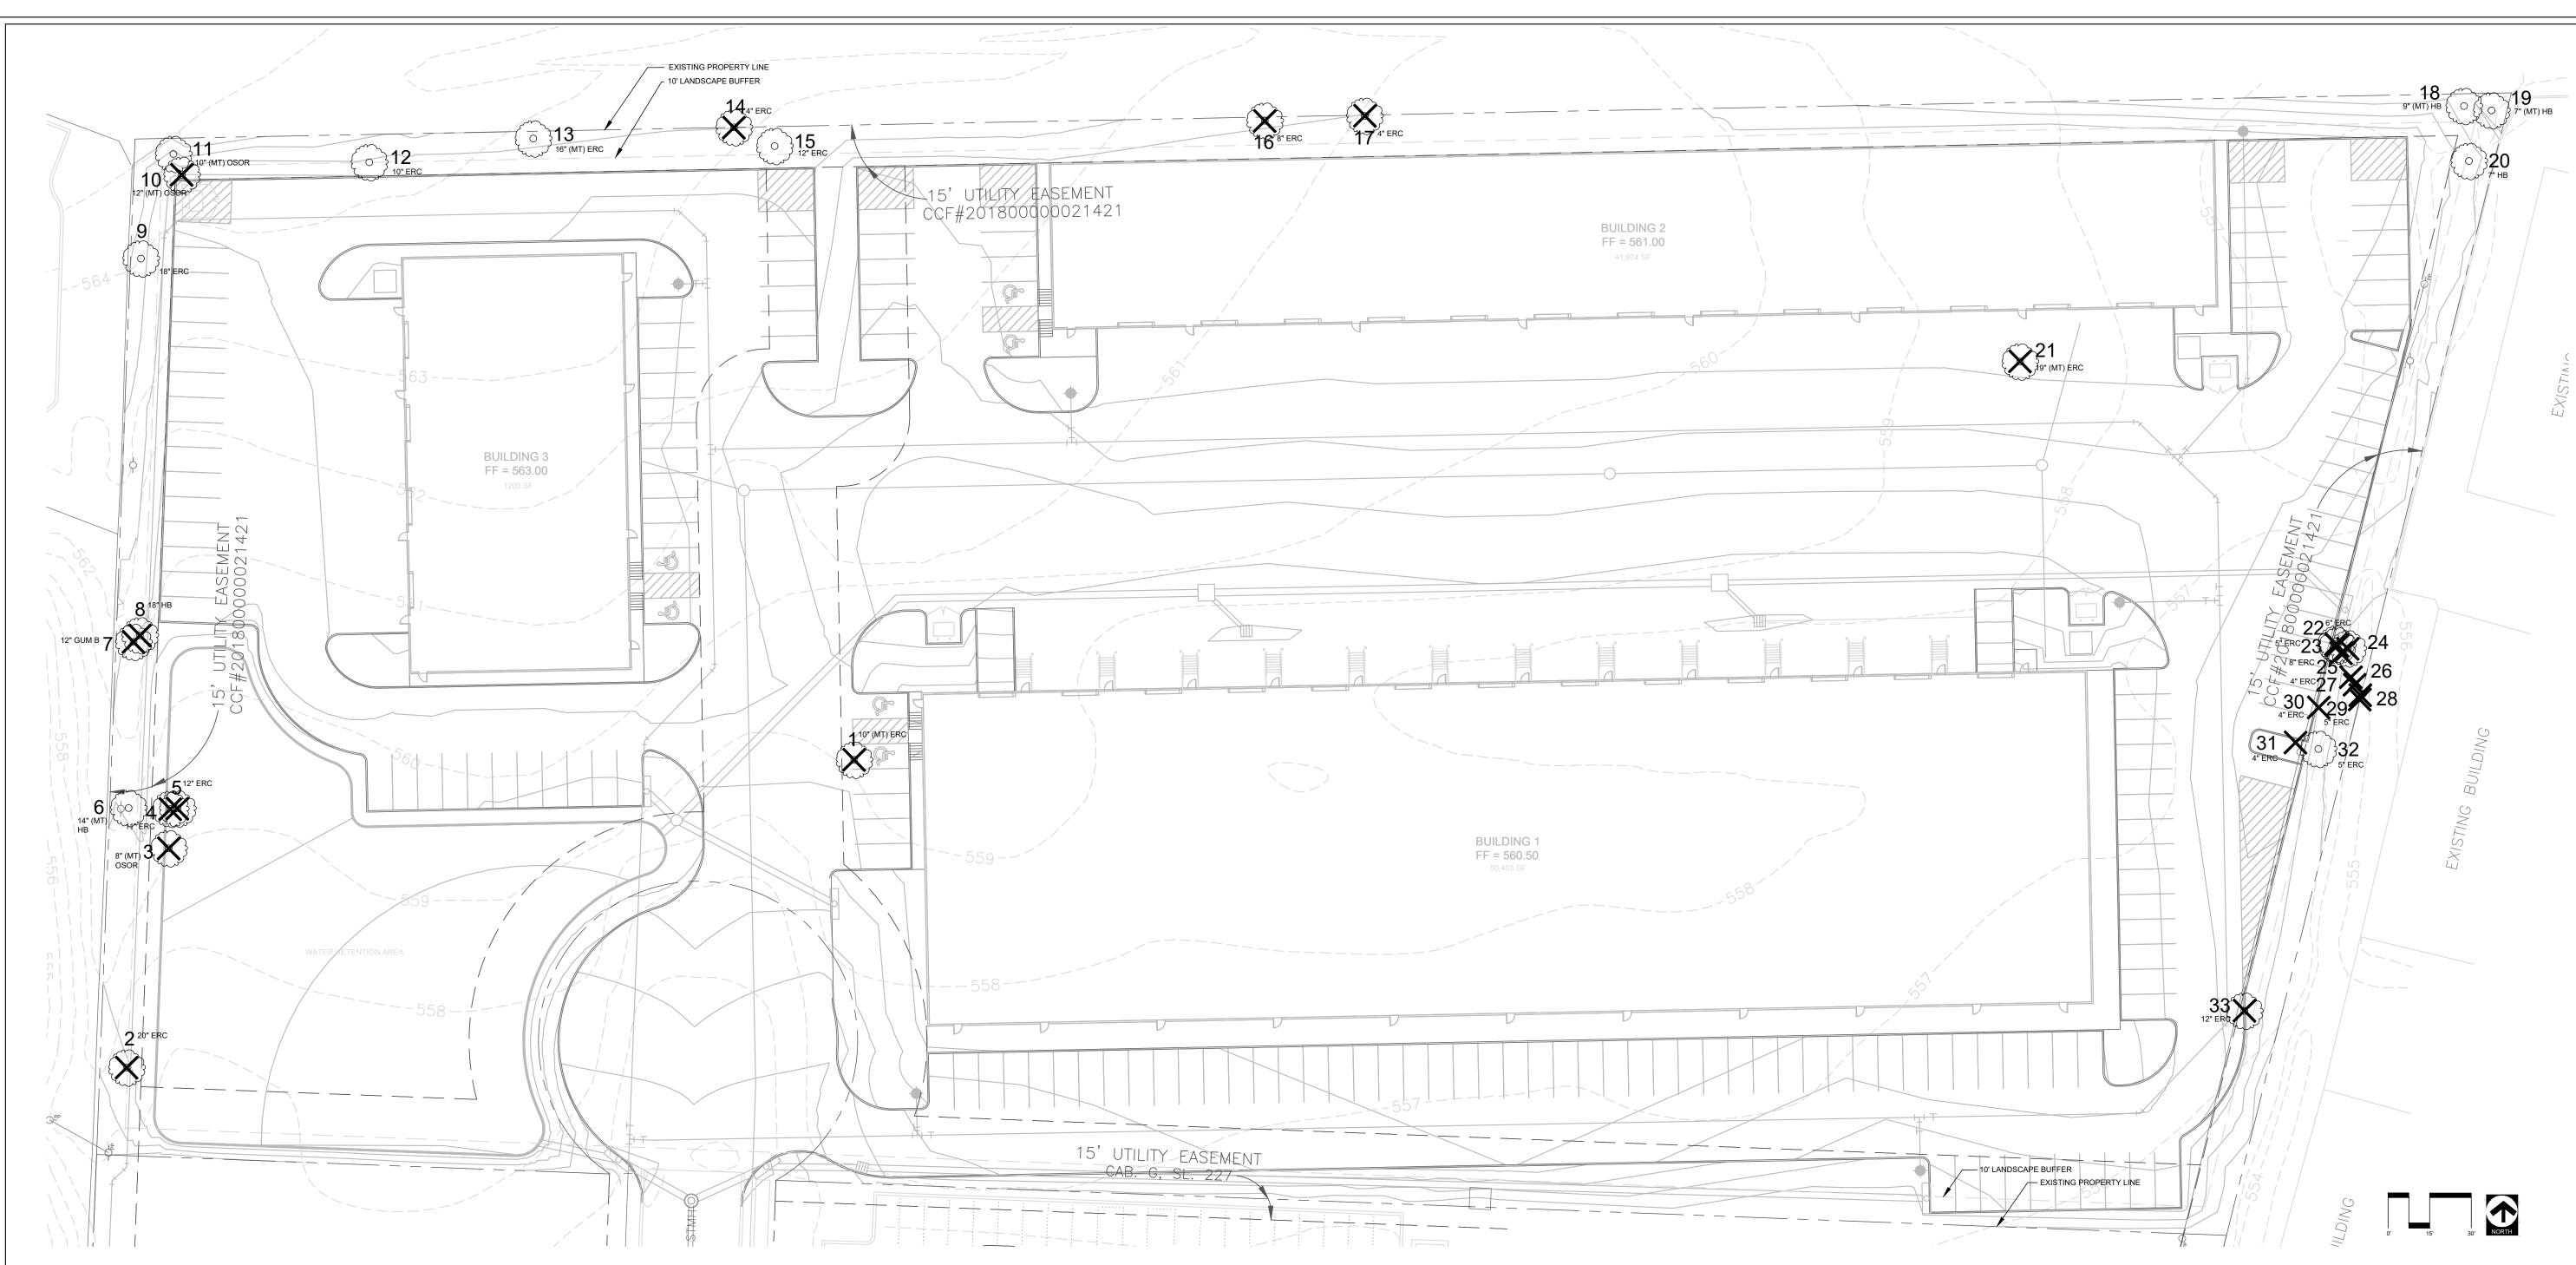
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Sheet Title

<u>l</u>nd

Rockwall



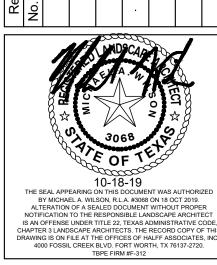

## TREE INVENTORY / MITIGATION

TREE #	SPECIES	SIZE (inches)	CLASSIFICATION	STATUS	REQ. MITIGATION (Inches
1	EASTERN RED CEDAR	10 MULTI-TK	NON-PROTECTED	REMOVE	
2	EASTERN RED CEDAR	20	SECONDARY	REMOVE	10
3	OSAGE ORANGE	8 MULTI-TK	NON-PROTECTED	REMOVE	
4	EASTERN RED CEDAR	11	SECONDARY	REMOVE	6
5	EASTERN RED CEDAR	12	SECONDARY	REMOVE	6
6	HACKBERRY	14 MULTI-TK	SECONDARY	PRESERVE	
7	GUM BUMILIA	12	PROTECTED	REMOVE	12
8	HACKBERRY	18	SECONDARY	REMOVE	9
9	EASTERN RED CEDAR	18	SECONDARY	PRESERVE	
10	OSAGE ORANGE	12 MULTI-TK	NON-PROTECTED	REMOVE	
11	OSAGE ORANGE	10 MULTI-TK	NON-PROTECTED	PRESERVE	
12	EASTERN RED CEDAR	10	SECONDARY	PRESERVE	
13	EASTERN RED CEDAR	16 MULTI-TK	SECONDARY	PRESERVE	
14	EASTERN RED CEDAR	4	NON-PROTECTED	REMOVE	
15	EASTERN RED CEDAR	12	SECONDARY	PRESERVE	
16	EASTERN RED CEDAR	8	NON-PROTECTED	REMOVE	
17	EASTERN RED CEDAR	4	NON-PROTECTED	REMOVE	
18	HACKBERRY	9 MULTI-TK	NON-PROTECTED	PRESERVE	
19	HACKBERRY	7 MULTI-TK	NON-PROTECTED	PRESERVE	
20	HACKBERRY	7	NON-PROTECTED	PRESERVE	
21	EASTERN RED CEDAR	19 MULTI-TK	SECONDARY	REMOVE	10
22	EASTERN RED CEDAR	6	NON-PROTECTED	REMOVE	
23	EASTERN RED CEDAR	5	NON-PROTECTED	REMOVE	
24	EASTERN RED CEDAR	5	NON-PROTECTED	REMOVE	
25	EASTERN RED CEDAR	8	NON-PROTECTED	REMOVE	
26	EASTERN RED CEDAR	6	NON-PROTECTED	REMOVE	
27	EASTERN RED CEDAR	5	NON-PROTECTED	REMOVE	
28	EASTERN RED CEDAR	5	NON-PROTECTED	REMOVE	
29	EASTERN RED CEDAR	5	NON-PROTECTED	REMOVE	
30	EASTERN RED CEDAR	4	NON-PROTECTED	REMOVE	
31	EASTERN RED CEDAR	4	NON-PROTECTED	REMOVE	
32	EASTERN RED CEDAR	5	NON-PROTECTED	PRESERVE	
33	EASTERN RED CEDAR	12	SECONDARY	REMOVE	6
ΤΩΤΛΙ					50

# **EXISTING TREES**



EXISTING TREE TO REMAIN




EXISTING TREE TO BE REMOVED

# LANDSCAPE REQUIREMENTS

TREE MITIGATION	
REQUIRED TREES (inches)	59" CALIPER
PROVIDED TREES (inches)	60" CALIPER
* See Sheet L 2.01 for Planting Locations	

# PLAN VIEW

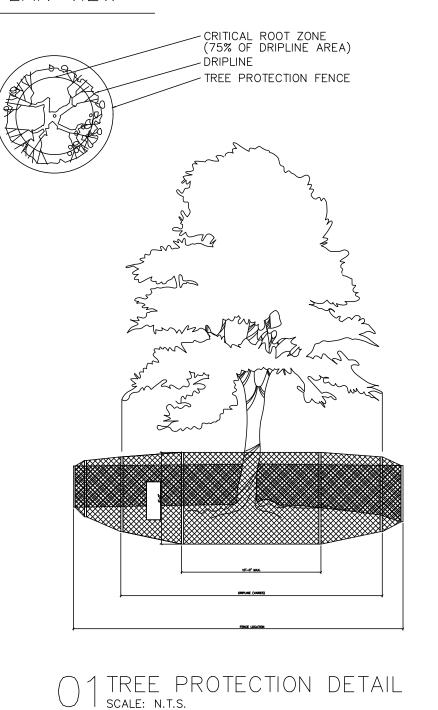

### STANDARD PRESERVATION NOTES FOR TREE AND NATURAL AREA PROTECTION

- All trees and natural areas shown on plan to be preserved shall be protected during construction with temporary fencing and other measures as needed which may include retaining walls, pruning of limbs, roots, etc.
   Protective fences shall be erected according to City Standards for Tree Protection.
   Protective fences shall be installed prior to the start of any site preparation work (clearing, grubbing or grading), and shall be maintained throughout all phases of the construction project.
- 4. Erosion and sedimentation control barriers shall be installed or maintained in a manner which does not result in
- soil build-up within tree drip lines. 5. Protective fences shall surround the trees or group of trees, and will be located no closer than the outermost limit of branches (drip line) plus an additional 2'-0" away from the limits of dripline. For natural areas, protective fences shall follow the Limit of Construction line, in order to prevent the following:

  A. Soil compaction in the root zone area resulting from vehicular traffic or storage of equipment or materials;

  B. Root zone disturbances due to grade changes (greater than 6 inches cut or fill), or trenching not reviewed and authorized by the City Parks Department;

  C. Wounds to exposed roots, trunk or limbs by mechanical equipment;

  D. Other activities detrimental to trees such as chemical storage cement truck cleaning, and fires
- D. Other activities detrimental to trees such as chemical storage, cement truck cleaning, and fires.
  6. Exceptions to installing fences at tree drip lines may be permitted in the following cases:

Arborist to discuss alternatives.


- A. Where there is to be an approved grade change, impermeable paving surface, tree well, or other such site development, erect the fence approximately 2 to 4 feet beyond the area disturbed;
- B. Where permeable paving is to be installed within a tree's drip line, erect the fence at the outer limits of the permeable paving area (prior to site grading so that this area is graded separately by hand prior to paving installation to minimized root damage);


  C. Where trees are close to proposed buildings, erect the fence to allow root pruning in the work space between the fence and the building, prior to disturbance. The fence can be erected at the point of root pruning;

  D. Where there are severe space constraints due to tract size, or other special requirements, contact an
- Special Note: Exceptions are permitted for areas outside the critical root zone. No disturbances are permitted within the critical root zone (75% of the dripline area). For the protection of natural areas, no exceptions to installing fences at the Limit`of Construction line will be permitted, and no silting of stock piling of material or dirt is
- allowed around trees.
- Where any of the above exceptions result in a fence being closer than 4 feet to a tree trunk, protect the trunk with strapped—on planking to a height of 8 ft. in addition to the reduced fencing provided.

  Trees approved for removal shall be removed in a manner which does not impact trees to be preserved.
- 8. Trees approved for removal shall be removed in a manner which does not impact trees to be preserved.
   9. Any roots exposed by construction activity shall be pruned flush with the soil. Backfill root areas with good quality top soil as soon as possible. If exposed root areas are not backfilled within 2 days, cover them with organic material in a manner which reduces soil temperature and minimizes water loss due to evaporation.
   10. Trenching required for the installation of irrigation shall be placed as far from existing tree trunks as possible.
   11. No landscape topsoil dressing greater than 2 inches shall be permitted within the drip line of trees. No soil or mulch is permitted on the root flare of any tree.
   12. Limbing & pruning to provide clearance for structures, traffic and equipment shall take place before damage occurs.
   13. All finished pruning shall be done according to recognized, approved standards of the industry (Reference the National Arborist Association Pruning Standards for Shade Trees).

Rockwall

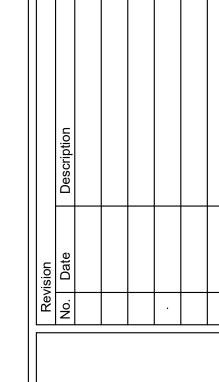

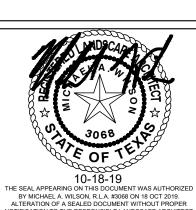


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TBPE FIRM #F-312

Project No.: 35989 Issued: 10-18-19 Drawn By: CAP Checked By: MAW Scale: AS SHOWN

Sheet Title TREESCAPE PLAN

L 1.01

SHEET SIZE: 24" x 36" | Sheet Number

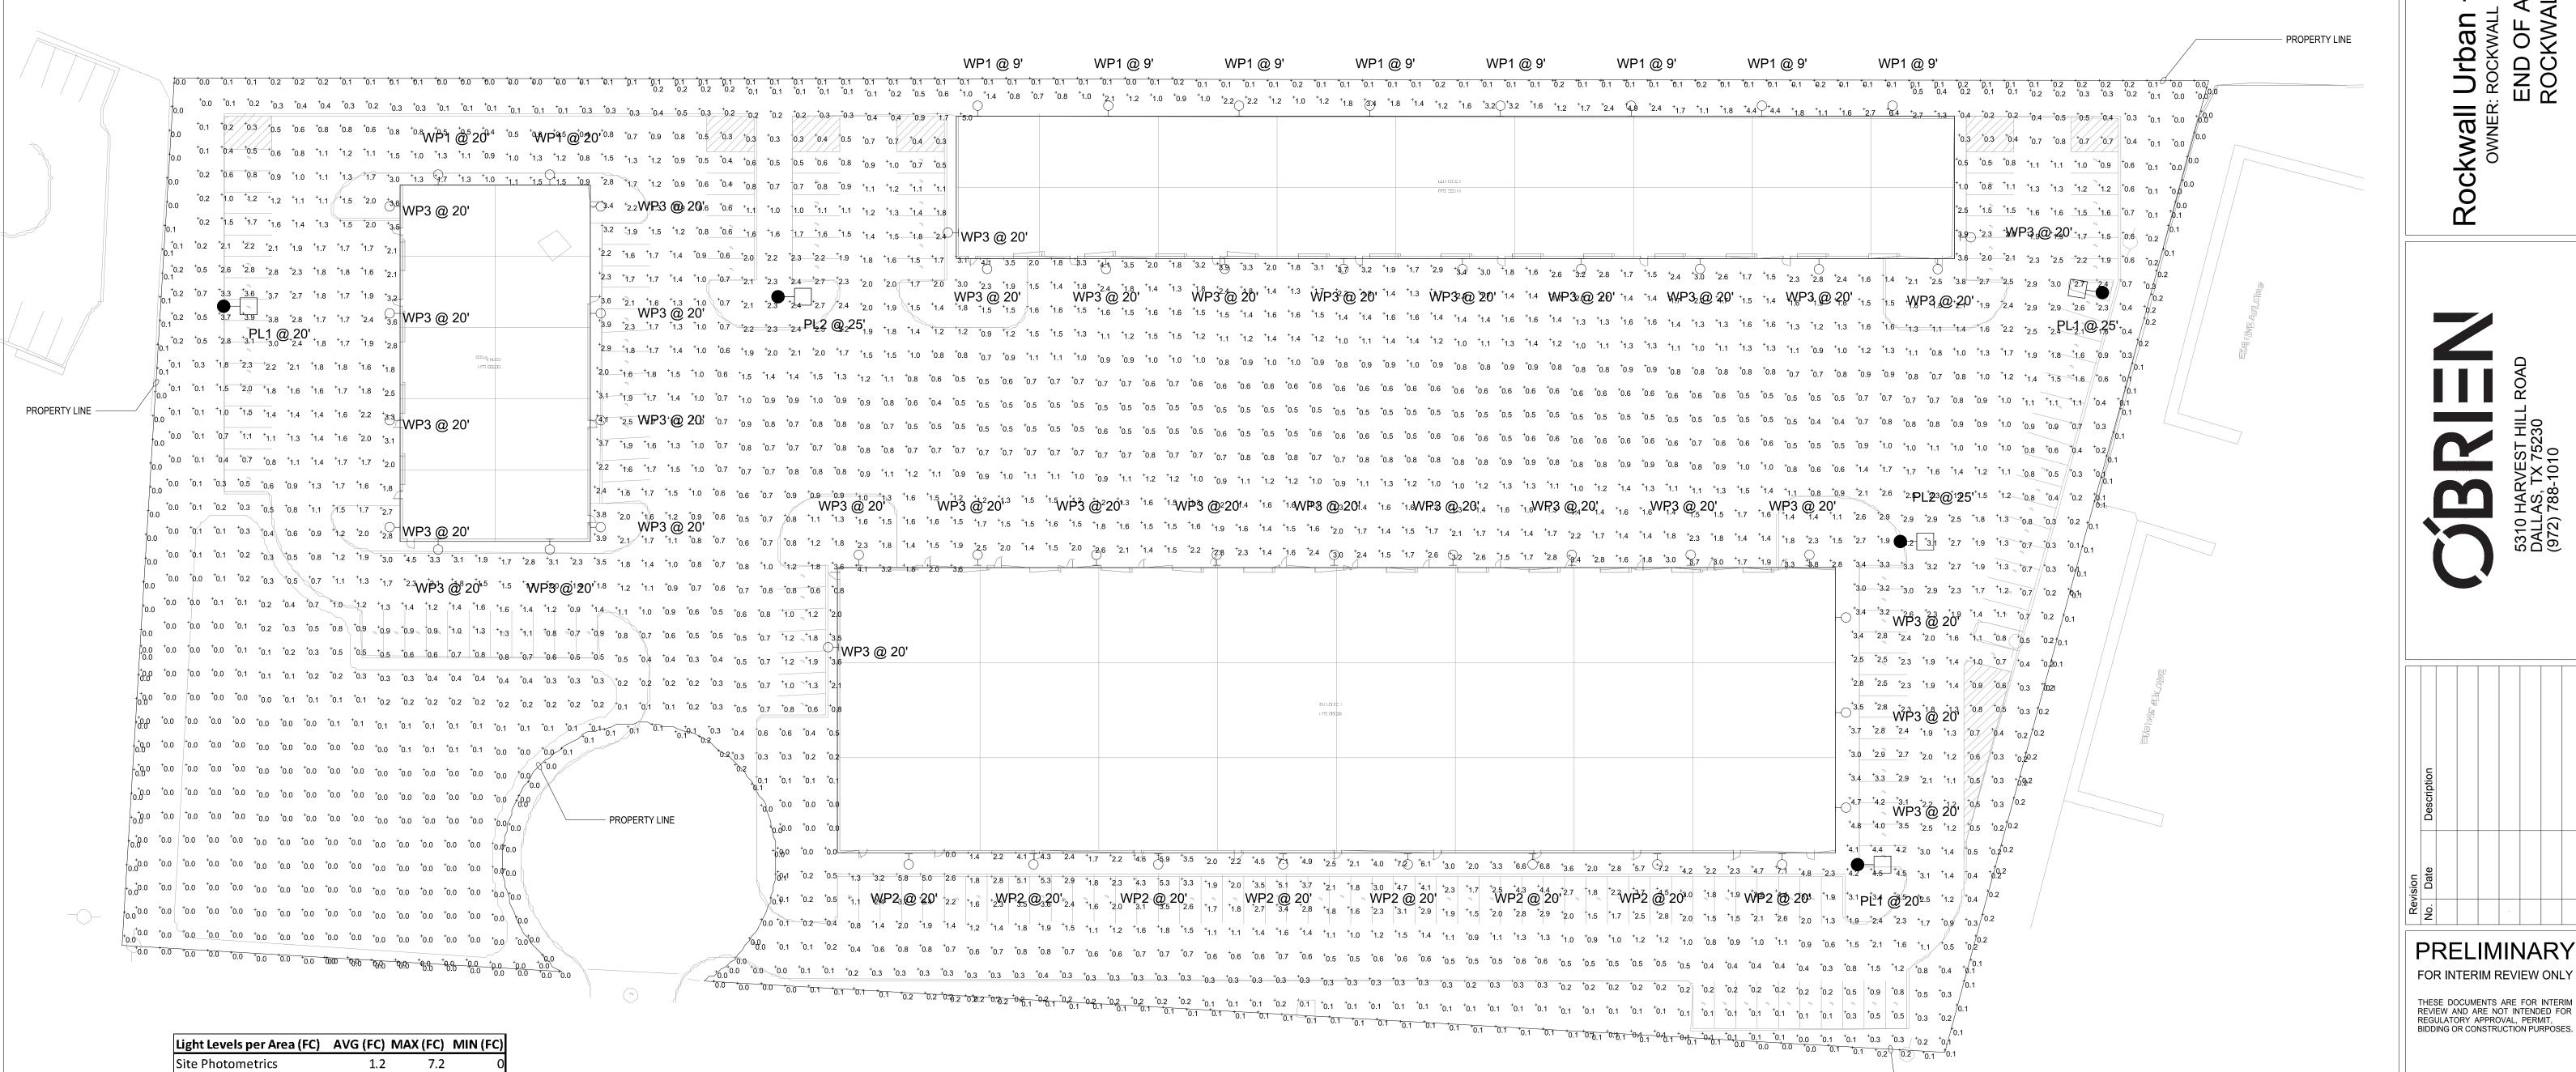

0.2

Description

WSR LED WITH P1-PERFORMANCE PACKAGE ,4000K, AND SR2 OPTIC TYPE WST LED Performance package 3 4000 K, visual comfort forward throw, MVOLT

WSR LED WITH P4-PERFORMANCE PACKAGE, 4000K, AND SR4 OPTIC TYPE

DSX0 LED P5 40K T2M MVOLT with houseside shield

DSX0 LED P6 40K T5M MVOLT with houseside shield

Lamp Lamp Lumens Watts

6609

6388

9550

11955

50

61

89

134

0.1

Along Property Line

Catalog Number

WSR LED P1 SR2 40K MVOLT

WST LED P3 40K VF MVOLT

WP3 WSR LED P4 SR4 40K MVOLT

PL1 DSX0 LED P5 40K T2M MVOLT HS

PL2 DSX0 LED P6 40K T5M MVOLT HS

SITE PHOTOMETRICS SCALE: 1/32" = 1'-0"



- PROPERTY LINE

17855 North Dallas Parkway • Suite 320 Dallas, TX, 75287 p. 469.385.1616 • f. 469.385.1615 Texas Registered Engineering Firm F-4990 Project Number:1930681 Drawn By:DNH Checked By:JW

SHEET SIZE: 24" x 36"

Sheet Number Case Number:

Sheet Title SITE

Project No.:

Checked By:

Issued: Drawn By:

JOSHUA WILEY

OCTOBER 2019


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**PHOTOMETRICS** 

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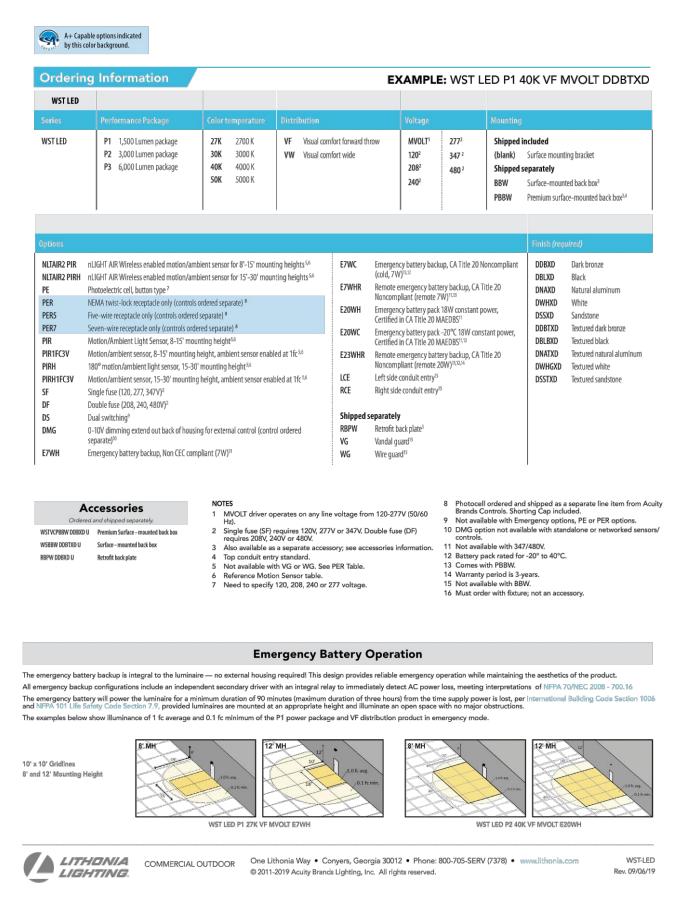
Center, LP.


Rockwall OWNER:




COMMERCIAL OUTDOOR

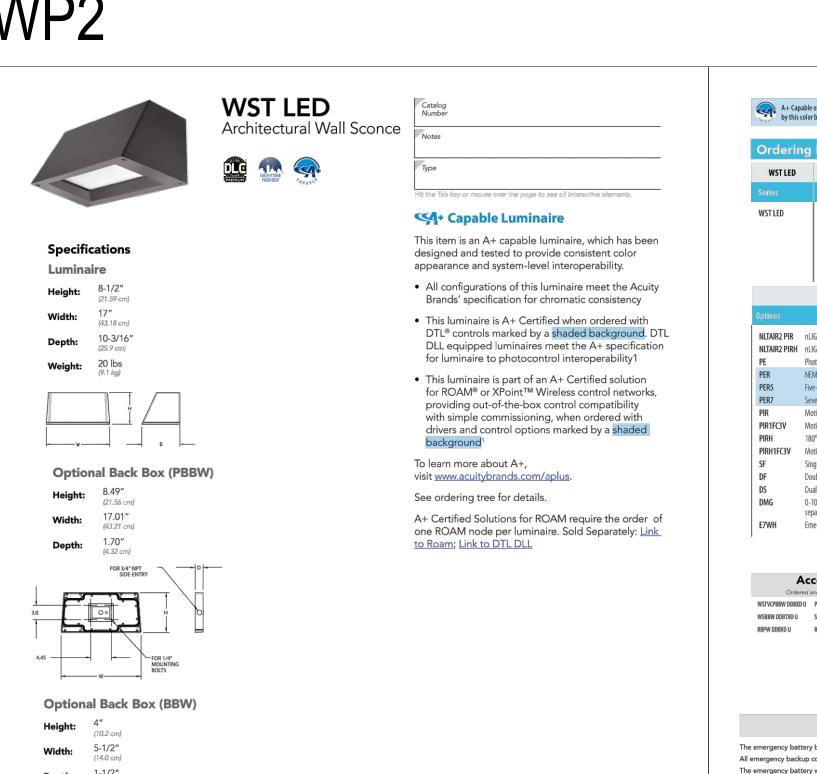
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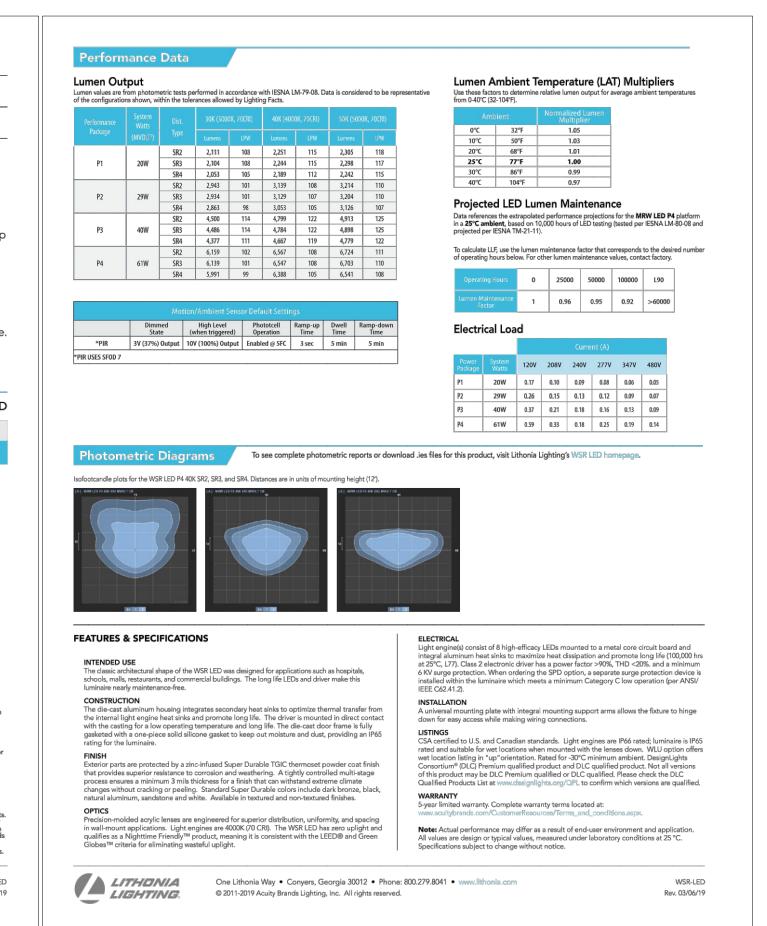




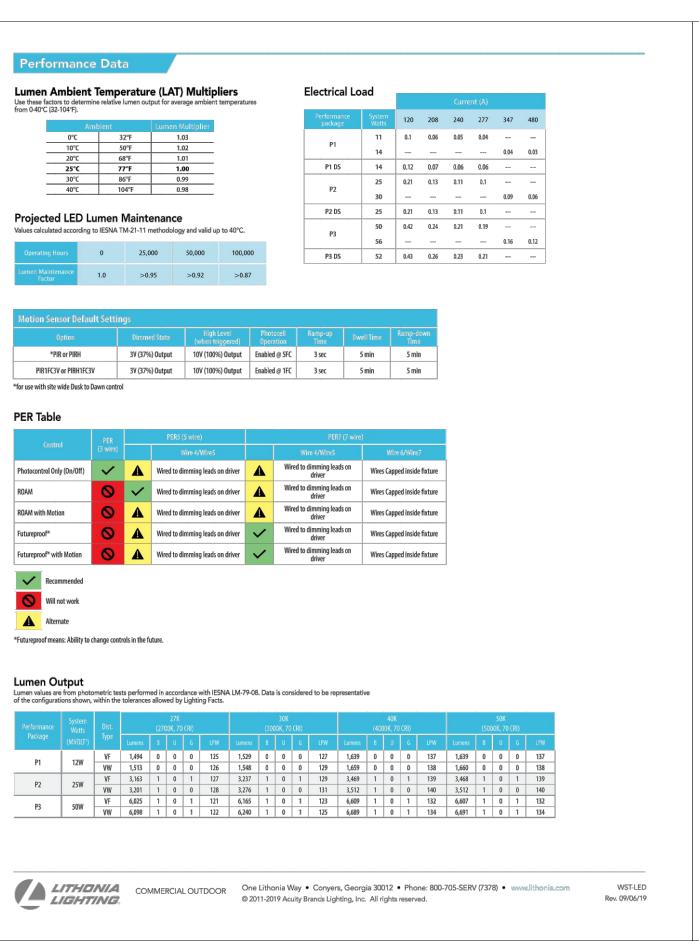

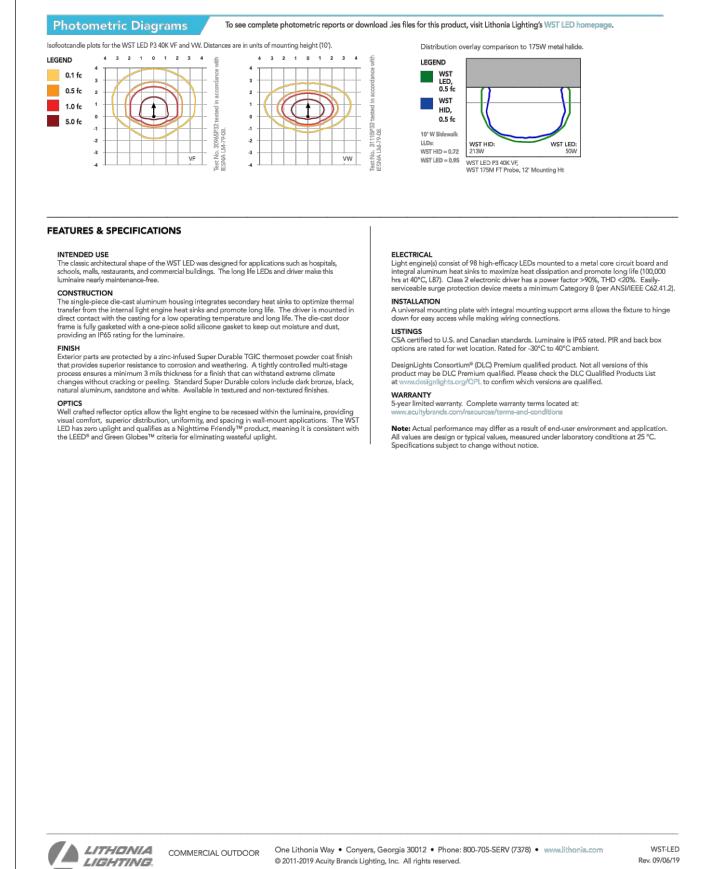Rev. 09/06/19



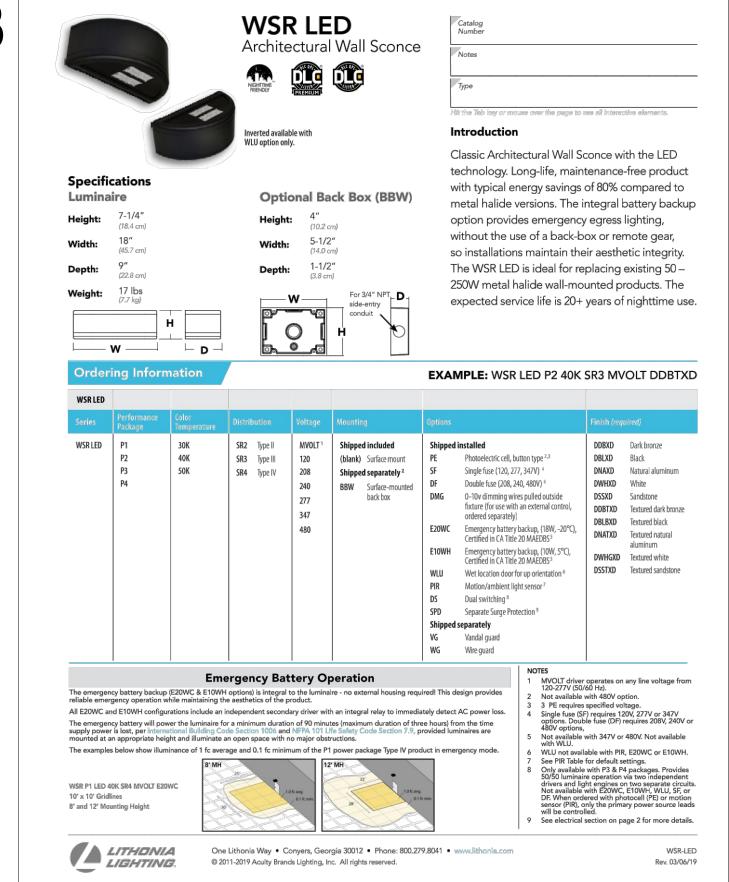



17855 North Dallas Parkway • Suite 320 Dallas, TX, 75287 p. 469.385.1616 • f. 469.385.1615 Texas Registered Engineering Firm F-4990 Project Number:1930681 Drawn By:DNH Checked By:JW

SHEET SIZE: 24" x 36"

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OCTOBER 2019 Scale: AS SHOWN Sheet Title WP1,WP2,WP3 **CUTSHEETS** 

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Sheet Number Case Number:

LITHONIA LIGHTING

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One Lithonia Way • Conyers, Georgia 30012 • Phone: 800.705.7378 • www.lithonia.com


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Jordan & Skala Engineers

lighting distribution, uniformity, and pole spacing. Light engines are available in 3000 K, 4000 K or 5000 K (70 CRI) configurations. The D-Series Size 0 has zero

Light engine(s) configurations consist of high-efficacy LEDs mounted to metal-core circuit boards to maximize heat dissipation and promote long life (up to L85/100,000 hours at 25°C). Class 1 electronic drivers are designed to have a power factor >90%, THD <20%, and an expected life of 100,000 hours with <1%

failure rate. Easily serviceable 10kV surge protection device meets a minimum

controls can be utilized via optional NEMA twist-lock photocell receptacles. Integrated motion sensors with on-board photocells feature field-adjustable programing and are suitable for mounting heights up to 30 feet.

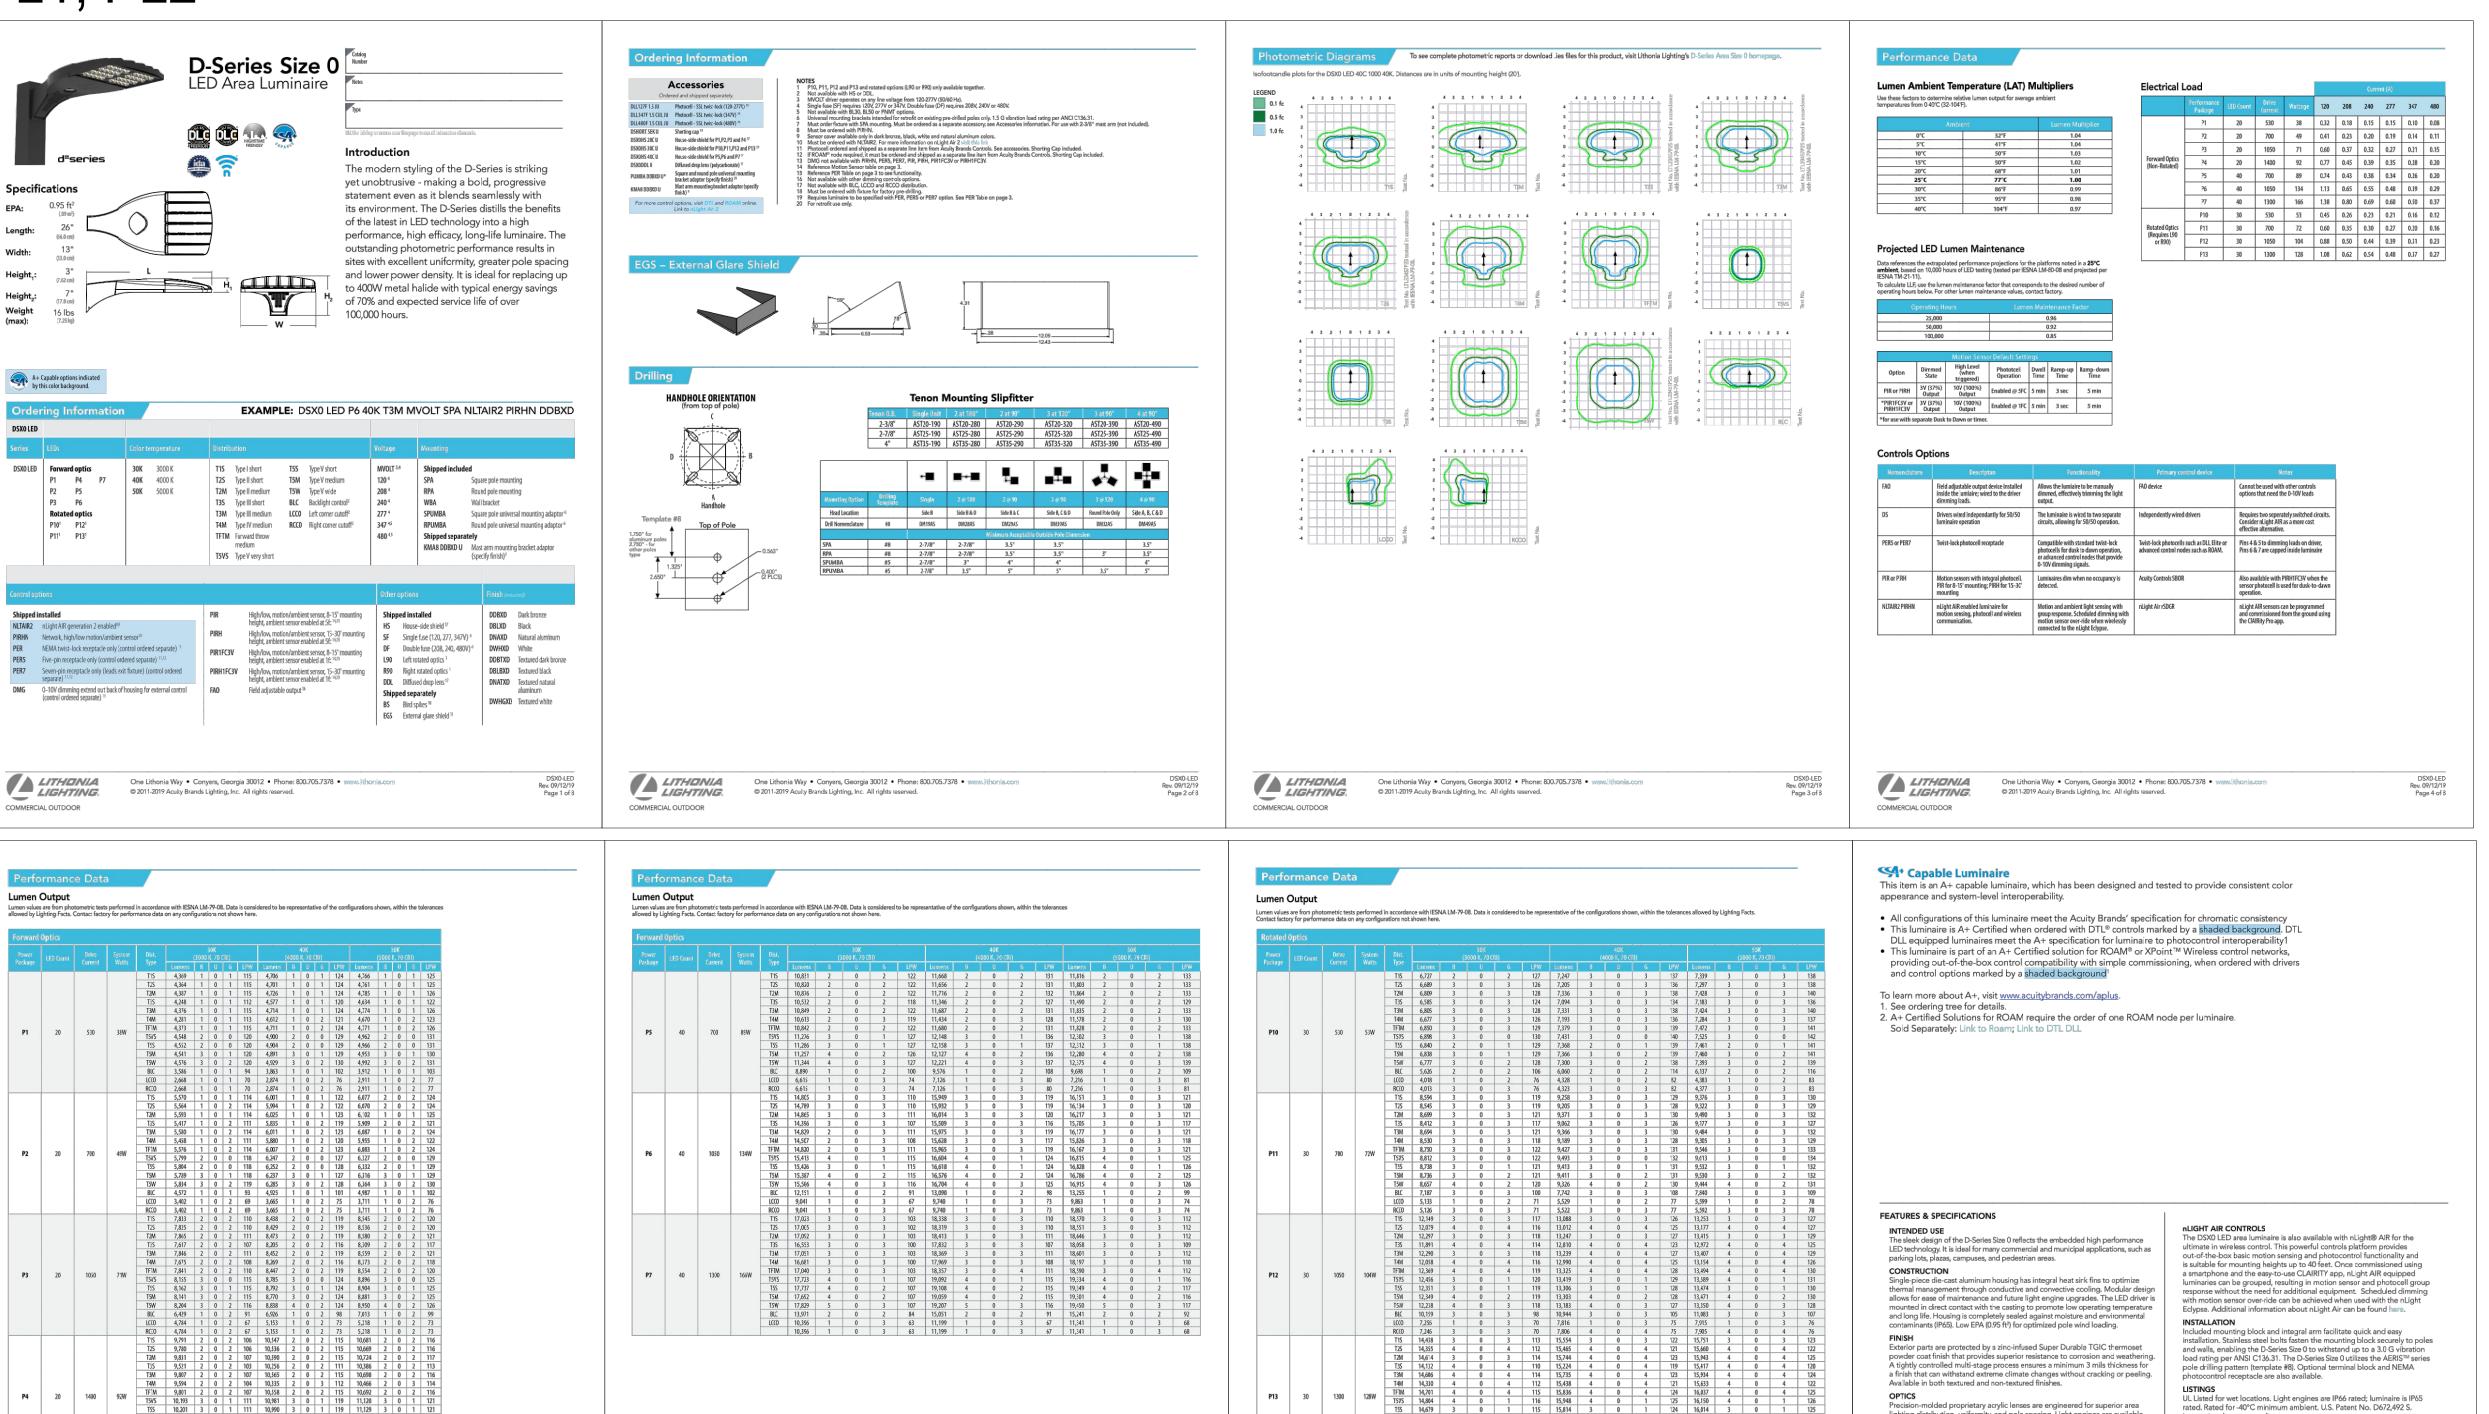The DSX0 LED area luminaire has a number of control options. Dusk to dawn

Category C Low operation (per ANSI/IEEE C62.41.2).

uplight and qualifies as a Nighttime Friendly™ product, meaning it is consiste with the LEED® and Green Globes™ criteria for eliminating wasteful uplight.

ELECTRICAL

STANDARD CONTROLS

LITHONIA LIGHTING

COMMERCIAL OUTDOOR

esignLights Consortium® (DLC) Premium qualified product and DLC

qualified product. Not all versions of this product may be DLC Premium qualified or DLC qualified. Please check the DLC Qualified Products List at www.designlights.org/QPL to confirm which versions are qualified.

International Dark-Sky Association (IDA) Fixture Seal of Approval (FSA) is

Note: Actual performance may differ as a result of end-user environment

DSX0-LED Rev. 09/12/19 Page 8 of 3

and application.
All values are design or typical values, measured under laboratory conditions at 25 °C.

Specifications subject to change without notice.

5-year limited warranty. Complete warranty terms located at:

WARRANTY

One Lithonia Way • Conyers, Georgia 30012 • Phone: 800.705.7378 • www.lithonia.com

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available for all products on this page utilizing 3000K color temperature only.

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SHEET SIZE: 24" x 36"

**Sheet Number** 

Sheet Title PL 1, PL2

**PRELIMINARY** 

FOR INTERIM REVIEW ONLY

THESE DOCUMENTS ARE FOR INTERIM

REVIEW AND ARE NOT INTENDED FOR

BIDDING OR CONSTRUCTION PURPOSES.

JOSHUA WILEY 129688

19068

OCTOBER 2019

AS SHOWN

REGULATORY APPROVAL, PERMIT,

enter

Industrial RBAN INDUSTRIAL

Urban

conver:


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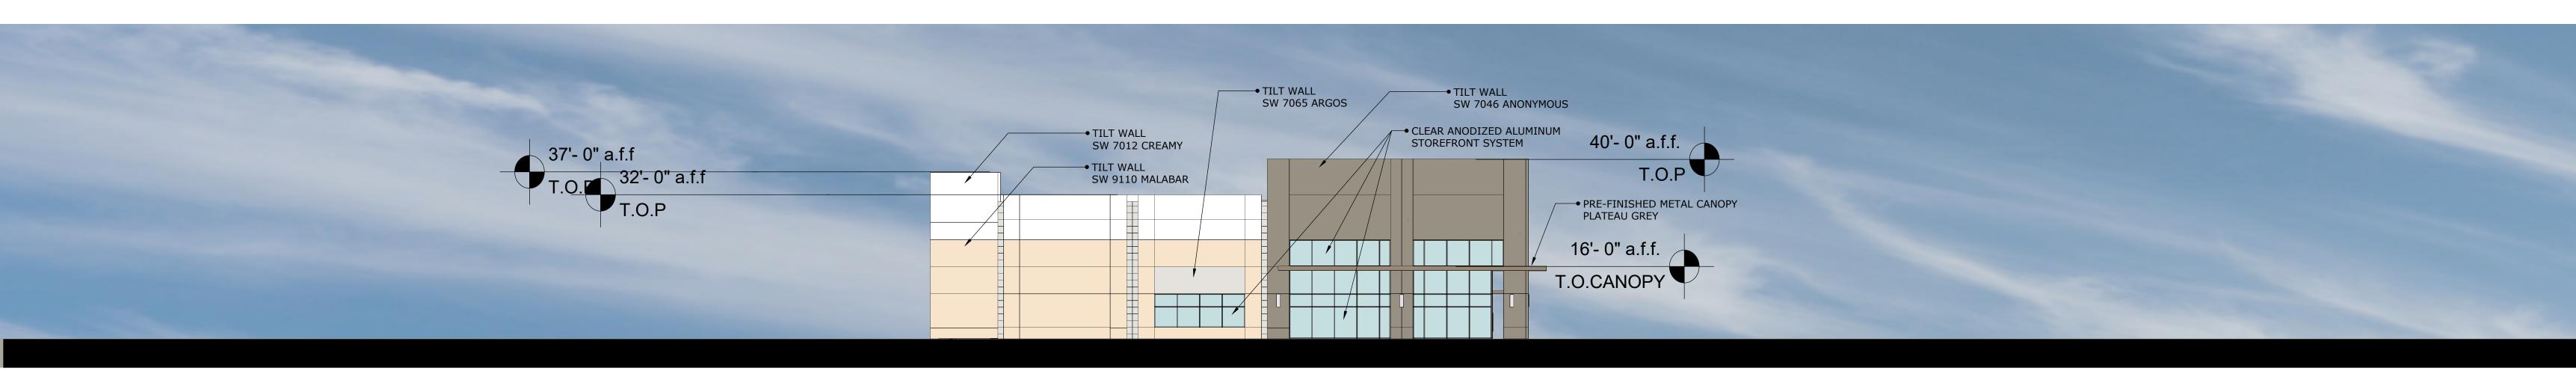
Project No.:

Checked By: Scale:


Issued: Drawn By:



EAST

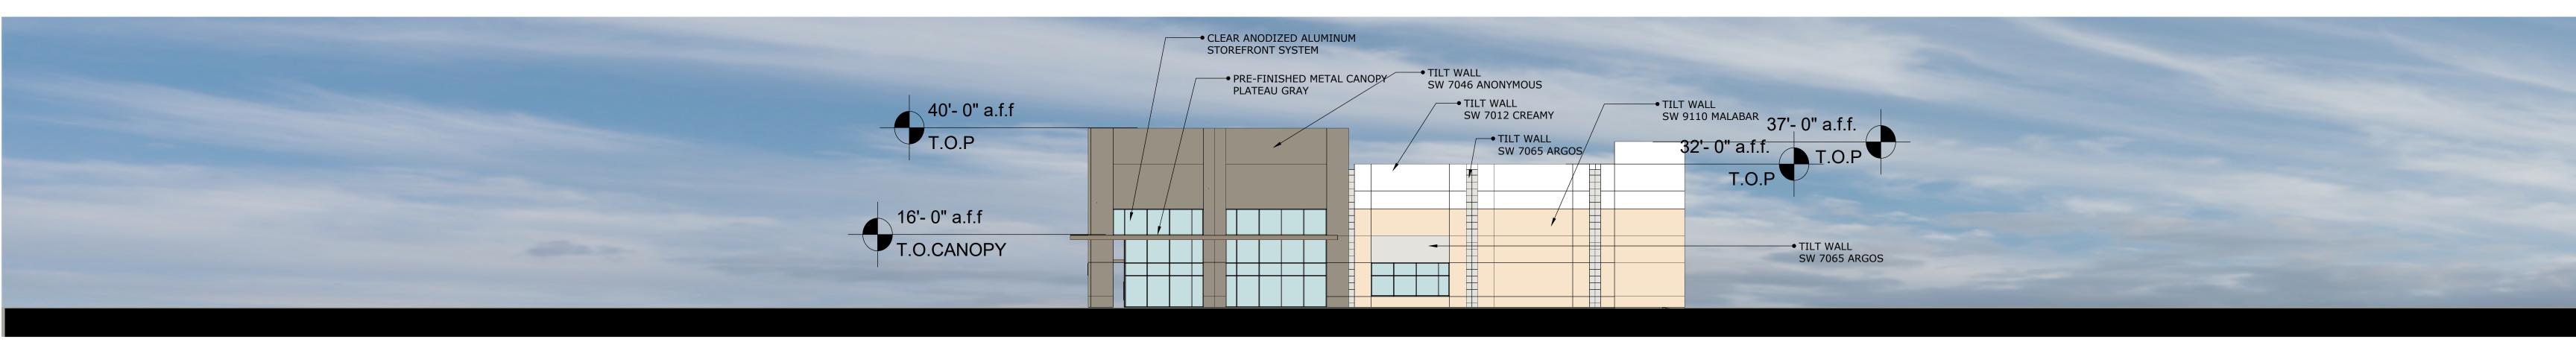

WEST

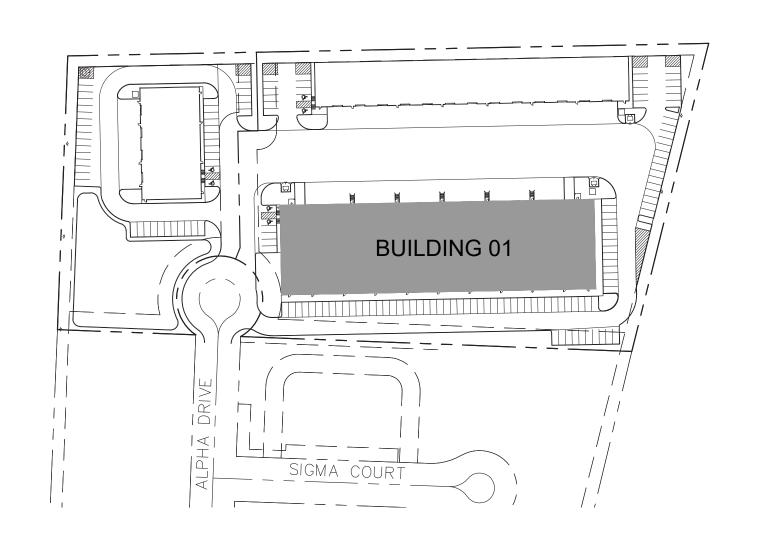

FAÇADE			
BLDG 1			
	METAL CANOPY	PRIMARY MASONRY: PAINTED CONCRETE TILT WALL	FAÇADE TOTAL SF (EXCLUSIVE OF DOORS & WINDOWS)
NORTH	0	14,140	14,140
SOUTH	235	11,220	11,455
EAST	59	3,734	3,793
WEST	59	3,734	3,793
			TOTAL
SF of Materials	353	32,828	33,181
Percentage of Material	1%	99%	100%







PRE-FINISHED METAL CANOPY PLATEAU GREY → TILT WALL SW 7046 ANONYMOUS CLEAR ANODIZED ALUMINUM STOREFRONT SYSTEM → PRE-FINISHED METAL CANOPY PLATEAU GREY PRE-FINISHED METAL CANOPY
PLATEAU GREY → PRE-FINISHED METAL CANOPY TILT WALL
SW 7065 ARGOS TILT WALL SW 7065 ARGOS PLATEAU GREY 40'- 0" a.f.f. → TILT WALL SW 9110 MALABAR → TILT WALL SW 7012 CREAMY T.O.P 16'- 0" a.f.f T.O.P 10'- 8" a.f.f. T.O.CANOPY

SOUTH

# TYPICAL DUMPSTER ENCLOSURE ELEVATIONS

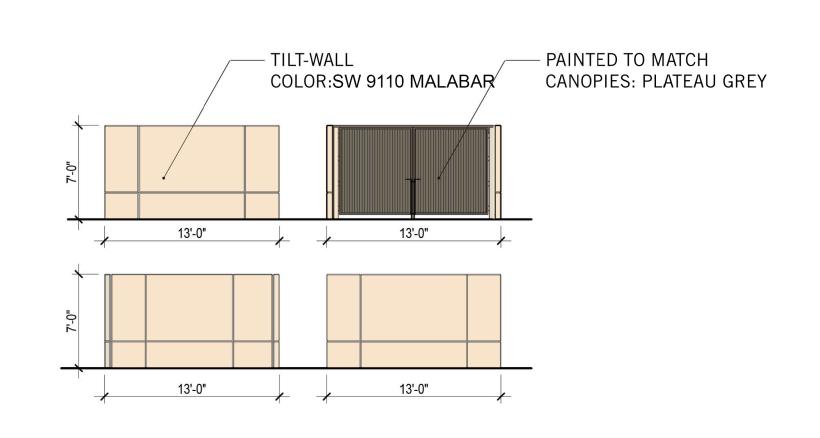

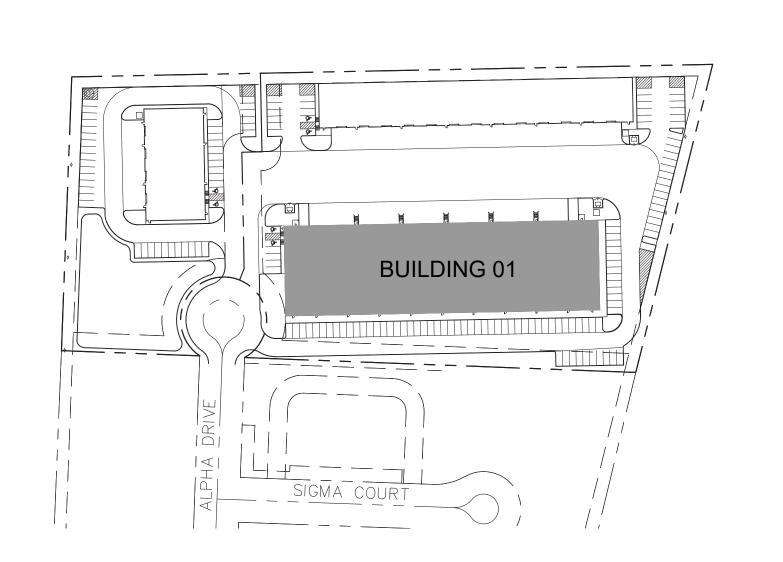

FAÇADE			
BLDG 1			
	METAL CANOPY	PRIMARY MASONRY: PAINTED CONCRETE TILT WALL	FAÇADE TOTAL SF (EXCLUSIVE OF DOORS & WINDOWS)
NORTH	0	14,140	14,140
SOUTH	235	11,220	11,455
EAST	59	3,734	3,793
WEST	59	3,734	3,793
			TOTAL
SF of Materials	353	32,828	33,181
Percentage of Material	1%	<b>99</b> %	100%

BUILDING ELEVATIONS


**ÓBRIEN** 




SOUTH




NORTH

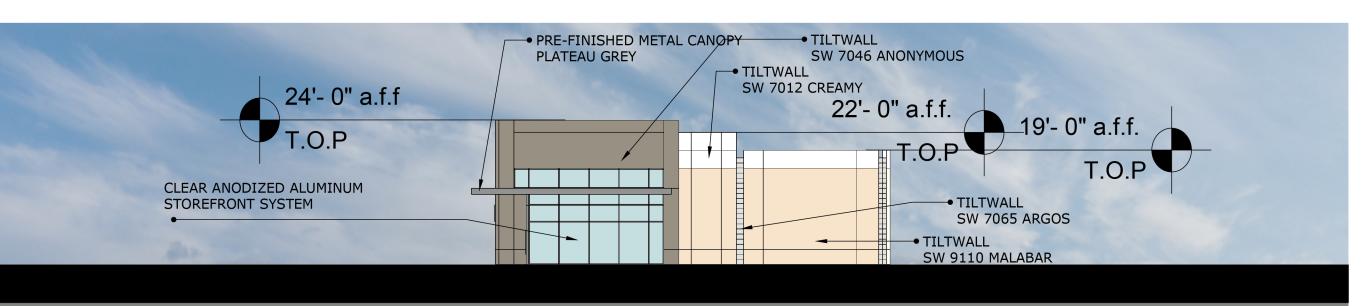

EAST

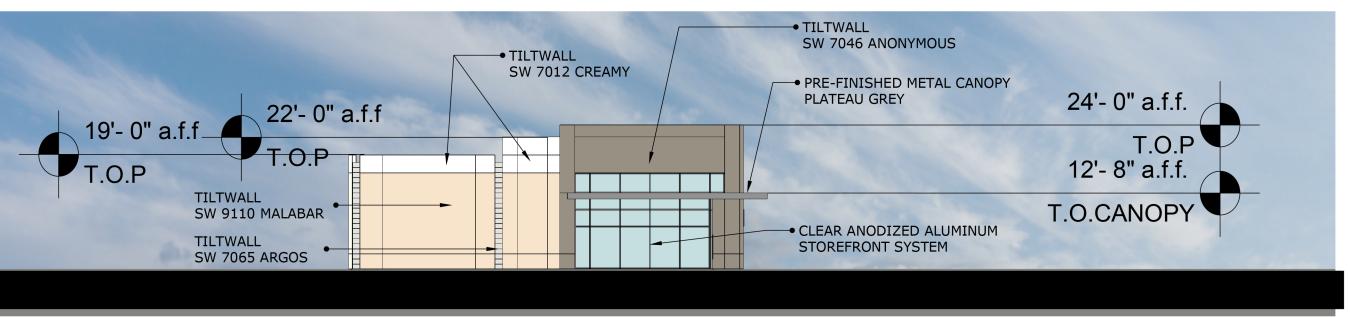


WEST

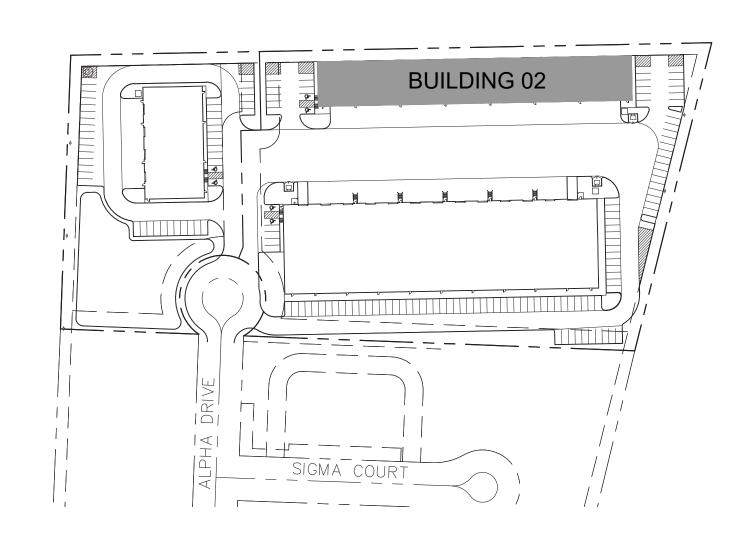


FAÇADE BLDG 2			
	METAL CANOPY	PRIMARY MASONRY: PAINTED CONCRETE TILT WALL	FAÇADE TOTAL SF (EXCLUSIVE OF DOORS & WINDOWS)
NORTH	0	9,178	9,178
SOUTH	66	5,714	5,780
EAST	33	1,086	1,119
WEST	33	1,086	1,119
			TOTAL
SF of Materials	132	17,065	17,196
Percentage of Material	1%	<b>99</b> %	100%

ÓBRIEN


BUILDING ELEVATIONS

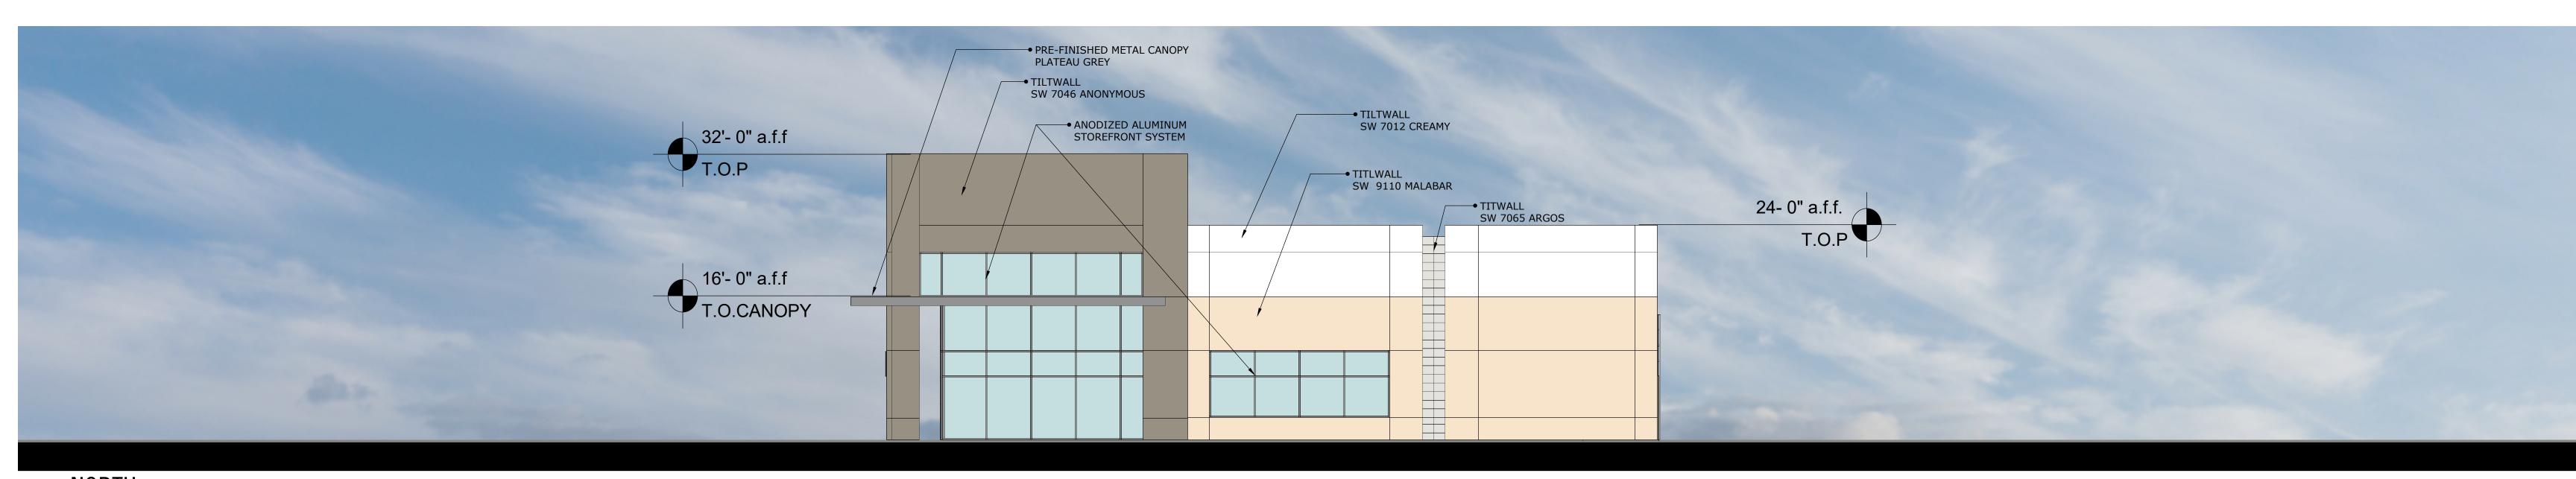


NORTH

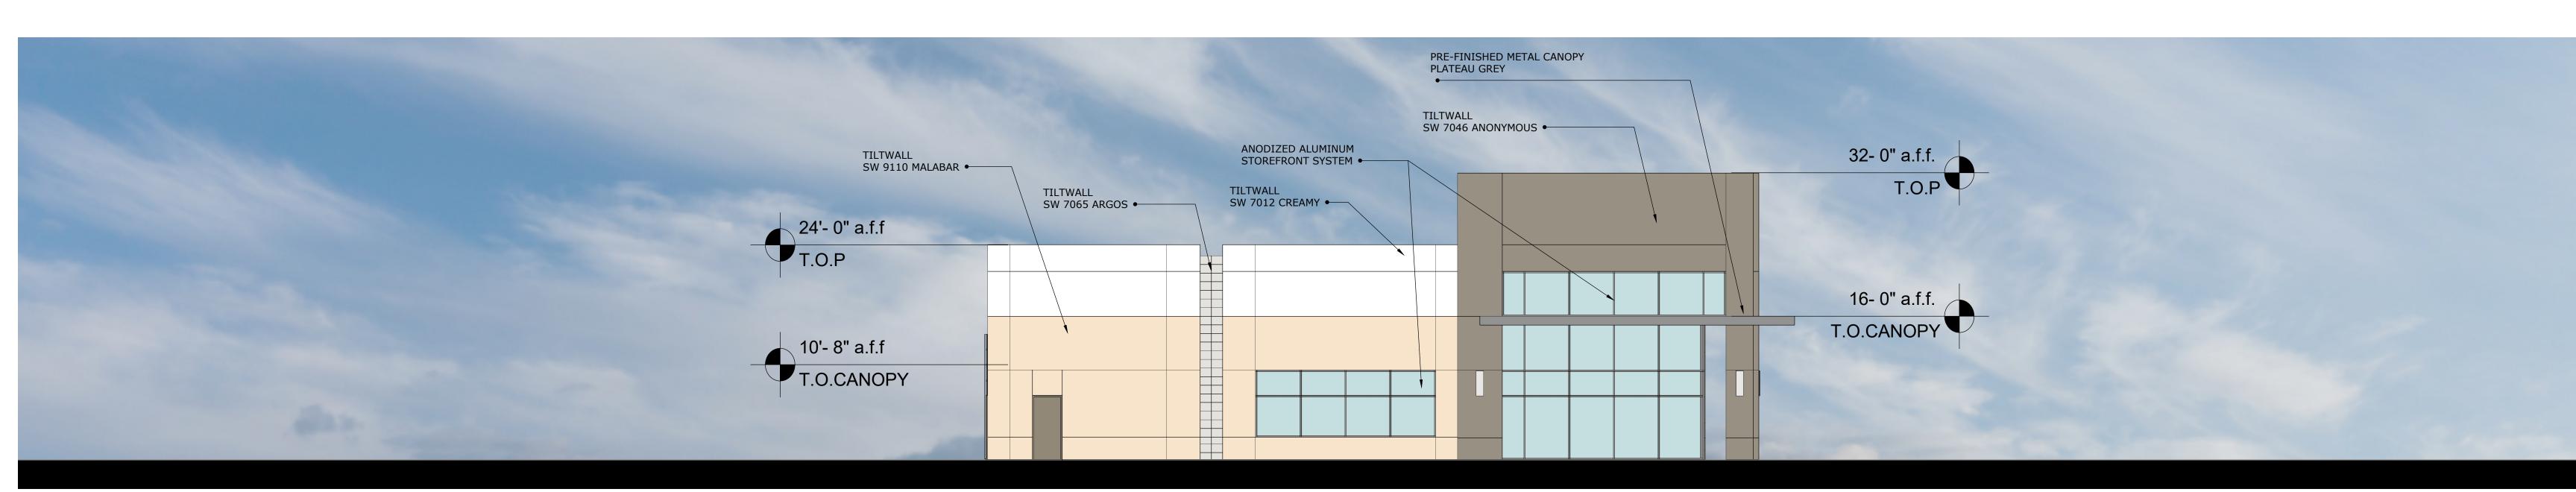


SOUTH

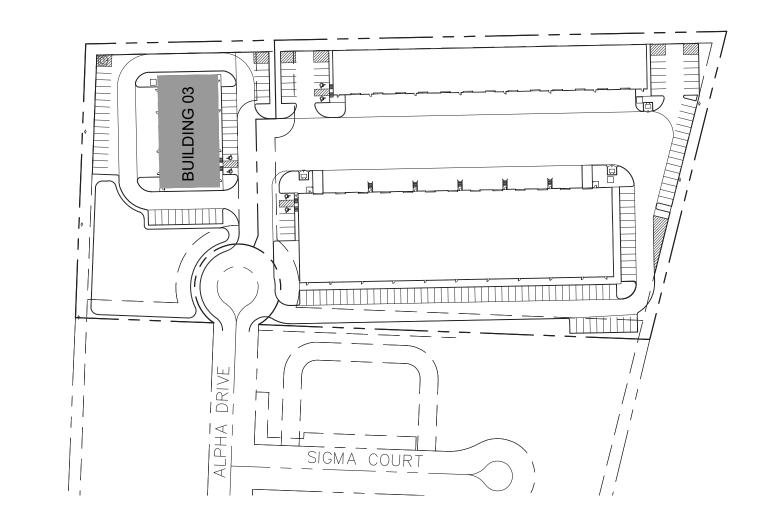


FAÇADE BLDG 3			
	METAL CANOPY	PRIMARY MASONRY: PAINTED CONCRETE TILT WALL	FAÇADE TOTAL SF (EXCLUSIVE OF DOORS & WINDOWS)
NODTH	25	1./24	1.//0
NORTH	35	1,634	1,669
SOUTH	35	1,634	1,669
EAST	74	2,824	2,898
WEST	0	3,096	3,096
			TOTAL
SF of Materials	144	9,188	9,332
Percentage of Material	2%	98%	100%

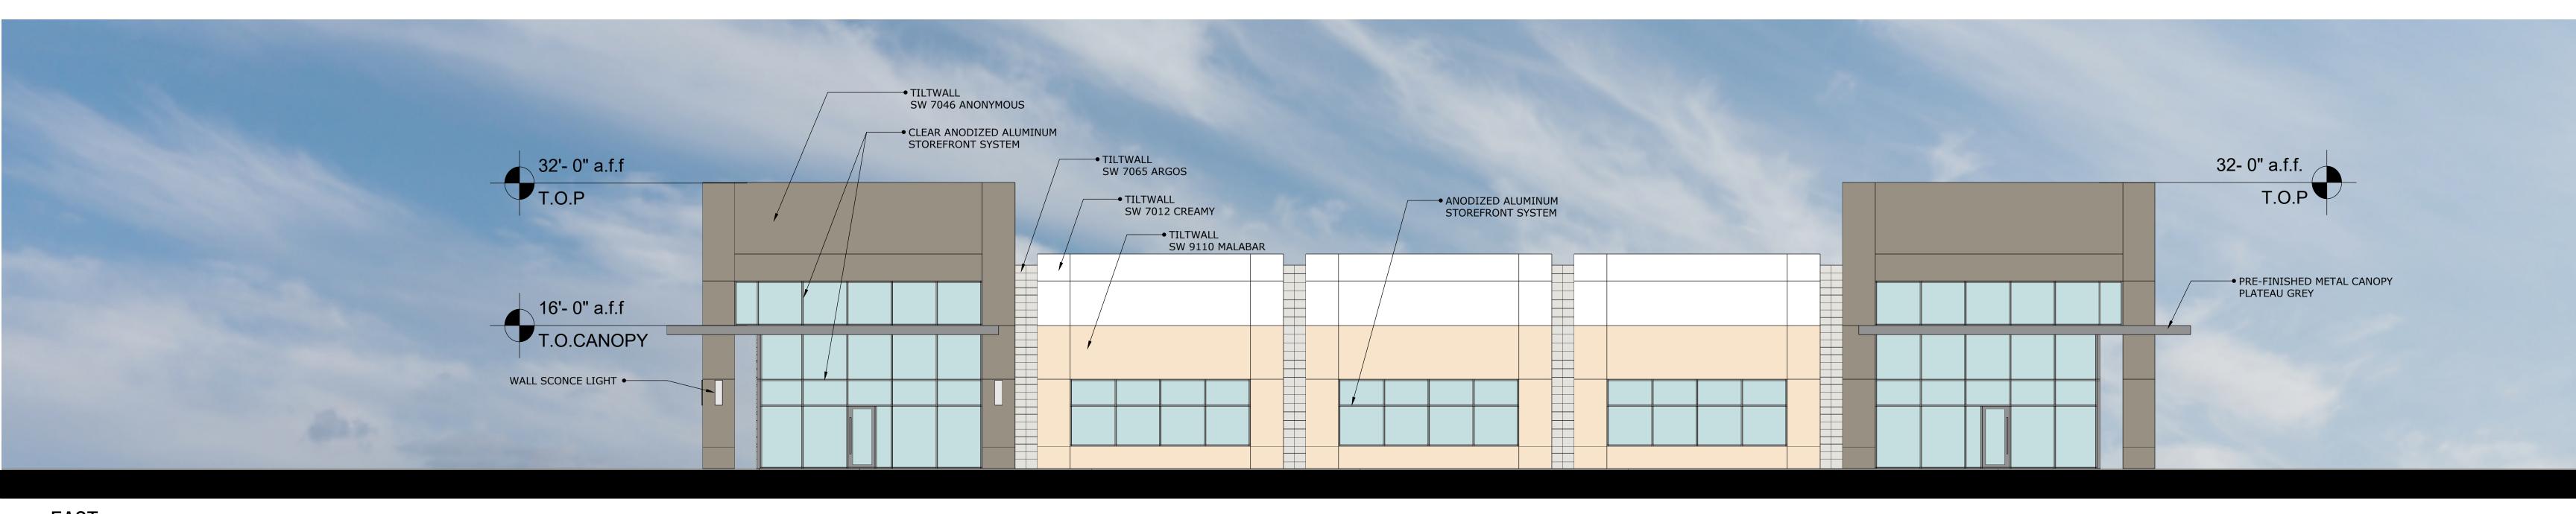

EAST

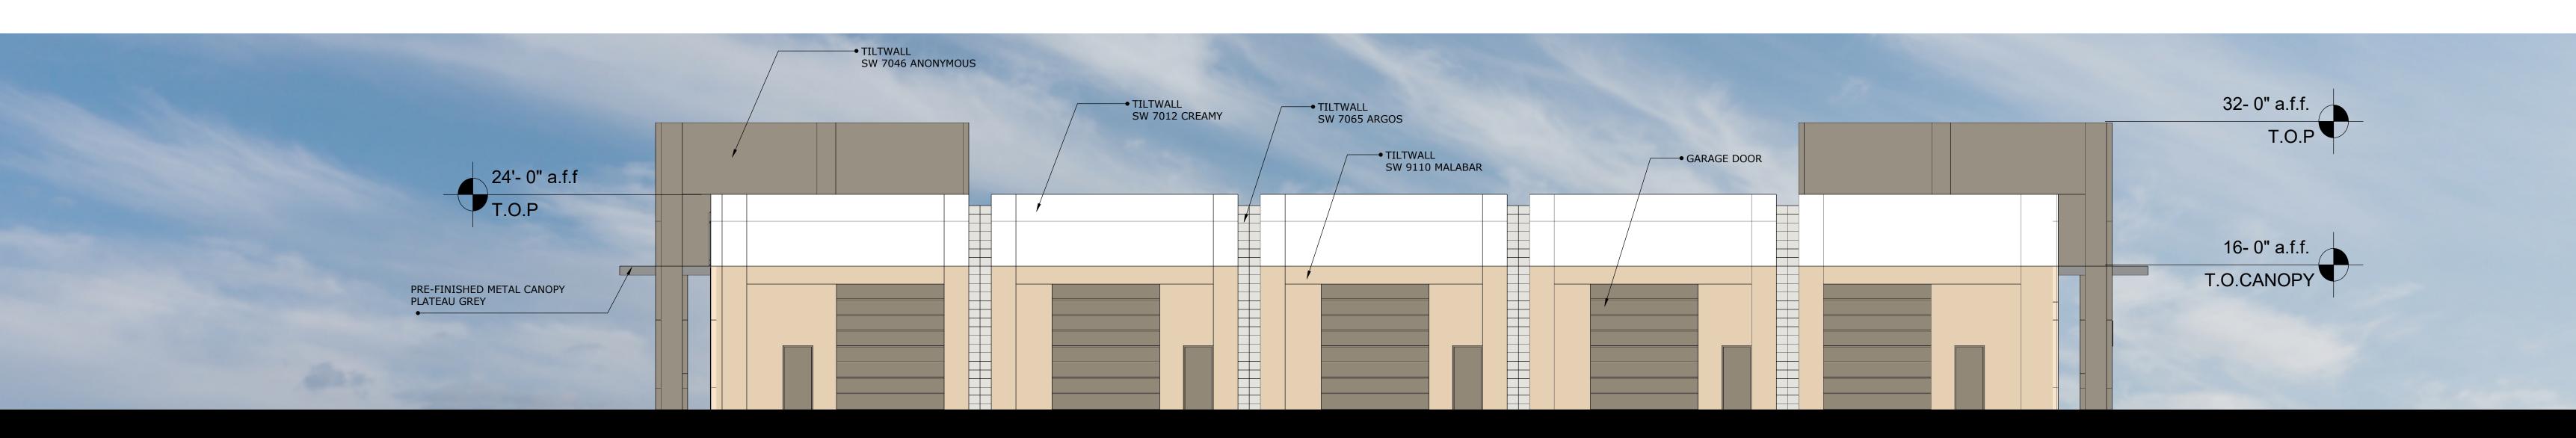

WEST

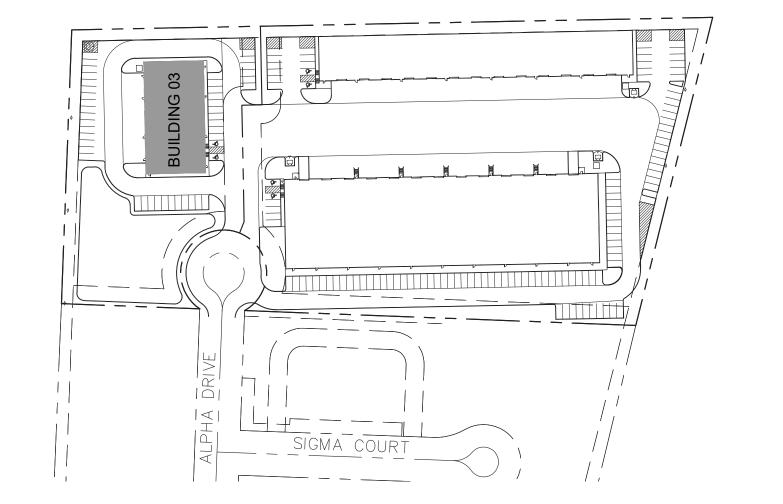

FAÇADE BLDG 3			
BLDG 3	METAL CANOPY	PRIMARY MASONRY: PAINTED CONCRETE TILT WALL	FAÇADE TOTAL SF (EXCLUSIVE OF DOORS & WINDOWS)
			,
NORTH	35	1,634	1,669
SOUTH	35	1,634	1,669
EAST	74	2,824	2,898
WEST	0	3,096	3,096
			TOTAL
SF of Materials	144	9,188	9,332
Percentage of Material	<b>2</b> %	98%	100%

URBAN INDUSTRIAL CENTER - BLDG 3

### **City of Rockwall**



10/21/2019 LM

### **Project Plan Review History**

**Project Number Project Name** 

SP2019-040

Ellis Centre Phase 2 Addition

Type

SITE PLAN

Subtype

Staff Review Status

**Site Address** 

City, State Zip

ALPHA DR

ROCKWALL, TX 75087

Subdivision

Tract

Block

Lot No

HALFF ASSOCIATES

ROCKWALL URBAN INDUSTRIAL, LP

Parcel No

**General Plan** 

**Applied** 

Closed

Expired

Status

Zoning

Approved

**ELLIS CENTRE 2** 3586-000D-0001-00-0R 1 D 1

Owner

**Applicant** 

Type of Review / Notes	Contact	Sent	Due	Received	Elap	sed Status	Remarks
BUILDING	Russell McDowell	10/21/2019	10/28/2019	9 10/22/2019		1 APPROVED	
ENGINEERING	Sarah Johnston	10/21/2019	10/28/2019	9 10/24/2019		3 COMMENTS	

ype of Review / Notes	Contact	Sent	Due	Received	Elapse	d Status	Remarks
(10/24/2019 4:26	PM SJ)						
M - Add note, "No	trees within 5' of utilit	ies" to the lar	ndscape plan	<b>.</b>			
M - Parking near t	he building to be 20'x9	'. All other pa	rking to be 1	.8'x9'. Standards o	of Design 2.	19	
M - All fire lane ra	dii to be 20' min. If the	building is 36	or taller, th	e fire lane radius	must be 30	o' min. Standards of	Design 2.19
M - Driveway radi	i to be 30' min. Standar	ds of Design 2	2.19				
M - No structures	in easements. This incl	udes retainin	g walls and f	ootings, dumpster	r and scree	ning wall must be o	out of easements. Standards of Design 6.4.1
M - All fire hydran	its must have a20'x20'	easement est	ablished. Fire	e hydrants to have	e5' of clear	rance around all side	es. Standards of Design 5.3.1
M - Must show ex	isting utilities and your	planned serv	vice connecti	ons.			
M - Minimum ease	ement width is 20' for <sub>ا</sub>	proposed ease	ements. Stan	dards of Design 5	.3.1 and 6.	4	
M - Retaining wall	ls in detention require	a variance Sta	andards of D	esign3.3.3.2			
M – Must stub ou	t the 8" water and 8" se	ewer to the no	orthern prop	erty for future ex	pansion		
M - Must meet all	standards of design ar	nd construction	on				
I - 4% Engineering	Fees						
I - Impact Fees							
I - Must have dete	ention on-site Manning'	s C-valve is pe	er zoning				
I - Water and sew	er lines must have 10' o	of easement o	n both sides				
I - No utilities in de	etention easements						
I - No grate utilitie	es allowed						
I - Cul-de-sac pavir	ng to be 8" 3600 psi (6.5	5 sack mix)					
I - No sand is allow	ved under paving.						
I - Walls 3' and ove	er must be engineered						
I - All retaining wa	Ills to be rock or stone	face. No smod	th concrete	walls			
I - If storm is picki	ng up offsite drainage t	the pipe main	tained must	be			
I - Where you sho	w the 15'x64' turnarou	nd, you must	stripe the en	ntire area as no pa	ırking.		
RE	Ariana Hargrove	10/21/20	019 10/28/2	019 10/24/2019	3	COMMENTS	see notes
(10/24/2019 3:16	PM AA)						
FDC shall be:							
-facing and visible	from the fire lane						
- within 100-feet o	of a fire hydrant						
- clear and unobst	ructed with a minimun	n of a 5-feet c	lear all-weat	her path from fire	lane acce	SS	
- installed 18-48 in	iches above grade.						
(Ord 16-31)							
S	Lance Singleton	10/21/20	019 10/28/2	019 10/22/2019	1	APPROVED	See comments
(10/22/2019 3:01	PM LS)						
Addressing will be	·						
_	ha Dr, Rockwall,TX 750	187					
•	ha Dr, Rockwall,TX 750						
•	ha Dr, Rockwall,TX 750						
ANNING	David Gonzales		719 10/28/2	019 10/24/2019	3	COMMENTS	See comments
7.114114O	Davia Golizales	10/21/20	JIJ 10/20/2	013 10,24,2013	3	CONTINIENTS	See comments

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(10/24/2019 8:50 PM DG)

SP2019-040; Site Plan for Rockwall Urban & Industrial Center (Ellis Centre, Phase 2)

Please address the following comments (M= Mandatory Comments; I = Informational Comments)

- I.1 This is a request for the approval of a site plan for a multi-tenant industrial building on a 7.02-acre parcel of land identified as Lot 1, Block D, Ellis Center Phase 2 Addition, City of Rockwall, Rockwall County, Texas, zoned Light Industrial (LI) District, situated at the terminus of Alpha Drive.
- 1.2 For guestions or comments concerning this case please contact David Gonzales in the Planning Department at (972) 772-6488 or email dgonzales@rockwall.com.
- M.3 For reference, include the case number (SP2019-040) in the lower right-hand corner of all pages on future submittals.
- 1.4 This project is subject to all requirements stipulated by the Unified Development Code(UDC); including the District Development Standards, of Article V, that are applicable to the subject property.
- 1.5 Please note that the property will require a replat prior to the issuance of a building permit.

M.6 Site Plan. Please make the following clarifications on the site plan to ensure staff can properly review this project and convey all of the required elements to the City's boards and commissions:

- 1) Please provide a label for the parking count for each row of spaces in order to determine total parking count
- 2) The cross sections of concrete pavement thickness is to be determined by the engineering department during the civil submittal process and is not considered to be approved during this site plan process.
- 3) Parking for an office use requires a minimum of one (1) parking space per 300-SF (i.e. 1:300 SF) of gross floor area. Will there be offices uses within this complex? If so, please update parking legend. (Article VI, Table 3).
- 4) Provide a standard signature block with signature space for the Planning and Zoning Chairman and Planning Director.
- 5) Is there a front building set back? If so, this is required to be 25-ft. Please adjust accordingly.
- 6) Provide a label for all drive aisle widths.
- 7) Indicate and label all sidewalk widths proposed for this site.
- 8) Delineate and label all loading dock parking spaces. Minimum 12-ft wide & 65-ft in length. (Art. VI, Section 6.04)
- 9) Ground mounted utility equipment and RTU's shall be screened from adjacent public rights-of-way and adjacent property. Provide screening detail for these units. (Art. V, Sec. 1.05.3)
- 10) Provide screening along the western property boundary from the school district property. (Art. VIII, Sec. 5.02.B Landscape Screening)
- 11) Will there be any outside storage of materials, products, etc.?

M.8 Building Elevations. According to Subsection 5.01.A1, of the General Industrial District Standards, of Article V, District Development Standards, of the UDC, requires a minimum of 20% stone (i.e. natural or synthetic/cultured) on all building façades. In this case, the construction of the addition does not include stone on any façade. This will require an exception from the Planning and Zoning Commission pending a recommendation from the Architectural Review Board(ARB).

M.9 Building Elevations. According to Subsection 5.01A.1, General Industrial District Standards, of Article V, District Development Standards, of the UDC, each exterior wall of a building's façade shall consist of a minimum of 90% primary materials and ten (10) percent secondary materials. In this case, the construction consists of concrete tilt-up wall. The use of concrete tilt-up walls may be permitted on a case-by-case basis in accordance with the exception requirements outlined in this section of the UDC. This will require an exception from the Planning and Zoning Commission pending a recommendation from the Architectural Review Board(ARB).

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- M.10 Building Elevations. Please review the articulation formulas contained in Section 5.01.C of Article V, District Development Standards, of the UDC. The submitted building elevations do not appear to meet all the formulas required for building articulation. This will require an exception from the Planning and Zoning Commission pending a recommendation from the Architectural Review Board (ARB).
- M.11 Building Elevations. Please make the following clarifications and changes to the building elevations to ensure staff can properly review this project and convey all of the required elements to the City's boards and commissions:
- 1) Indicate all HVAC units (i.e. dash-in RTU's) on the building elevations so that staff can ensure that they meet the screening requirements dictated by the UDC (Subsection. 1.05.C.3; Art. V; UDC).
- 2) Provide calculation of building materials as a percentage
- M.12 Landscape Plan. Please make the following clarifications and changes to the landscape plan to ensure staff can properly review this project and convey all of the required elements to the City's boards and commissions:
- 1) Provide screening along the western property boundary from the school district property. Art. VIII, Sec. 5.02.B Landscape Screening, states (a)ny non-residential...land use or parking area that has a ide or rear contiguous to any residentially zoned or used property shall be screened with a masonry fence a minimum of six (6) feet in height with canopy trees planted on 20-foot centers (as depicted in Figures 6 & 7 below). As an alternative, the Planning and Zoning Commission may approve an alternative screening method that incorporates a wrought iron fence and three(3) tiered screening along the entire length of the adjacency. The canopy trees shall be placed on 20-foot centers. As a note, the Agricultural (AG) District is considered residential
- 2) Correct table to indicate a minimum 15% landscaping required (currently indicates 10%).
- 3) All new tree plantings are to be a minimum of 4-inch caliper trees. Correct plan. (Art. VIII, Sec. 4.A.2)
- 4) Parking lotsgreater than 20,000 SF are required to provide a minimum of one (1) tree for each 10 parking spaces. 161 parking spaces = 16 trees within the parking lot area. (Art. VIII, Sec. 5.03.E.2)
- M.13 Treescape Plan According to Section 3.4, Treescape Plan Review Process, of Article IX, of the UDC, the director of planning and zoning, or his/her designee, shall review the treescape plan and approve the plan per the requirements of this article, or forward any recommendations to the planning and zoning commission. As part of the treescape plan review process, the city has the right to request changes or adjustments in the layout and design of a development to save trees. The planning and zoning commission will review and approve or disapprove the treescape plan. The decision of the planning and zoning commission may be appealed to the city council. The treescape plan requires approval by the Planning and Zoning Commission as submitted.
- M.14 Photometric Plan. According to Section 3.3, Minimum Requirements, of Article VII, Environmental Performance, of the UDC, the maximum allowable light intensity measured at the property line of any non-residentially zoned lot shall be 0.2 FC. In this case, the submitted photometric plan conforms to the requirements of the UDC.
  - 1) No light pole, base or combination thereof shall exceed an overall height of 30-ft. Provide pole detail. (Art. VII, Sec. 3.3.D)
- M.15 Based on the submittal staff has identified the following exceptions
- 1) Building Materials. The proposed addition is requesting the use of tilt-up wall construction and does not include a minimum of 20% stone.
- Building Articulation. The proposed addition does not meet the articulation standards established by the UDC.

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I.16 The Architectural Review Board (ARB) meeting will be held on October 29, 2019 and will begin at 5:00 p.m. in the City's Council Chambers. The ARB will forward a recommendation to the Planning and Zoning Commission.

I.17 Staff recommends that a representative be present for the meetings as scheduled above The Planning and Zoning meeting will be held in the City's Council Chambers and will begin at 6:00 p.m.

Police Department David Gonzales 10/25/2019 11/1/2019 10/25/2019 COMMENTS See comments

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(10/25/2019 12:12 PM DG)

The following CPTED comments are from Captain Ed Fowler of the Rockwall Police Department

### SP2019-040 Ellis Center Phase 2

### Considerations

- Provide clearance around the bottom of the fencing surrounding the dumpster for visual sight line of anyone inside fencing
- Consider mirror(s) on dumpster fencing to reveal any persons inside holding (fencing) area.
- Consider lighting spaced at intervals around the overhead doors(sides) and rear that fully illuminate the area.
- Evaluate transitional lighting for employees entering the parking lot from an area that has bright lighting to dim lighting and may pose a visual problem
- There does not appear to be shrubs or trees that will obstruct views around the business.
- Consider additional locking mechanisms for overhead doors in the form of a bar system and case hardened locking system
- Consider the addition of removable bollards for overhead doors to prevent vehicles from being used to breach the doors
- Consider auxiliary locking system on main entrance door(s) with limited key access, key pad or electronic badges for afterhours employees.
- Consider all exterior doors being equipped with alarm contact sensors and windows with glass break sensors
- Consider motion sensor alarms inside the business and motion activated lighting for the interior.
- Consider installation of locking mechanisms on all sliding windows up to the use of security rods.
- Roof access points should be locked from the inside.
- Consider installation of solid core doors for offices inside the business including the room that houses the safe Single cylinder locks for all offices and a double cylinder lock for the safe room
- Consider an additional alarm inside the safe room, either attached to the entrance door or safe.
- Consider the addition of security cameras on the exterior of the building that provide 360 degree coverage.
- Consider the addition of security cameras forthe interior the business.
- Interior considerations are not being added without speaking with the business owners/reps first.

The implementation of all or any portion of the considerations are NO guarantee or assurance that crime will not occur or that the property will be crimeproof. The considerations should, however, reduce the probability of crime if the strategies and recommendations are properly applied and consistently maintained. Any changes should still meet with the City of Rockwall's building code, code of ordinances and fire code.

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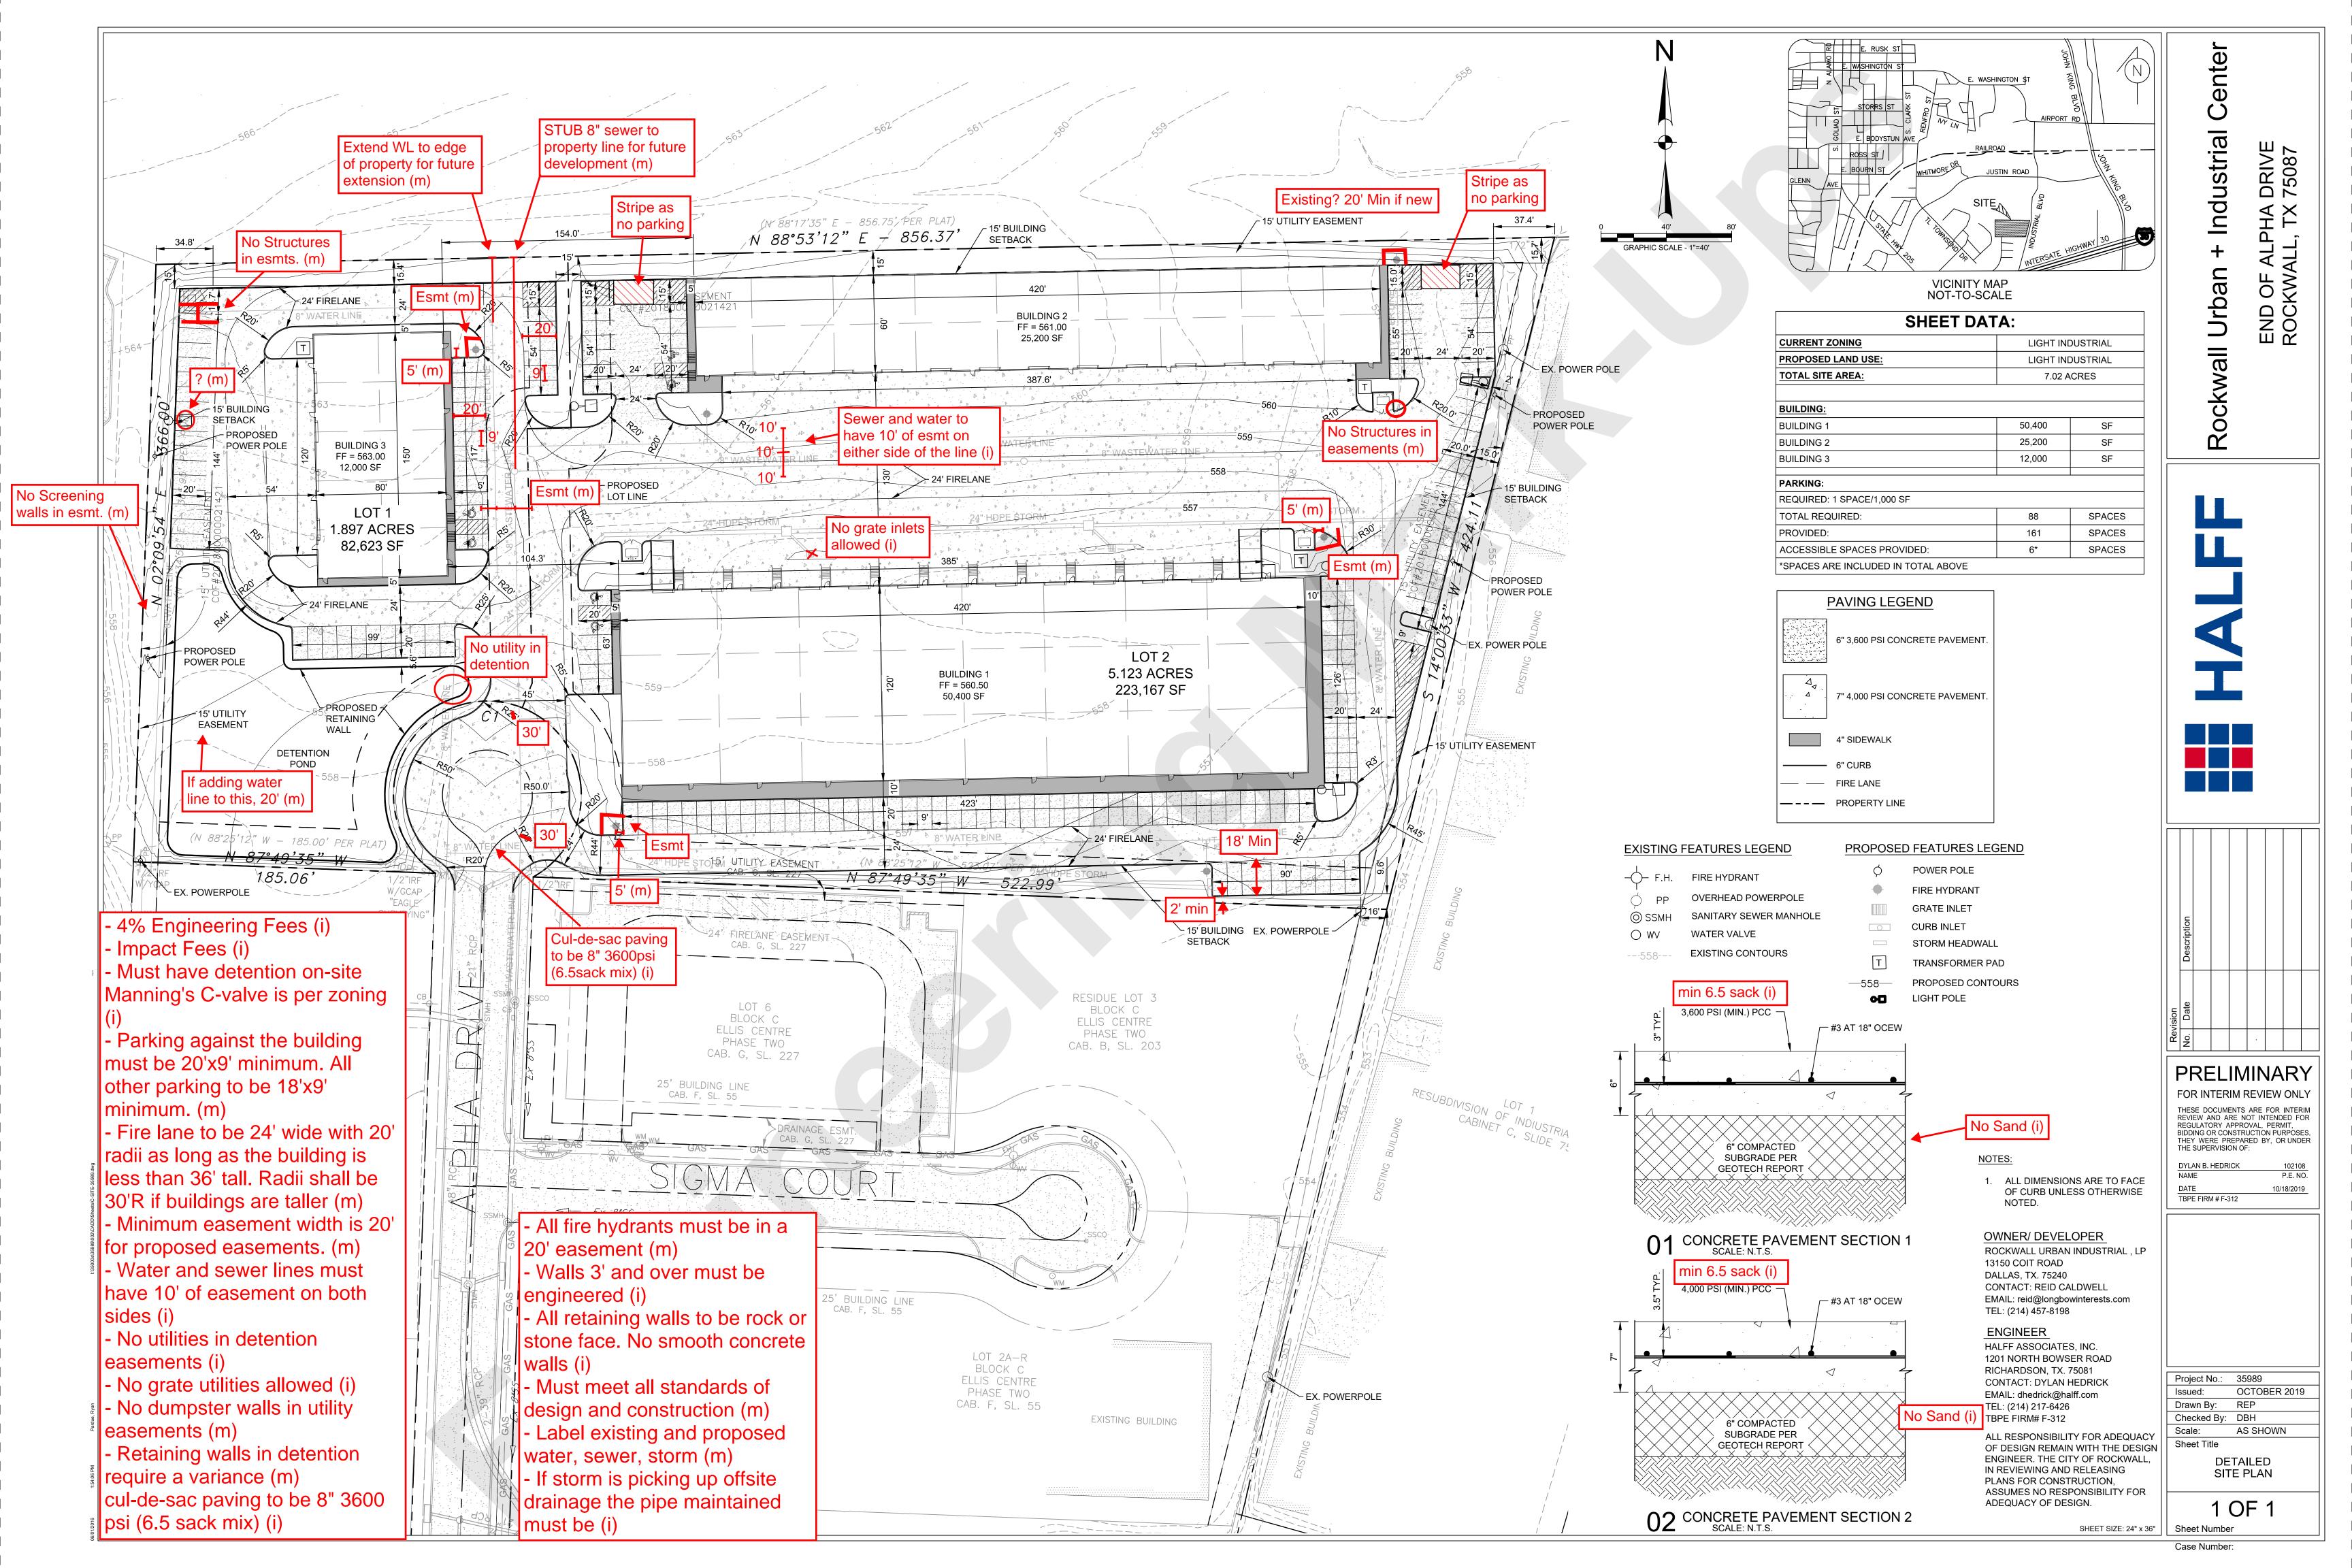
### STANDARD SITE PLAN WORDING


City of Rockwall Planning and Zoning Department 385 S. Goliad Street Rockwall, Texas 75087

GENERAL REFERENCE: SECTION 212.009 OF CHAPTER 212, MUNICIPAL REGULATION OF SUBDIVISIONS AND PROPERTY DEVELOPMENT, OF THE TEXAS LOCAL GOVERNMENT CODE

### SITE PLAN SIGNATURE BLOCK

APPROVED: I hereby certify that the above and foregoing site plan for a d Commission of the City of Rockwall on the [DAY] day of [MON	levelopment in the City of Rockwall, Texas, was approved by the Planning & Zoning ITH], [YEAR].
WITNESS OUR HANDS, this [DAY] day of [MONTH], [YEAR].	
Planning & Zoning Commission, Chairman	Director of Planning and Zoning



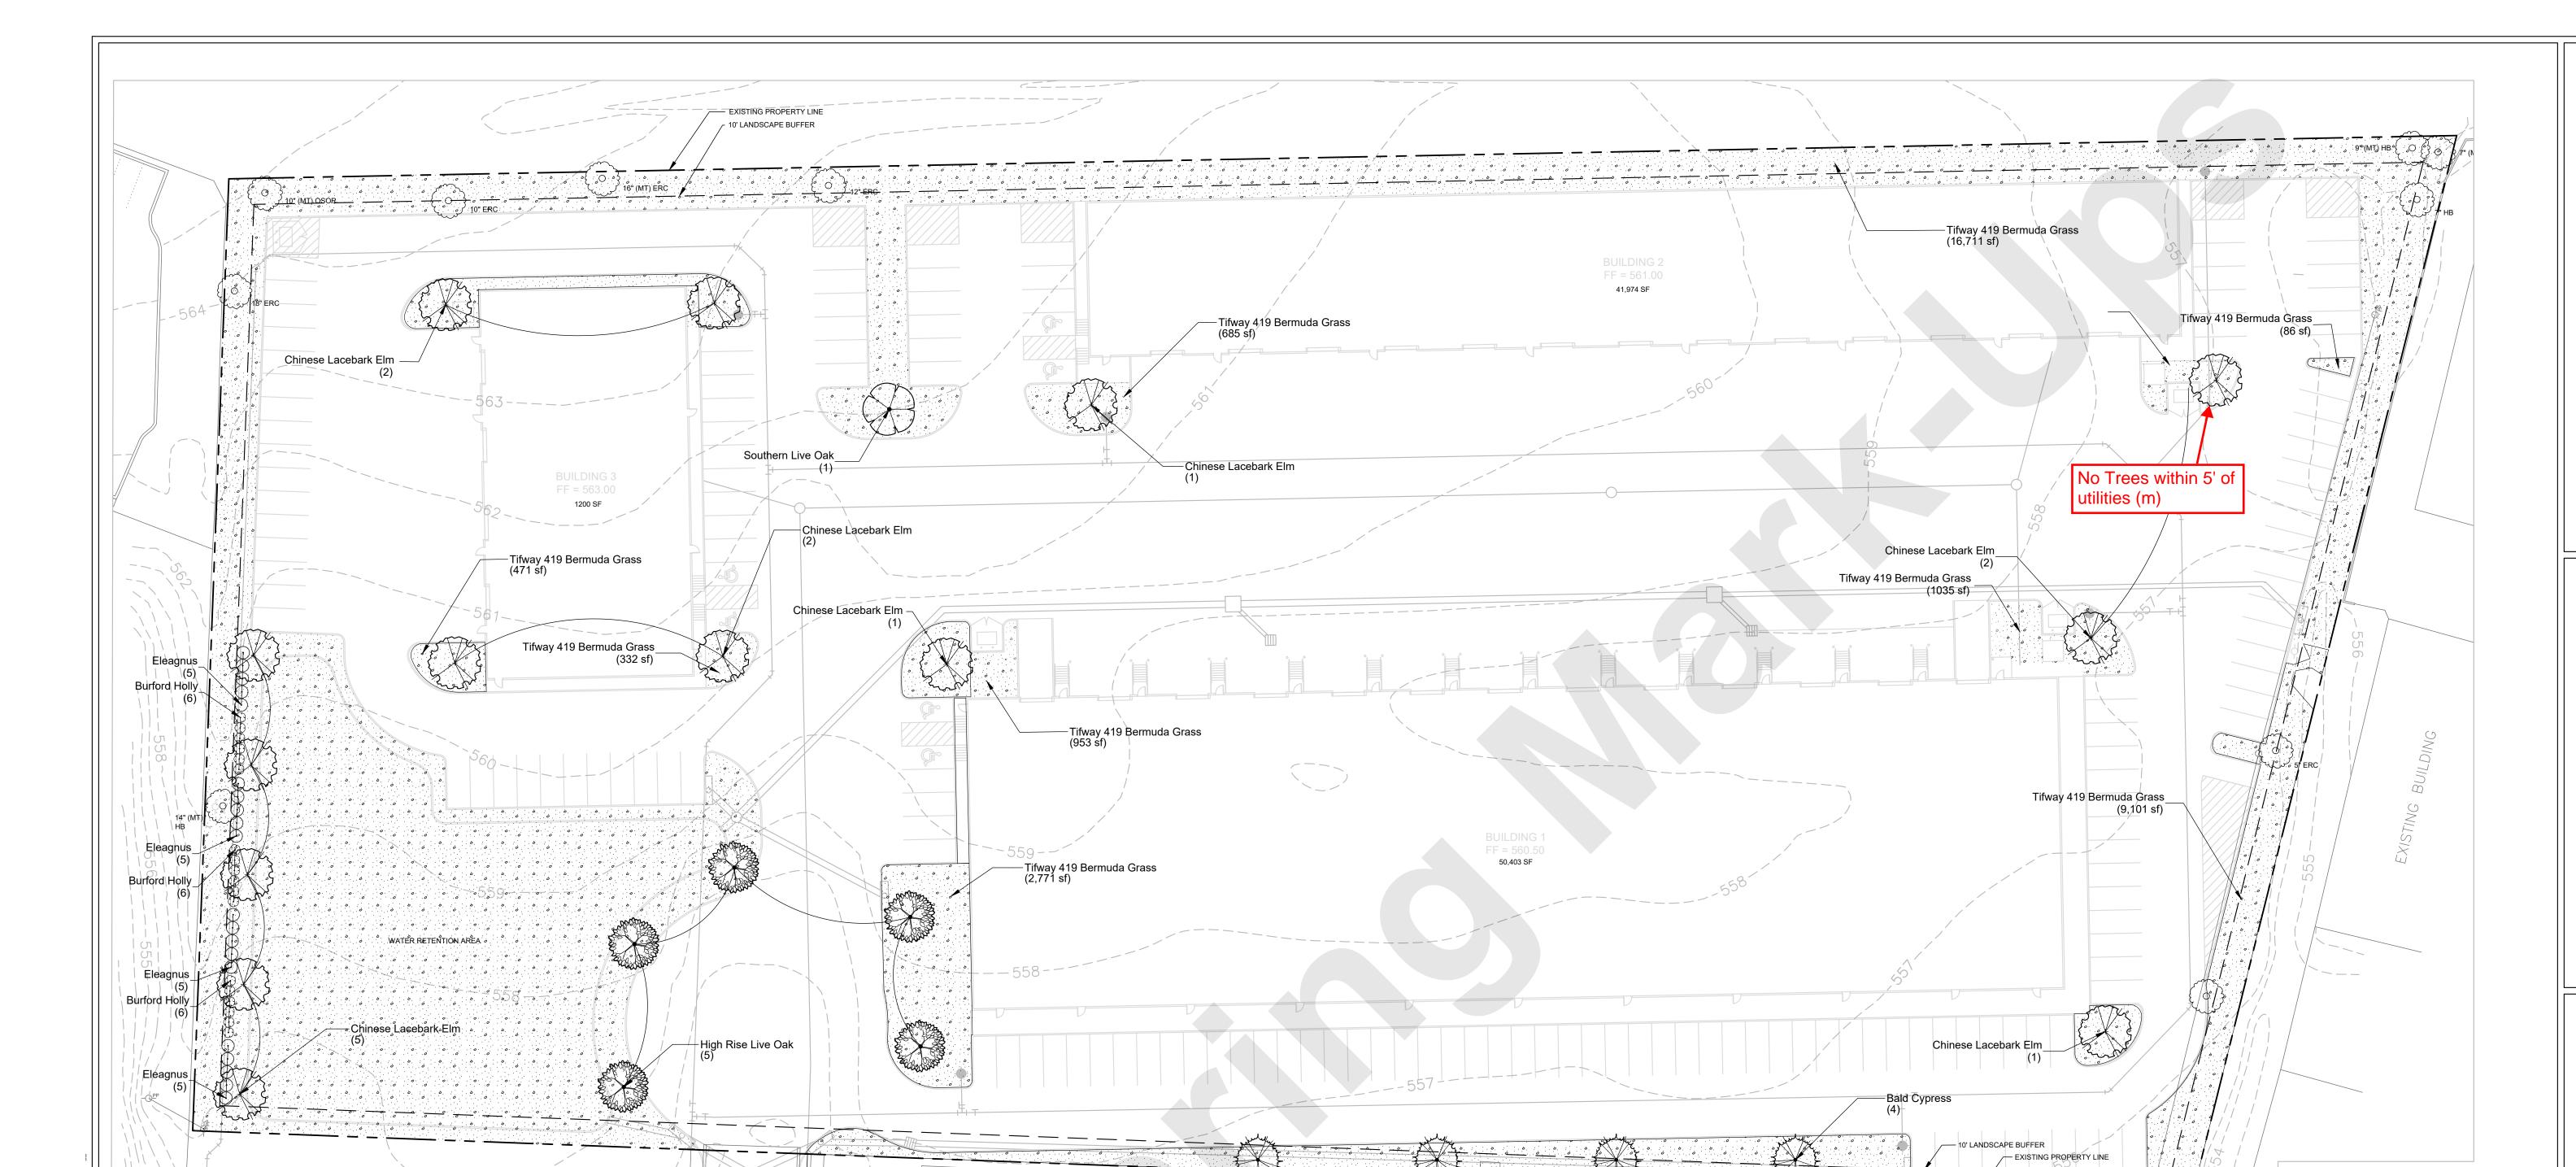

## PLANTING PLAN

1 L/ \(\dagger\)						
TREES	BOTANICAL / COMMON NAME	CONT	CAL	HT	SPD	QTY
	Quercus virginiana / Southern Live Oak	45 gal	3" Cal	8`-10` Ht.	4`-6` Spd	1
	Quercus virginiana `High Rise` / High Rise Live Oak	45 gal	3" Cal	8`-10` Ht.	6`-7` Spd.	5
The second secon	Taxodium distichum / Bald Cypress	45 gal	3" Cal	10`-12` Ht.	4`-6` Spd	4
	Ulmus parvifolia / Chinese Lacebark Elm	45 gal	3" Cal	8`-10` Ht.	4`-6` Spd	14
SHRUBS	BOTANICAL / COMMON NAME	SIZE	CAL	HT	SPD	QTY
$\odot$	Elaeagnus x ebbingei / Eleagnus	5 gal		18"-24" Ht.	18"-24" Spd	20
$\odot$	llex cornuta `Burfordii` / Burford Holly	5 gal		18"-24" Ht.	18"-24" Spd	18
GROUND COVERS	BOTANICAL / COMMON NAME	CONT	SIZE			QTY
	Cynodon dactylon `Tifway 419` / Tifway 419 Bermuda Grass	SOLID SOD				66,576 sf

# **EXISTING TREES**

EXISTING TREE TO REMAIN

# LANDSCAPE REQUIREMENTS

	9 II (LIVIE	
REQUIRED LANDSCAPING		
REQUIRED LANDSCAPING		
ZONED LIGHT INDUSTRIAL	REQUIRED	PROVIDED
TOTAL LANDSCAPE AREA PROVIDED (%)	10% OF SITE	21% OF SITE
TOTAL LANDSCAPE AREA PROVIDED (SF)	31,598 SF	66,576 SF
TREE MITIGATION		
	REQUIRED	PROVIDED
MITIGATION REQUIREMENTS (inches)	59" CALIPER*	60" CALIPER
* See Sheet L 1.01 for calculations		
PARKING LOT LANDSCAPING		
	REQUIRED	PROVIDED
200 SF MIN/ 2 ROWS OR MORE		✓
3 AREAS 200 FT/SQ X 3	600 SF	<b>√</b>
ONE TREE WITHIN 80' OF REQ. PARKING		✓
PERMIABLE LANDSCAPE PROVIDED		3,756 SF
SCREENING REQUIREMENTS		
	REQUIRED	PROVIDED
SCREEN TRASH AREAS	N/A	
SCREEN RESIDENTIAL OR MULTI-FAMILY	N/A	

REQUIRED PROVIDED

STREET TREES

1 TREE /50' FRONTAGE

# PLANTING NOTES

LANDSCAPE CONTRACTOR SHALL BE RESPONSIBLE FOR VERIFYING THE CORRECT LOCATION OF ALL UNDERGROUND UTILITIES, PIPES, STRUCTURES, AND LINE RUNS IN THE FIELD PRIOR TO THE INSTALLATION OF ANY

REFER TO PLANTING PLAN FOR PIANTING LOCATION AND PLANT MATERIAL LEGEND FOR SPECIFICATIONS. PLANT MATERIAL LOCATION TO BE STAKED IN THE FIELD AND APPROVED BY LANDSCAPE ARCHITECT PRIOR TO PLANTING.

LANDSCAPE CONTRACTOR SHALL BE RESPONSIBLE FOR ANY COORDINATION WITH OTHER CONTRACTORS ON SITE AS REQUIRED TO ACCOMPLISH ALL PLANTING OPERATIONS.

LANDSCAPE CONTRACTOR SHALL BE RESPONSIBLE FOR MAINTAINING ALL PLANTING BEDS IN A WEED AND DEBRIS FREE CONDITION AND SHALL ACCOMPLISH WATERING BY HAND AS DEEMED NECESSARY UNTIL SUBSTANTIAL

LANDSCAPE CONTRACTOR SHALL BE RESPONSIBLE FOR ALL QUANTITIES PER DRAWINGS AND SPECIFICATION BY IANDSCAPE ARCHITECT. PLANT QUANTITIES HAVE BEEN PROVIDED AS A CONVENIENCE ONLY AND SHALL NOT BE CONSIDERED ABSOLUTE. LANDSCAPE ARCHITECT TO BE NOTIFIED IF DISCREPANCIES OCCUR. OTHERWISE, THE

COMPLETION AND ACCEPTANCE BY THE OWNER. THE CONTRACTOR SHALL MAINTAIN ALL WORK FOR A PERIOD OF

ALL BED AREAS ARE TO BE FLUSH WITH FINISHED GRADE AT ADJACENT PAVEMENT. ALL BED AREAS SHALL BE ROTOTILLED TO BE A DEPTH OF 6", ADDING PREPARED SOIL MIXTURE AS REQUIRED.

MULCH
AFTER SETTLEMENT, ALL PLANTING BED MULCH DEPTHS SHALL BE A MIN. OF 3". ALL AREAS DISTURBED BY PLANTING OPERATIONS SHALL BE FINE GRADED AND REPLANTED. MULCH SHALL BE TEXAS NATIVE CEDAR


ALL PLANT MATERIAL SHALL CONFORM TO THE SIZES GIVEN IN THE PLANT LIST AND SHALL BE NURSERY GROWN IN ACCORDANCE WITH THE "AMERICAN STANDARD FOR NURSERY STOCK", LATEST EDITION. ALL PLANTING SHALL BE IN ACCORDANCE WITH STANDARD AMERICAN ASSOCIATION OF NURSERYMEN PROCEDURES AND SPECIFICATIONS.

PROTECTED TREES SHALL BE MARKED AND THE DRIP LINE OF SAID TREES SHALL BE PROTECTED PRIOR TO AND DURING ALL CONSTRUCTION, INCLUDING EARTHWORK.

IRRIGATION
IRRIGATION WILL MEET ALL TCEQ AND UDC REQUIREMENTS.

30 DAYS AFTER SUBSTANTIAL COMPLETION AND ACCEPTANCE.

CONTRACTOR IS TO BID THEIR OWN VERIFIED QUANTITIES PER LANDSCAPE PLAN.

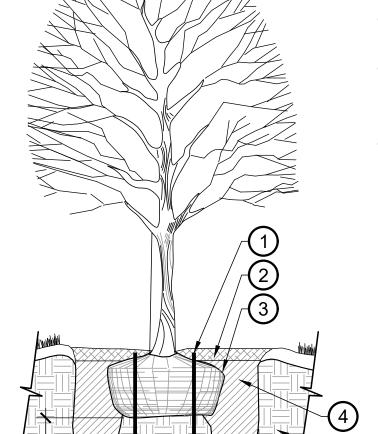

**NEW TREE PLANTING** 

NEVER CUT LEADER

(3) ARBOR STAKES. INSTALL PER MANUFACTURE'S SPECIFICATIONS

2 SPECIFIED MULCH - 3" MIN. DEPTH ENTIRE TREE BASIN 3 SET TOP OF ROOT BALL 3" ABOVE FINISH GRADE. BUILD 3" HT. SAUCER AROUND PLANTING PIT WITH TOPSOIL.

4 LIVING EARTH PLANTING MIX OR APPROVED EQUAL BY LANDSCAPE ARCHITECT. WATER AND TAMP TO REMOVE SIDE AND BOTTOM AIR POCKETS 6" MIN.

5 UNCOMPACTED NATIVE SOIL/UNDISTURBED SUBGRADE

FOR BALL & BURLAP REMOVE WIRE/TWINE FROM AROUND BURLAP, FOLD TOP THIRD DOWN OR CUT/REMOVE PRIOR TO BACKFILL.

> Project No.: 35989 Issued: Drawn By: CAP Checked By: MAW AS SHOWN Scale:

LANDSCAPE PLAN

SHEET SIZE: 24" x 36" | Sheet Number

TU-18-19

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TBPE FIRM #F-312


<u>l</u>nd

Rockwall

END OF ROCKWA

Sheet Title

L 2.01

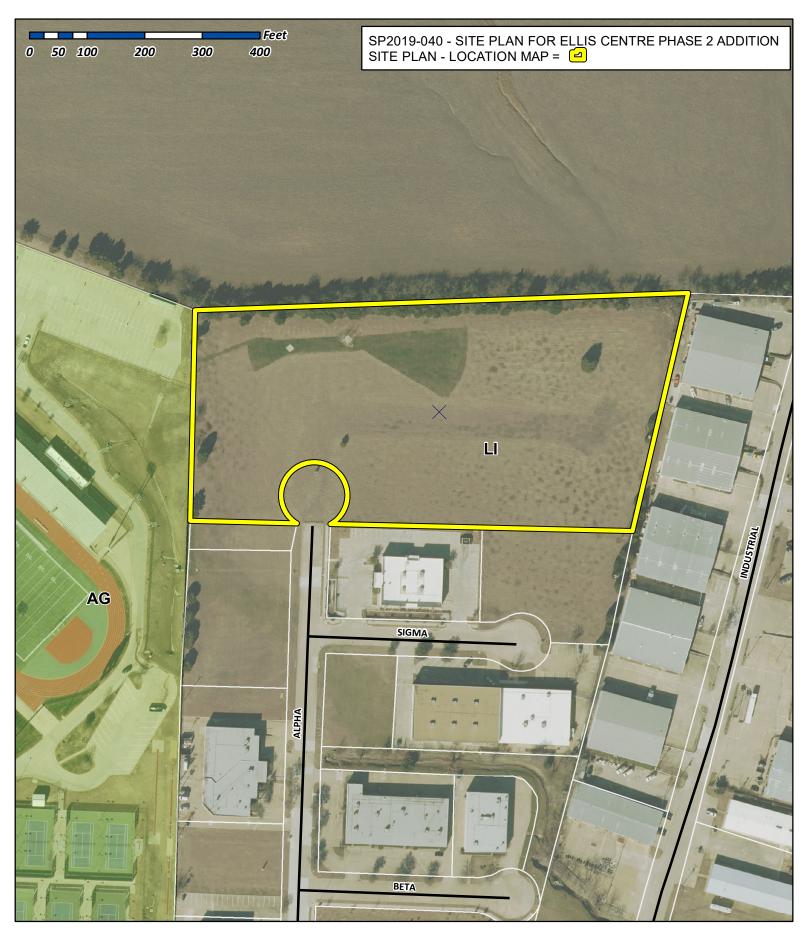





# City of Rockwall

Planning & Zoning Department 385 S. Goliad Street Rockwall, Texas 75032 (P): (972) 771-7745 (W): www.rockwall.com The City of Rockwall GIS maps are continually under development and therefore subject to change without notice. While we endeavor to provide timely and accurate information, we make no guarantees. The City of Rockwall makes no warranty, express or implied, including warranties of merchantability and fitness for a particular purpose. Use of the information is the sole responsibility of the user.




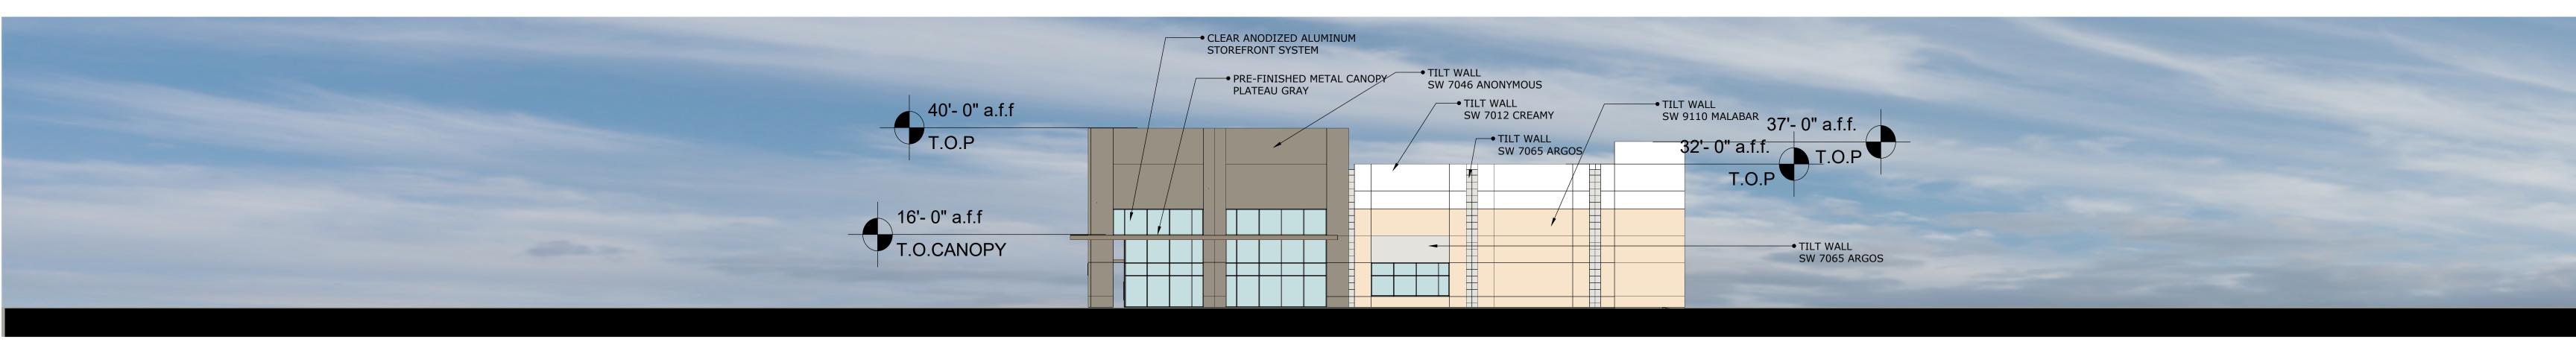

EAST

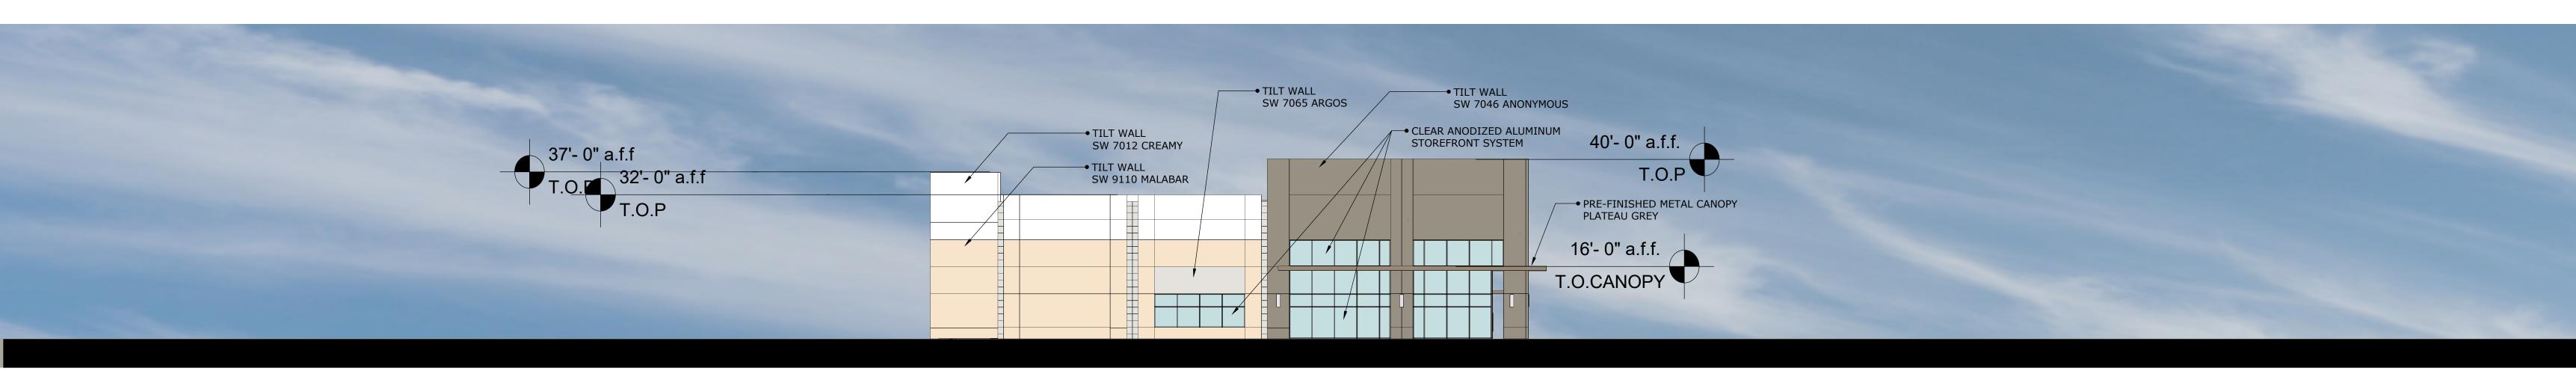

WEST

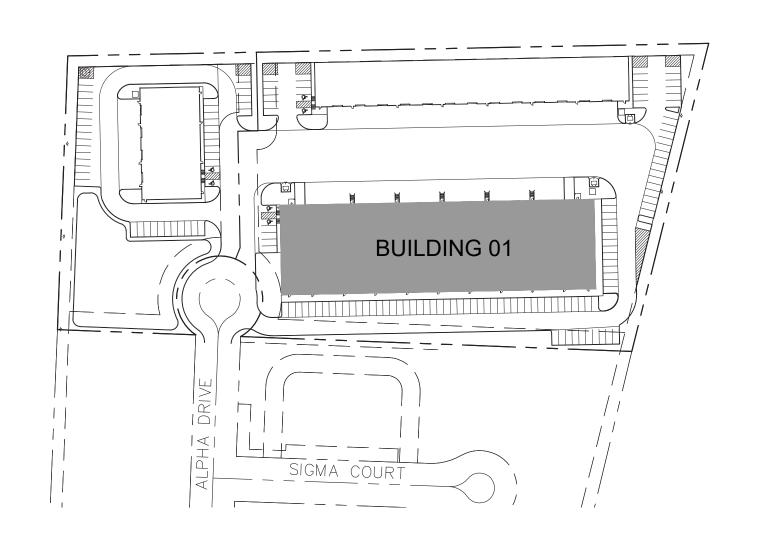

FAÇADE			
BLDG 1			
	METAL CANOPY	PRIMARY MASONRY: PAINTED CONCRETE TILT WALL	FAÇADE TOTAL SF (EXCLUSIVE OF DOORS & WINDOWS)
NORTH	0	14,140	14,140
SOUTH	235	11,220	11,455
EAST	59	3,734	3,793
WEST	59	3,734	3,793
			TOTAL
SF of Materials	353	32,828	33,181
Percentage of Material	1%	99%	100%







PRE-FINISHED METAL CANOPY PLATEAU GREY → TILT WALL SW 7046 ANONYMOUS CLEAR ANODIZED ALUMINUM STOREFRONT SYSTEM → PRE-FINISHED METAL CANOPY PLATEAU GREY PRE-FINISHED METAL CANOPY
PLATEAU GREY → PRE-FINISHED METAL CANOPY TILT WALL
SW 7065 ARGOS TILT WALL SW 7065 ARGOS PLATEAU GREY 40'- 0" a.f.f. → TILT WALL SW 9110 MALABAR → TILT WALL SW 7012 CREAMY T.O.P 16'- 0" a.f.f T.O.P 10'- 8" a.f.f. T.O.CANOPY

SOUTH

# TYPICAL DUMPSTER ENCLOSURE ELEVATIONS

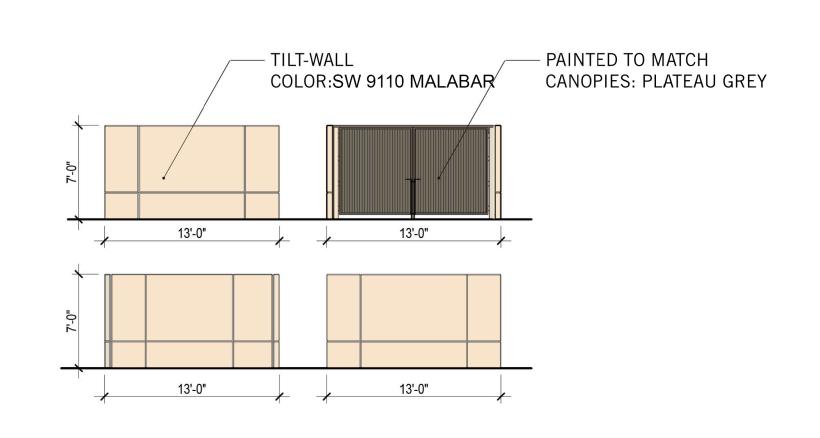

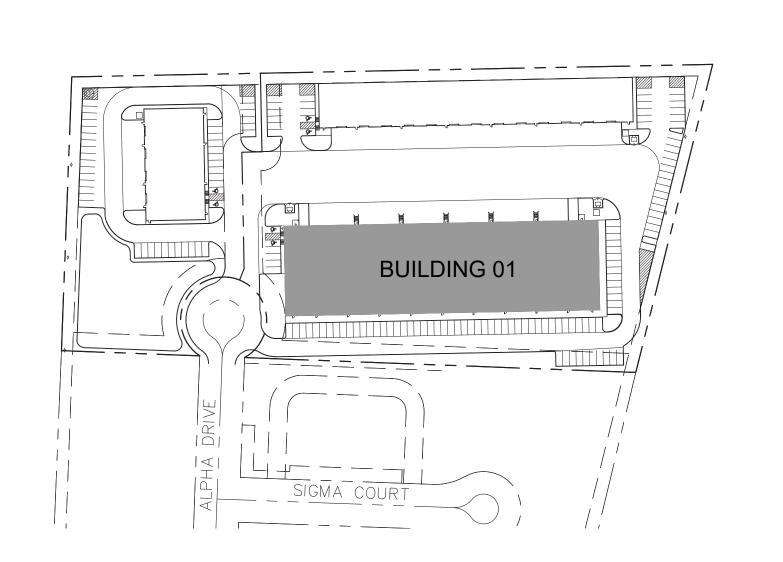


FAÇADE			
BLDG 1			
	METAL CANOPY	PRIMARY MASONRY: PAINTED CONCRETE TILT WALL	FAÇADE TOTAL SF (EXCLUSIVE OF DOORS & WINDOWS)
NORTH	0	14,140	14,140
SOUTH	235	11,220	11,455
EAST	59	3,734	3,793
WEST	59	3,734	3,793
			TOTAL
SF of Materials	353	32,828	33,181
Percentage of Material	1%	<b>99</b> %	100%

BUILDING ELEVATIONS


**ÓBRIEN** 




SOUTH

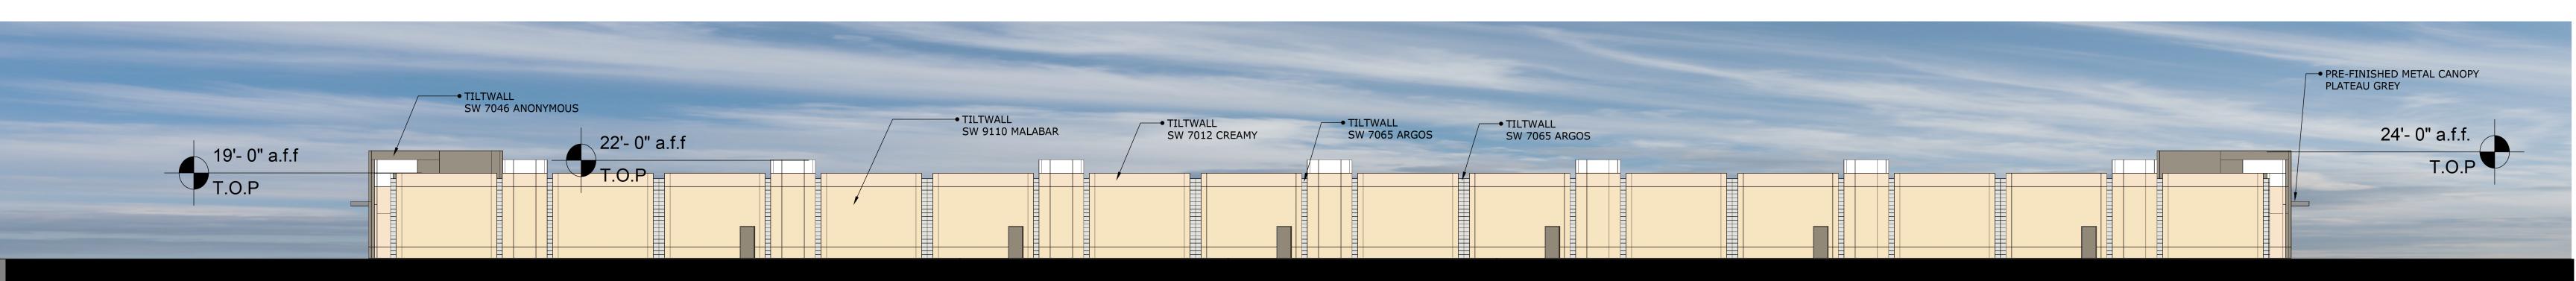


NORTH

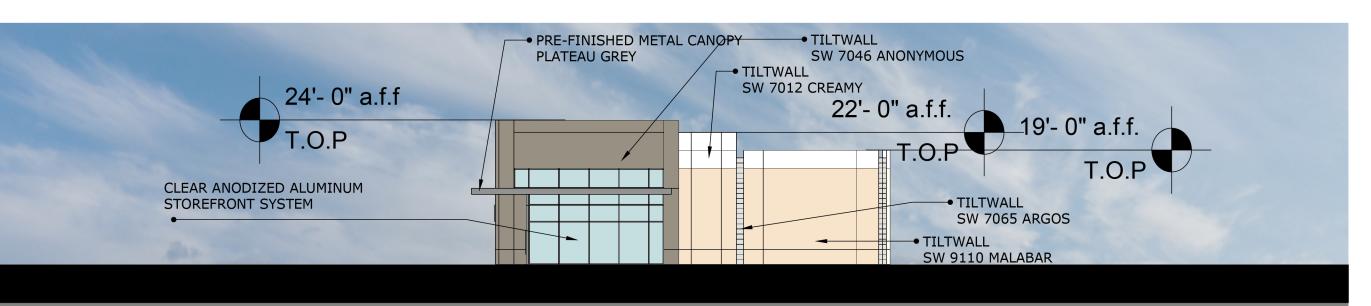

EAST

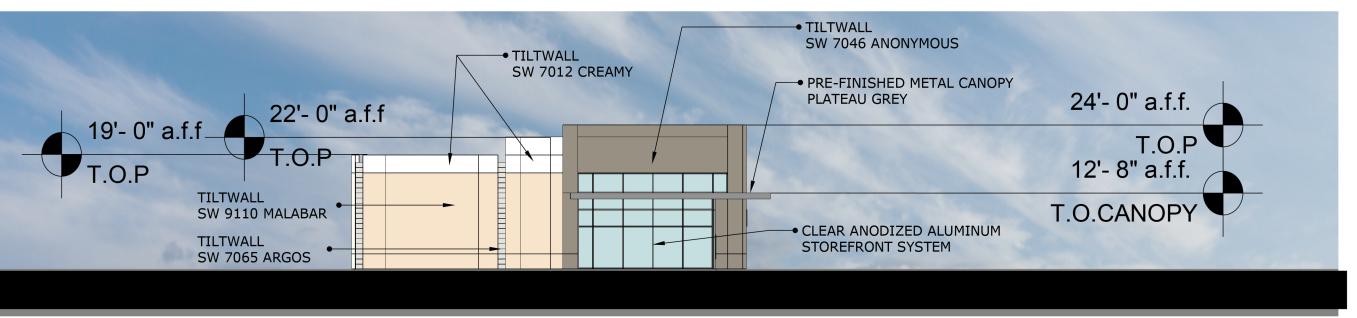


WEST

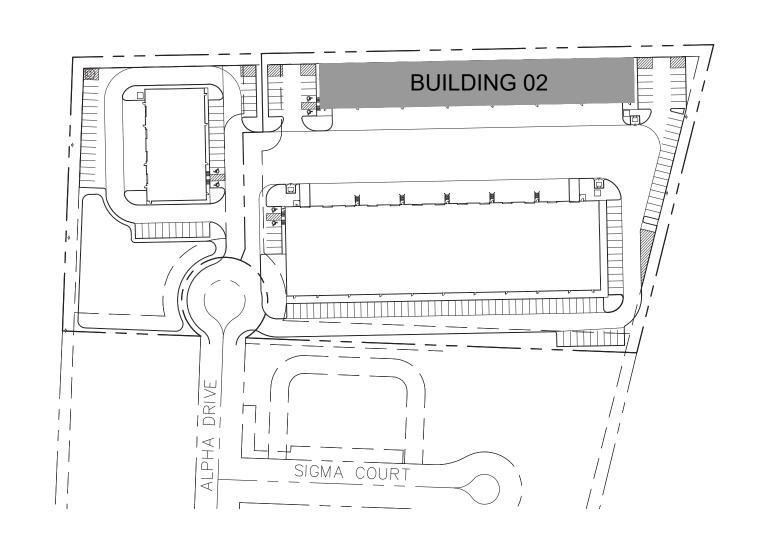


FAÇADE			
BLDG 2			
	METAL CANOPY	PRIMARY MASONRY: PAINTED CONCRETE TILT WALL	FAÇADE TOTAL SF (EXCLUSIVE OF DOORS & WINDOWS)
NORTH	0	9,178	9,178
SOUTH	66	5,714	5,780
EAST	33	1,086	1,119
WEST	33	1,086	1,119
			TOTAL
SF of Materials	132	17,065	17,196
Percentage of Material	1%	99%	100%
		·	-

ÓBRIEN


BUILDING ELEVATIONS

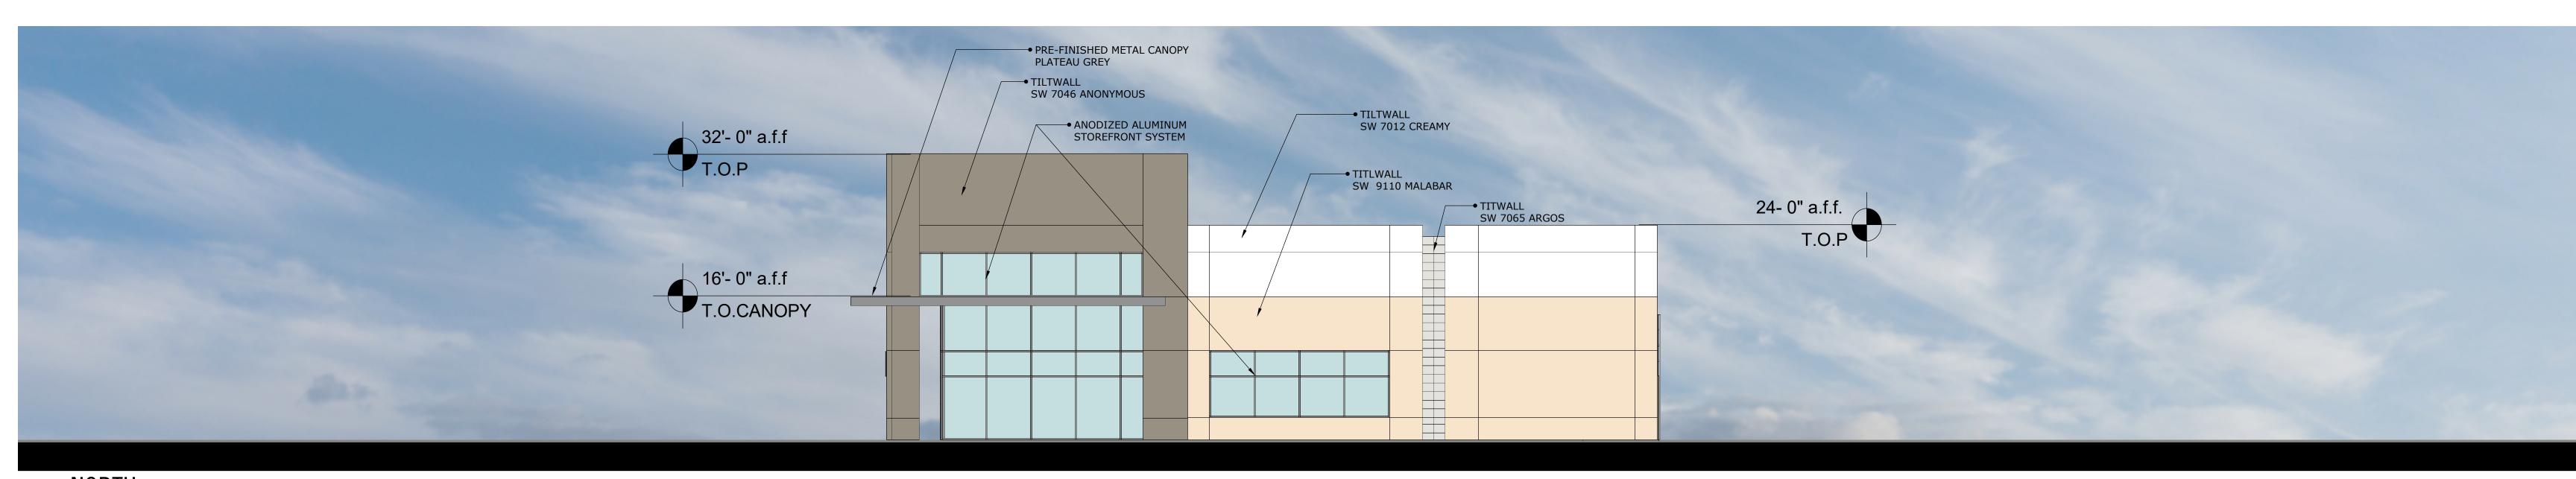


NORTH

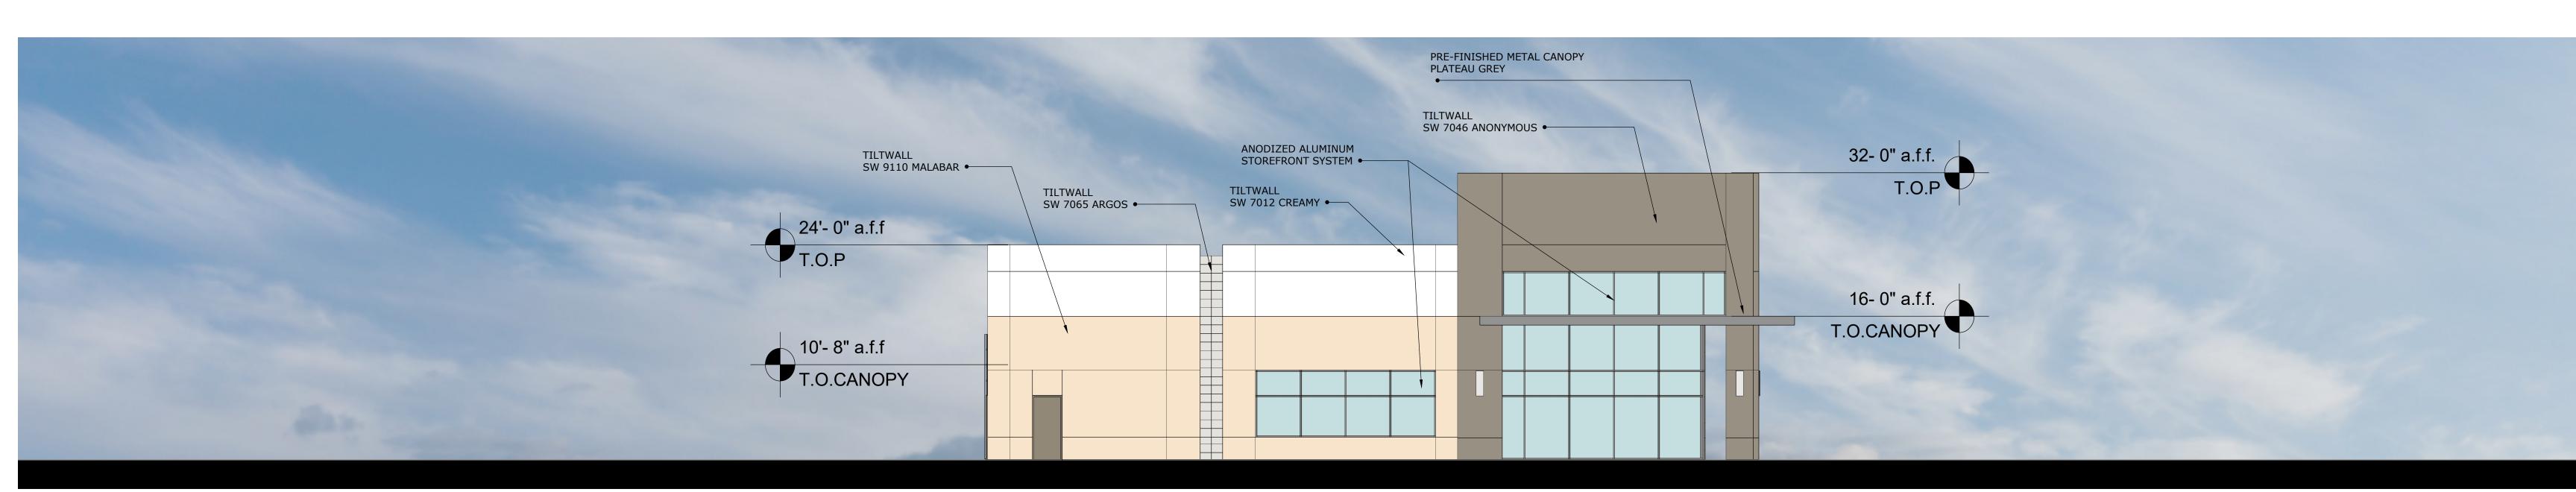


SOUTH

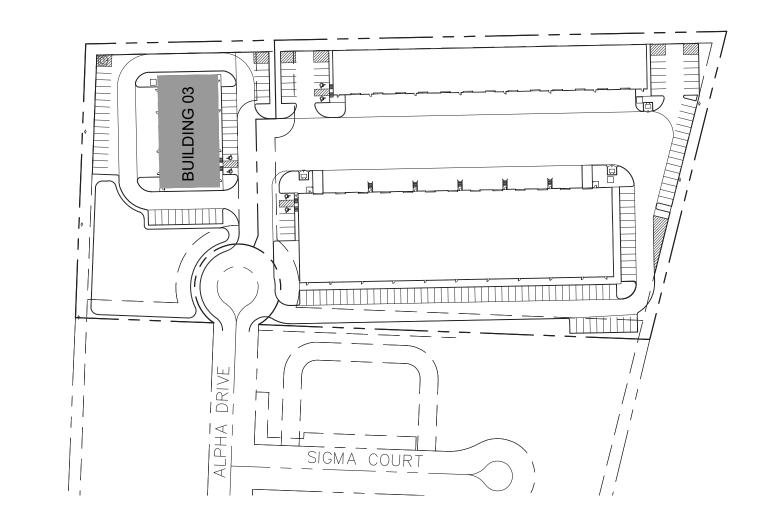


FAÇADE BLDG 3			
	METAL CANOPY	PRIMARY MASONRY: PAINTED CONCRETE TILT WALL	FAÇADE TOTAL SF (EXCLUSIVE OF DOORS & WINDOWS)
NODTH	25	1./24	1.//0
NORTH	35	1,634	1,669
SOUTH	35	1,634	1,669
EAST	74	2,824	2,898
WEST	0	3,096	3,096
			TOTAL
SF of Materials	144	9,188	9,332
Percentage of Material	2%	98%	100%

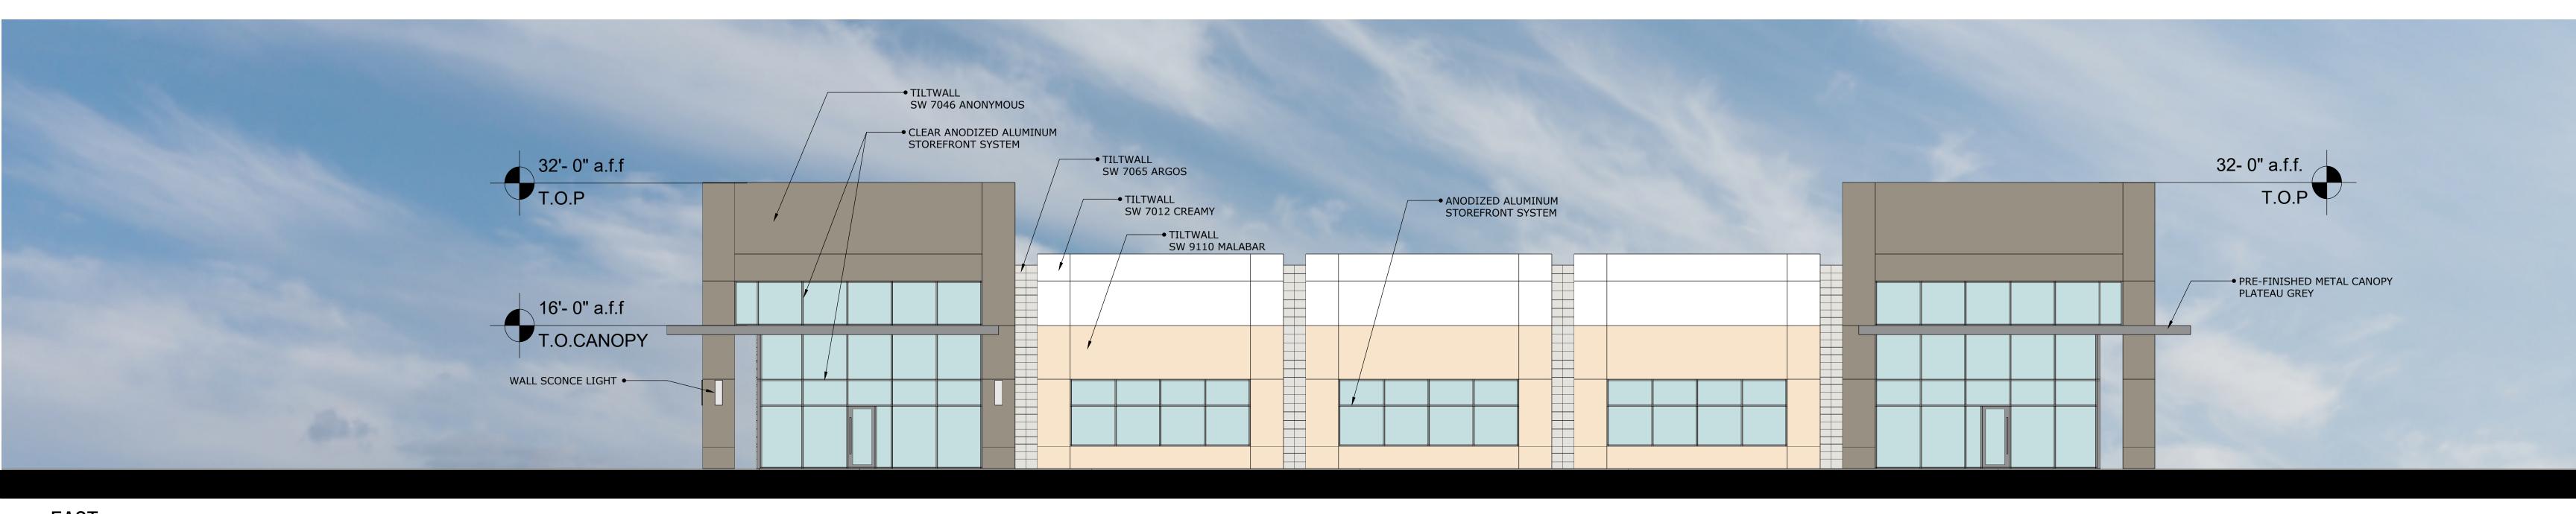

EAST

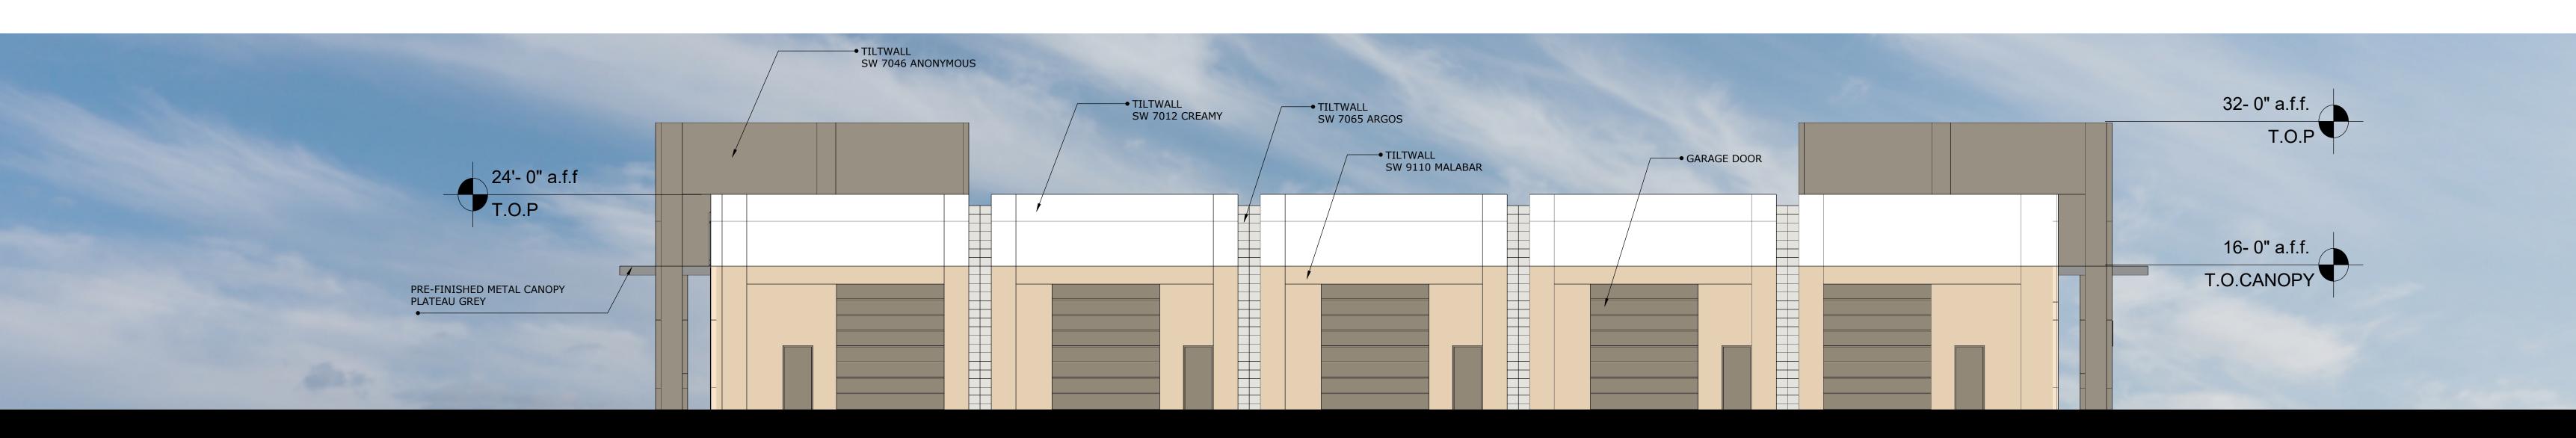


WEST

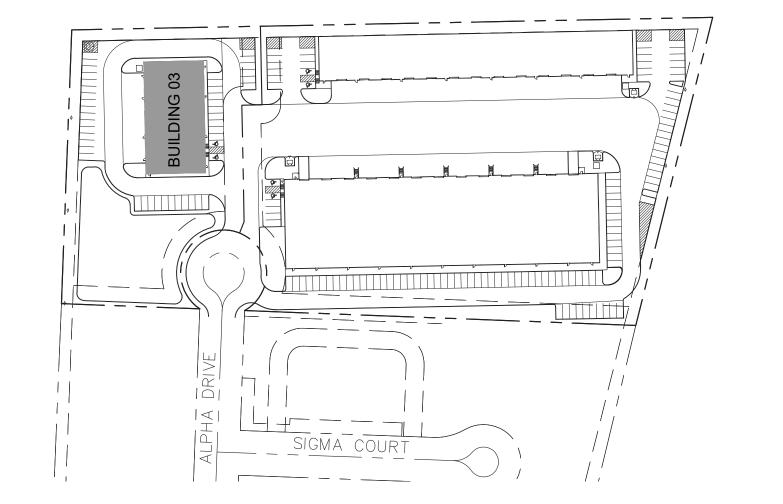

FAÇADE BLDG 3			
BLDG 3	METAL CANOPY	PRIMARY MASONRY: PAINTED CONCRETE TILT WALL	FAÇADE TOTAL SF (EXCLUSIVE OF DOORS & WINDOWS)
			,
NORTH	35	1,634	1,669
SOUTH	35	1,634	1,669
EAST	74	2,824	2,898
WEST	0	3,096	3,096
			TOTAL
SF of Materials	144	9,188	9,332
Percentage of Material	<b>2</b> %	98%	100%

URBAN INDUSTRIAL CENTER - BLDG 3

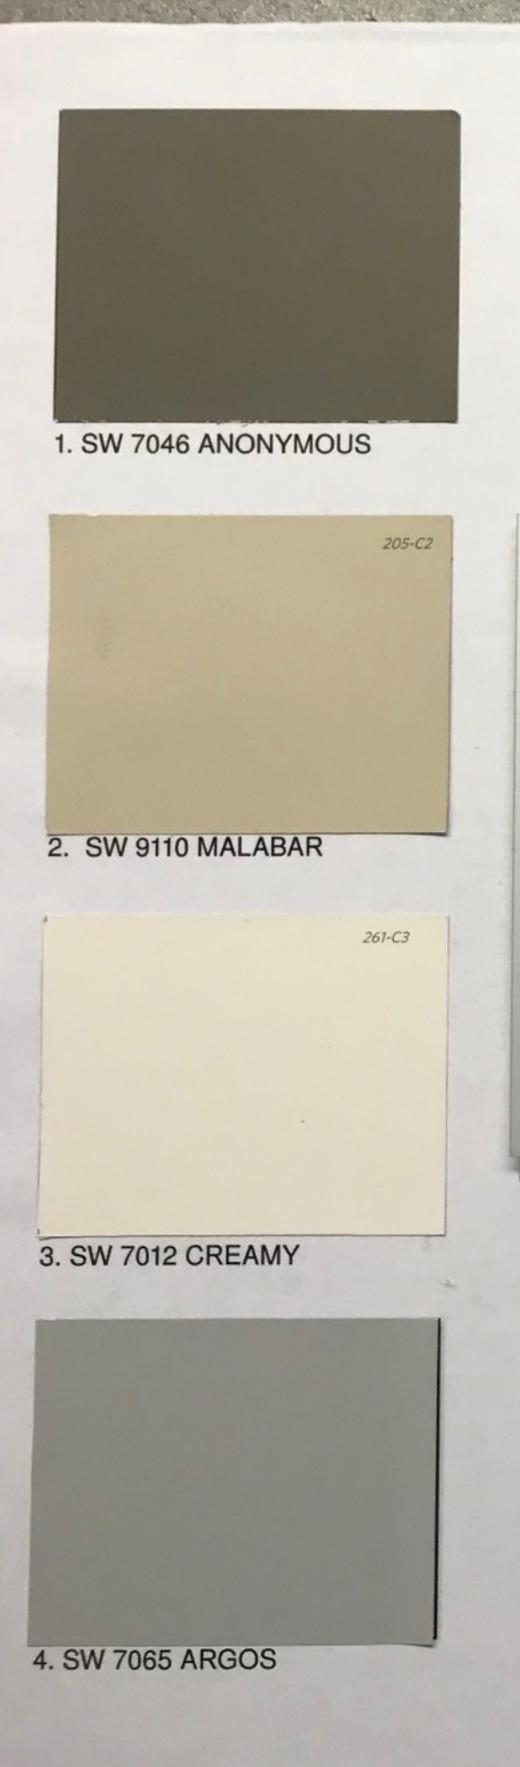



PLATEAU GRAY



## APPLICANT INFORMATION


O'BRIEN Joshua Atkins, AIA 5310 HARVEST HILL ROAD DALLAS, TX 75230 972.788.1010 josh.atkins@obrienarch.com


## OWNER INFORMATION

ROCKWALL URBAN INDUSTRIAL, LP. 13150 COIT RD, SUITE 205 DALLAS, TX 75240 214.457.8198 reid@longbowinterests.com


### PROJECT NAME

Rockwall Urban + Industrial Center CASE NUMBER:

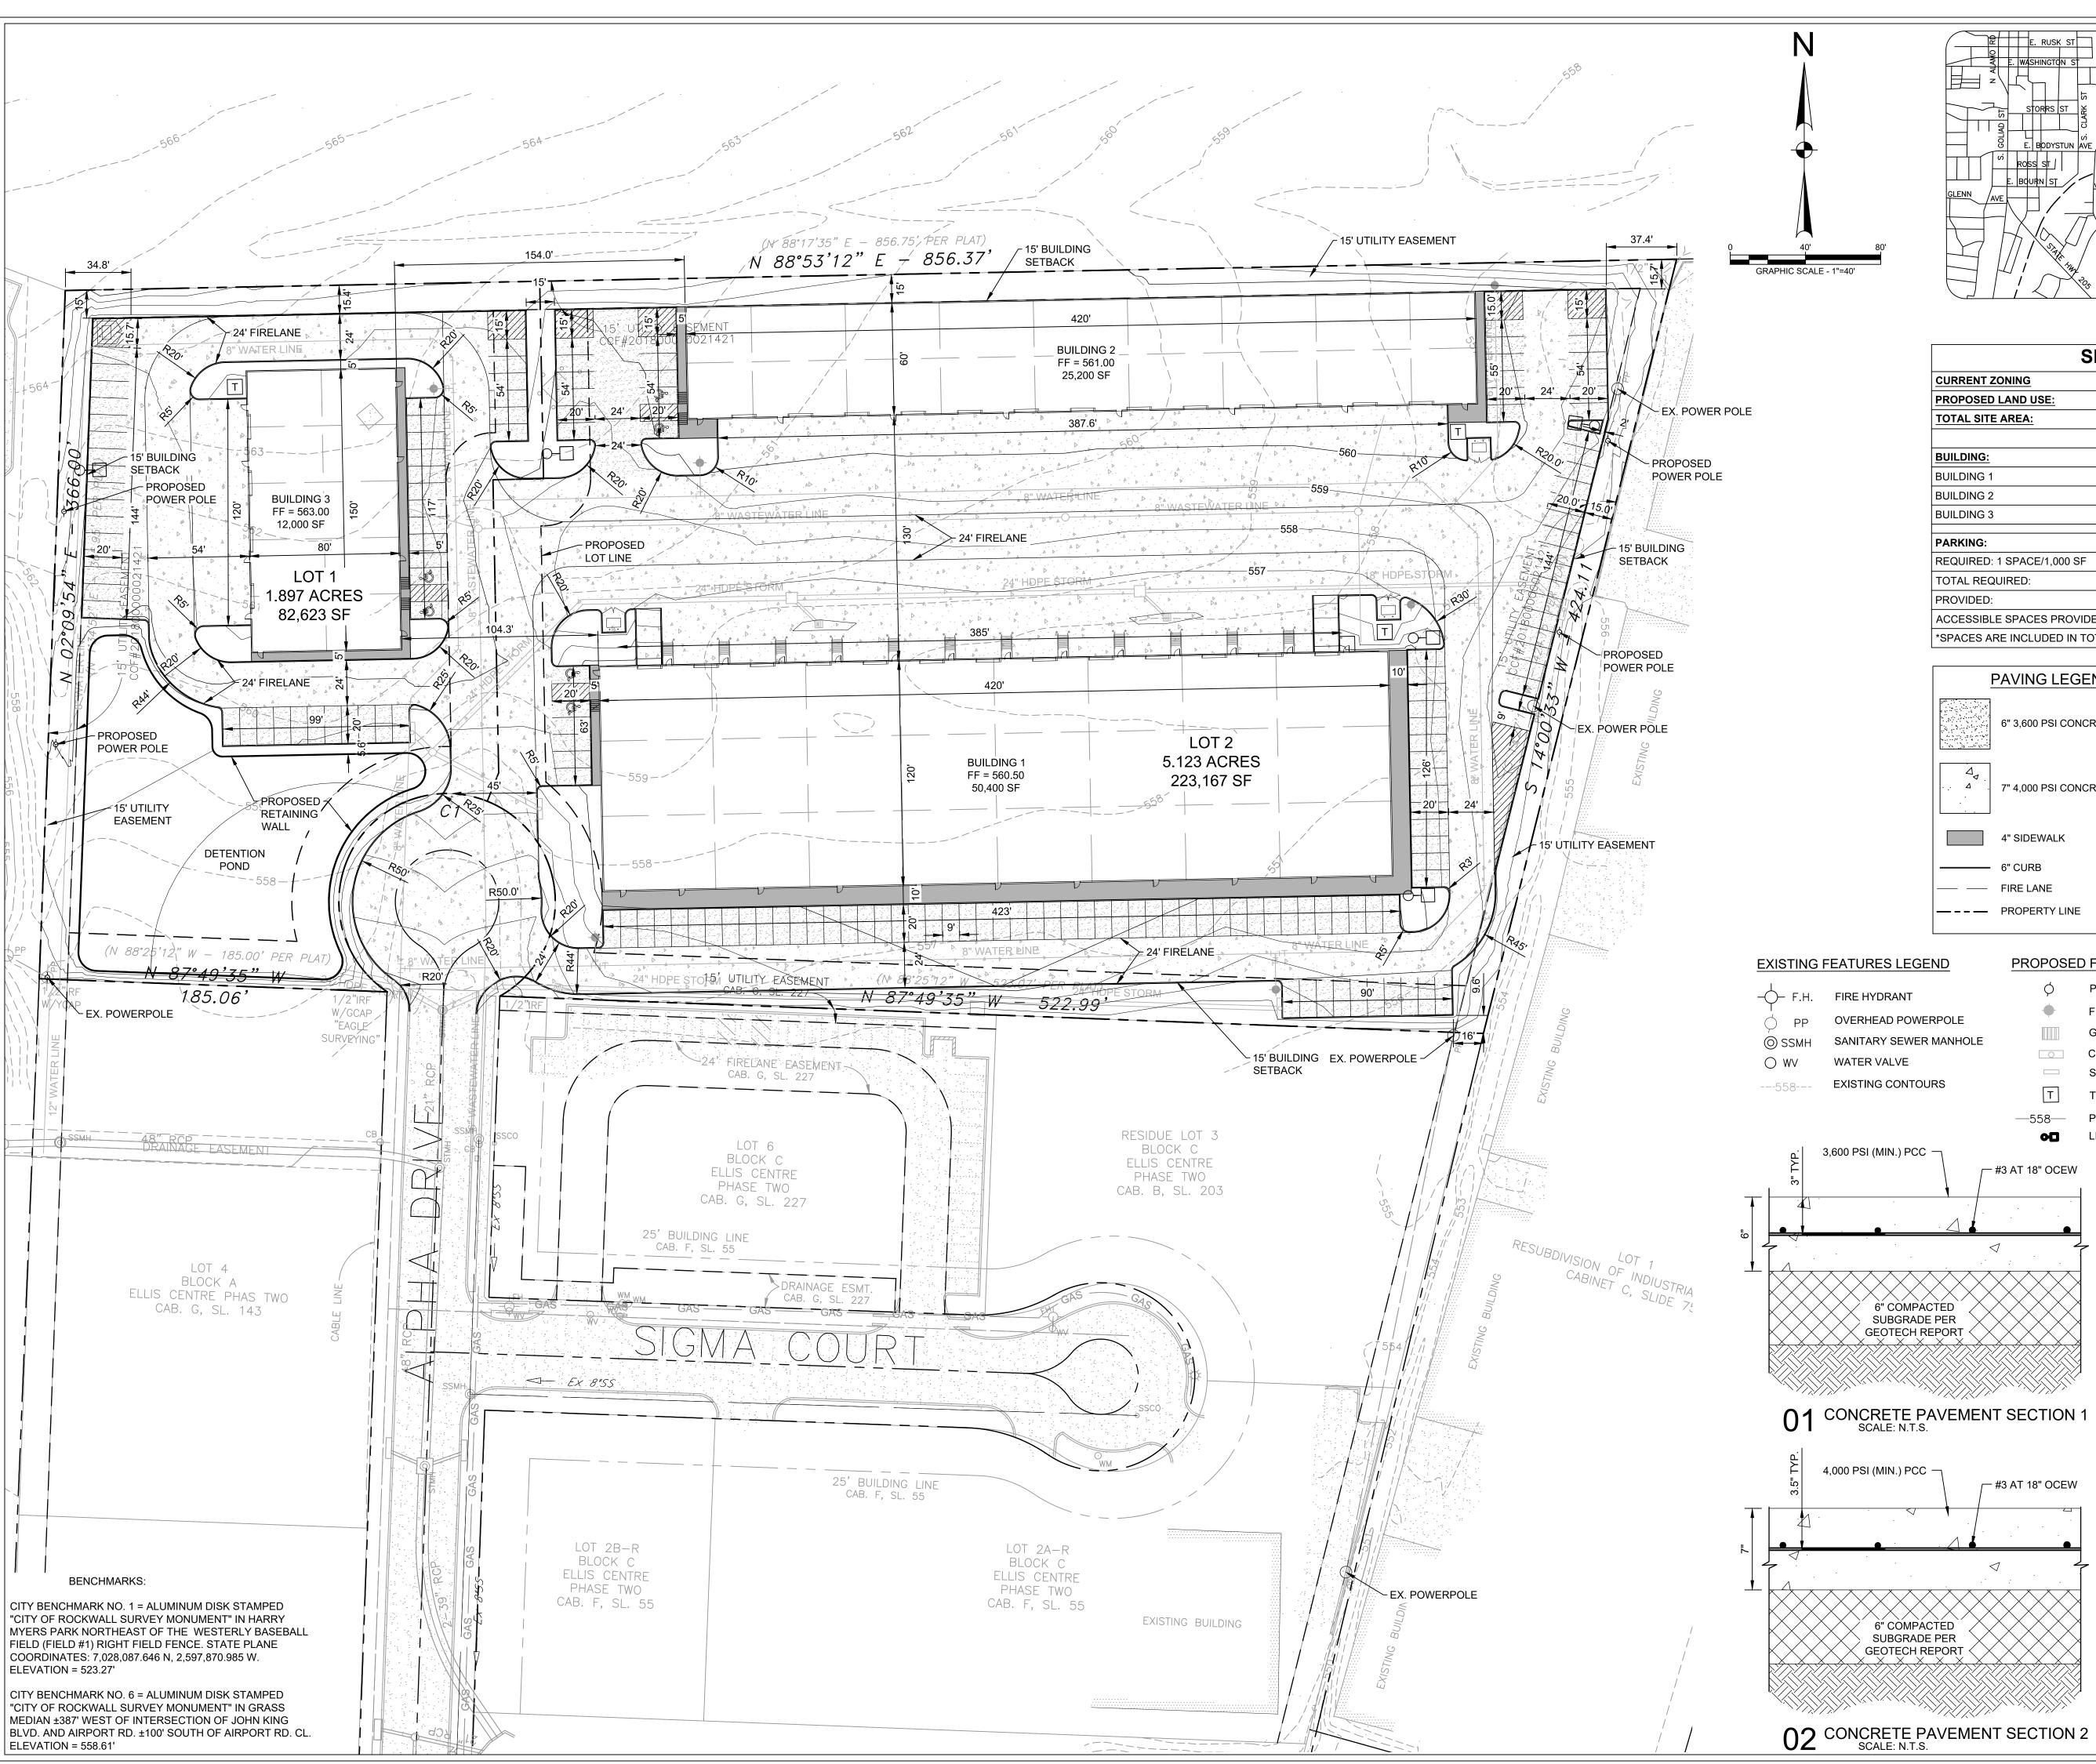

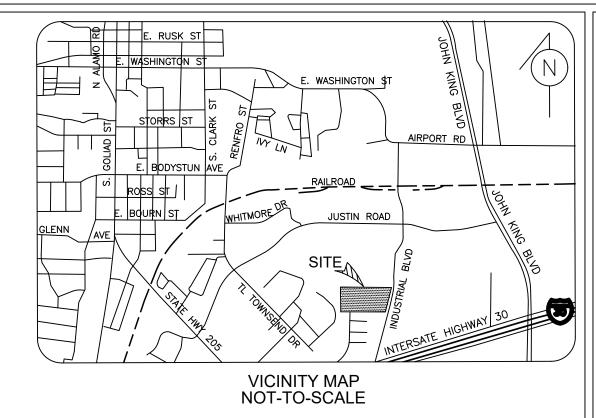


#### **SHEET DATA: CURRENT ZONING** LIGHT INDUSTRIAL PROPOSED LAND USE: LIGHT INDUSTRIAL **TOTAL SITE AREA:** 7.02 ACRES **BUILDING**: **BUILDING 1** 50,400 SF BUILDING 2 25,200 SF 12,000 SF BUILDING 3 PARKING: REQUIRED: 1 SPACE/1,000 SF SPACES TOTAL REQUIRED: SPACES PROVIDED: SPACES ACCESSIBLE SPACES PROVIDED: \*SPACES ARE INCLUDED IN TOTAL ABOVE

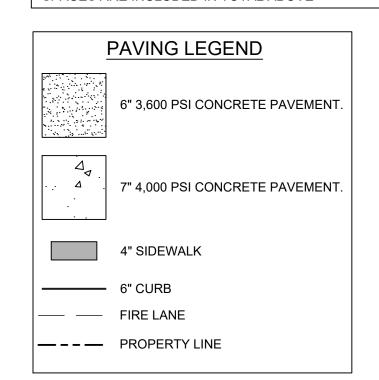


PROPOSED FEATURES LEGEND

	FIDE LIVED ANT	ø	POWER POLE
<b>)</b> − F.H.	FIRE HYDRANT	•	FIRE HYDRANT
→ PP  →	OVERHEAD POWERPOLE		
SSMH	SANITARY SEWER MANHOLE		GRATE INLET
$\bigcirc$ WV	WATER VALVE	0	CURB INLET
<b>O</b>	EXISTING CONTOURS		STORM HEADWALL
558	EXISTING CONTOURS	T	TRANSFORMER PAD
		<u> </u>	PROPOSED CONTOU

LIGHT POLE

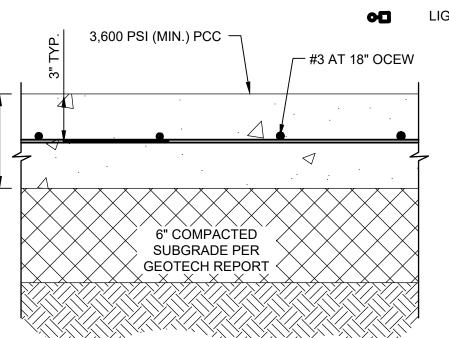

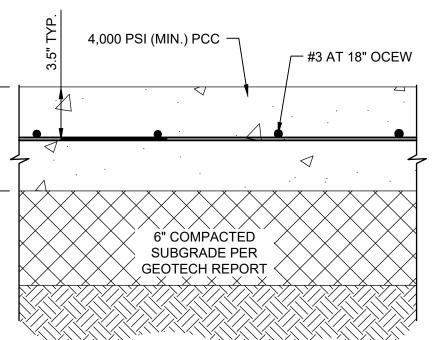

TEL: (214) 457-8198 **ENGINEER** HALFF ASSOCIATES, INC. 1201 NORTH BOWSER ROAD RICHARDSON, TX. 75081 CONTACT: DYLAN HEDRICK EMAIL: dhedrick@halff.com TEL: (214) 217-6426 TBPE FIRM# F-312

NOTES:

NOTED.

13150 COIT ROAD DALLAS, TX. 75240

ALL RESPONSIBILITY FOR ADEQUACY OF DESIGN REMAIN WITH THE DESIGN ENGINEER. THE CITY OF ROCKWALL, IN REVIEWING AND RELEASING PLANS FOR CONSTRUCTION, ASSUMES NO RESPONSIBILITY FOR ADEQUACY OF DESIGN.

1. ALL DIMENSIONS ARE TO FACE

ROCKWALL URBAN INDUSTRIAL , LP

OWNER/ DEVELOPER

CONTACT: REID CALDWELL

EMAIL: reid@longbowinterests.com

OF CURB UNLESS OTHERWISE

SHEET SIZE: 24" x 36" | Sheet Number

Case Number:

Industrial

Rockwall

DRIVE 75087

END


**PRELIMINARY** FOR INTERIM REVIEW ONLY THESE DOCUMENTS ARE FOR INTERIM REVIEW AND ARE NOT INTENDED FOR REGULATORY APPROVAL, PERMIT,

BIDDING OR CONSTRUCTION PURPOSES. THEY WERE PREPARED BY, OR UNDER THE SUPERVISION OF: 10/18/2019

DYLAN B. HEDRICK TBPE FIRM # F-312

Project No.: 35989 Issued: OCTOBER 2019 Drawn By: REP Checked By: DBH Scale: AS SHOWN

Sheet Title DETAILED SITE PLAN 1 OF 1

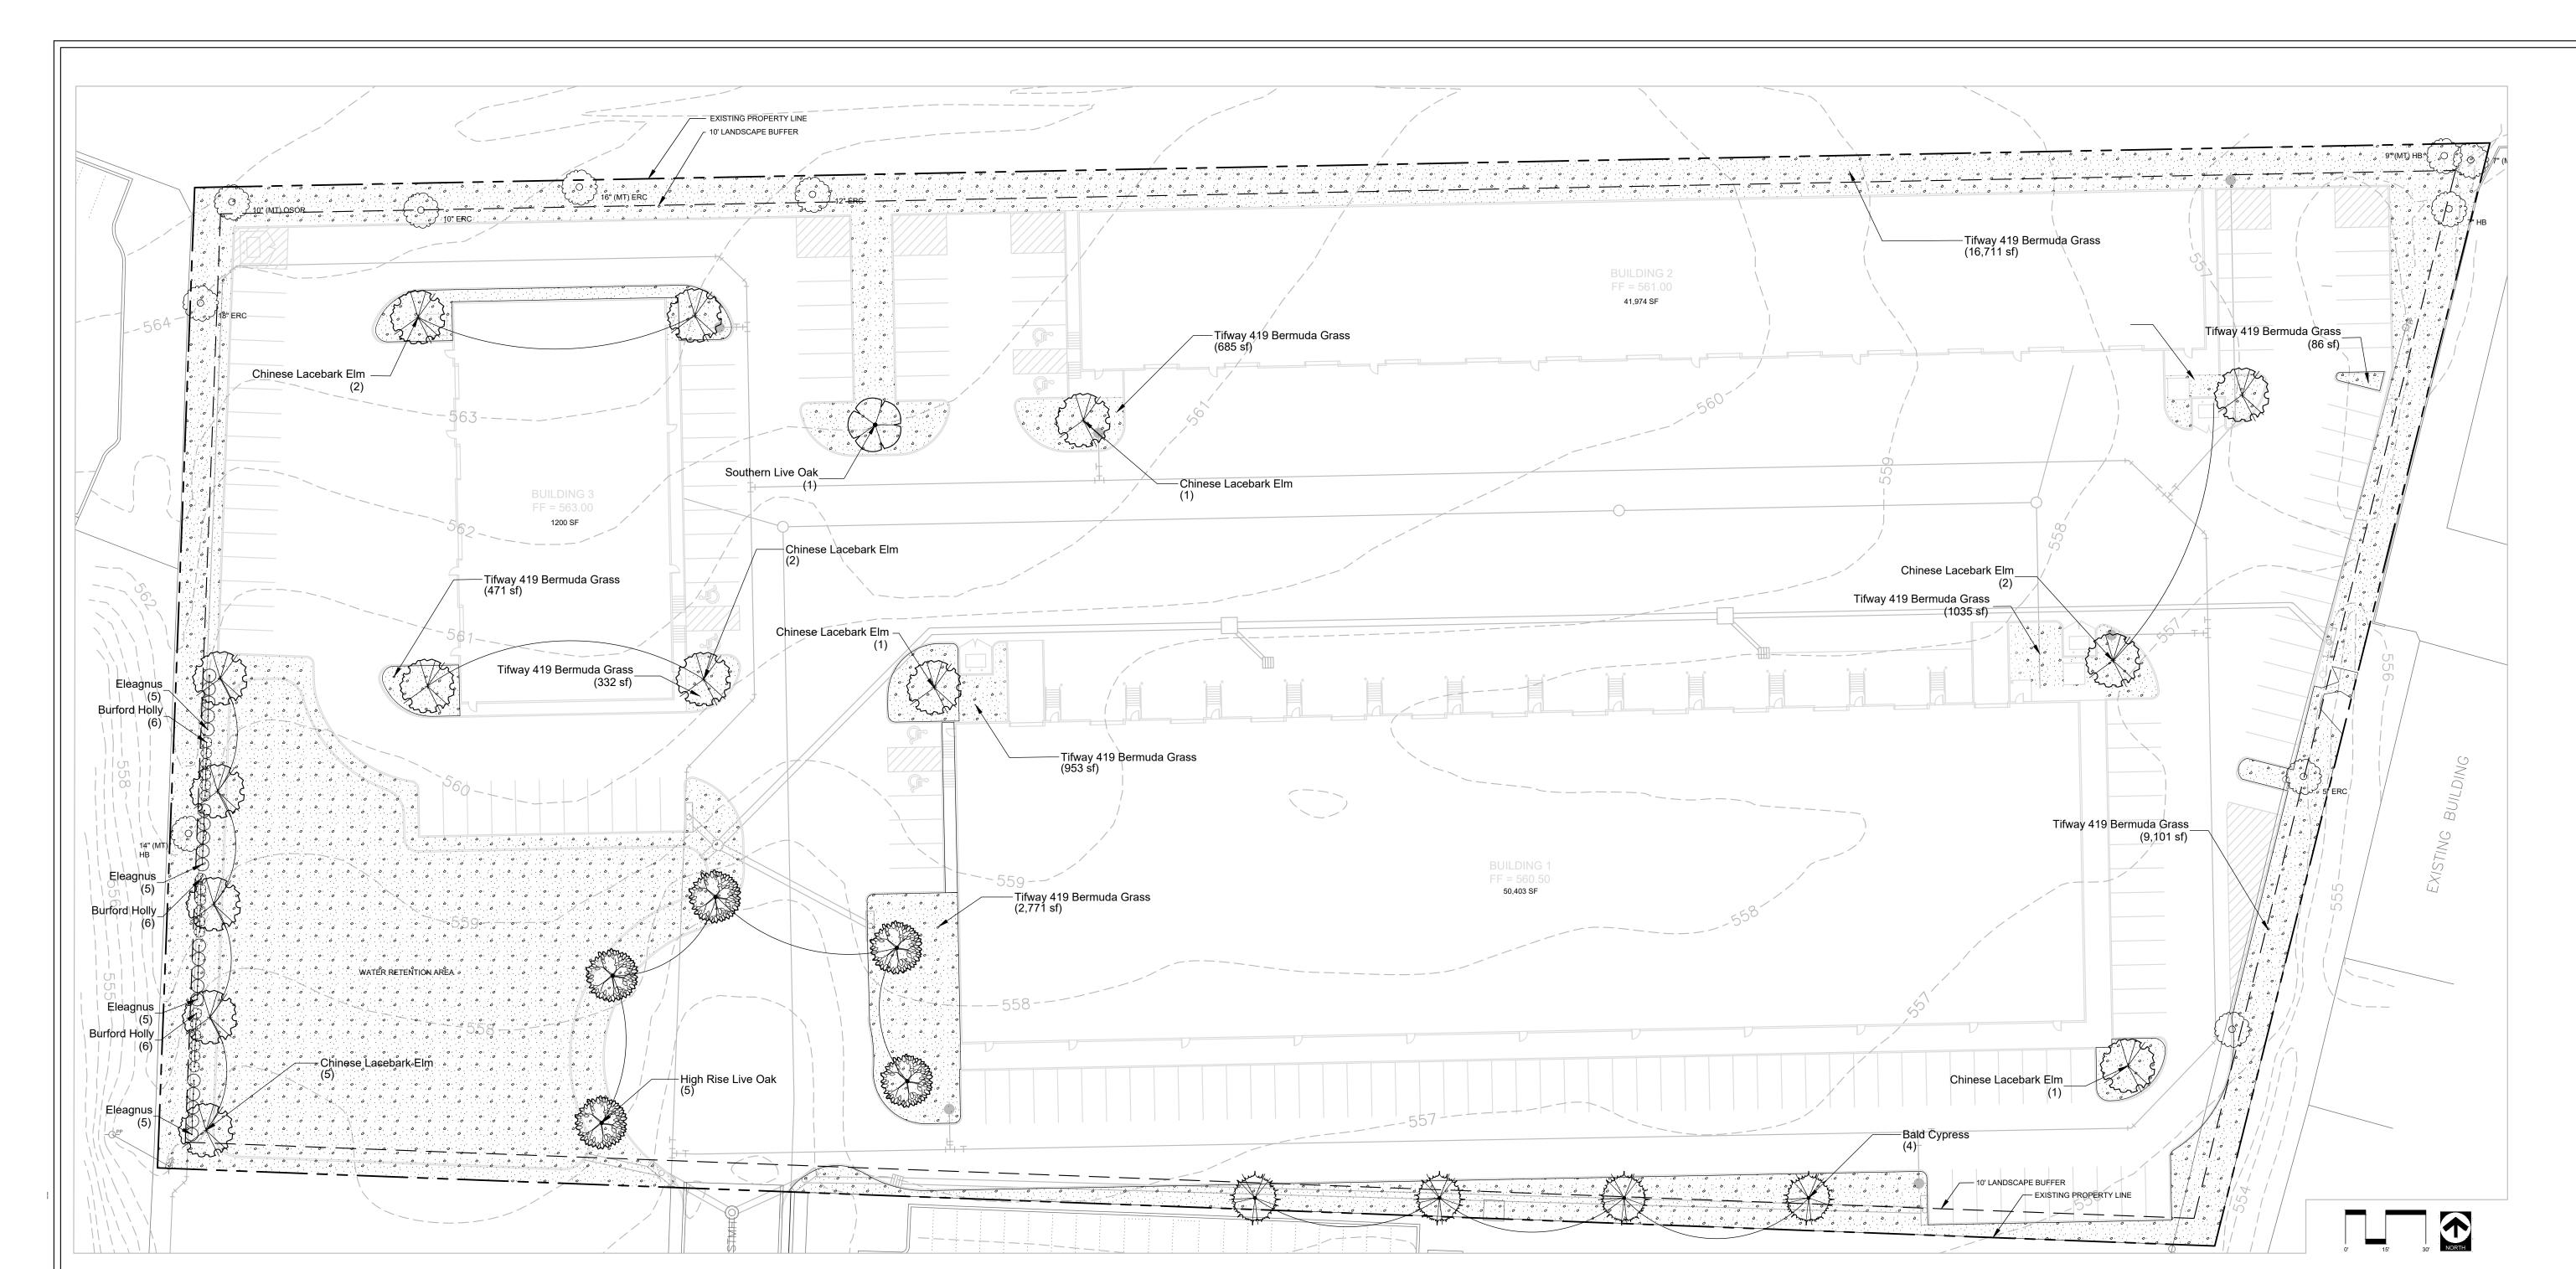

### PLANTING PLAN

rrees	BOTANICAL / COMMON NAME	CONT	CAL	HT	SPD	QTY
	Quercus virginiana / Southern Live Oak	45 gal	3" Cal	8`-10` Ht.	4`-6` Spd	1
	Quercus virginiana `High Rise` / High Rise Live Oak	45 gal	3" Cal	8`-10` Ht.	6`-7` Spd.	5
	Taxodium distichum / Bald Cypress	45 gal	3" Cal	10`-12` Ht.	4`-6` Spd	4
	Ulmus parvifolia / Chinese Lacebark Elm	45 gal	3" Cal	8`-10` Ht.	4`-6` Spd	14
SHRUBS	BOTANICAL / COMMON NAME	SIZE	CAL	HT	SPD	QTY
$\odot$	Elaeagnus x ebbingei / Eleagnus	5 gal		18"-24" Ht.	18"-24" Spd	20
$\odot$	llex cornuta `Burfordii` / Burford Holly	5 gal		18"-24" Ht.	18"-24" Spd	18
ROUND COVERS	BOTANICAL / COMMON NAME	CONT	SIZE			QTY
6 6 6 6 6	Cynodon dactylon `Tifway 419` / Tifway 419 Bermuda Grass	SOLID SOD				66,576 st

## **EXISTING TREES**

EXISTING TREE TO REMAIN

### LANDSCAPE REQUIREMENTS

REQUIRED LANDSCAPING		
REQUIRED LANDSCAPING		
ZONED LIGHT INDUSTRIAL	REQUIRED	PROVIDED
TOTAL LANDSCAPE AREA PROVIDED (%)	10% OF SITE	21% OF SITE
TOTAL LANDSCAPE AREA PROVIDED (SF)	31,598 SF	66,576 SF
TREE MITIGATION		
	REQUIRED	PROVIDED
MITIGATION REQUIREMENTS (inches)	59" CALIPER*	60" CALIPER
* See Sheet L 1.01 for calculations		
PARKING LOT LANDSCAPING		
17111111110 1201 12 11 12007 11 1110	1	
TAINGING LOT BRIDGON INC	REQUIRED	PROVIDED
200 SF MIN/ 2 ROWS OR MORE	REQUIRED	PROVIDED   √
	REQUIRED 600 SF	,
200 SF MIN/ 2 ROWS OR MORE	,	√ 
200 SF MIN/ 2 ROWS OR MORE 3 AREAS 200 FT/SQ X 3	,	√ 
200 SF MIN/ 2 ROWS OR MORE 3 AREAS 200 FT/SQ X 3 ONE TREE WITHIN 80' OF REQ. PARKING	,	\frac{1}{}
200 SF MIN/ 2 ROWS OR MORE 3 AREAS 200 FT/SQ X 3 ONE TREE WITHIN 80' OF REQ. PARKING PERMIABLE LANDSCAPE PROVIDED	,	\frac{1}{}
200 SF MIN/ 2 ROWS OR MORE 3 AREAS 200 FT/SQ X 3 ONE TREE WITHIN 80' OF REQ. PARKING PERMIABLE LANDSCAPE PROVIDED	600 SF	√ √ √ 3,756 SF

REQUIRED PROVIDED

STREET TREES

1 TREE /50' FRONTAGE

### PLANTING NOTES

LANDSCAPE CONTRACTOR SHALL BE RESPONSIBLE FOR VERIFYING THE CORRECT LOCATION OF ALL UNDERGROUND UTILITIES, PIPES, STRUCTURES, AND LINE RUNS IN THE FIELD PRIOR TO THE INSTALLATION OF ANY PLANT MATERIALS.

REFER TO PLANTING PLAN FOR PlaNTING LOCATION AND PLANT MATERIAL LEGEND FOR SPECIFICATIONS. PLANT MATERIAL LOCATION TO BE STAKED IN THE FIELD AND APPROVED BY LANDSCAPE ARCHITECT PRIOR TO PLANTING.

LANDSCAPE CONTRACTOR SHALL BE RESPONSIBLE FOR ANY COORDINATION WITH OTHER CONTRACTORS ON SITE AS REQUIRED TO ACCOMPLISH ALL PLANTING OPERATIONS.

LANDSCAPE CONTRACTOR SHALL BE RESPONSIBLE FOR MAINTAINING ALL PLANTING BEDS IN A WEED AND DEBRIS FREE CONDITION AND SHALL ACCOMPLISH WATERING BY HAND AS DEEMED NECESSARY UNTIL SUBSTANTIAL

30 DAYS AFTER SUBSTANTIAL COMPLETION AND ACCEPTANCE. LANDSCAPE CONTRACTOR SHALL BE RESPONSIBLE FOR ALL QUANTITIES PER DRAWINGS AND SPECIFICATION BY IANDSCAPE ARCHITECT. PLANT QUANTITIES HAVE BEEN PROVIDED AS A CONVENIENCE ONLY AND SHALL NOT BE CONSIDERED ABSOLUTE. LANDSCAPE ARCHITECT TO BE NOTIFIED IF DISCREPANCIES OCCUR. OTHERWISE, THE

COMPLETION AND ACCEPTANCE BY THE OWNER. THE CONTRACTOR SHALL MAINTAIN ALL WORK FOR A PERIOD OF

ALL BED AREAS ARE TO BE FLUSH WITH FINISHED GRADE AT ADJACENT PAVEMENT. ALL BED AREAS SHALL BE ROTOTILLED TO BE A DEPTH OF 6", ADDING PREPARED SOIL MIXTURE AS REQUIRED.


CONTRACTOR IS TO BID THEIR OWN VERIFIED QUANTITIES PER LANDSCAPE PLAN.

MULCH
AFTER SETTLEMENT, ALL PLANTING BED MULCH DEPTHS SHALL BE A MIN. OF 3". ALL AREAS DISTURBED BY PLANTING OPERATIONS SHALL BE FINE GRADED AND REPLANTED. MULCH SHALL BE TEXAS NATIVE CEDAR

ALL PLANT MATERIAL SHALL CONFORM TO THE SIZES GIVEN IN THE PLANT LIST AND SHALL BE NURSERY GROWN IN ACCORDANCE WITH THE "AMERICAN STANDARD FOR NURSERY STOCK", LATEST EDITION. ALL PLANTING SHALL BE IN ACCORDANCE WITH STANDARD AMERICAN ASSOCIATION OF NURSERYMEN PROCEDURES AND SPECIFICATIONS.

PROTECTED TREES SHALL BE MARKED AND THE DRIP LINE OF SAID TREES SHALL BE PROTECTED PRIOR TO AND DURING ALL CONSTRUCTION, INCLUDING EARTHWORK.

IRRIGATION WILL MEET ALL TCEQ AND UDC REQUIREMENTS.

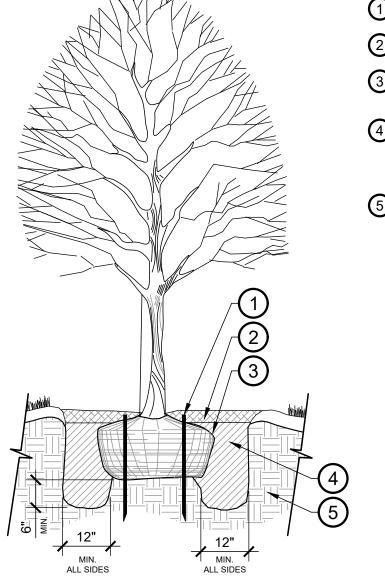

**NEW TREE PLANTING** 

NEVER CUT LEADER

(3) ARBOR STAKES. INSTALL PER MANUFACTURE'S SPECIFICATIONS

2 SPECIFIED MULCH - 3" MIN. DEPTH ENTIRE TREE BASIN 3 SET TOP OF ROOT BALL 3" ABOVE FINISH GRADE. BUILD 3" HT. SAUCER AROUND PLANTING PIT WITH TOPSOIL.

4 LIVING EARTH PLANTING MIX OR APPROVED EQUAL BY LANDSCAPE ARCHITECT. WATER AND TAMP TO REMOVE SIDE AND BOTTOM AIR POCKETS 6" MIN.

5 UNCOMPACTED NATIVE SOIL/UNDISTURBED SUBGRADE

FOR BALL & BURLAP REMOVE WIRE/TWINE FROM AROUND BURLAP, FOLD TOP THIRD DOWN OR CUT/REMOVE PRIOR TO BACKFILL.

> Project No.: 35989 Issued: Drawn By: CAP Checked By: MAW AS SHOWN Scale:

LANDSCAPE PLAN


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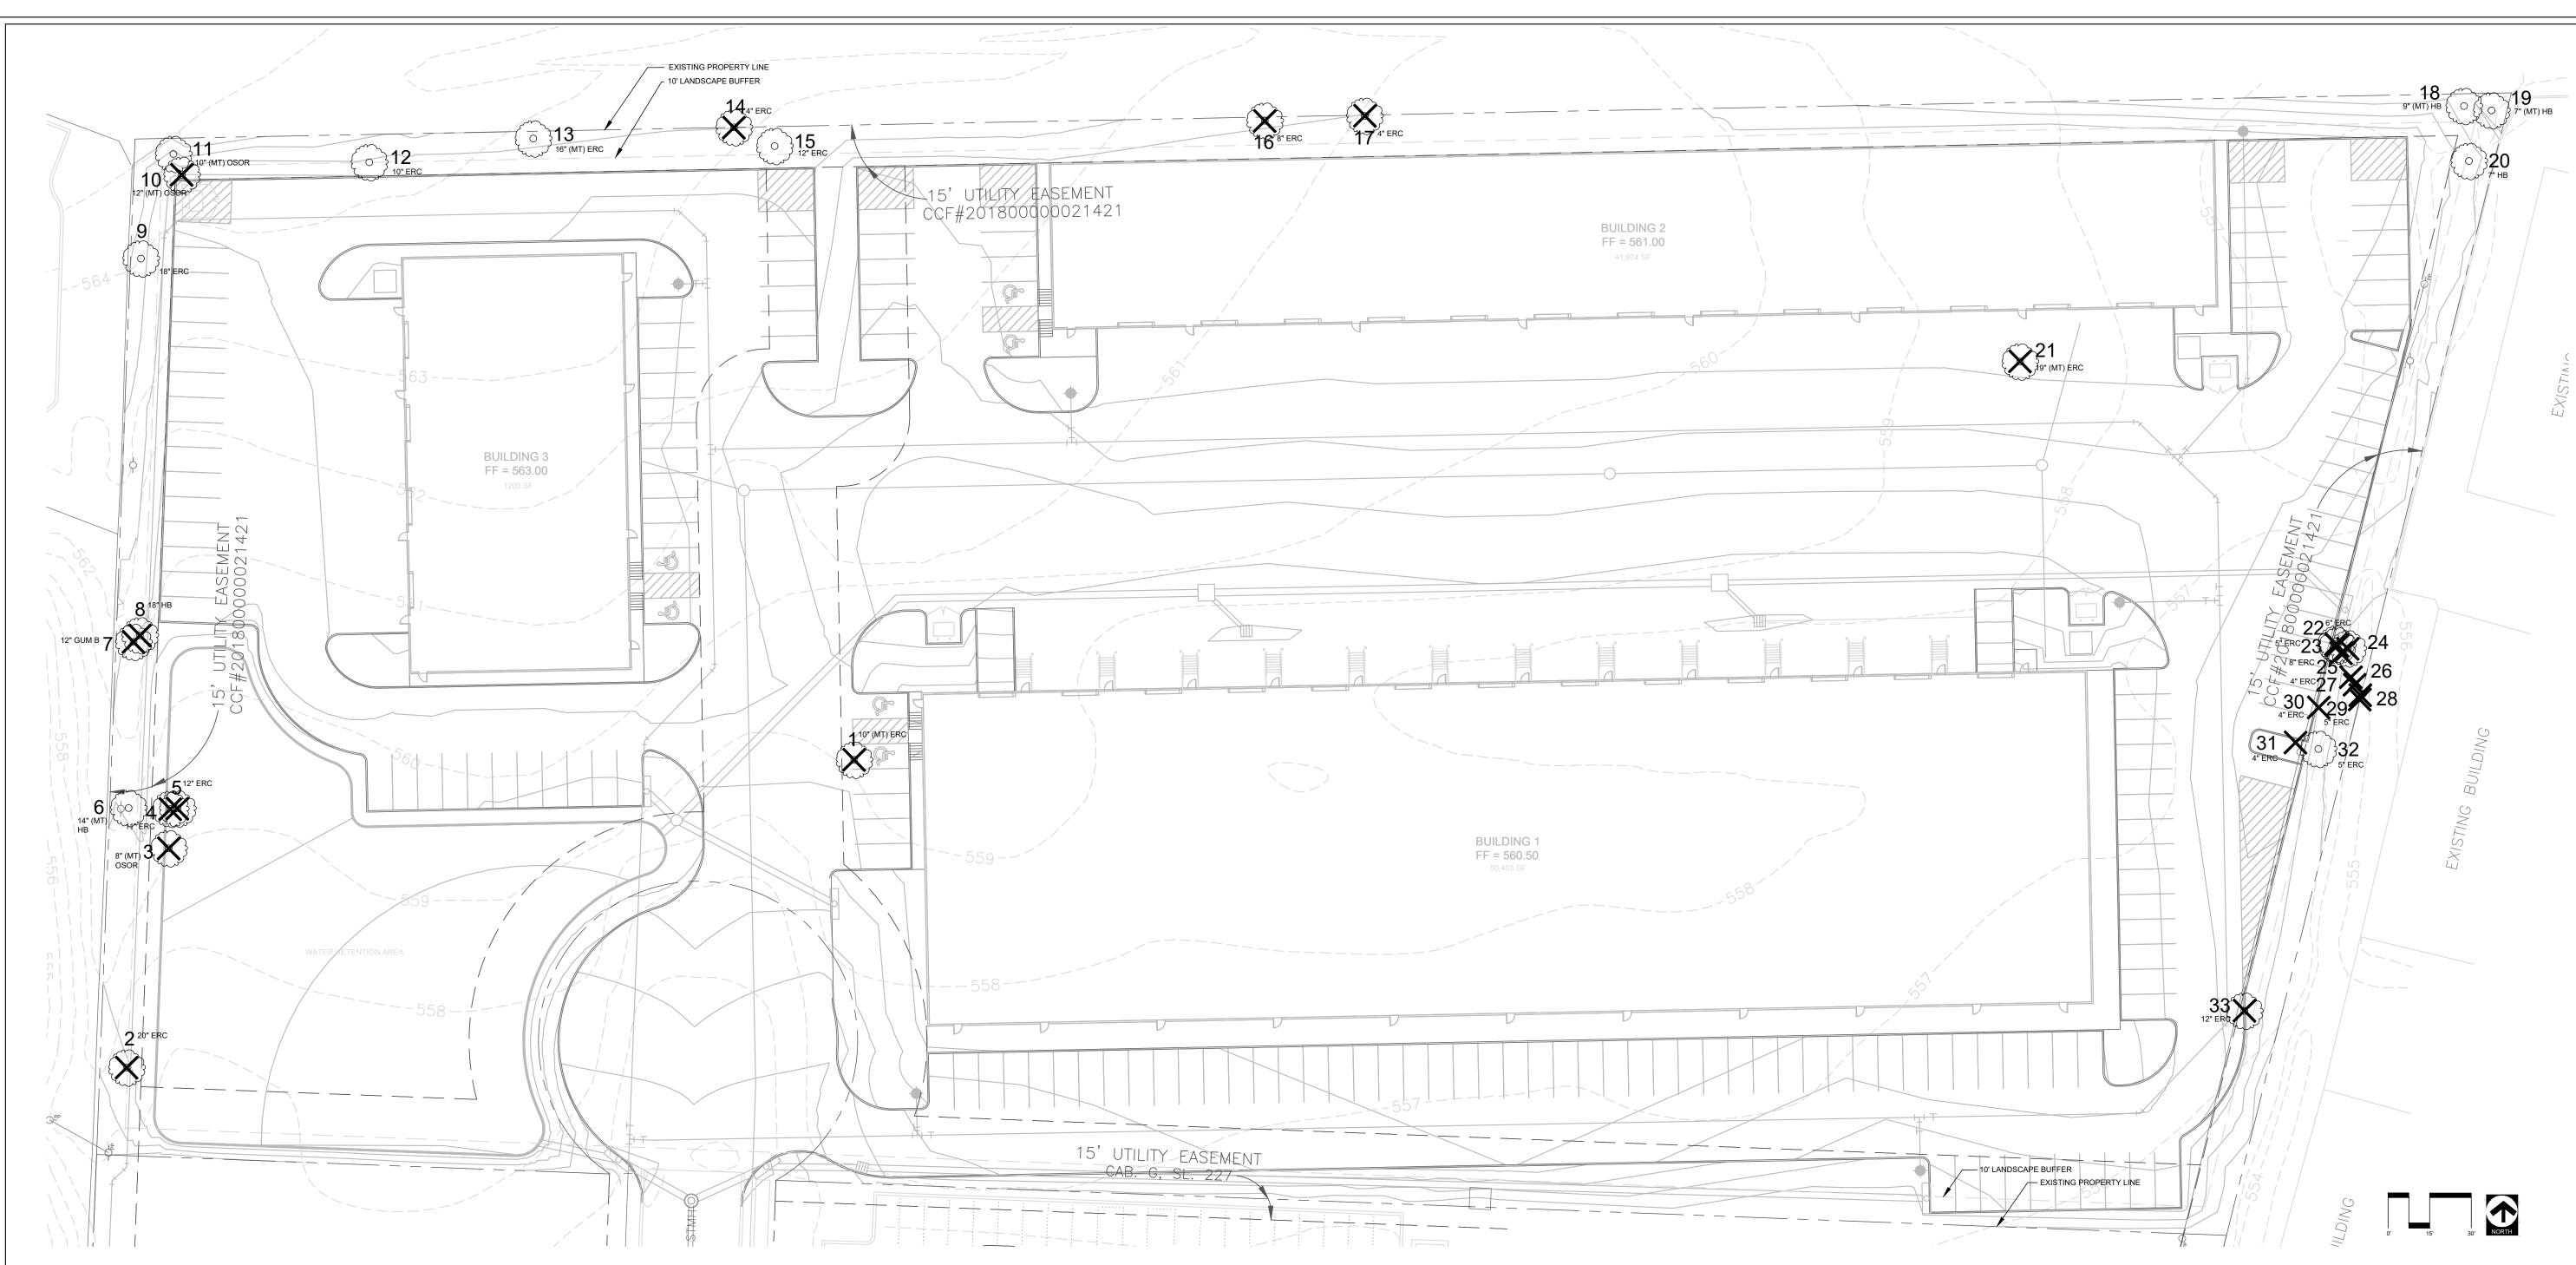
SHEET SIZE: 24" x 36" | Sheet Number

Sheet Title

<u>l</u>nd

Rockwall



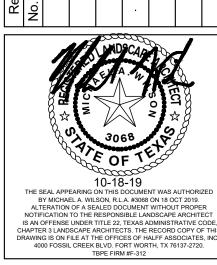

### TREE INVENTORY / MITIGATION

TREE #	SPECIES	SIZE (inches)	CLASSIFICATION	STATUS	REQ. MITIGATION (Inches
1	EASTERN RED CEDAR	10 MULTI-TK	NON-PROTECTED	REMOVE	
2	EASTERN RED CEDAR	20	SECONDARY	REMOVE	10
3	OSAGE ORANGE	8 MULTI-TK	NON-PROTECTED	REMOVE	
4	EASTERN RED CEDAR	11	SECONDARY	REMOVE	6
5	EASTERN RED CEDAR	12	SECONDARY	REMOVE	6
6	HACKBERRY	14 MULTI-TK	SECONDARY	PRESERVE	
7	GUM BUMILIA	12	PROTECTED	REMOVE	12
8	HACKBERRY	18	SECONDARY	REMOVE	9
9	EASTERN RED CEDAR	18	SECONDARY	PRESERVE	
10	OSAGE ORANGE	12 MULTI-TK	NON-PROTECTED	REMOVE	
11	OSAGE ORANGE	10 MULTI-TK	NON-PROTECTED	PRESERVE	
12	EASTERN RED CEDAR	10	SECONDARY	PRESERVE	
13	EASTERN RED CEDAR	16 MULTI-TK	SECONDARY	PRESERVE	
14	EASTERN RED CEDAR	4	NON-PROTECTED	REMOVE	
15	EASTERN RED CEDAR	12	SECONDARY	PRESERVE	
16	EASTERN RED CEDAR	8	NON-PROTECTED	REMOVE	
17	EASTERN RED CEDAR	4	NON-PROTECTED	REMOVE	
18	HACKBERRY	9 MULTI-TK	NON-PROTECTED	PRESERVE	
19	HACKBERRY	7 MULTI-TK	NON-PROTECTED	PRESERVE	
20	HACKBERRY	7	NON-PROTECTED	PRESERVE	
21	EASTERN RED CEDAR	19 MULTI-TK	SECONDARY	REMOVE	10
22	EASTERN RED CEDAR	6	NON-PROTECTED	REMOVE	
23	EASTERN RED CEDAR	5	NON-PROTECTED	REMOVE	
24	EASTERN RED CEDAR	5	NON-PROTECTED	REMOVE	
25	EASTERN RED CEDAR	8	NON-PROTECTED	REMOVE	
26	EASTERN RED CEDAR	6	NON-PROTECTED	REMOVE	
27	EASTERN RED CEDAR	5	NON-PROTECTED	REMOVE	
28	EASTERN RED CEDAR	5	NON-PROTECTED	REMOVE	
29	EASTERN RED CEDAR	5	NON-PROTECTED	REMOVE	
30	EASTERN RED CEDAR	4	NON-PROTECTED	REMOVE	
31	EASTERN RED CEDAR	4	NON-PROTECTED	REMOVE	
32	EASTERN RED CEDAR	5	NON-PROTECTED	PRESERVE	
33	EASTERN RED CEDAR	12	SECONDARY	REMOVE	6
ΤΩΤΛΙ					50

# **EXISTING TREES**



EXISTING TREE TO REMAIN




EXISTING TREE TO BE REMOVED

## LANDSCAPE REQUIREMENTS

TREE MITIGATION	
REQUIRED TREES (inches)	59" CALIPER
PROVIDED TREES (inches)	60" CALIPER
* See Sheet L 2.01 for Planting Locations	

### PLAN VIEW

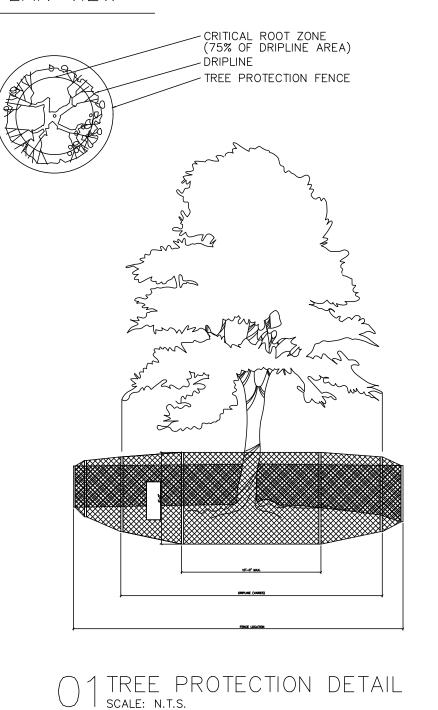

### STANDARD PRESERVATION NOTES FOR TREE AND NATURAL AREA PROTECTION

- All trees and natural areas shown on plan to be preserved shall be protected during construction with temporary fencing and other measures as needed which may include retaining walls, pruning of limbs, roots, etc.
   Protective fences shall be erected according to City Standards for Tree Protection.
   Protective fences shall be installed prior to the start of any site preparation work (clearing, grubbing or grading), and shall be maintained throughout all phases of the construction project.
- 4. Erosion and sedimentation control barriers shall be installed or maintained in a manner which does not result in
- soil build-up within tree drip lines. 5. Protective fences shall surround the trees or group of trees, and will be located no closer than the outermost limit of branches (drip line) plus an additional 2'-0" away from the limits of dripline. For natural areas, protective fences shall follow the Limit of Construction line, in order to prevent the following:

  A. Soil compaction in the root zone area resulting from vehicular traffic or storage of equipment or materials;

  B. Root zone disturbances due to grade changes (greater than 6 inches cut or fill), or trenching not reviewed and authorized by the City Parks Department;

  C. Wounds to exposed roots, trunk or limbs by mechanical equipment;

  D. Other activities detrimental to trees such as chemical storage cement truck cleaning, and fires
- D. Other activities detrimental to trees such as chemical storage, cement truck cleaning, and fires.
  6. Exceptions to installing fences at tree drip lines may be permitted in the following cases:

Arborist to discuss alternatives.


- A. Where there is to be an approved grade change, impermeable paving surface, tree well, or other such site development, erect the fence approximately 2 to 4 feet beyond the area disturbed;
- B. Where permeable paving is to be installed within a tree's drip line, erect the fence at the outer limits of the permeable paving area (prior to site grading so that this area is graded separately by hand prior to paving installation to minimized root damage);


  C. Where trees are close to proposed buildings, erect the fence to allow root pruning in the work space between the fence and the building, prior to disturbance. The fence can be erected at the point of root pruning;

  D. Where there are severe space constraints due to tract size, or other special requirements, contact an
- Special Note: Exceptions are permitted for areas outside the critical root zone. No disturbances are permitted within the critical root zone (75% of the dripline area). For the protection of natural areas, no exceptions to installing fences at the Limit`of Construction line will be permitted, and no silting of stock piling of material or dirt is
- allowed around trees.
- Where any of the above exceptions result in a fence being closer than 4 feet to a tree trunk, protect the trunk with strapped—on planking to a height of 8 ft. in addition to the reduced fencing provided.

  Trees approved for removal shall be removed in a manner which does not impact trees to be preserved.
- 8. Trees approved for removal shall be removed in a manner which does not impact trees to be preserved.
   9. Any roots exposed by construction activity shall be pruned flush with the soil. Backfill root areas with good quality top soil as soon as possible. If exposed root areas are not backfilled within 2 days, cover them with organic material in a manner which reduces soil temperature and minimizes water loss due to evaporation.
   10. Trenching required for the installation of irrigation shall be placed as far from existing tree trunks as possible.
   11. No landscape topsoil dressing greater than 2 inches shall be permitted within the drip line of trees. No soil or mulch is permitted on the root flare of any tree.
   12. Limbing & pruning to provide clearance for structures, traffic and equipment shall take place before damage occurs.
   13. All finished pruning shall be done according to recognized, approved standards of the industry (Reference the National Arborist Association Pruning Standards for Shade Trees).

Rockwall

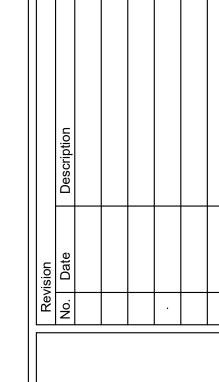

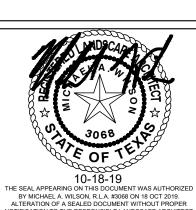


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Janaca
10-18-19
THE SEAL APPEARING ON THIS DOCUMENT WAS AUTHORIZED
BY MICHAEL A. WILSON, R.L.A. #3068 ON 18 OCT 2019.
ALTERATION OF A SEALED DOCUMENT WITHOUT PROPER
NOTIFICATION TO THE RESPONSIBLE LANDSCAPE ARCHITECT
IS AN OFFENSE UNDER TITLE 22, TEXAS ADMINISTRATIVE CODE
CHAPTER 3 LANDSCAPE ARCHITECTS. THE RECORD COPY OF THI
RAWING IS ON FILE AT THE OFFICES OF HALFF ASSOCIATES, INC
4000 FOSSIL CREEK BLVD. FORT WORTH, TX 76137-2720.
TBPE FIRM #F-312

Project No.: 35989 Issued: 10-18-19 Drawn By: CAP Checked By: MAW Scale: AS SHOWN

Sheet Title TREESCAPE PLAN

L 1.01

SHEET SIZE: 24" x 36" | Sheet Number

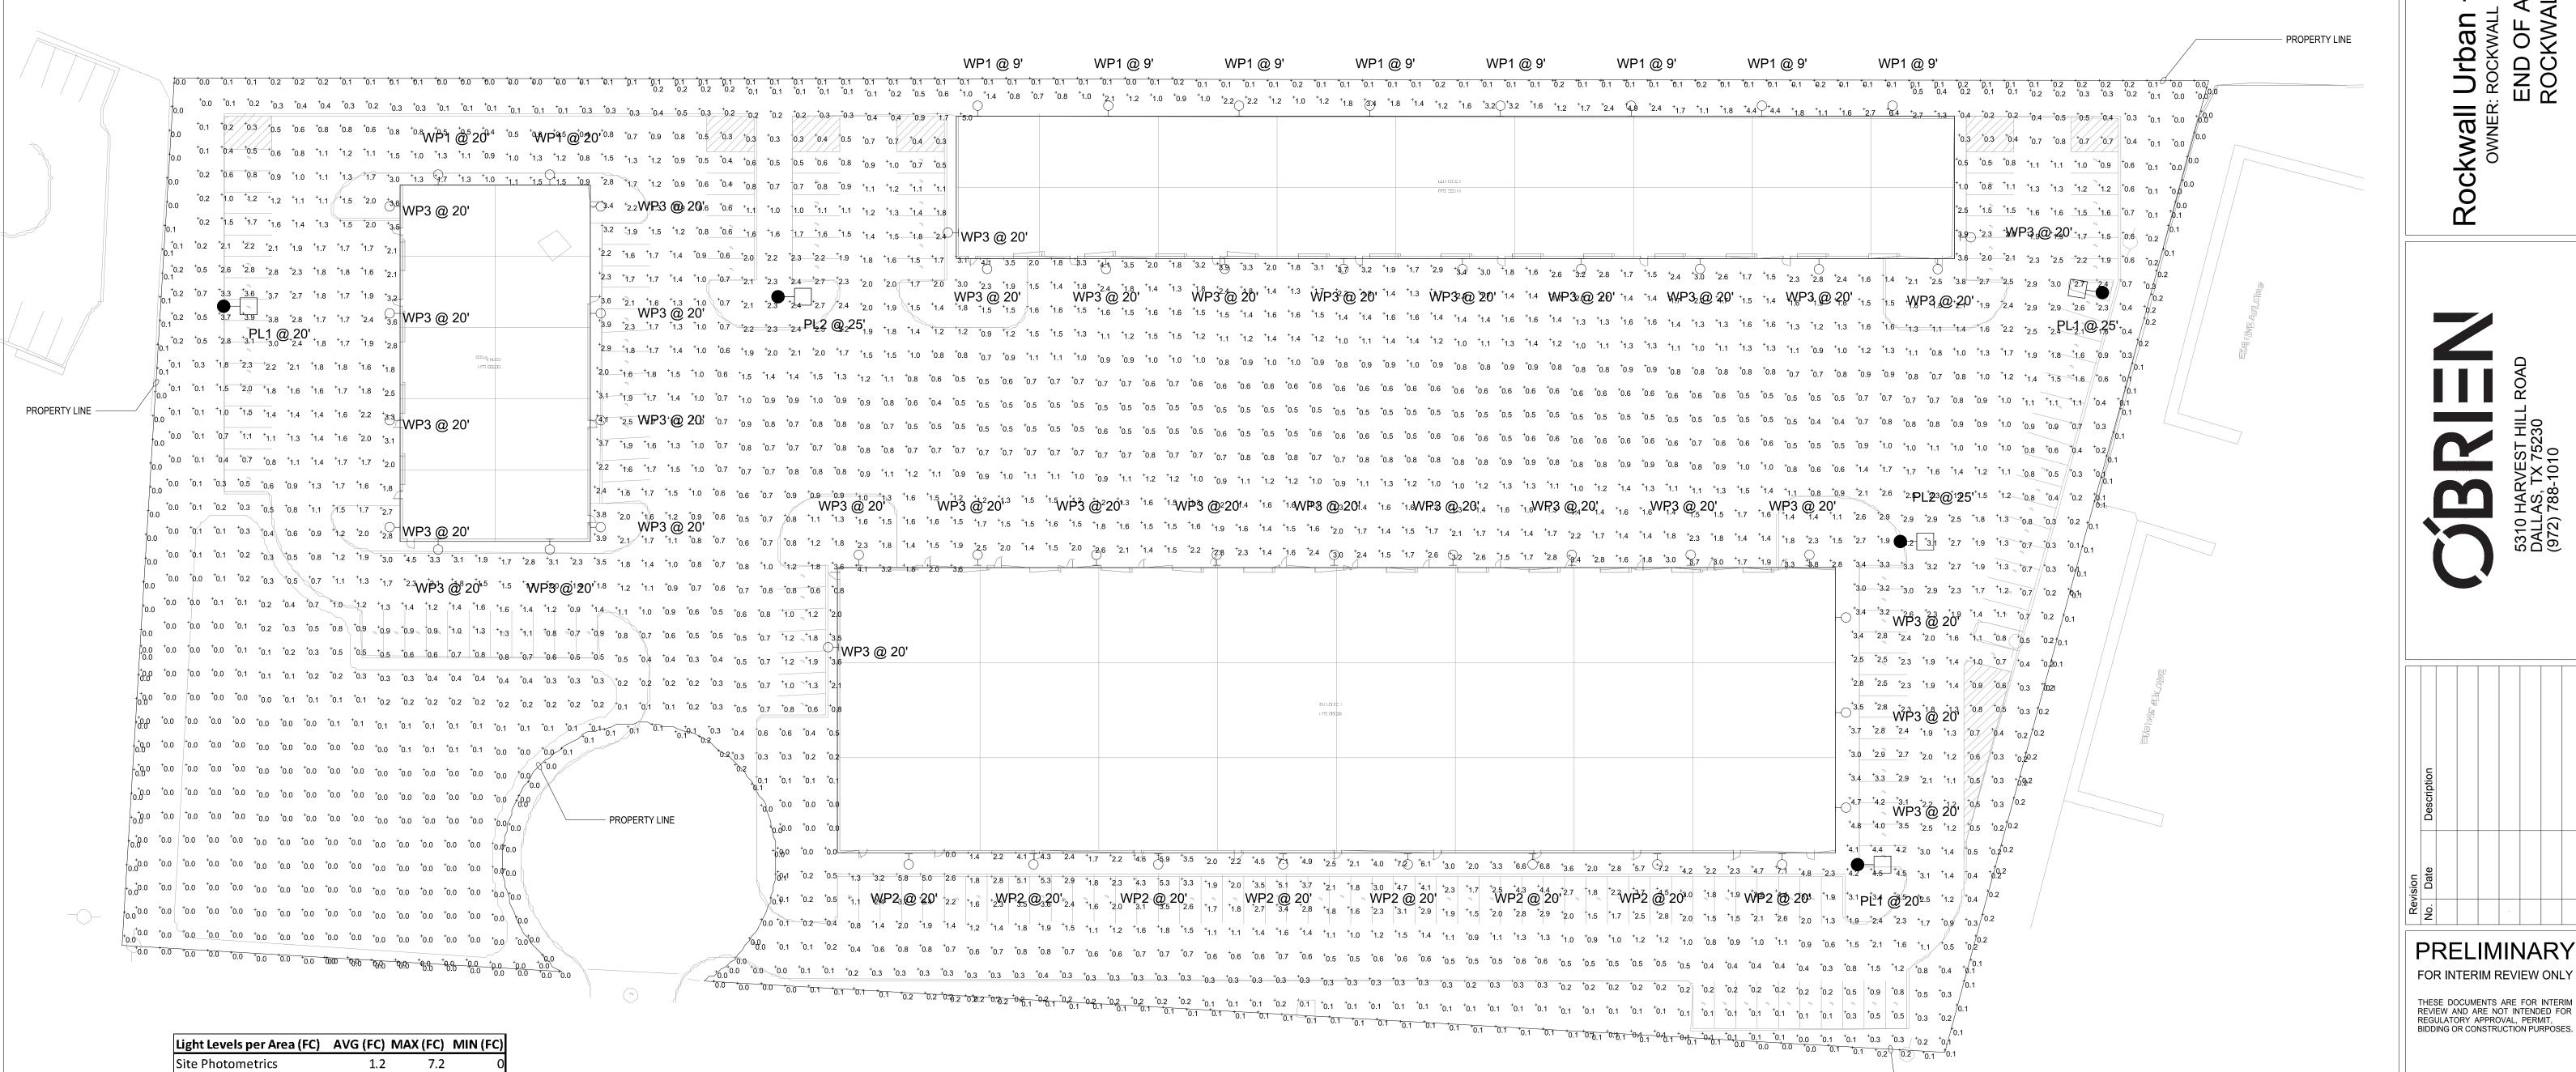

0.2

Description

WSR LED WITH P1-PERFORMANCE PACKAGE, 4000K, AND SR2 OPTIC TYPE WST LED Performance package 3 4000 K, visual comfort forward throw, MVOLT

WSR LED WITH P4-PERFORMANCE PACKAGE, 4000K, AND SR4 OPTIC TYPE

DSX0 LED P5 40K T2M MVOLT with houseside shield

DSX0 LED P6 40K T5M MVOLT with houseside shield

Lamp Lamp Lumens Watts

6609

6388

9550

11955

50

61

89

134

0.1

Along Property Line

Catalog Number

WSR LED P1 SR2 40K MVOLT

WST LED P3 40K VF MVOLT

WP3 WSR LED P4 SR4 40K MVOLT

PL1 DSX0 LED P5 40K T2M MVOLT HS

PL2 DSX0 LED P6 40K T5M MVOLT HS

SITE PHOTOMETRICS SCALE: 1/32" = 1'-0"



- PROPERTY LINE

17855 North Dallas Parkway • Suite 320 Dallas, TX, 75287 p. 469.385.1616 • f. 469.385.1615 Texas Registered Engineering Firm F-4990 Project Number:1930681 Drawn By:DNH Checked By:JW

SHEET SIZE: 24" x 36"

Sheet Number Case Number:

Sheet Title SITE

Project No.:

Checked By:

Issued: Drawn By:

JOSHUA WILEY

OCTOBER 2019


AS SHOWN

**PHOTOMETRICS** 

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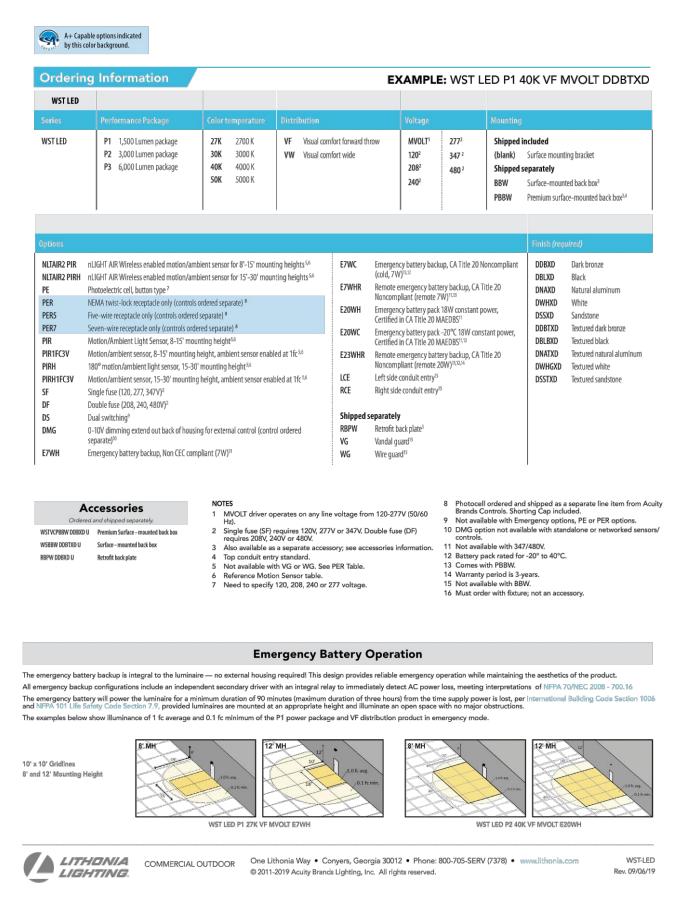
Center, LP.


Rockwall OWNER:

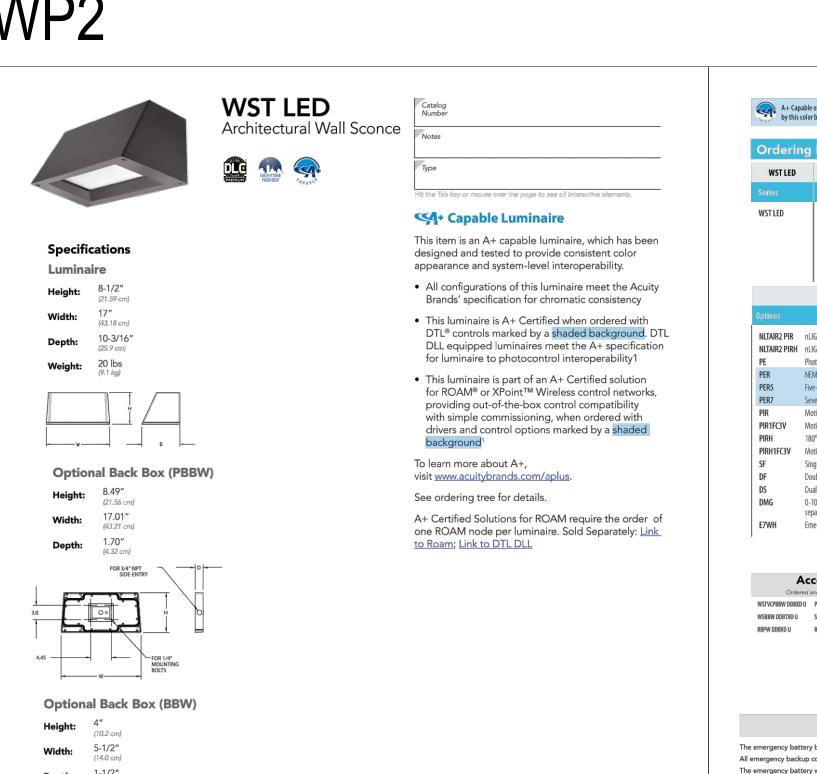


COMMERCIAL OUTDOOR


One Lithonia Way • Conyers, Georgia 30012 • Phone: 800-705-SERV (7378) • www.lithonia.com
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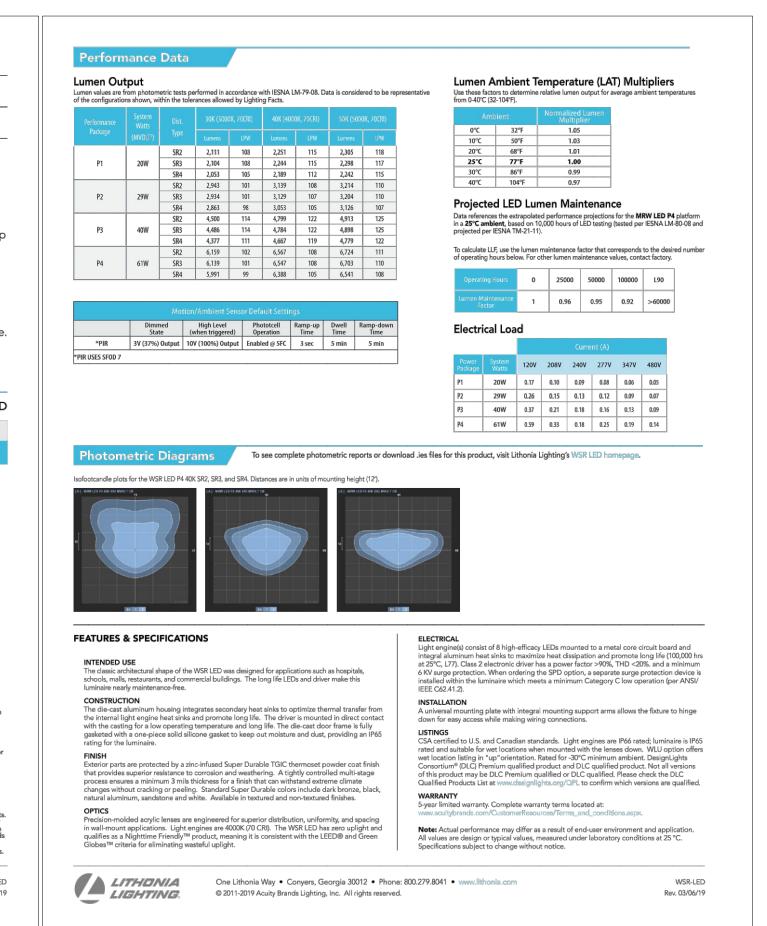




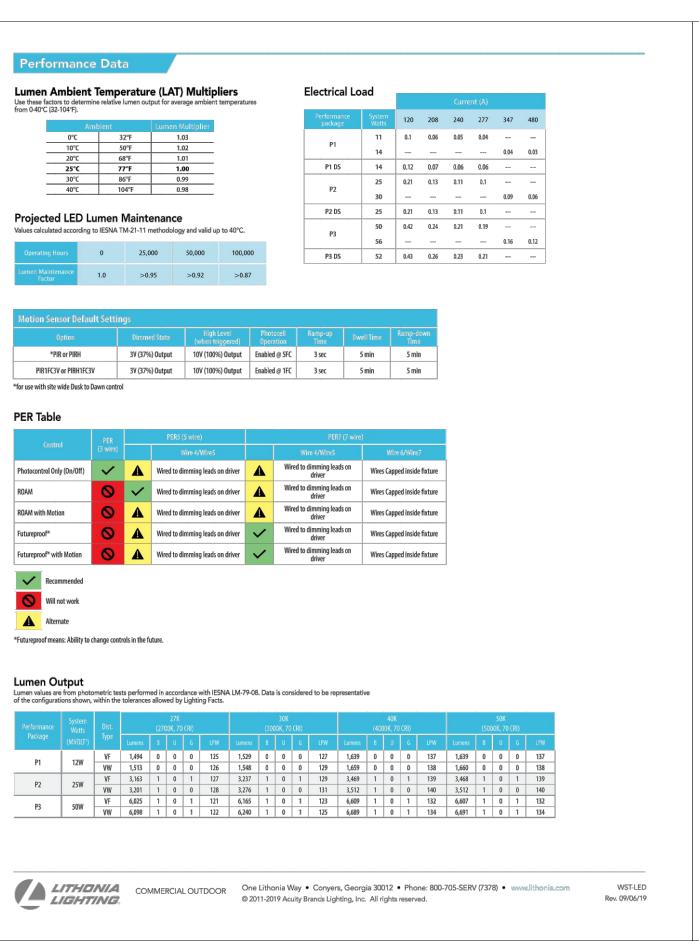

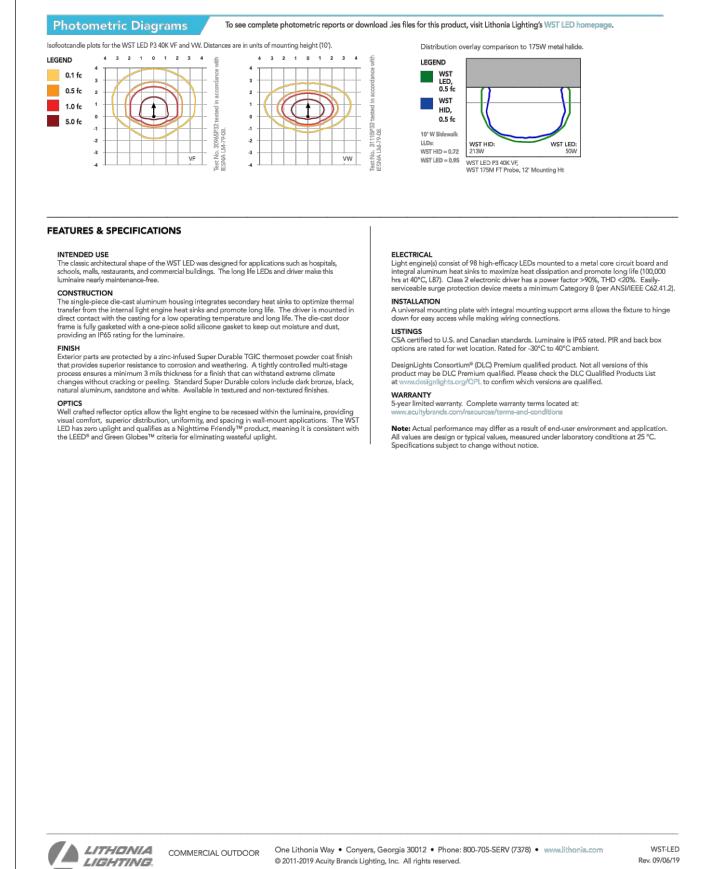Rev. 09/06/19



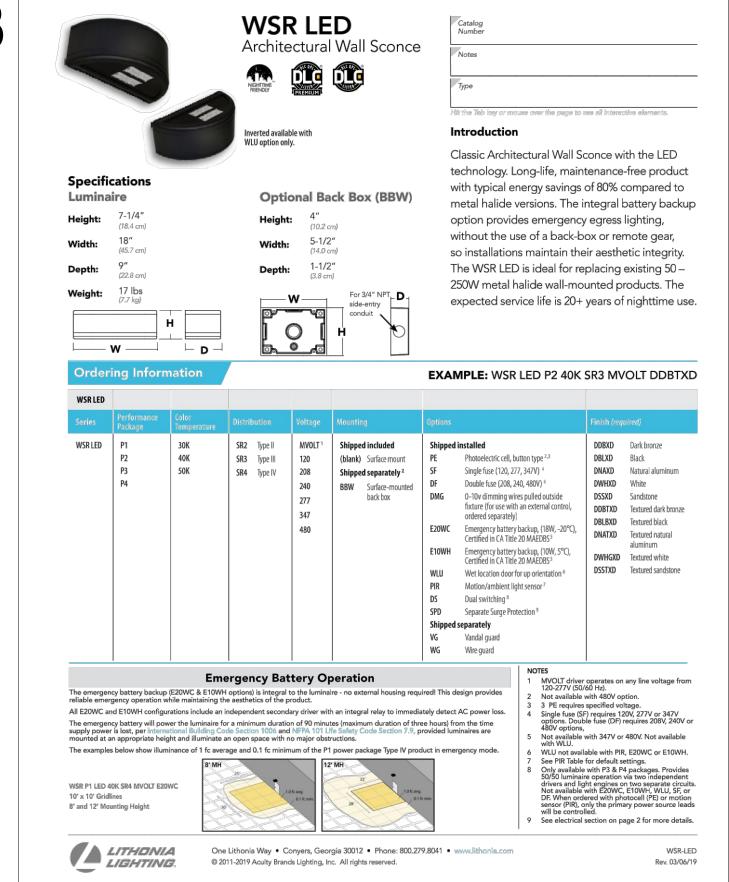



17855 North Dallas Parkway • Suite 320 Dallas, TX, 75287 p. 469.385.1616 • f. 469.385.1615 Texas Registered Engineering Firm F-4990 Project Number:1930681 Drawn By:DNH Checked By:JW

SHEET SIZE: 24" x 36"

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OCTOBER 2019 Scale: AS SHOWN Sheet Title WP1,WP2,WP3 **CUTSHEETS** 

**PRELIMINARY** 

FOR INTERIM REVIEW ONLY

THESE DOCUMENTS ARE FOR INTERIM REVIEW AND ARE NOT INTENDED FOR REGULATORY APPROVAL, PERMIT.

BIDDING OR CONSTRUCTION PURPOSES.

Sheet Number Case Number:

LITHONIA LIGHTING

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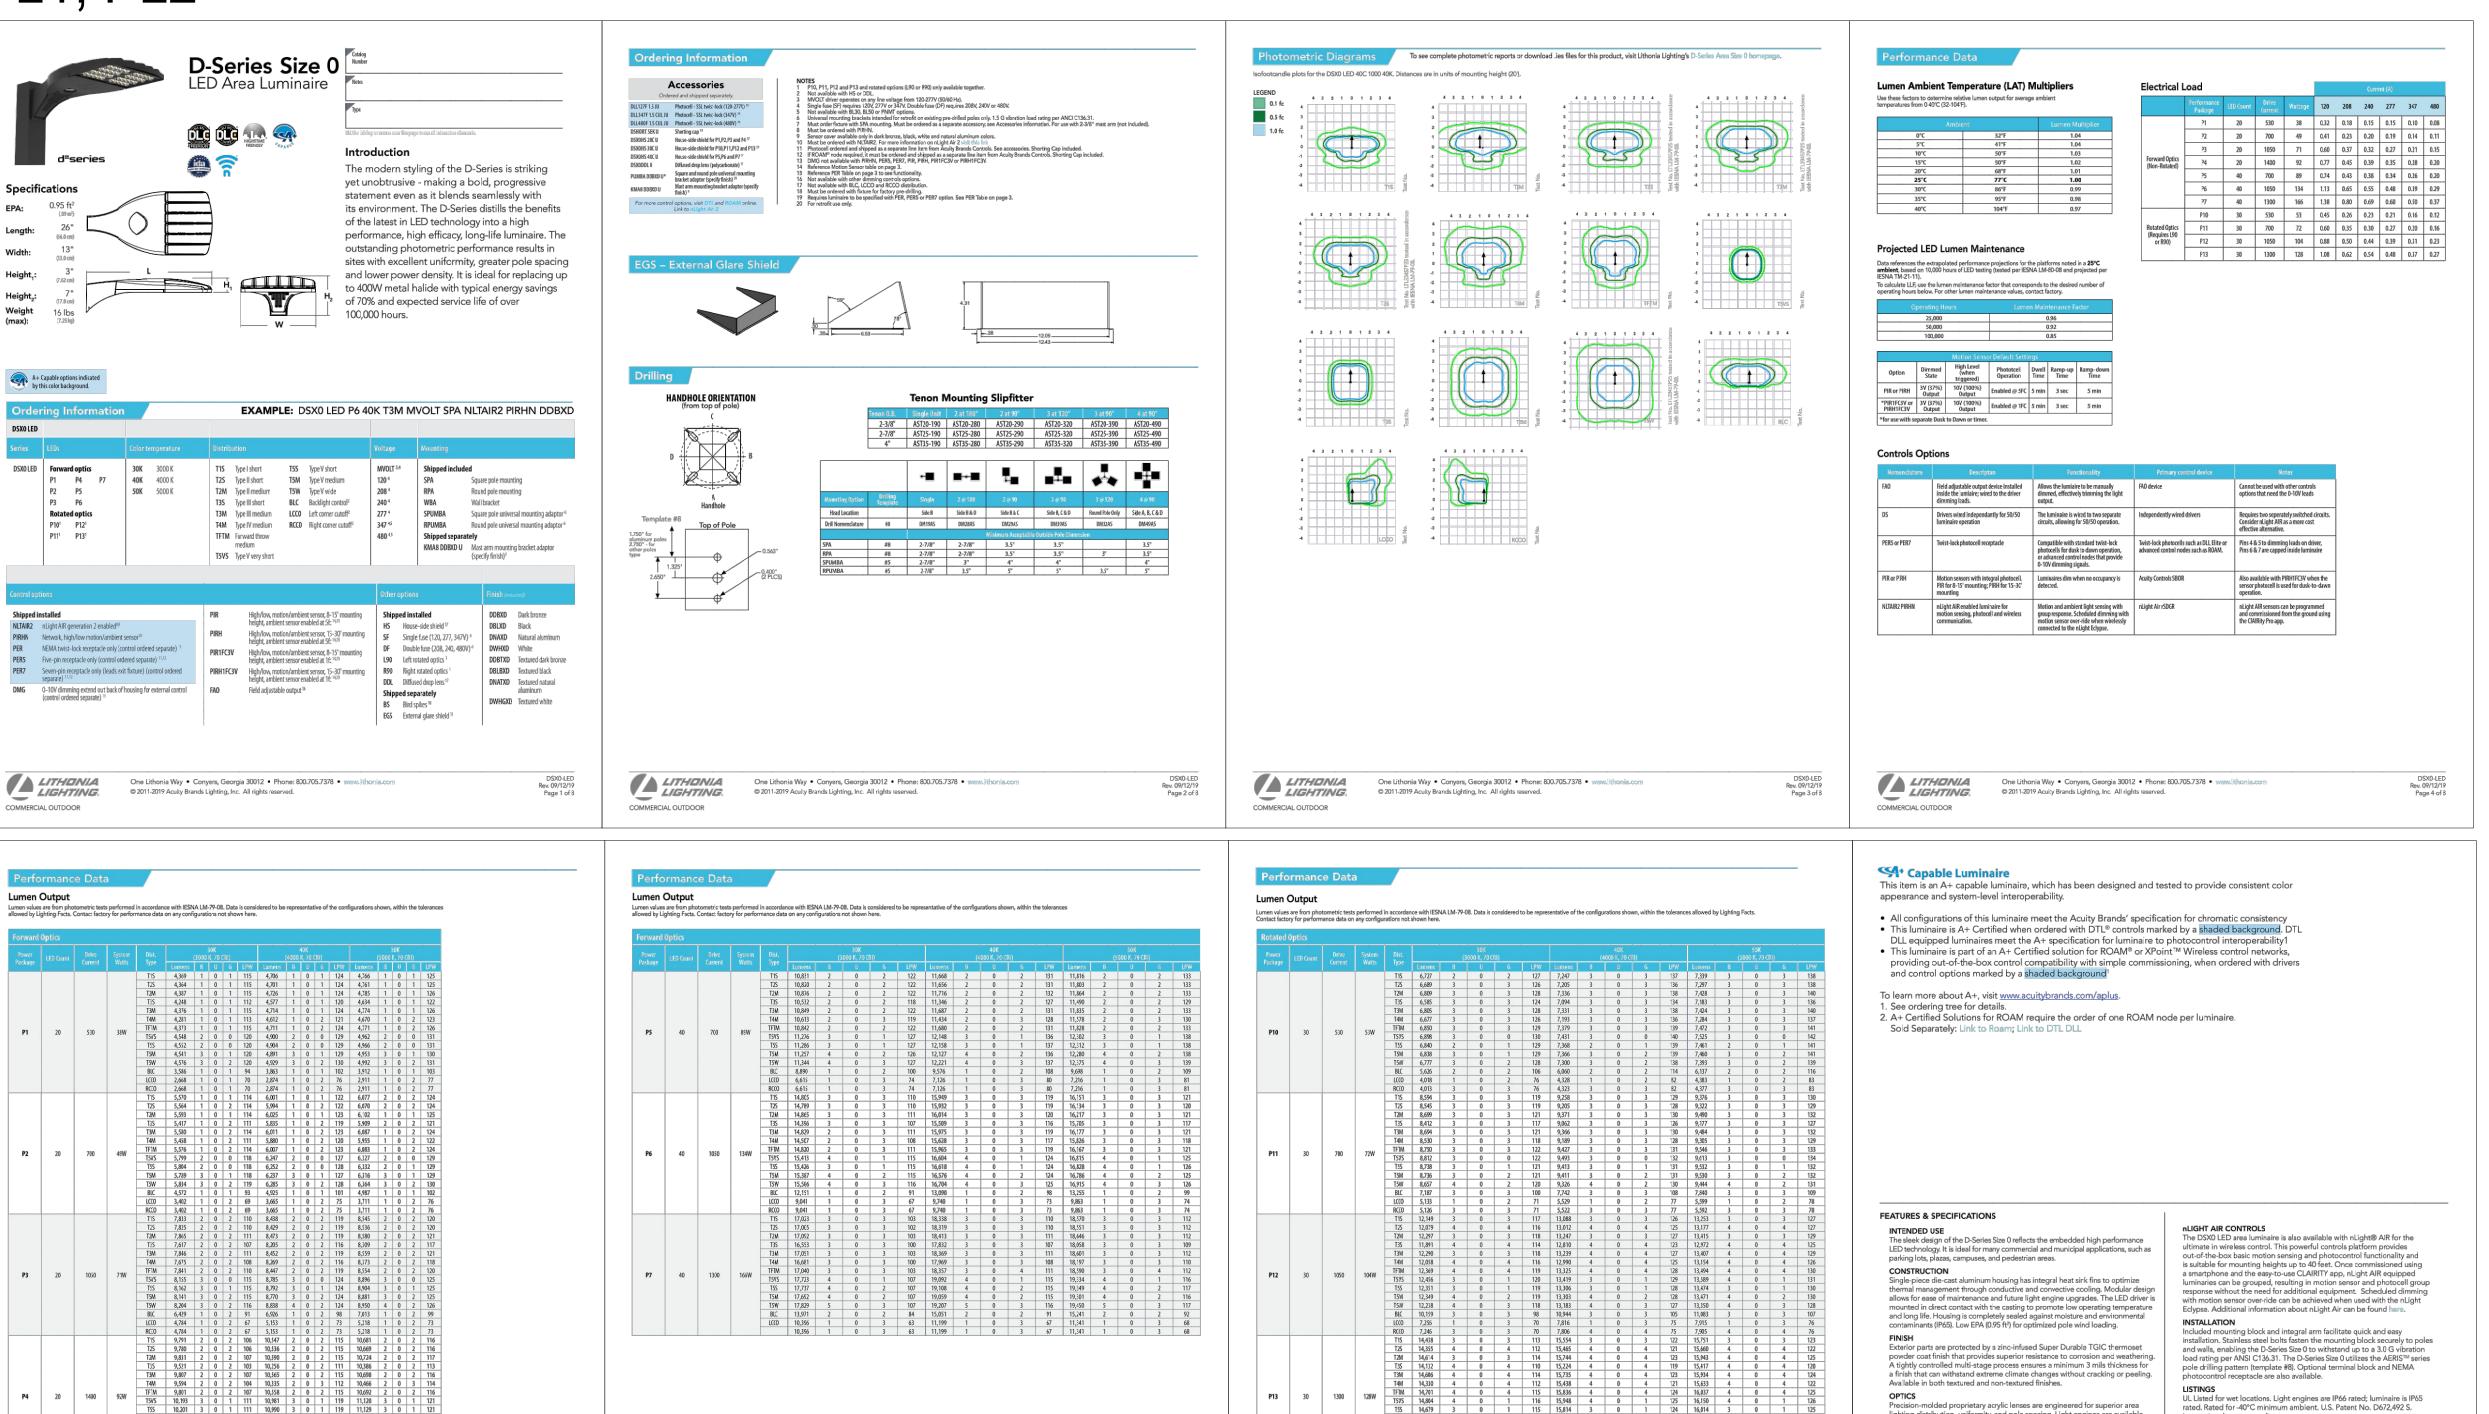
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Jordan & Skala Engineers

lighting distribution, uniformity, and pole spacing. Light engines are available in 3000 K, 4000 K or 5000 K (70 CRI) configurations. The D-Series Size 0 has zero

Light engine(s) configurations consist of high-efficacy LEDs mounted to metal-core circuit boards to maximize heat dissipation and promote long life (up to L85/100,000 hours at 25°C). Class 1 electronic drivers are designed to have a power factor >90%, THD <20%, and an expected life of 100,000 hours with <1%

failure rate. Easily serviceable 10kV surge protection device meets a minimum

controls can be utilized via optional NEMA twist-lock photocell receptacles. Integrated motion sensors with on-board photocells feature field-adjustable programing and are suitable for mounting heights up to 30 feet.

The DSX0 LED area luminaire has a number of control options. Dusk to dawn

Category C Low operation (per ANSI/IEEE C62.41.2).

uplight and qualifies as a Nighttime Friendly™ product, meaning it is consiste with the LEED® and Green Globes™ criteria for eliminating wasteful uplight.

ELECTRICAL

STANDARD CONTROLS

LITHONIA LIGHTING

COMMERCIAL OUTDOOR

esignLights Consortium® (DLC) Premium qualified product and DLC

qualified product. Not all versions of this product may be DLC Premium qualified or DLC qualified. Please check the DLC Qualified Products List at www.designlights.org/QPL to confirm which versions are qualified.

International Dark-Sky Association (IDA) Fixture Seal of Approval (FSA) is

Note: Actual performance may differ as a result of end-user environment

DSX0-LED Rev. 09/12/19 Page 8 of 3

and application.
All values are design or typical values, measured under laboratory conditions at 25 °C.

Specifications subject to change without notice.

5-year limited warranty. Complete warranty terms located at:

WARRANTY

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available for all products on this page utilizing 3000K color temperature only.

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SHEET SIZE: 24" x 36"

**Sheet Number** 

Sheet Title PL 1, PL2

**PRELIMINARY** 

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REVIEW AND ARE NOT INTENDED FOR

BIDDING OR CONSTRUCTION PURPOSES.

JOSHUA WILEY 129688

19068

OCTOBER 2019

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REGULATORY APPROVAL, PERMIT,

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Urban

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Project No.:

Checked By: Scale:

Issued: Drawn By:



October 18, 2019 AVO 35989

Korey Brooks, AICP Senior Planner Planning and Zoning City of Rockwall 385 S. Goliad St Rockwall, Texas 75087

RE: Detention Pond Slope Variance for Rockwall Urban + Industrial Center

Dear Mr. Brooks:

On behalf of Reid Caldwell and Rockwall Urban Industrial, LP we request a variance to section 3.3.4A of the City of Rockwall Standards of Design and Construction that states "Detention ponds shall have a side slope 4:1 or flatter." Based on maximizing the value of this property and the proposed site layout the detention pond will need to have retaining walls in order to meet the City of Rockwall drainage design.

We believe this variance request is reasonable because it is consistent with the developments directly around our site. The site located directly to our south at the NE Corner of Alpha Dr. and Sigma Ct. has retaining walls built as part of its detention system. If there are any questions or concerns please do not hesitate to contact me.

Sincerely,

Matthew Gardner, P.E.


Civil Engineer

mgardner@halff.com

214-346-6308

HALFF ASSOCIATES, INC.

Matthew Sandner

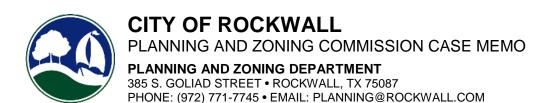

**TO:** Planning and Zoning Commission

DATE: November 12, 2019

**APPLICANT:** Matthew Gardner: *Halff Associates* 

CASE NUMBER: SP2019-040; Site Plan for Ellis Center, Phase 2 Addition

#### **SUMMARY**

Discuss and consider a request by Matthew Gardner and Halff Associates on behalf of Reid Caldwell of Rockwall Urban Industrial, LP for the approval of a site plan for a multi-tenant industrial building on a 7.02-acre parcel of land identified as Lot 1, Block D, Ellis Center Phase 2 Addition, City of Rockwall, Rockwall County, Texas, zoned Light Industrial (LI) District, situated at the terminus of Alpha Drive, and take any action necessary.

### **BACKGROUND**

The subject property was annexed on November 30, 1959 by *Ordinance No. 60-01*. The subject property was zoned -- along with the remainder of the 23.888-acre tract of land that made up Phases 1 & 2 of the Ellis Center Addition -- from an Agricultural (AG) District and Commercial (C) District to a Light Industrial (LI) District on December 5, 1983 by *Ordinance No. 83-61 (PZ1983-035-01)*. The subject property was then platted as part of Lot 2 and all of Lots 4 & 5 of the Ellis Center, Phase 2 Addition on February 15, 1985 as part of Case No. PZ1984-014-01. The subject property was later assembled into its current configuration (i.e. Lot 1, Block D, Ellis Center, Phase 2 Addition) by Case No. P2018-015.

#### **PURPOSE**

On October 18, 2019, the applicant -- *Matthew Gardner of Halff Associates* -- submitted an application requesting approval of a site plan for the purpose of developing a multi-tenant industrial site consisting of three (3) separate buildings that will be approximately 87,600 SF (*i.e.* 50,400 SF, 25,200 SF, & 12,000 SF). The proposed development is subject to the land use, density and dimensional requirements of the Light Industrial (LI) District as stipulated by the Unified Development Code (UDC).

#### ADJACENT LAND USES AND ACCESS

The subject property is located north of the intersection of Alpha Drive and Sigma Court. The land uses adjacent to the subject property are as follows:

North: Directly north of the property is an un-platted 71.022-acre tract of land that is vacant (i.e. Tract 20-1 of the A. Hanna Survey, Abstract No. 99), which is zoned Light Industrial (LI) District. Beyond this property is Justin Road, which is identified as a M4D (i.e. major collector, four [4] lane, divided roadway) on the City's Master Thoroughfare Plan.

<u>South</u>: Directly south of the subject property is the continuation of Phases 1 & 2 of the Ellis Centre Addition, which are occupied with light industrial land uses. All of these properties are zoned Light Industrial (LI) District. Beyond this is an urgent care/medical office facility (*i.e. Baylor Scott & White Emergency Hospital*) that is zoned Light Industrial (LI) District. South of this land use is the westbound frontage road for E. IH-30.

<u>East</u>: Directly east of the subject property are two (2) large tracts of land (*i.e. Lots 1 & 2 of the Rockwall Industrial*) which are bisected by Industrial Boulevard. Industrial Boulevard is identified as a M4U (*i.e. minor collector, four [4] lane, roadway*) on the City's Master Thoroughfare Plan. The majority of these properties were developed during the 1970's and 1980's. All of these properties are zoned Light Industrial (LI) District.

<u>West</u>: Directly west of the subject property is a 41.649-acre tract of land (*i.e.* Lot 1, Block 1, Herman Utley Middle School Addition) zoned Agricultural (AG) District. Adjacent to the subject property is Wilkerson-Sanders Memorial Stadium. Beyond this property is N. TL Townsend Drive, which is identified as a M4D (*i.e.* major collector, four [4] lane, divided roadway) on the City's Master Thoroughfare Plan.

#### **DENSITY AND DIMENSIONAL REQUIREMENTS**

According to Section 1, Land Use Schedule, of Article IV, Permissible Uses, of the Unified Development Code (UDC), light manufacturing/multi-tenant warehouse facilities are permitted by-right land uses in a Light Industrial (LI) District. The subject property proposes one (1) point of ingress and egress at the terminus of Alpha Drive. Other than the exceptions being requested, the submitted site plan, landscape plan, treescape plan, photometric plan, and building elevations generally conform to the technical requirements contained within the UDC for a property located within a Light Industrial (LI) District. A summary of the density and dimensional requirements for the subject property are as follows:

Ordinance Provisions	Zoning District Standards	Conformance to the Standards
Minimum Lot Area	12,500 SF	x>7.02-acres; In Conformance
Minimum Lot frontage	100-Feet	x> 750-feet; In Conformance
Minimum Lot Depth	125-Feet	x>366-feet; In Conformance
Minimum Front Yard Setback	25-Feet	x>25-feet; In Conformance
Minimum Rear Yard Setback	0-Feet + ½ H	x>15-feet; In Conformance
Minimum Side Yard Setback	0-Feet + ½ H	x>44-feet; In Conformance
Maximum Building Height	60-Feet	x>40-feet; In Conformance
Max Building/Lot Coverage	60%	x<29%; In Conformance
Minimum Masonry Requirement	90%	x>90%; Exception Required for Tilt-Up Wall Construction
Minimum Number of Parking Spaces	1:1000=88	<i>x</i> =161; In Conformance
Minimum Stone Requirement	20% Each Facade	x≤5%; Exception Required
Minimum Landscaping Percentage	15%	x=21%; In Conformance
Maximum Impervious Coverage	90-95%	x<95%; In Conformance

#### TREESCAPE PLAN

The treescape plan provided by the applicant indicates a total of 59-caliper inches to be removed from the site, which are primarily cedar trees. The applicant is providing 144-caliper inches on site, which satisfies the mitigation requirements.

#### **CONFORMANCE WITH THE CITY'S CODES**

Subsection 5.02, Light Industrial (LI) District, of Article V, District Development Standards, of the Unified Development Code (UDC), states that the "Light Industrial (LI) District is a zoning district intended to create a limited industrial zone that provides for modern types of industrial land uses." The proposed multi-tenant light industrial complex are a permitted land uses in the Light Industrial (LI) District. Additionally, all operations will be indoors with no outside storage of materials unless properly screened or buffered.

According to Subsection 5.02.B, Screening from Residential Uses, of Article VIII, Landscape Standards, of the Unified Development Code (UDC), non-residential developments that have a "...side or rear contiguous to any residential zoned or used property...shall be screened with a masonry fence a minimum of six (6) feet in height with canopy trees planted on 20-foot centers. As an alternative, the Planning and Zoning Commission may approve an alternative screening method that incorporates a wrought iron fence and three (3) tiered screening (i.e. [1] small to mid-sized shrubs, large shrubs or accent trees, and canopy trees or [2] evergreen trees and canopy trees) along the entire length of the adjacency...(t)he canopy trees shall be placed on 20-foot centers."

In this case, the applicant is providing a three (3) tiered screening system along the entire western property boundary that is adjacent to the Herman Utley Middle School; however, RISD has an existing wrought-iron fence along this western property boundary. Based on the existing fence on the RISD's property the applicant is not proposing to incorporate an additional wrought iron fence. Staff made this suggestion to the applicant to prevent the possibility of creating a strip of land in between the two (2) fences that would be hard for either property owner to maintain. With all this being said, the proposed landscape screening is a discretionary approval for the Planning and Zoning Commission upon a determination that the provided screening will achieve the intent of the screening ordinance. This has been included as a condition of approval in this case memo.

#### VARIANCES/EXCEPTIONS REQUESTED BY THE APPLICANT

Based on the information submitted by the applicant, staff has identified the following exceptions to the requirements of the Unified Development Code (UDC):

#### (1) Building Materials.

- (a) Stone. According to Section 5.01.A.1, General Industrial District Standards, of Article V, District Development Standards, of the UDC, a minimum of 20% stone is required on all building façades. In this case, the applicant is providing stone on the columns at the entry ways of the buildings; however, the stone falls short of the 20% requirement. Staff should note that this is not an uncommon request with larger industrial buildings.
- (b) *Tilt Wall.* According to Section 5.01.A.1, *General Industrial District Standards*, of Article V, *District Development Standards*, of the UDC, the use of concrete tilt-up walls may be permitted on a case-by-case basis by the Planning and Zoning Commission. The proposed building is 100% tilt-wall construction.

#### (2) Articulation.

- (a) Primary Building Façades. According to Section 5.01.C.1, General Industrial District Standards, of Article V, District Development Standards, of the UDC, primary facades require projections associated with entryways, architectural elements and wall lengths. Specifically, primary architectural/entryway elements are required to extend a minimum of 25% above the top of the wall and a minimum of 25% from the walls surface. In addition, no wall should exceed a length of four (4) time the walls height without an architectural/entryway element. In this case, the proposed building does incorporate vertical projections, but does not meet the horizontal projection standards on the primary façades.
- (b) Secondary Building Façades. According to Section 5.01.C.1, General Industrial District Standards, of Article V, District Development Standards, of the UDC, secondary facades require projections associated with entryways and architectural elements. Specifically, the secondary architectural/entryway elements are required to extend a minimum of 15% above the top of the wall and a minimum of 15% from the walls surface. In this case, the proposed building does

incorporate vertical projections, but does not meet the horizontal projection standards on the secondary façades.

### (3) Residential Screening Fence.

Screening. According to Subsection 5.6, Screening from Residential Uses, of Section 5, Mandatory Provisions, of Article VIII, Landscape Standards, of the Unified Development Code (UDC), "any non-residential or multi-family land use or parking area that has a side or rear contiguous to any residentially zoned or used property shall be screened with a masonry fence a minimum of six (6) feet in height with canopy trees planted on 20-foot centers ... (a)s an alternative, the Planning and Zoning Commission may approve an alternative screening method that incorporates a wrought iron fence and three (3) tiered screening (i.e. [1] small to mid-sized shrubs, large shrubs or accent trees, and canopy trees or [2] evergreen trees and canopy trees)

#### (4) Detention Pond.

(a) Maximum of 4:1 Slope. According to the Engineering Department's Standards of Design and Construction Manual, "(d)etention ponds shall have a side slope 4:1 or flatter. No retaining walls are allowed in detention ponds." In this case the applicant is requesting vertical retaining walls within the detention system. According to Section 3, Storm Drainage Facilities, of the Standards of Design and Construction Manual, "(a) variance to allow retaining walls in a detention easement will require approval by the Planning and Zoning Commission with appeals being heard by the City Council." To off-set the variance, staff has included a condition of approval that the applicant be required to screen the detention system with a combination of trees and shrubs. This will require the applicant to revise the landscape plan prior to submitting civil plans.

According to Section 9, Exceptions and Variances, of Article XI, Development Applications and Review Procedures, of the Unified Development Code (UDC), and unless otherwise specified by the UDC, "(a)n applicant may request the Planning and Zoning Commission grant an exception to the provisions contained in the Unified Development Code (UDC), where unique or extraordinary conditions exist or where strict adherence to the technical requirements of the...(UDC) would create an undue hardship. In cases where an exception or exceptions is/are being requested, the applicant shall provide compensatory measures that directly offset the requested exception." In this case, the applicant has provided a letter explaining the variances and offering compensatory measures for the The Planning and Zoning Commission is tasked with determining if the requested variances. compensatory measures properly off-set the requested variance. This is a discretionary decision for the Planning and Zoning Commission that require approval by a super majority vote (i.e. a threefourths vote of those members present), with a minimum of four (4) votes in the affirmative required for approval. In the event that the exception is denied, the applicant has the ability to appeal the Planning and Zoning Commission's decision to the City Council by filing a written request with the Planning and Zoning Department.

#### **CONFORMANCE WITH OURHOMETOWN VISION 2040 COMPREHENSIVE PLAN**

The Future Land Use Plan adopted with the OURHometown Vision 2040 Comprehensive Plan (*Comp Plan*) indicates that the subject property is located within the <u>IH-30 Corridor District</u> which is "... the primary retail corridor for the City of Rockwall. Currently the corridor is approximately 55% developed, with the remaining 45% being vacant or raw land. The Corridor acts as the western gateway for both the City and County of Rockwall, and has land uses that include retail, personal services, medical, and industrial." Additionally, the *Special Commercial Corridor (SC)* designation "...is intended to provide an area for commercial/retail...activity centers that are intended to support and serve the entire region." (*Ch. 1; Land Use Plan*) In this case, the applicant's request does not conform to the development referred to in the Comprehensive Plan; however, the development is going into an existing industrial park that is already zoned for the proposed land use.

According to the Comprehensive Plan, industrial developments should be adequately buffered and/or screened from residential land uses. In addition, the Comprehensive Plan states that "(b)uffers utilizing a combination of berms, landscaping and trees should be used for industrial properties that are adjacent to non-industrial land uses or agricultural land." While the adjacent property (*i.e. Herman Utley Middle School*) is zoned Agricultural (AG) District -- which is considered to be residential -- the property is developed with a non-residential land use (*i.e. a football stadium*). Regardless of the adjacency, the applicant is proposing to install a three (3) tiered landscape screening system in conjunction with an existing wrought-iron fence (*located on the adjacent property*) to accomplish the screening required by the Comprehensive Plan and Unified Development Code (UDC).

### **ARCHITECTURAL REVIEW BOARD (ARB)**

On October 29, 2019, the Architectural Review Board (ARB) reviewed the proposed site plan and building elevations. Based on the submittal the Architectural Review Board (ARB) requested that the applicant incorporate stone around the primary and secondary entryways for the building. The applicant has revised the building elevations to incorporate the stone. The Architectural Review Board (ARB) will review the applicant's changes at the <u>November 12, 2019</u> meeting and provide a recommendation to the Planning and Zoning Commission.

#### **CONDITIONS OF APPROVAL**

If the Planning and Zoning Commission chooses to approve the applicant's request, then staff would propose the following conditions of approval:

- (1) All staff comments provided by the Planning, Engineering and Fire Department must be addressed prior to the submittal of a building permit;
- (2) Approval by the Planning and Zoning Commission of all exceptions requested as outlined in staff's report;
- (3) The applicant will be required to revise the landscape plan to incorporate a mixture of trees and shrubs to screen the detention pond adjacent to the entryway off of Alpha Drive prior to submitting civil plans;
- (4) All Roof Top Units (RTU's) will need to be screened and not visible from adjacent properties or public rights-of-way; and
- (5) Any construction resulting from the approval of this site plan shall conform to the requirements set forth by the Unified Development Code (UDC), the International Building Code (IBC), the Rockwall Municipal Code of Ordinances, city adopted engineering and fire codes and with all other applicable regulatory requirements administered and/or enforced by the state and federal government.

### **City of Rockwall**

### **Project Plan Review History**



ROCKWALL URBAN INDUSTRIAL, LP

HALFF ASSOCIATES

Project Number SP2019-040

Project Name Ellis Centre Phase 2 Addition

Type SITE PLAN

Subtype

Status Staff Review

Site Address City, State Zip

ALPHA DR ROCKWALL, TX 75087 Zoning

Subdivision Tract Block Lot No Parcel No General Plan

Owner

Applicant

ELLIS CENTRE 2 1 D 1 3586-000D-0001-00-0R

Type of Review / Notes	Contact	Sent Due	Received	Elapsed Status	Remarks
BUILDING	Russell McDowell	10/21/2019 10/28/2	2019 10/22/2019	1 APPROVED	
ENGINEERING	Sarah Johnston	10/21/2019 10/28/2	2019 10/24/2019	3 COMMENTS	



10/21/2019 LM

**Applied** 

Closed

Expired

Status

Approved

pe of Review / Notes Contact	Sent	Due	Received	Elapsed Status	Remarks	
(10/24/2019 4:26 PM SJ)						
M - Add note, "No trees within 5' of u	tilities" to the lar	ndscape plan				
M - Parking near the building to be 20	)'x9'. All other pa	arking to be 1	.8'x9'. Standards of	f Design 2.19		
M - All fire lane radii to be 20' min. If t	the building is $36$	or taller, th	e fire lane radius r	nust be 30' min. Standaı	ds of Design 2.19	
M - Driveway radii to be 30' min. Stan	dards of Design ?	2.19				
M - No structures in easements. This i	ncludes retainin	ng walls and f	ootings, dumpster	and screening wall mus	t be out of easements. Standards	of Design 6.4.1
M - All fire hydrants must have a 20'x2	20' easement est	tablished. Fire	e hydrants to have	5' of clearance around a	all sides. Standards of Design 5.3.1	<u> </u>
M - Must show existing utilities and y	our planned serv	vice connecti	ons.			
M - Minimum easement width is 20' f	or proposed eas	ements. Stan	dards of Design 5.	3.1 and 6.4		
M - Retaining walls in detention requi	ire a variance Sta	andards of De	esign3.3.3.2			
M – Must stub out the 8" water and 8	" sewer to the n	orthern prop	erty for future exp	pansion		
M - Must meet all standards of design	and construction	on.				
I - 4% Engineering Fees						
I - Impact Fees						
I - Must have detention on-site Manni	ing's C-valve is p	er zoning				
I - Water and sewer lines must have 1	0' of easement o	on both sides				
I - No utilities in detention easements	;					
I - No grate utilities allowed						
I - Cul-de-sac paving to be 8" 3600 psi	(6.5 sack mix)					
I - No sand is allowed under paving.						
I - Walls 3' and over must be engineer	ed					
I - All retaining walls to be rock or sto	ne face. No smoo	oth concrete	walls			
I - If storm is picking up offsite draina	ge the pipe mair	ntained must	be			
I - Where you show the 15'x64' turnar	ound, you must	stripe the en	itire area as no pai	rking.		
E Ariana Hargrove	10/21/2	019 10/28/2	019 10/24/2019	3 COMMENTS	see notes	
(10/24/2019 3:16 PM AA)						
FDC shall be:						
facing and visible from the fire lane						
within 100-feet of a fire hydrant						
- clear and unobstructed with a minin	num of a 5-feet c	clear all-weat	her path from fire	lane access		
- installed 18-48 inches above grade.						
(Ord 16-31)						
E Ariana Hargrove	11/6/20	19 11/13/2	019 11/6/2019	COMMENTS	see notes	
(11/6/2019 10:11 AM AA)						
Fire hydrant shall be located within 6-	ft for the fire lan	ne. Add fire la	<mark>ane as shown on m</mark>	narkups or relocate fire l	nydrant and FDC.	
Fire hydrant shall be within 6-ft for fire	e lane (IFC 507 5	.1.2)				
FDC shall be witin 100-ft of a fire hydr	ant. (IFC 912.2.3	)				

Project Reviews.rpt Page 2 of 8

Type of Review / Not	es Contact	Sent	Due	Received	Elapse	d Status	Remarks
(10/22/2019 3:0	1 PM LS)						
Addressing will I	oe:						
BLDG 1 = 1915 A	lpha Dr, Rockwall,TX 750	87					
BLDG 2 = 1905 A	lpha Dr, Rockwall,TX 750	87					
BLDG 3 = 1910 A	lpha Dr, Rockwall,TX 750	87					
PLANNING	<b>David Gonzales</b>	10/21/2	2019 10/28/2019	10/24/2019	3	COMMENTS	See comments

Project Reviews.rpt Page 3 of 8

(10/24/2019 8:50 PM DG)

SP2019-040; Site Plan for Rockwall Urban & Industrial Center (Ellis Centre, Phase 2)

Please address the following comments (M= Mandatory Comments; I = Informational Comments)

- I.1 This is a request for the approval of a site plan for a multi-tenant industrial building on a 7.02-acre parcel of land identified as Lot 1, Block D, Ellis Center Phase 2 Addition, City of Rockwall, Rockwall County, Texas, zoned Light Industrial (LI) District, situated at the terminus of Alpha Drive.
- 1.2 For questions or comments concerning this case please contact David Gonzales in the Planning Department at (972) 772-6488 or email dgonzales@rockwall.com.
- M.3 For reference, include the case number (SP2019-040) in the lower right-hand corner of all pages on future submittals.
- 1.4 This project is subject to all requirements stipulated by the Unified Development Code(UDC); including the District Development Standards, of Article V, that are applicable to the subject property.
- 1.5 Please note that the property will require a replat prior to the issuance of a building permit.

M.6 Site Plan. Please make the following clarifications on the site plan to ensure staff can properly review this project and convey all of the required elements to the City's boards and commissions:

- 1) Please provide a label for the parking count for each row of spaces in order to determine total parking count
- 2) The cross sections of concrete pavement thickness is to be determined by the engineering department during the civil submittal process and is not considered to be approved during this site plan process.
- 3) Parking for an office use requires a minimum of one (1) parking space per 300-SF (i.e. 1:300 SF) of gross floor area. Will there be offices uses within this complex? If so, please update parking legend. (Article VI, Table 3).
- 4) Provide a standard signature block with signature space for the Planning and Zoning Chairman and Planning Director.
- 5) Is there a front building set back? If so, this is required to be 25-ft. Please adjust accordingly.
- 6) Provide a label for all drive aisle widths.
- 7) Indicate and label all sidewalk widths proposed for this site.
- 8) Delineate and label all loading dock parking spaces. Minimum 12-ft wide & 65-ft in length. (Art. VI, Section 6.04)
- 9) Ground mounted utility equipment and RTU's shall be screened from adjacent public rights-of-way and adjacent property. Provide screening detail for these units. (Art. V, Sec. 1.05.3)
- 10) Provide screening along the western property boundary from the school district property. (Art. VIII, Sec. 5.02.B Landscape Screening)
- 11) Will there be any outside storage of materials, products, etc.?

M.8 Building Elevations. According to Subsection 5.01.A1, of the General Industrial District Standards, of Article V, District Development Standards, of the UDC, requires a minimum of 20% stone (i.e. natural or synthetic/cultured) on all building façades. In this case, the construction of the addition does not include stone on any façade. This will require an exception from the Planning and Zoning Commission pending a recommendation from the Architectural Review Board(ARB).

M.9 Building Elevations. According to Subsection 5.01A.1, General Industrial District Standards, of Article V, District Development Standards, of the UDC, each exterior wall of a building's façade shall consist of a minimum of 90% primary materials and ten (10) percent secondary materials. In this case, the construction consists of concrete tilt-up wall. The use of concrete tilt-up walls may be permitted on a case-by-case basis in accordance with the exception requirements outlined in this section of the UDC. This will require an exception from the Planning and Zoning Commission pending a recommendation from the Architectural Review Board(ARB).

Project Reviews.rpt Page 4 of 8

- M.10 Building Elevations. Please review the articulation formulas contained in Section 5.01.C of Article V, District Development Standards, of the UDC. The submitted building elevations do not appear to meet all the formulas required for building articulation. This will require an exception from the Planning and Zoning Commission pending a recommendation from the Architectural Review Board (ARB).
- M.11 Building Elevations. Please make the following clarifications and changes to the building elevations to ensure staff can properly review this project and convey all of the required elements to the City's boards and commissions:
- 1) Indicate all HVAC units (i.e. dash-in RTU's) on the building elevations so that staff can ensure that they meet the screening requirements dictated by the UDC (Subsection. 1.05.C.3; Art. V; UDC).
- 2) Provide calculation of building materials as a percentage
- M.12 Landscape Plan. Please make the following clarifications and changes to the landscape plan to ensure staff can properly review this project and convey all of the required elements to the City's boards and commissions:
- 1) Provide screening along the western property boundary from the school district property. Art. VIII, Sec. 5.02.B Landscape Screening, states (a)ny non-residential...land use or parking area that has a ide or rear contiguous to any residentially zoned or used property shall be screened with a masonry fence a minimum of six (6) feet in height with canopy trees planted on 20-foot centers (as depicted in Figures 6 & 7 below). As an alternative, the Planning and Zoning Commission may approve an alternative screening method that incorporates a wrought iron fence and three(3) tiered screening along the entire length of the adjacency. The canopy trees shall be placed on 20-foot centers. As a note, the Agricultural (AG) District is considered residential
- 2) Correct table to indicate a minimum 15% landscaping required (currently indicates 10%).
- 3) All new tree plantings are to be a minimum of 4-inch caliper trees. Correct plan. (Art. VIII, Sec. 4.A.2)
- 4) Parking lotsgreater than 20,000 SF are required to provide a minimum of one (1) tree for each 10 parking spaces. 161 parking spaces = 16 trees within the parking lot area. (Art. VIII, Sec. 5.03.E.2)
- M.13 Treescape Plan According to Section 3.4, Treescape Plan Review Process, of Article IX, of the UDC, the director of planning and zoning, or his/her designee, shall review the treescape plan and approve the plan per the requirements of this article, or forward any recommendations to the planning and zoning commission. As part of the treescape plan review process, the city has the right to request changes or adjustments in the layout and design of a development to save trees. The planning and zoning commission will review and approve or disapprove the treescape plan. The decision of the planning and zoning commission may be appealed to the city council. The treescape plan requires approval by the Planning and Zoning Commission as submitted.
- M.14 Photometric Plan. According to Section 3.3, Minimum Requirements, of Article VII, Environmental Performance, of the UDC, the maximum allowable light intensity measured at the property line of any non-residentially zoned lot shall be 0.2 FC. In this case, the submitted photometric plan conforms to the requirements of the UDC.
  - 1) No light pole, base or combination thereof shall exceed an overall height of 30-ft. Provide pole detail. (Art. VII, Sec. 3.3.D)
- M.15 Based on the submittal staff has identified the following exceptions
- 1) Building Materials. The proposed addition is requesting the use of tilt-up wall construction and does not include a minimum of 20% stone.
- 2) Building Articulation. The proposed addition does not meet the articulation standards established by the UDC

Project Reviews.rpt Page 5 of 8

I.15 Staff has identified the aforementioned items necessary to continue the submittal process Please make these revisions and corrections, and provide any additional information that is requested. Revisions for this case will be due on November 5, 2019; however, it is encouraged for applicants to submit revisions as soon as possible to give staff ample time to review the case prior to the November 12, 2019 Planning & Zoning Meeting. Please note that the Planning & Zoning Work Session meeting will be held on October 29, 2019.

I.16 The Architectural Review Board (ARB) meeting will be held on October 29, 2019 and will begin at 5:00 p.m. in the City's Council Chambers. The ARB will forward a recommendation to the Planning and Zoning Commission.

I.17 Staff recommends that a representative be present for the meetings as scheduled above The Planning and Zoning meeting will be held in the City's Council Chambers and will begin at 6:00 p.m.

**PLANNING** 

**David Gonzales** 

11/6/2019 11/13/2019 11/6/2019

COMMENTS

**Revision 1 Comments** 

Project Reviews.rpt Page 6 of 8

10/25/2019 11/1/2019 10/25/2019

1.8 Staff recommends that a representative be present for the meetings as scheduled above. The Planning and Zoning meeting will be held in the City's Council

**COMMENTS** 

See comments

forward a recommendation to the Planning and Zoning Commission

**David Gonzales** 

Chambers and will begin at 6:00 p.m.

Police Department

Project Reviews.rpt Page 7 of 8

(10/25/2019 12:12 PM DG)

The following CPTED comments are from Captain Ed Fowler of the Rockwall Police Department

#### SP2019-040 Ellis Center Phase 2

#### Considerations

- Provide clearance around the bottom of the fencing surrounding the dumpster for visual sight line of anyone inside fencing
- Consider mirror(s) on dumpster fencing to reveal any persons inside holding(fencing) area.
- Consider lighting spaced at intervals around the overhead doors(sides) and rear that fully illuminate the area.
- Evaluate transitional lighting for employees entering the parking lot from an area that has bright lighting to dim lighting and may pose a visual problem
- There does not appear to be shrubs or trees that will obstruct views around the business.
- Consider additional locking mechanisms for overhead doors in the form of a bar system and case hardened locking system
- Consider the addition of removable bollards for overhead doors to prevent vehicles from being used to breach the doors
- Consider auxiliary locking system on main entrance door(s) with limited key access, key pad or electronic badges for afterhours employees.
- Consider all exterior doors being equipped with alarm contact sensors and windows with glass break sensors.
- Consider motion sensor alarms inside the business and motion activated lighting for the interior.
- Consider installation of locking mechanisms on all sliding windows up to the use of security rods.
- Roof access points should be locked from the inside.
- Consider installation of solid core doors for offices inside the business including the room that houses the safe Single cylinder locks for all offices and a double cylinder lock for the safe room
- Consider an additional alarm inside the safe room, either attached to the entrance door or safe.
- Consider the addition of security cameras on the exterior of the building that provide 360 degree coverage.
- Consider the addition of security cameras forthe interior the business.
- Interior considerations are not being added without speaking with the business owners/reps first.

The implementation of all or any portion of the considerations are NO guarantee or assurance that crime will not occur or that the property will be crimeproof. The considerations should, however, reduce the probability of crime if the strategies and recommendations are properly applied and consistently maintained. Any changes should still meet with the City of Rockwall's building code, code of ordinances and fire code.

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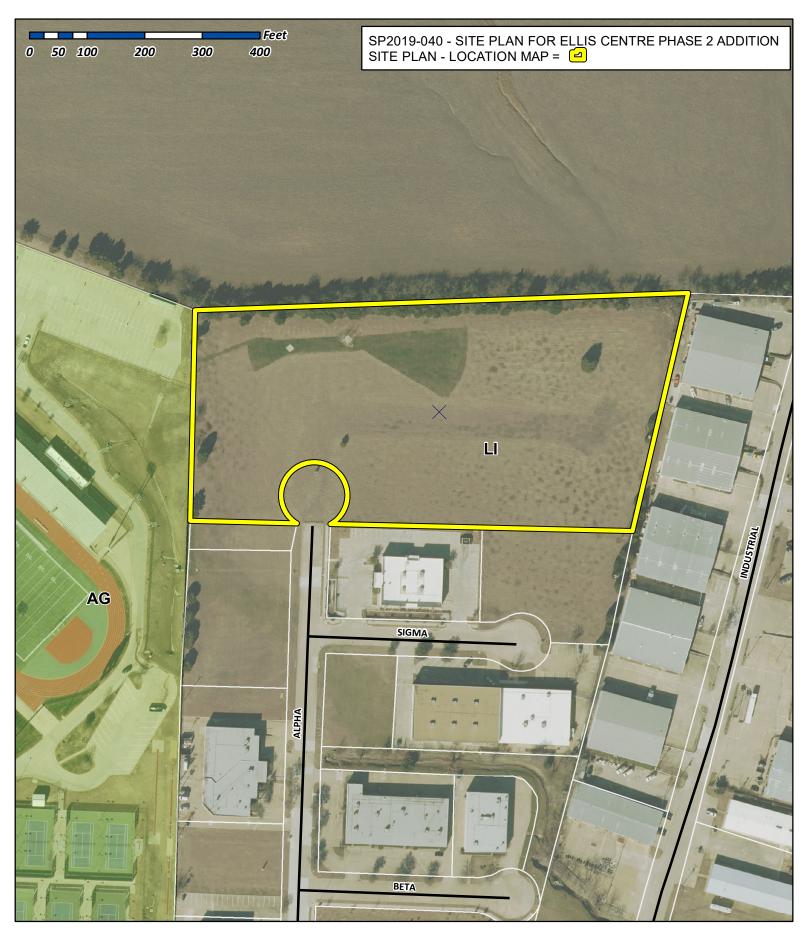
### STANDARD SITE PLAN WORDING

City of Rockwall Planning and Zoning Department 385 S. Goliad Street Rockwall, Texas 75087

GENERAL REFERENCE: SECTION 212.009 OF CHAPTER 212, MUNICIPAL REGULATION OF SUBDIVISIONS AND PROPERTY DEVELOPMENT, OF THE TEXAS LOCAL GOVERNMENT CODE

### SITE PLAN SIGNATURE BLOCK

APPROVED: I hereby certify that the above and foregoing site plan for a commission of the City of Rockwall on the [DAY] day of [MOI]	development in the City of Rockwall, Texas, was approved by the Planning & Zoning NTH], [YEAR].
WITNESS OUR HANDS, this [DAY] day of [MONTH], [YEAR].	
Planning & Zoning Commission, Chairman	Director of Planning and Zoning






## City of Rockwall

Planning & Zoning Department 385 S. Goliad Street Rockwall, Texas 75032 (P): (972) 771-7745 (W): www.rockwall.com The City of Rockwall GIS maps are continually under development and therefore subject to change without notice. While we endeavor to provide timely and accurate information, we make no guarantees. The City of Rockwall makes no warranty, express or implied, including warranties of merchantability and fitness for a particular purpose. Use of the information is the sole responsibility of the user.



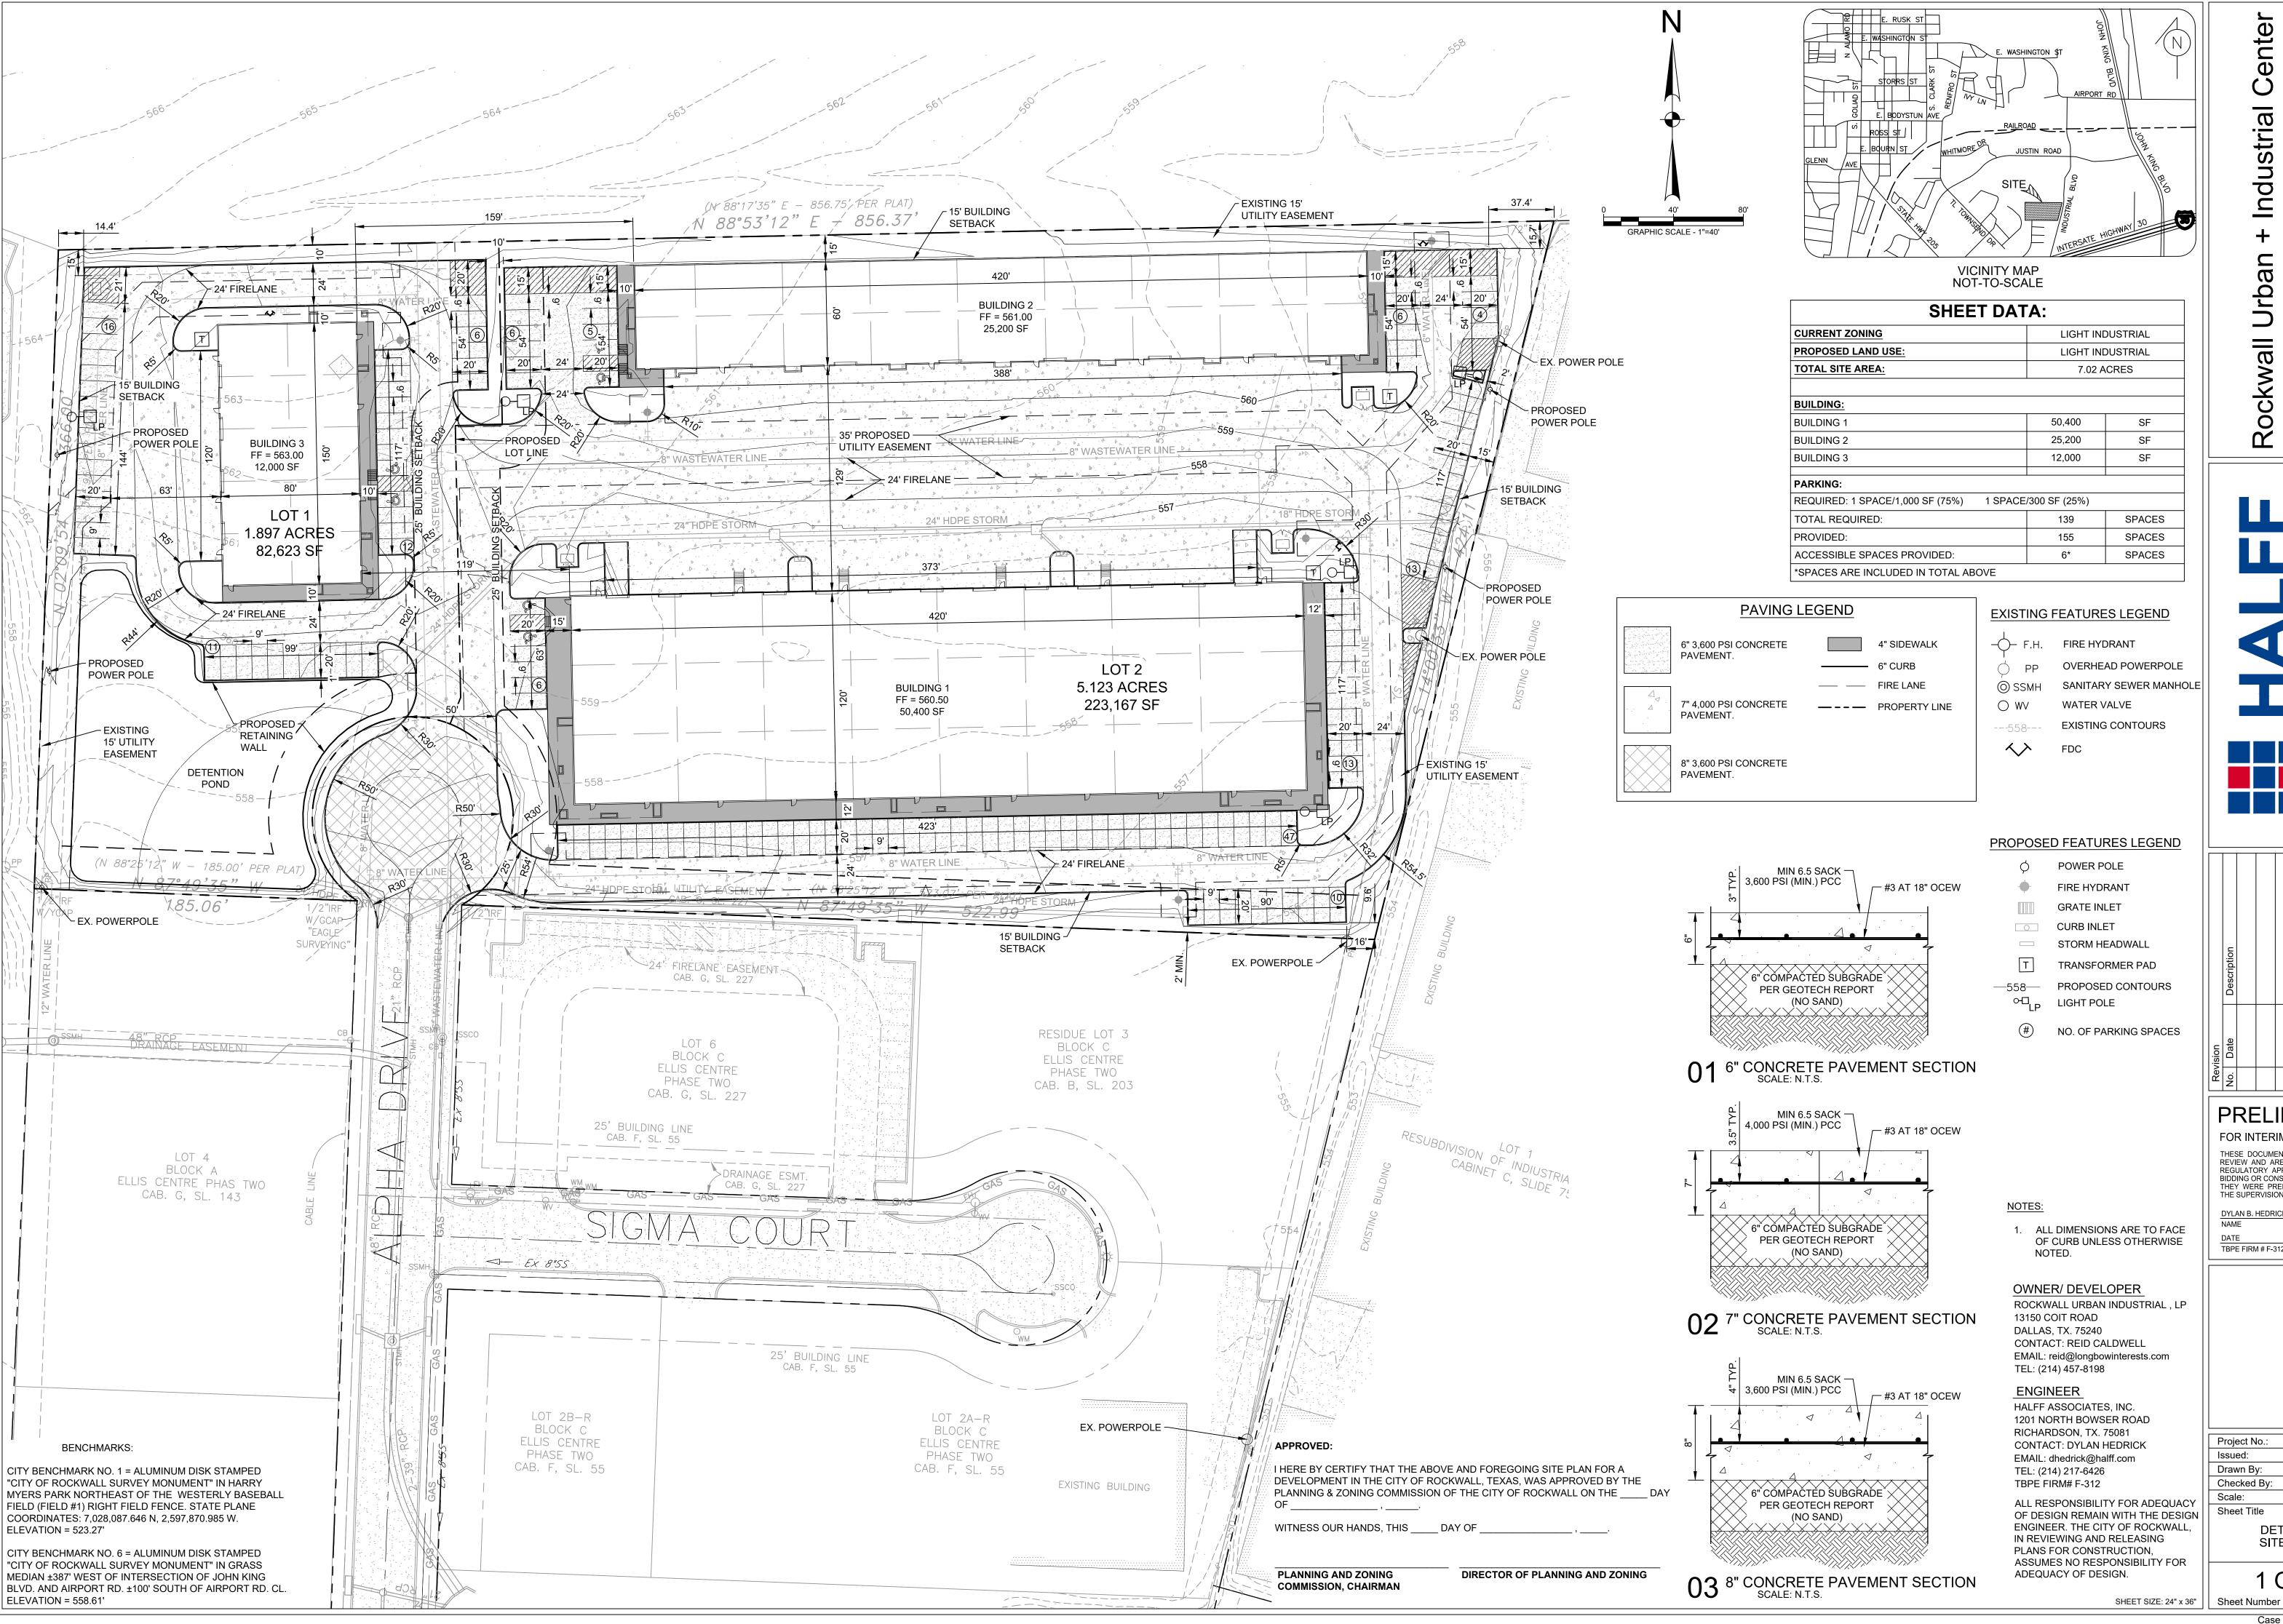

Industrial DRIVE 75087 P ≷ END ROC Rockwall

**PRELIMINARY** FOR INTERIM REVIEW ONLY THESE DOCUMENTS ARE FOR INTERIM REVIEW AND ARE NOT INTENDED FOR REGULATORY APPROVAL, PERMIT, BIDDING OR CONSTRUCTION PURPOSES.

THE SUPERVISION OF: DYLAN B. HEDRICK TBPE FIRM # F-312

THEY WERE PREPARED BY, OR UNDER

1 OF 1

Project No.: 35989

Checked By: DBH

REP

DETAILED

SITE PLAN


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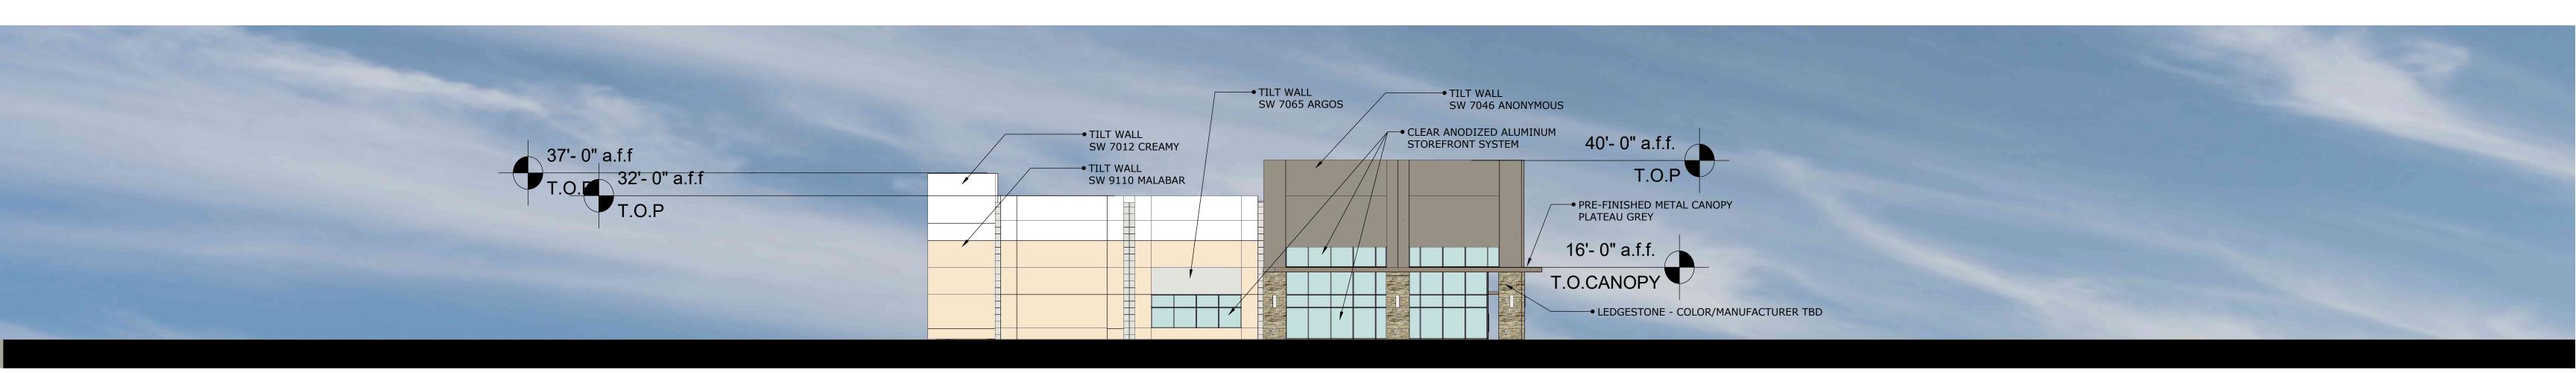
Sheet Title

Case Number: SP2019-040


NOVEMBER 2019

AS SHOWN



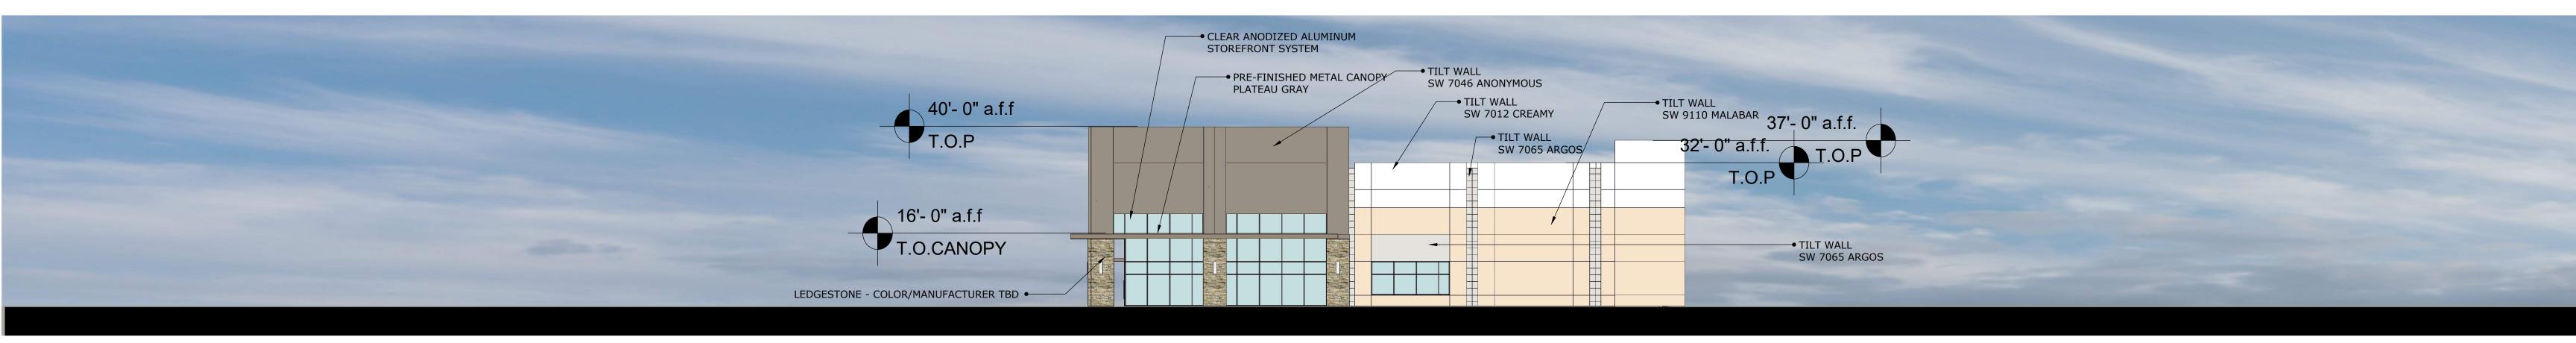

WEST

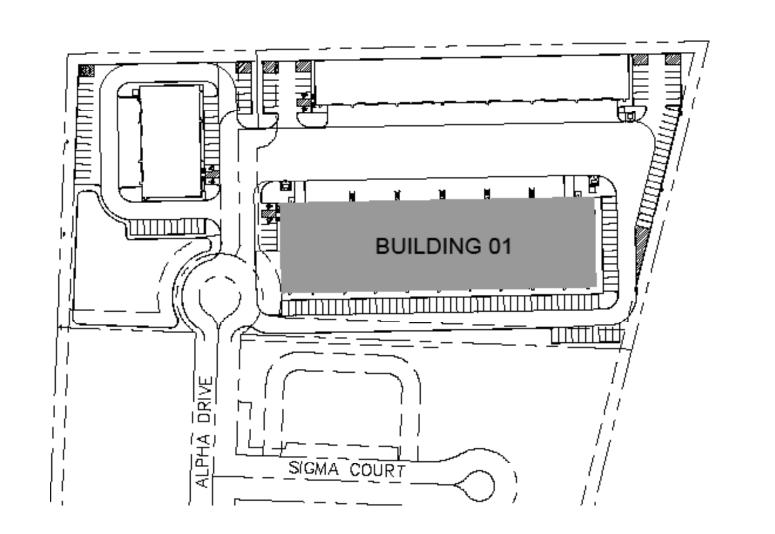


FAÇADE				
BLDG 1				
	METAL CANOPY	MASONRY	PRIMARY MASONRY: PAINTED CONCRETE TILT WALL	FAÇADE TOTAL SF (EXCLUSIVE OF DOORS WINDOWS)
NORTH	0	0	14,051	14,051
SOUTH	235	580	10,586	11,401
EAST	59	241	3,533	3,833
WEST	59	241	3,533	3,833
				TOTAL
SF of Materials	353	1,062	31,702	33,117
Percentage of Material	1%	3%	96%	100%

**ÓBRIEN** BUILDING ELEVATIONS





NORTH

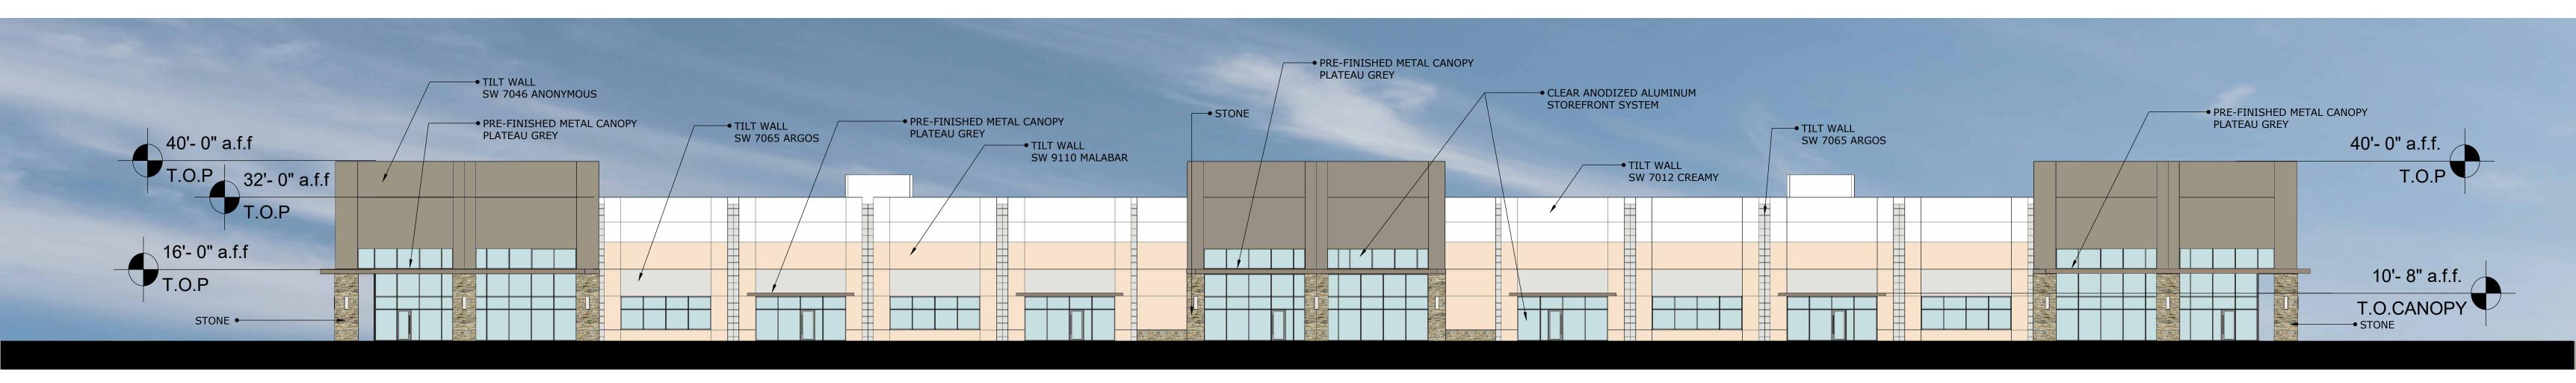

SOUTH

## TYPICAL DUMPSTER ENCLOSURE ELEVATIONS

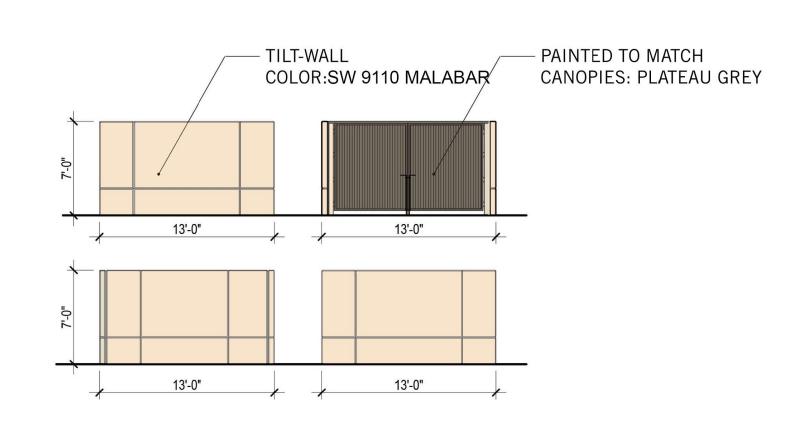

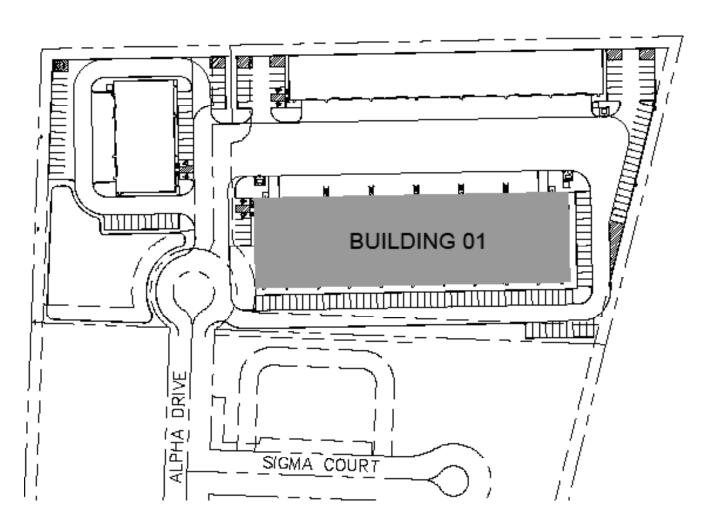


FAÇADE				
BLDG 1				
	METAL CANOPY	MASONRY	PRIMARY MASONRY: PAINTED CONCRETE TILT WALL	FAÇADE TOTAL SF (EXCLUSIVE OF DOORS & WINDOWS)
NORTH	0	0	14,051	14,051
SOUTH	235	580	10,586	11,401
EAST	59	241	3,533	3,833
WEST	59	241	3,533	3,833
				TOTAL
SF of Materials	353	1,062	31,702	33,117
Percentage of Material	1%	3%	<b>96</b> %	100%


URBAN INDUSTRIAL CENTER - BLDG 1




SOUTH

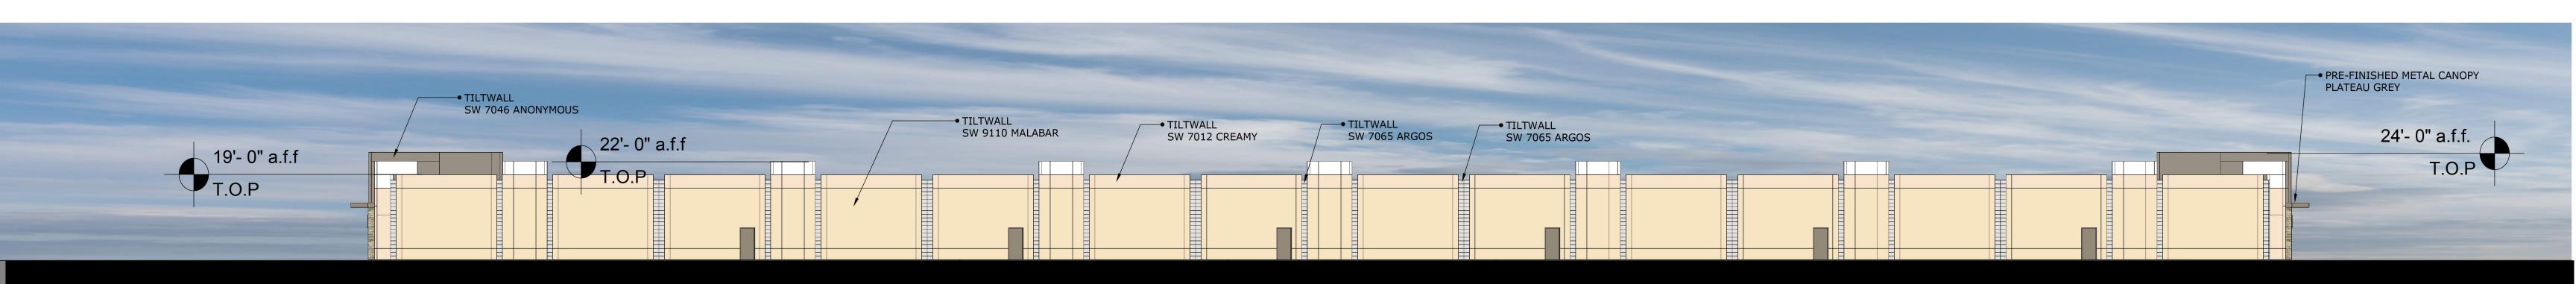


NORTH

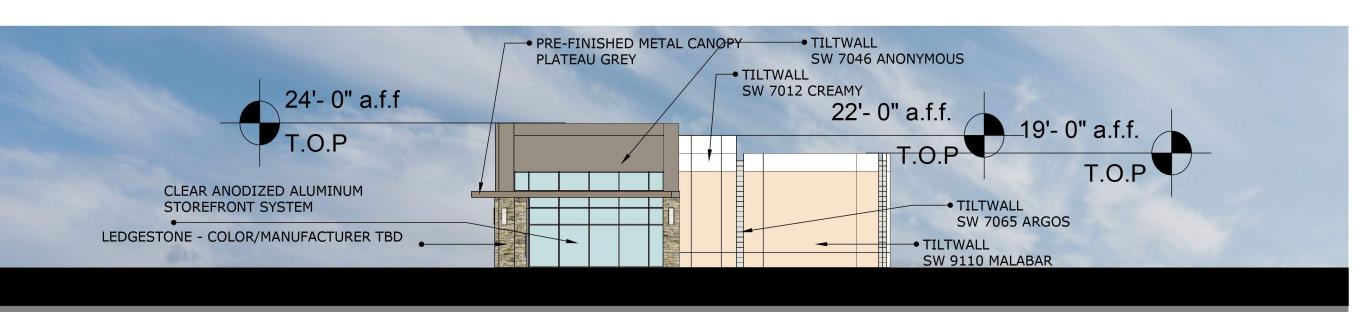

EAST

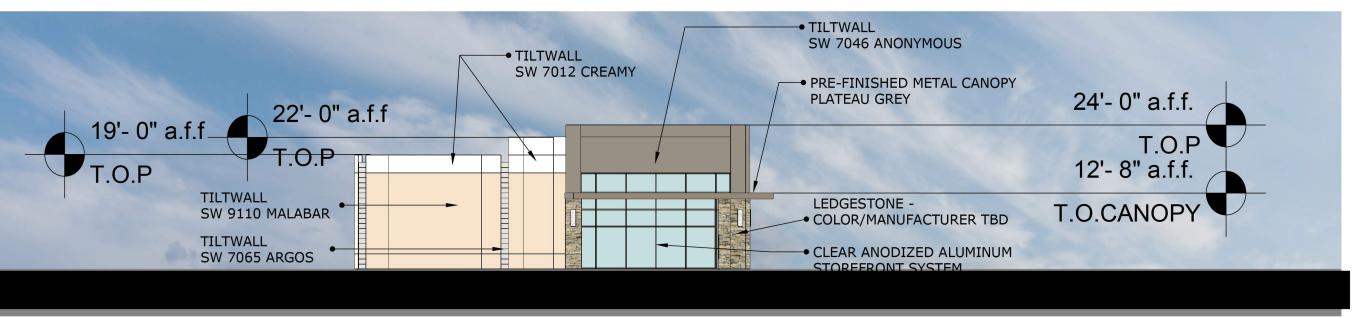


WEST

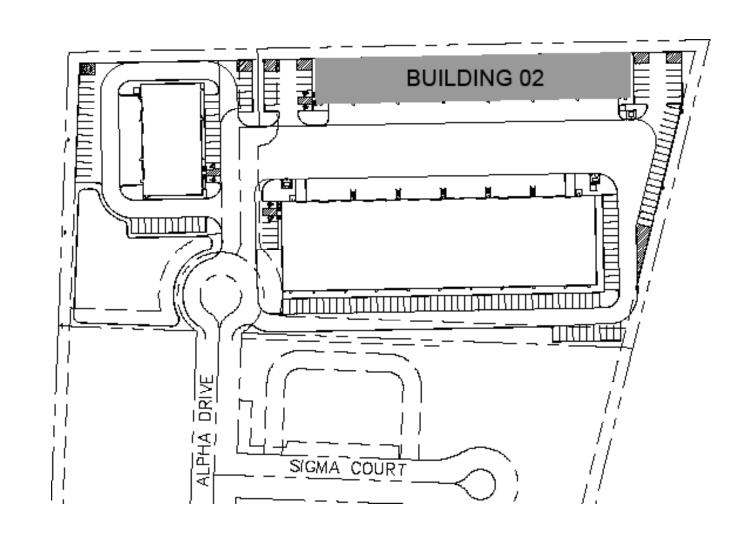


BLDG 2				
	METAL CANOPY	MASONRY	PRIMARY MASONRY: PAINTED CONCRETE TILT WALL	FAÇADE TOTAL SF (EXCLUSIVE OF DOORS & WINDOWS)
NORTH	0	0	9,178	9,178
SOUTH	66	190	3,592	3,848
EAST	33	73	946	1,052
WEST	33	73	946	1,052
				TOTAL
SF of Materials	132	336	14,662	15,129
Percentage of Material	1%	2%	97%	100%

**OBRIEN** 


**BUILDING ELEVATIONS** 

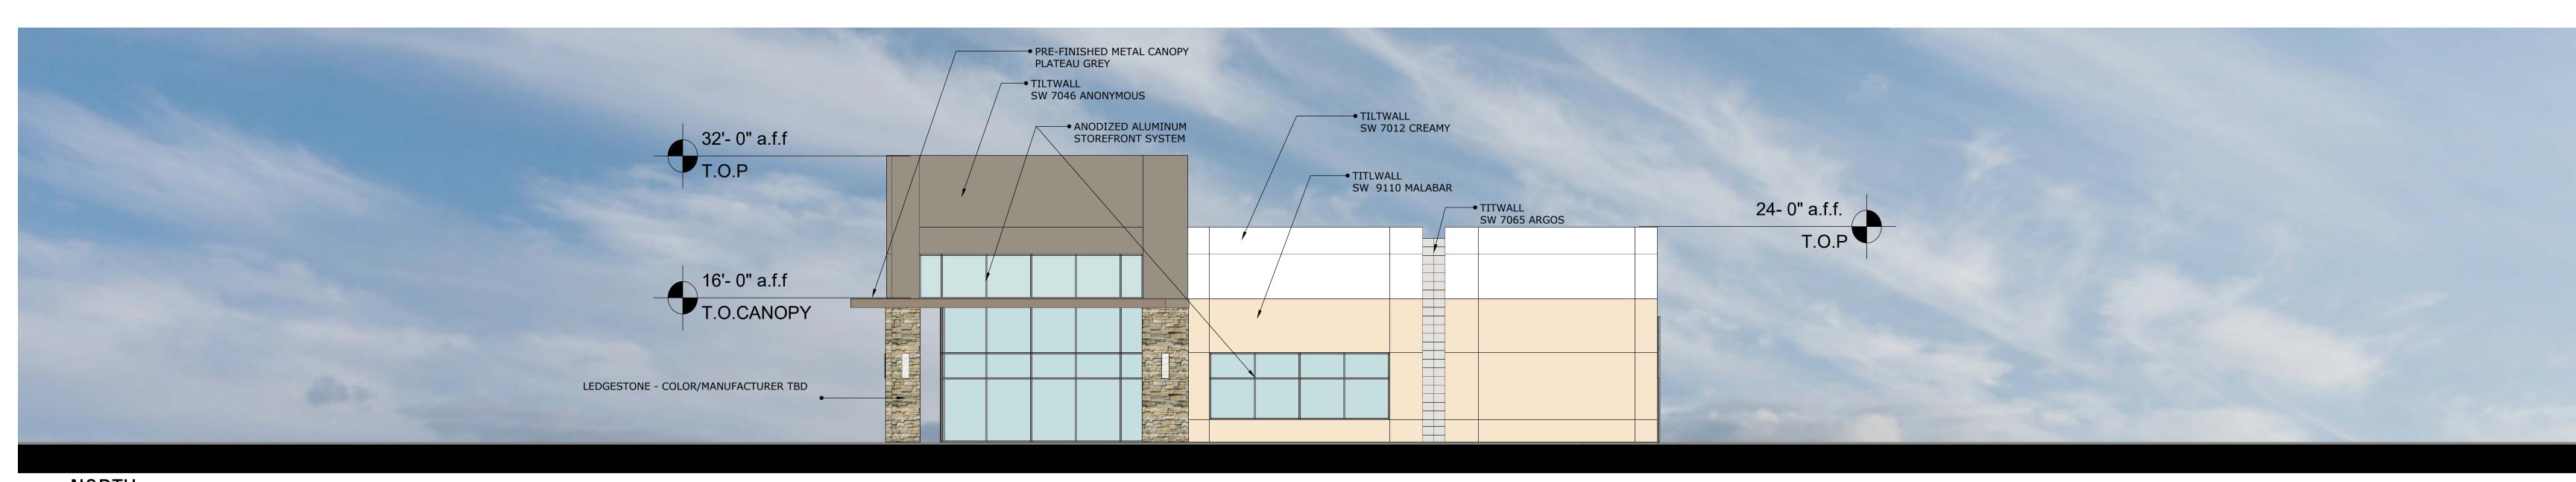

NORTH

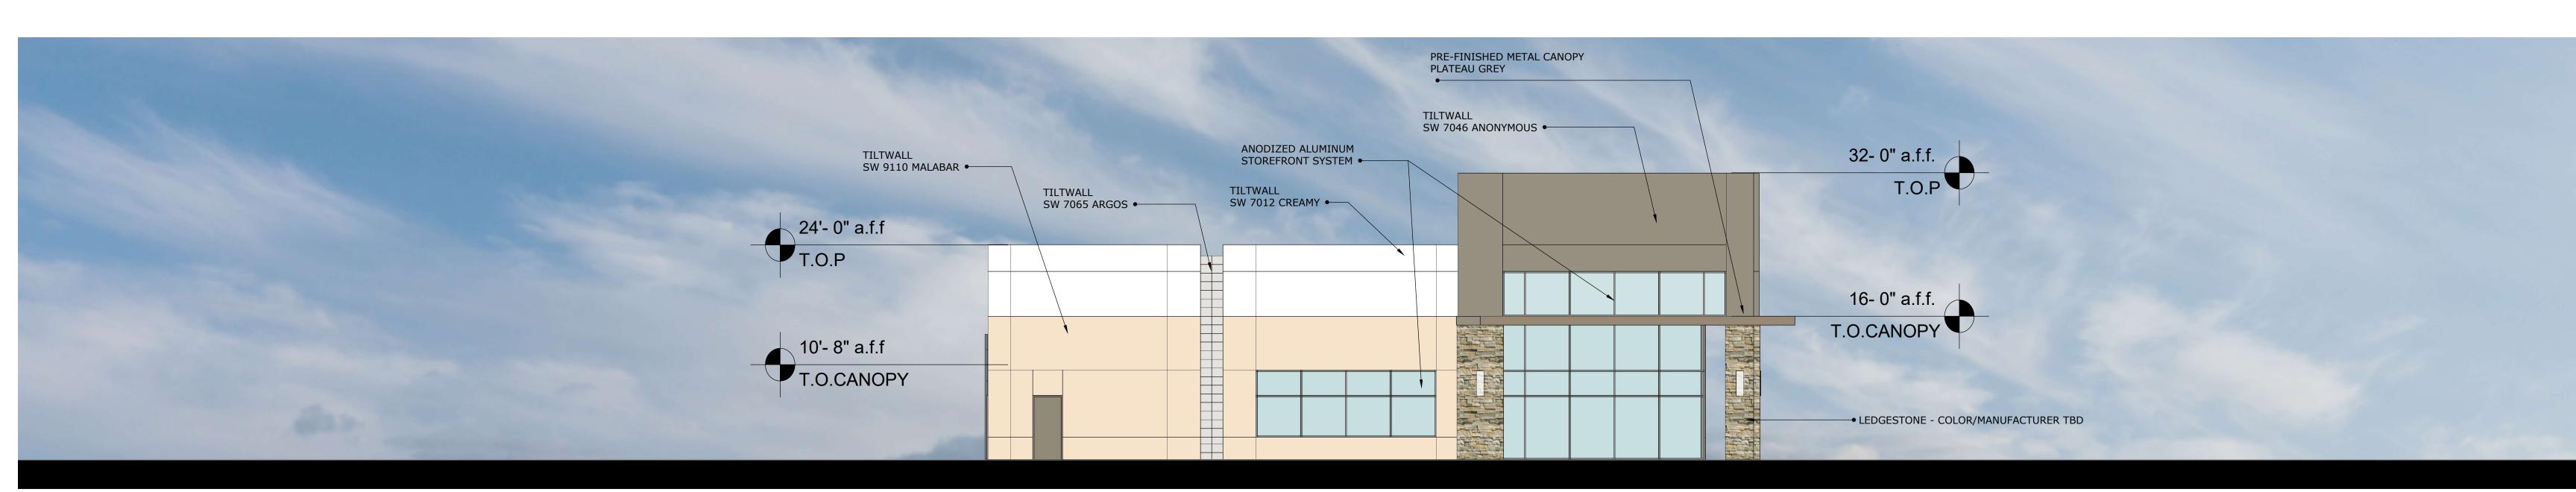


SOUTH

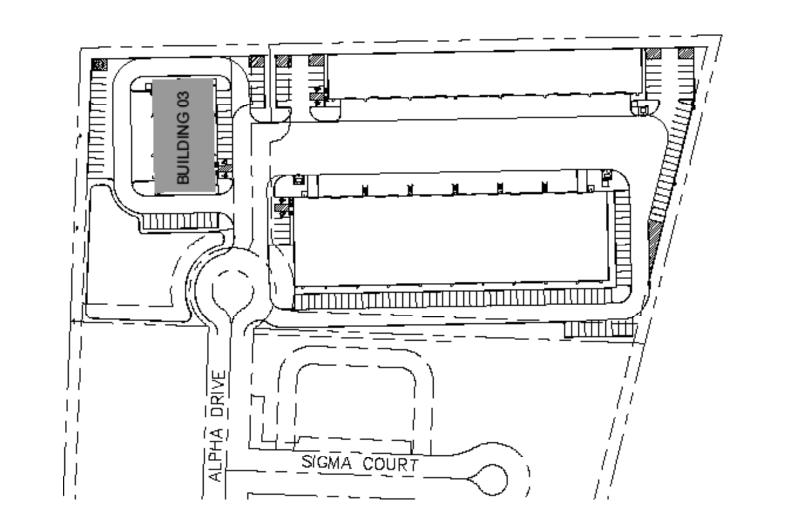


BLDG 3				
	METAL CANOPY	MASONRY	PRIMARY MASONRY: PAINTED CONCRETE TILT WALL	FAÇADE TOTAL SF (EXCLUSIVE OF DOOR WINDOWS)
NORTH	35	136	1,495	1,666
SOUTH	35	136	1,495	1,666
EAST	74	230	2,592	2,896
WEST	0	0	3,000	3,000
				TOTAL
SF of Materials	144	502	9 593	
			8,582	9,228
Percentage of Material	2%	5%	93%	100%

ÓBRIEN


**BUILDING ELEVATIONS** 

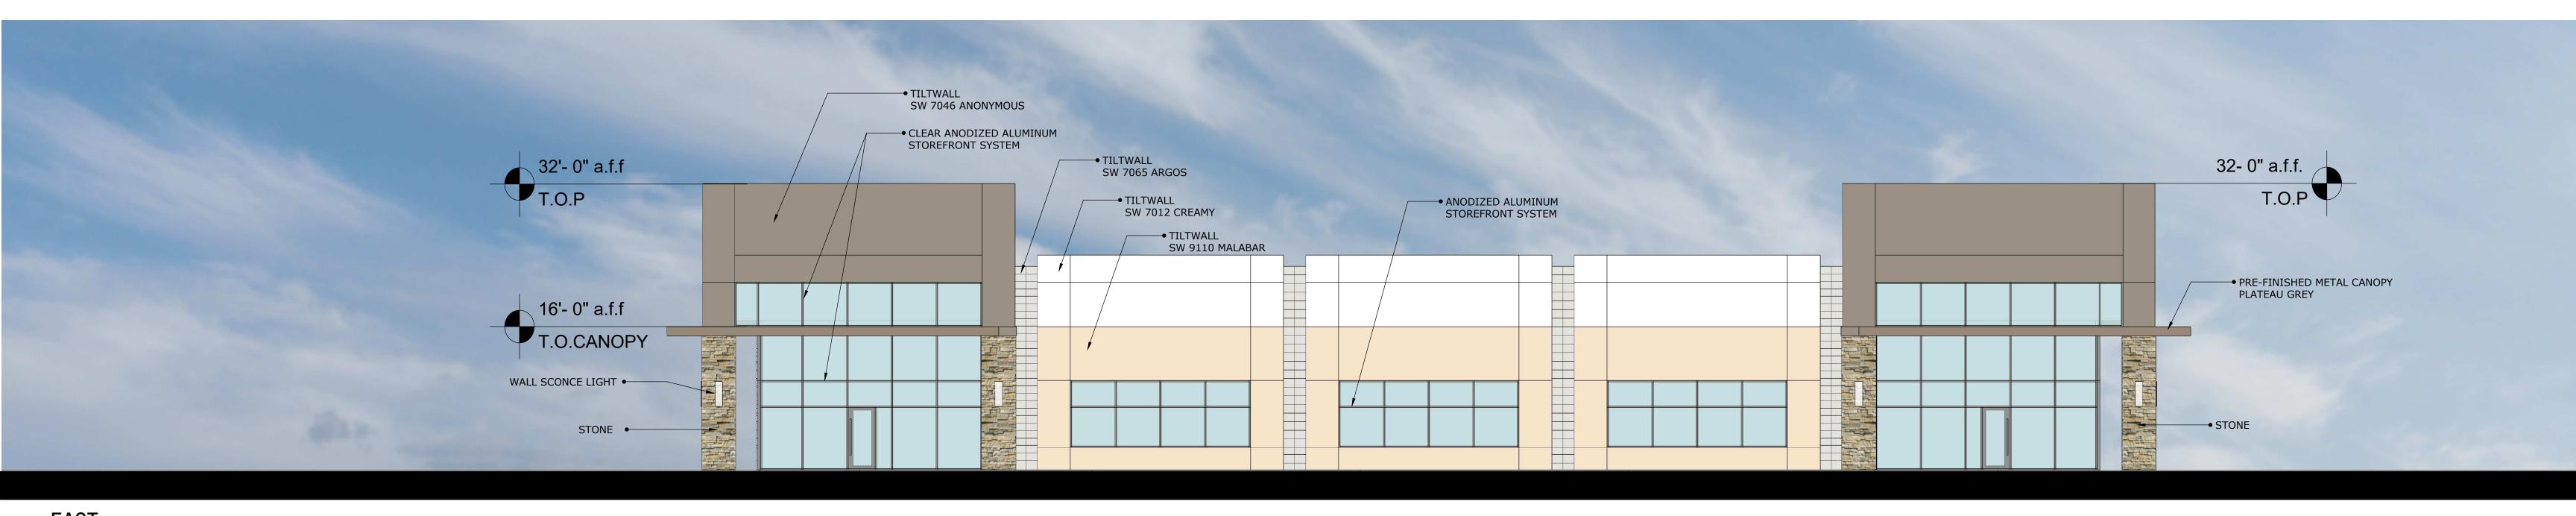

EAST

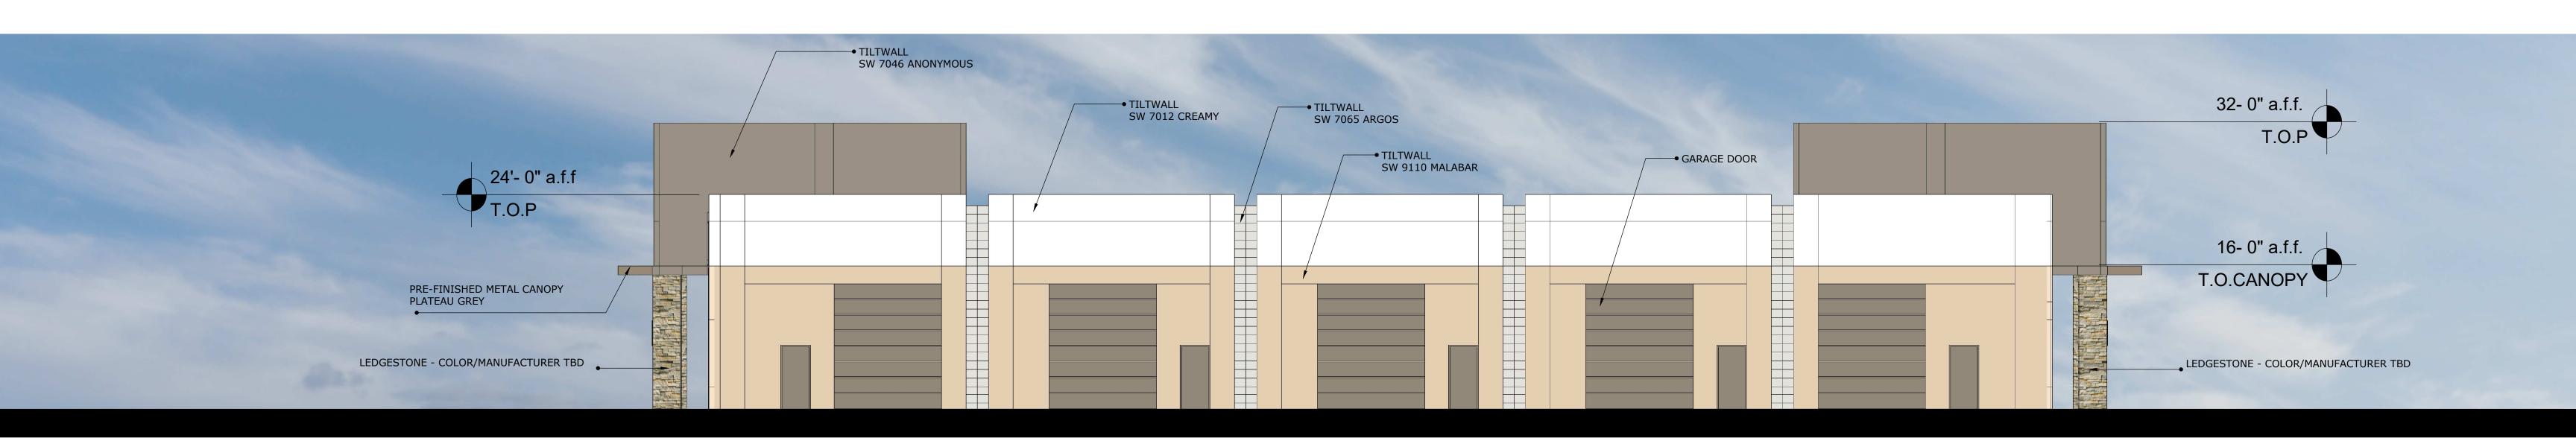


WEST

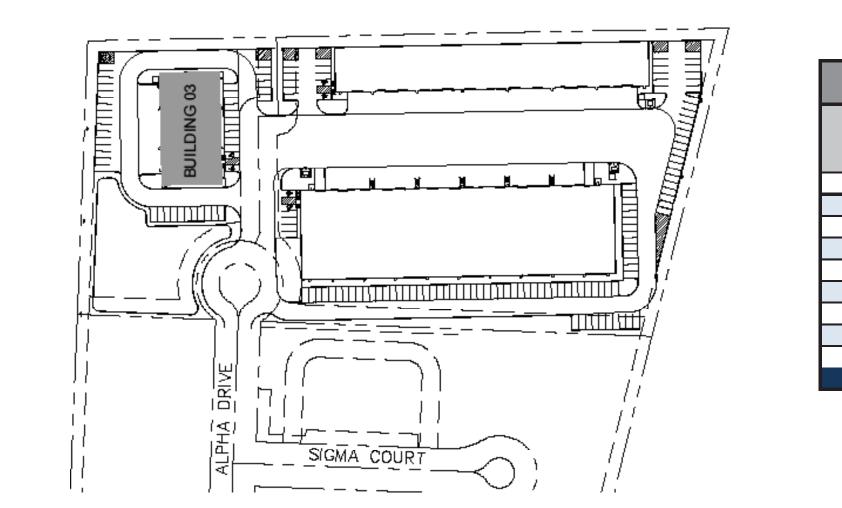

BLDG 3				
	METAL CANOPY	MASONRY	PRIMARY MASONRY: PAINTED CONCRETE TILT WALL	(EXC
NORTH	35	136	1,495	
SOUTH	35	136	1,495	
EAST	74	230	2,592	
WEST	0	0	3,000	
SF of Materials	144	502	8,582	
Percentage of Material	2%	5%	93%	

Y:	FAÇADE TOTAL SF
ΓE	(EXCLUSIVE OF DOORS &
	WINDOWS)
	1,666
	1,666
	2,896
	3,000
	TOTAL
	9,228
	100%

URBAN INDUSTRIAL CENTER - BLDG 3

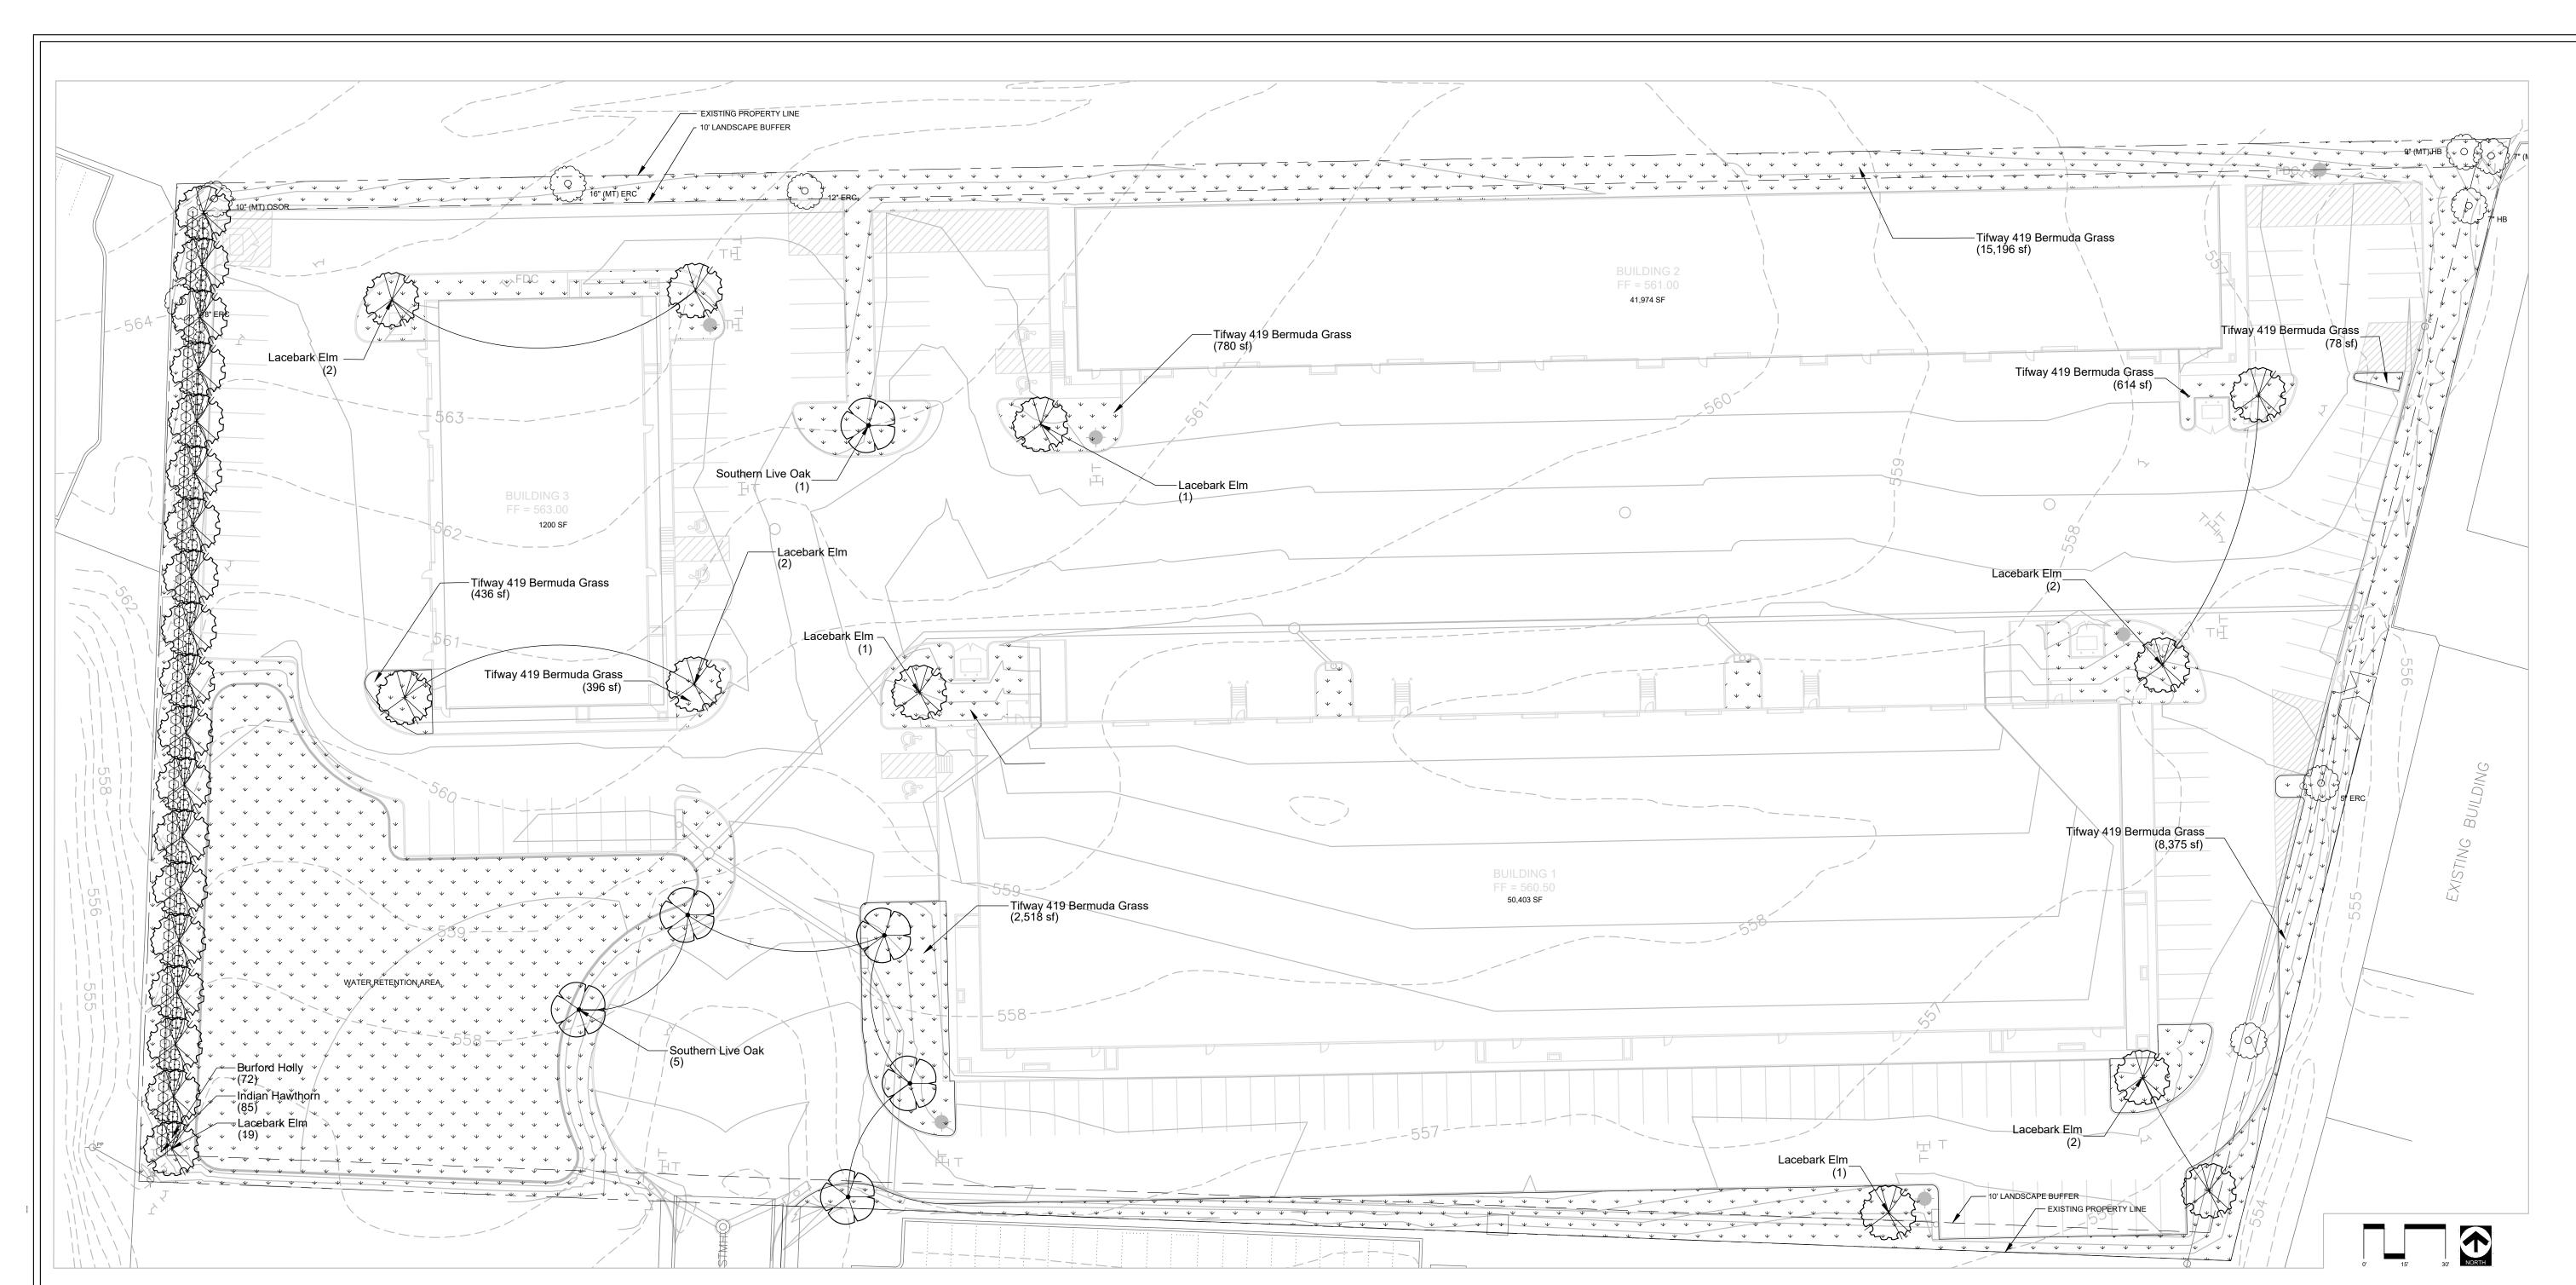

## PLANT SCHEDULE

TREES	BOTANICAL / COMMON NAME	CONT	CAL	HT	SPD	QTY
	Quercus virginiana / Southern Live Oak	B & B	4" Cal	10`-12` Ht.	6`-8`	6
	Ulmus parvifolia / Lacebark Elm	B & B	4" Cal	10`-12` Ht.	6`-8`	30
SHRUBS	BOTANICAL / COMMON NAME	SIZE	HT	SPD		QTY
$\odot$	llex cornuta `Burfordii` / Burford Holly	5 gal	18"-24"	12"-18"		72
$\bigcirc$	Rhaphiolepis indica / Indian Hawthorn	5 gal	18"-24"	12"-18"		85
GROUND COVERS	BOTANICAL / COMMON NAME	CONT	SIZE			QTY
, , , , , , , , , , , , , , , , , , ,	Cynodon dactylon `Tifway 419` / Tifway 419 Bermuda Grass	SOLID SOD				61,952 sf

### **EXISTING TREES**

EXISTING TREE TO REMAIN

### LANDSCAPE REQUIREMENTS

LANDSCAPE REQUI	KEIVIEIV	113
REQUIRED LANDSCAPING		
ZONED LIGHT INDUSTRIAL	REQUIRED	PROVIDED
TOTAL LANDSCAPE AREA PROVIDED (%)	15% OF SITE	21% OF SITE
TOTAL LANDSCAPE AREA PROVIDED (SF)	45,869 SF	66,576 SF
TREE MITIGATION		
	REQUIRED	PROVIDED
MITIGATION REQUIREMENTS (inches)	59" CALIPER*	144" CALIPER
* See Sheet L 1.01 for calculations		
PARKING LOT LANDSCAPING		
	REQUIRED	PROVIDED
200 SF MIN/ 2 ROWS OR MORE		$\checkmark$
3 AREAS 200 FT/SQ X 3	600 SF	<b>√</b>
ONE TREE WITHIN 80' OF REQ. PARKING		✓
PERMIABLE LANDSCAPE PROVIDED		3,756 SF
1 TREE / 10 PARKING SPACES	16	16
	•	
SCREENING REQUIREMENTS		
	REQUIRED	PROVIDED
SCREEN TRASH AREAS	N/A	
SCREEN RESIDENTIAL OR MULTI-FAMILY	N/A	
STREET TREES		
	REQUIRED	PROVIDED
1 TREE /50' FRONTAGE	1	1
-		

### PLANTING NOTES

PREPARATION
LANDSCAPE CONTRACTOR SHALL BE RESPONSIBLE FOR VERIFYING THE CORRECT LOCATION OF ALL UNDERGROUND UTILITIES, PIPES, STRUCTURES, AND LINE RUNS IN THE FIELD PRIOR TO THE INSTALLATION OF ANY PLANT MATERIALS.

REFER TO PLANTING PLAN FOR PIANTING LOCATION AND PLANT MATERIAL LEGEND FOR SPECIFICATIONS. PLANT MATERIAL LOCATION TO BE STAKED IN THE FIELD AND APPROVED BY LANDSCAPE ARCHITECT PRIOR TO PLANTING.

LANDSCAPE CONTRACTOR SHALL BE RESPONSIBLE FOR ANY COORDINATION WITH OTHER CONTRACTORS ON SITE AS REQUIRED TO ACCOMPLISH ALL PLANTING OPERATIONS.

LANDSCAPE CONTRACTOR SHALL BE RESPONSIBLE FOR MAINTAINING ALL PLANTING BEDS IN A WEED AND DEBRIS FREE CONDITION AND SHALL ACCOMPLISH WATERING BY HAND AS DEEMED NECESSARY UNTIL SUBSTANTIAL COMPLETION AND ACCEPTANCE BY THE OWNER. THE CONTRACTOR SHALL MAINTAIN ALL WORK FOR A PERIOD OF 30 DAYS AFTER SUBSTANTIAL COMPLETION AND ACCEPTANCE.

VERIFICATION

LANDSCAPE CONTRACTOR SHALL BE RESPONSIBLE FOR ALL QUANTITIES PER DRAWINGS AND SPECIFICATION BY IANDSCAPE

ARCHITECT. PLANT QUANTITIES HAVE BEEN PROVIDED AS A CONVENIENCE ONLY AND SHALL NOT BE CONSIDERED ABSOLUTE.

LANDSCAPE ARCHITECT TO BE NOTIFIED IF DISCREPANCIES OCCUR. OTHERWISE, THE CONTRACTOR IS TO BID THEIR OWN

VERIFIED QUANTITIES PER LANDSCAPE PLAN.

PLANTING BEDS

ALL BED AREAS ARE TO BE FLUSH WITH FINISHED GRADE AT ADJACENT PAVEMENT. ALL BED AREAS SHALL BE ROTOTILLED TO BE A DEPTH OF 6", ADDING PREPARED SOIL MIXTURE AS REQUIRED.


MULCH
AFTER SETTLEMENT, ALL PLANTING BED MULCH DEPTHS SHALL BE A MIN. OF 3". ALL AREAS DISTURBED BY PLANTING
OPERATIONS SHALL BE FINE GRADED AND REPLANTED. MULCH SHALL BE TEXAS NATIVE CEDAR

STANDARDS
ALL PLANT MATERIAL SHALL CONFORM TO THE SIZES GIVEN IN THE PLANT LIST AND SHALL BE NURSERY GROWN IN ACCORDANCE WITH THE "AMERICAN STANDARD FOR NURSERY STOCK", LATEST EDITION. ALL PLANTING SHALL BE IN ACCORDANCE WITH STANDARD AMERICAN ASSOCIATION OF NURSERYMEN PROCEDURES AND SPECIFICATIONS.

PROTECTED TREES
PROTECTED TREES SHALL BE MARKED AND THE DRIP LINE OF SAID TREES SHALL BE PROTECTED PRIOR TO AND DURING ALL CONSTRUCTION, INCLUDING EARTHWORK.

IRRIGATION
IRRIGATION WILL MEET ALL TCEQ AND UDC REQUIREMENTS.

\*\*NO TREES SHALL BE PLANTED WITHIN 5' OF UTILITIES\*\*

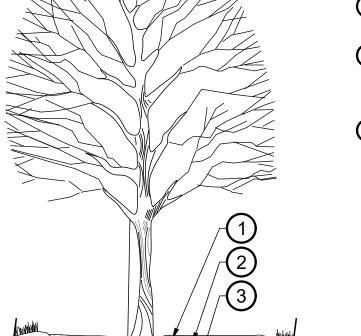

**NEW TREE PLANTING** 

— NEVER CUT LEADER

KEY:
(3) ARBOR STAKES. INSTAL

(3) ARBOR STAKES. INSTALL PER MANUFACTURE'S SPECIFICATIONS

SPECIFIED MULCH - 3" MIN. DEPTH ENTIRE TREE BASIN

3 SET TOP OF ROOT BALL 3" ABOVE FINISH GRADE. BUILD 3" HT. SAUCER AROUND PLANTING PIT WITH TOPSOIL.
4 LIVING EARTH PLANTING MIX OR APPROVED EQUAL BY LANDSCAPE ARCHITECT. WATER AND TAMP TO

APPROVED EQUAL BY LANDSCAPE
ARCHITECT. WATER AND TAMP TO
REMOVE SIDE AND BOTTOM AIR
POCKETS 6" MIN.

5 UNCOMPACTED NATIVE SOIL/UNDISTURBED SUBGRADE

NOTE:
FOR BALL & BURLAP REMOVE
WIRE/TWINE FROM AROUND BURLAP,
FOLD TOP THIRD DOWN OR
CUT/REMOVE PRIOR TO BACKFILL.

Project No.: 35989
Issued: 11-5-19
Drawn By: CAP
Checked By: MAW
Scale: AS SHOWN
Sheet Title

LANDSCAPE PLAN

1.20

L 2.01

SHEET SIZE: 24" x 36" | Sheet Number


No. Date Description

Ind

THE SEAL APPEARING ON THIS DOCUMENT WAS AUTHORIZED BY MICHAEL A. WILSON, R. LA. #3068 ON 5 NOV 2019.

ALTERATION OF A SEALED DOCUMENT WITHOUT PROPER NOTIFICATION TO THE RESPONSIBLE LANDSCAPE ARCHITECT IS AN OFFENSE UNDER TITLE 22, TEXAS ADMINISTRATIVE CODE. CHAPTER 3 LANDSCAPE ARCHITECT. THE RECORD COPY OF THID DRAWING IS ON FILE AT THE OFFICES OF HALFF ASSOCIATES, INC. 4000 FOSSIL CREEK BLVD. FORT WORTH, TX 76137-2720.

TEPE FIRM #F-312

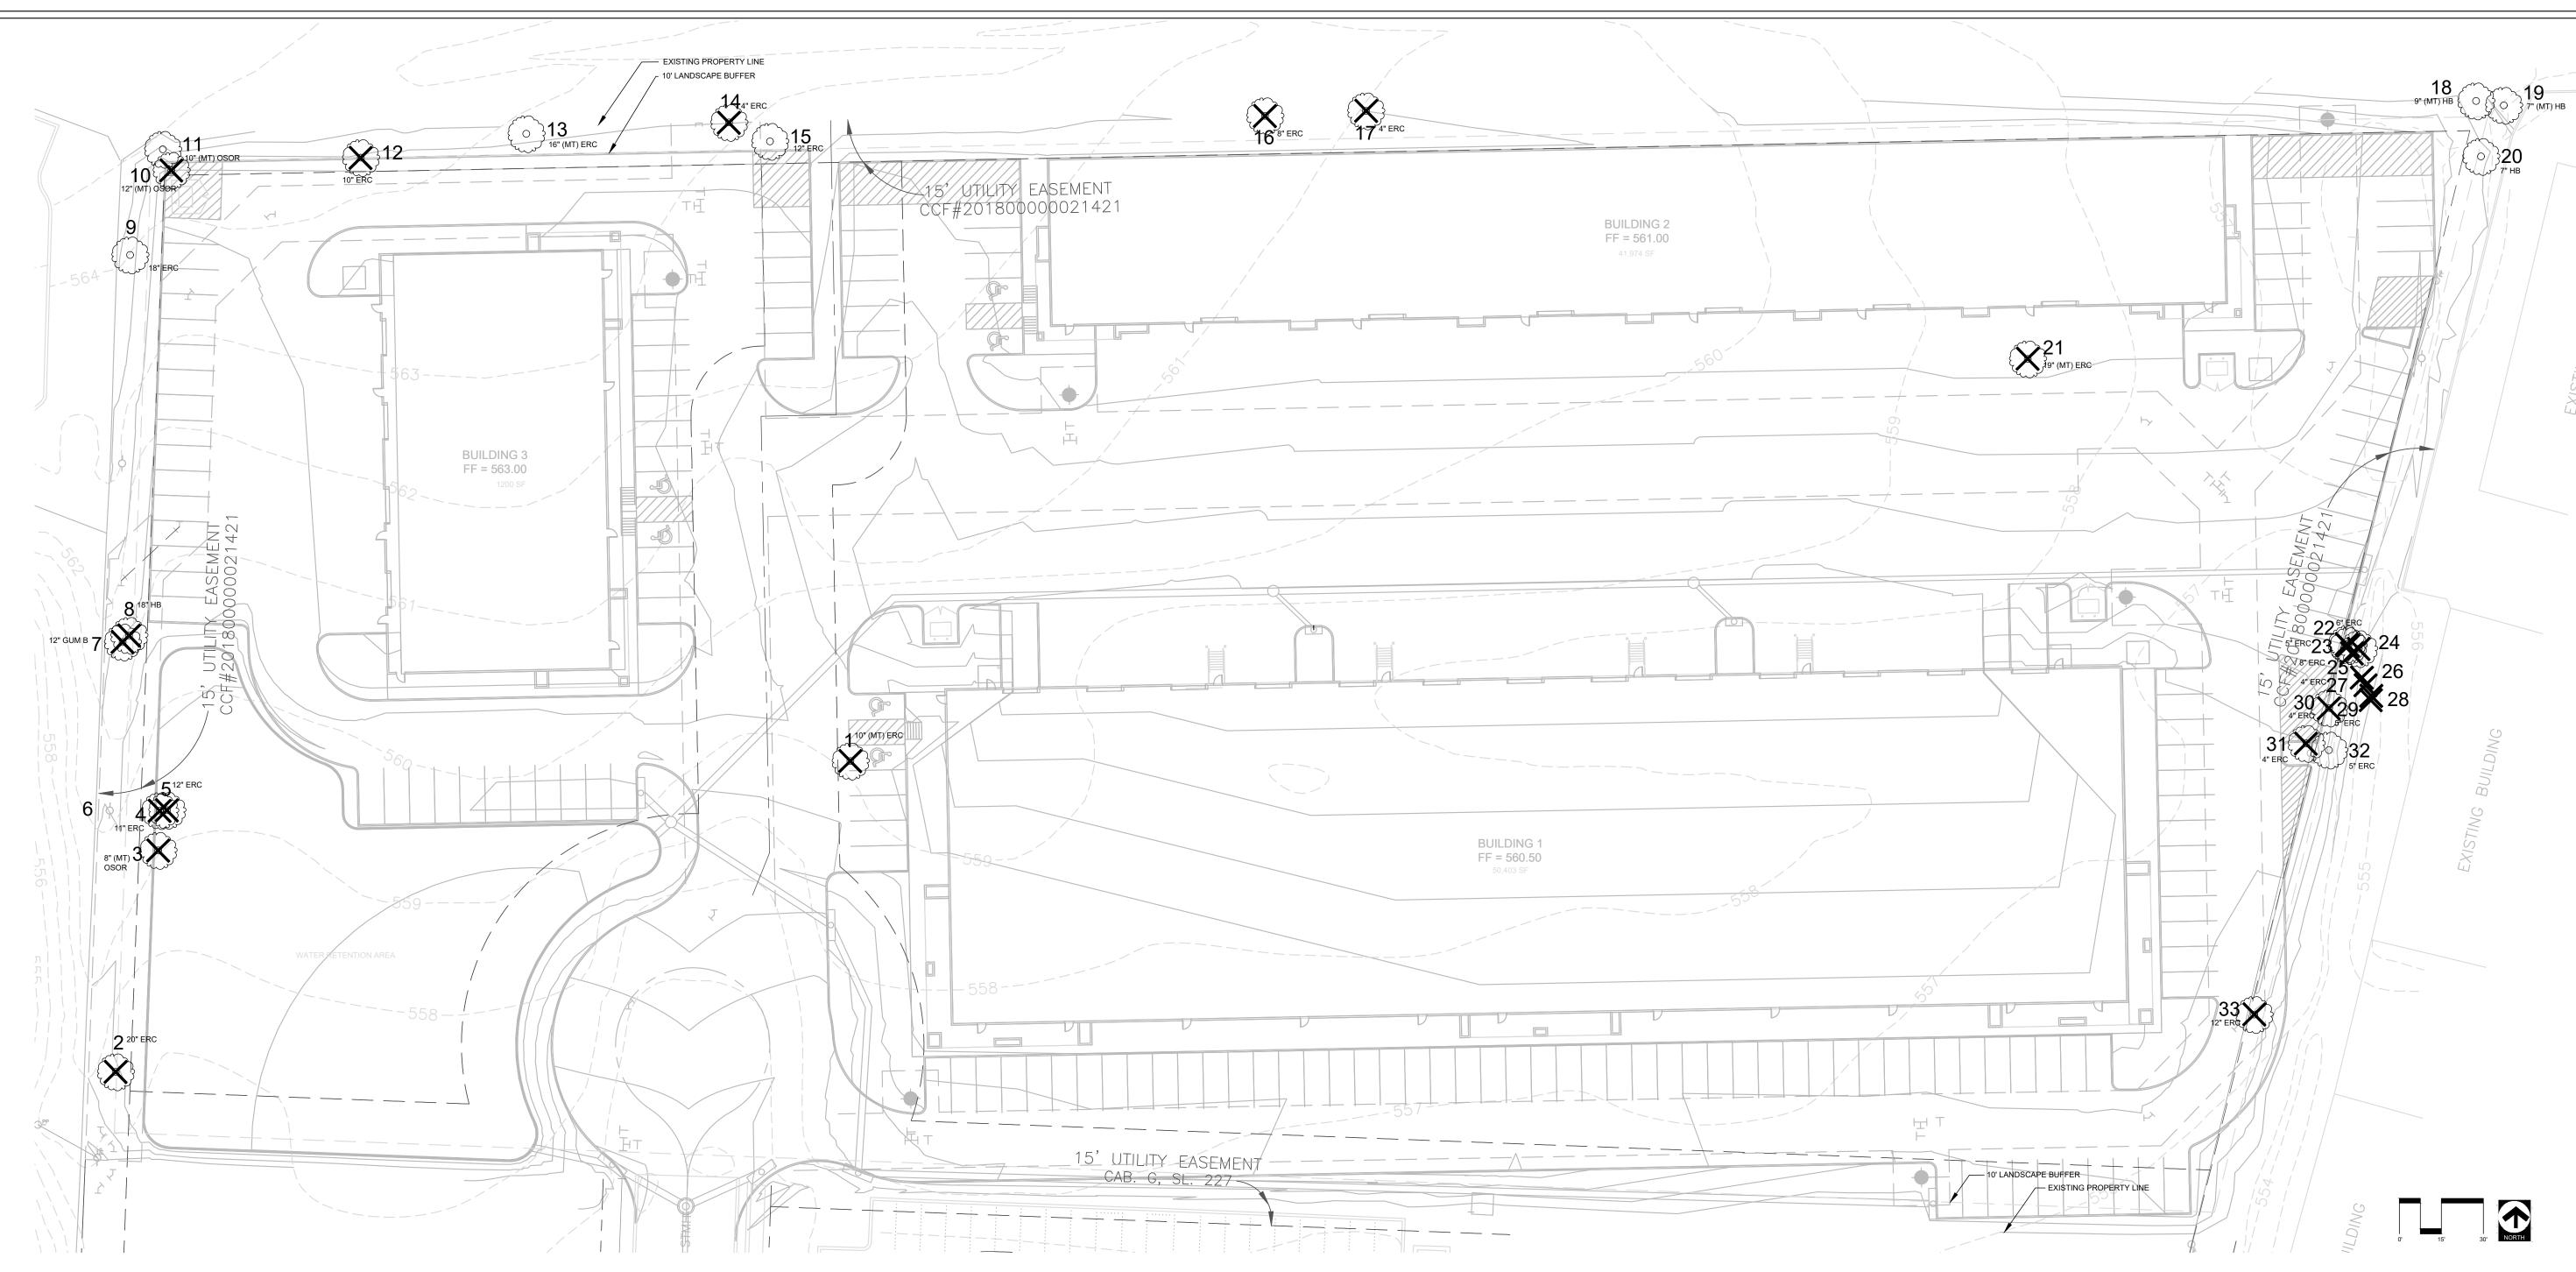

### TREE INVENTORY / MITIGATION

TREE#	SPECIES	SIZE (inches)	CLASSIFICATION	STATUS	REQ. MITIGATION (Inches
1	EASTERN RED CEDAR	10 MULTI-TK	NON-PROTECTED	REMOVE	
2	EASTERN RED CEDAR	20	SECONDARY	REMOVE	10
3	OSAGE ORANGE	8 MULTI-TK	NON-PROTECTED	REMOVE	
4	EASTERN RED CEDAR	11	SECONDARY	REMOVE	6
5	EASTERN RED CEDAR	12	SECONDARY	REMOVE	6
6	HACKBERRY	14 MULTI-TK	SECONDARY	PRESERVE	
7	GUM BUMILIA	12	PROTECTED	REMOVE	12
8	HACKBERRY	18	SECONDARY	REMOVE	9
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33	EASTERN RED CEDAR	12	SECONDARY	REMOVE	6
TOTAL					59

**EXISTING TREES** 

**TREE MITIGATION** 

REQUIRED TREES (inches)

PROVIDED TREES (inches)

\* See Sheet L 2.01 for Planting Locations


EXISTING TREE TO REMAIN

EXISTING TREE TO BE REMOVED

LANDSCAPE REQUIREMENTS

59" CALIPER\* 144" CALIPER

## PLAN VIEW

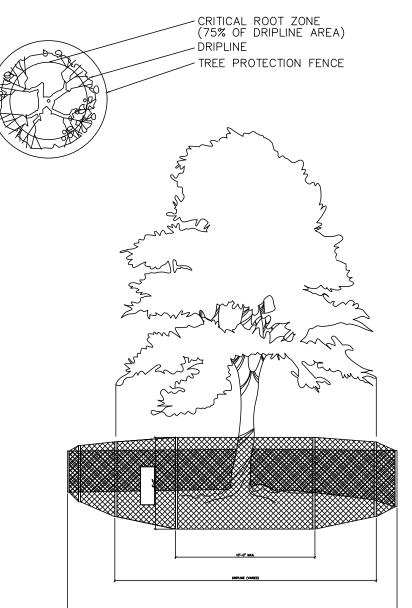

1 TREE PROTECTION DETAIL scale: n.t.s.

STANDARD PRESERVATION NOTES FOR TREE AND NATURAL AREA PROTECTION

soil build—up within tree drip lines.
5. Protective fences shall surround the trees or group of trees, and will be located no closer than the outermost limit of branches (drip line) plus an additional 2'-0" away from the limits of dripline. For natural areas, protective fences shall follow the Limit of Construction line, in order to prevent the following:

A. Soil compaction in the root zone area resulting from vehicular traffic or storage of equipment or materials;
B. Root zone disturbances due to grade changes (greater than 6 inches cut or fill), or trenching not reviewed and authorized by the City Parks Department;
C. Wounds to exposed roots, trunk or limbs by mechanical equipment;
D. Other activities detrimental to trees such as chemical storage, cement truck cleaning, and fires.

6. Exceptions to installing fences at tree drip lines may be permitted in the following cases:

A. Where there is to be an approved grade change, impermeable paving surface, tree well, or other such site development, erect the fence approximately 2 to 4 feet beyond the area disturbed;
B. Where permeable paving is to be installed within a tree's drip line, erect the fence at the outer limits of the

All trees and natural areas shown on plan to be preserved shall be protected during construction with temporary fencing and other measures as needed which may include retaining walls, pruning of limbs, roots, etc.
 Protective fences shall be erected according to City Standards for Tree Protection.
 Protective fences shall be installed prior to the start of any site preparation work (clearing, grubbing or grading), and shall be maintained throughout all phases of the construction project.
 Erosion and sedimentation control barriers shall be installed or maintained in a manner which does not result in soil build—up within tree drip lines.

B. Where permeable paving is to be installed within a tree's drip line, erect the fence at the outer limits of the permeable paving area (prior to site grading so that this area is graded separately by hand prior to paving installation to minimized root damage);

C. Where trees are close to proposed buildings, erect the fence to allow root pruning in the work space between the fence and the building, prior to disturbance. The fence can be erected at the point of root pruning;

D. Where there are severe space constraints due to tract size, or other special requirements, contact an Arborist to discuss alternatives.

Special Note: Exceptions are permitted for areas outside the critical root zone. No disturbances are permitted within the critical root zone (75% of the dripline area). For the protection of natural areas, no exceptions to installing fences at the Limit`of Construction line will be permitted, and no silting of stock piling of material or dirt is allowed around trees.

allowed around trees.

7. Where any of the above exceptions result in a fence being closer than 4 feet to a tree trunk, protect the trunk with strapped—on planking to a height of 8 ft. in addition to the reduced fencing provided.

8. Trees approved for removal shall be removed in a manner which does not impact trees to be preserved.


9. Any roots exposed by construction activity shall be pruned flush with the soil. Backfill root areas with good quality top soil as soon as possible. If exposed root areas are not backfilled within 2 days, cover them with organic material in a manner which reduces soil temperature and minimizes water loss due to evaporation.

10. Trenching required for the installation of irrigation shall be placed as far from existing tree trunks as possible.

11. No landscape topsoil dressing greater than 2 inches shall be permitted within the drip line of trees. No soil or mulch is permitted on the root flare of any tree.

12. Limbing & pruning to provide clearance for structures, traffic and equipment shall take place before damage occurs.

13. All finished pruning shall be done according to recognized, approved standards of the industry (Reference the National Arborist Association Pruning Standards for Shade Trees).

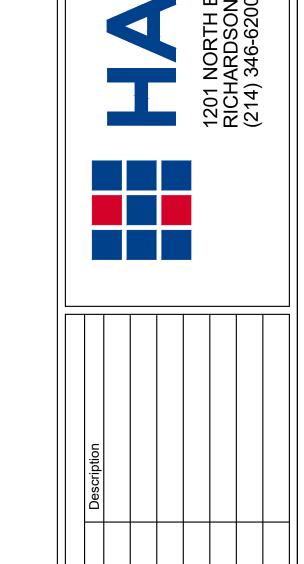

THE SEAL APPEARING ON THIS DOCUMENT WAS AUTHORIZE BY MICHAEL A. WILSON, R.L.A. #3068 ON 5 NOV 2019. ALTERATION OF A SEALED DOCUMENT WITHOUT PROPER NOTIFICATION TO THE RESPONSIBLE LANDSCAPE ARCHITEC

IS AN OFFENSE UNDER TITLE 22, TEXAS ADMINISTRATIVE CODE, CHAPTER 3 LANDSCAPE ARCHITECTS. THE RECORD COPY OF THIS PRAWING IS ON FILE AT THE OFFICES OF HALFF ASSOCIATES, INC. 4000 FOSSIL CREEK BLVD. FORT WORTH, TX 76137-2720. TBPE FIRM #F-312

Project No.: 35989

Scale:

Sheet Title

Issued: 11-5-19 Drawn By: CAP Checked By: MAW


AS SHOWN

TREESCAPE PLAN

L 1.01

Rockwall

SHEET SIZE: 24" x 36" | Sheet Number

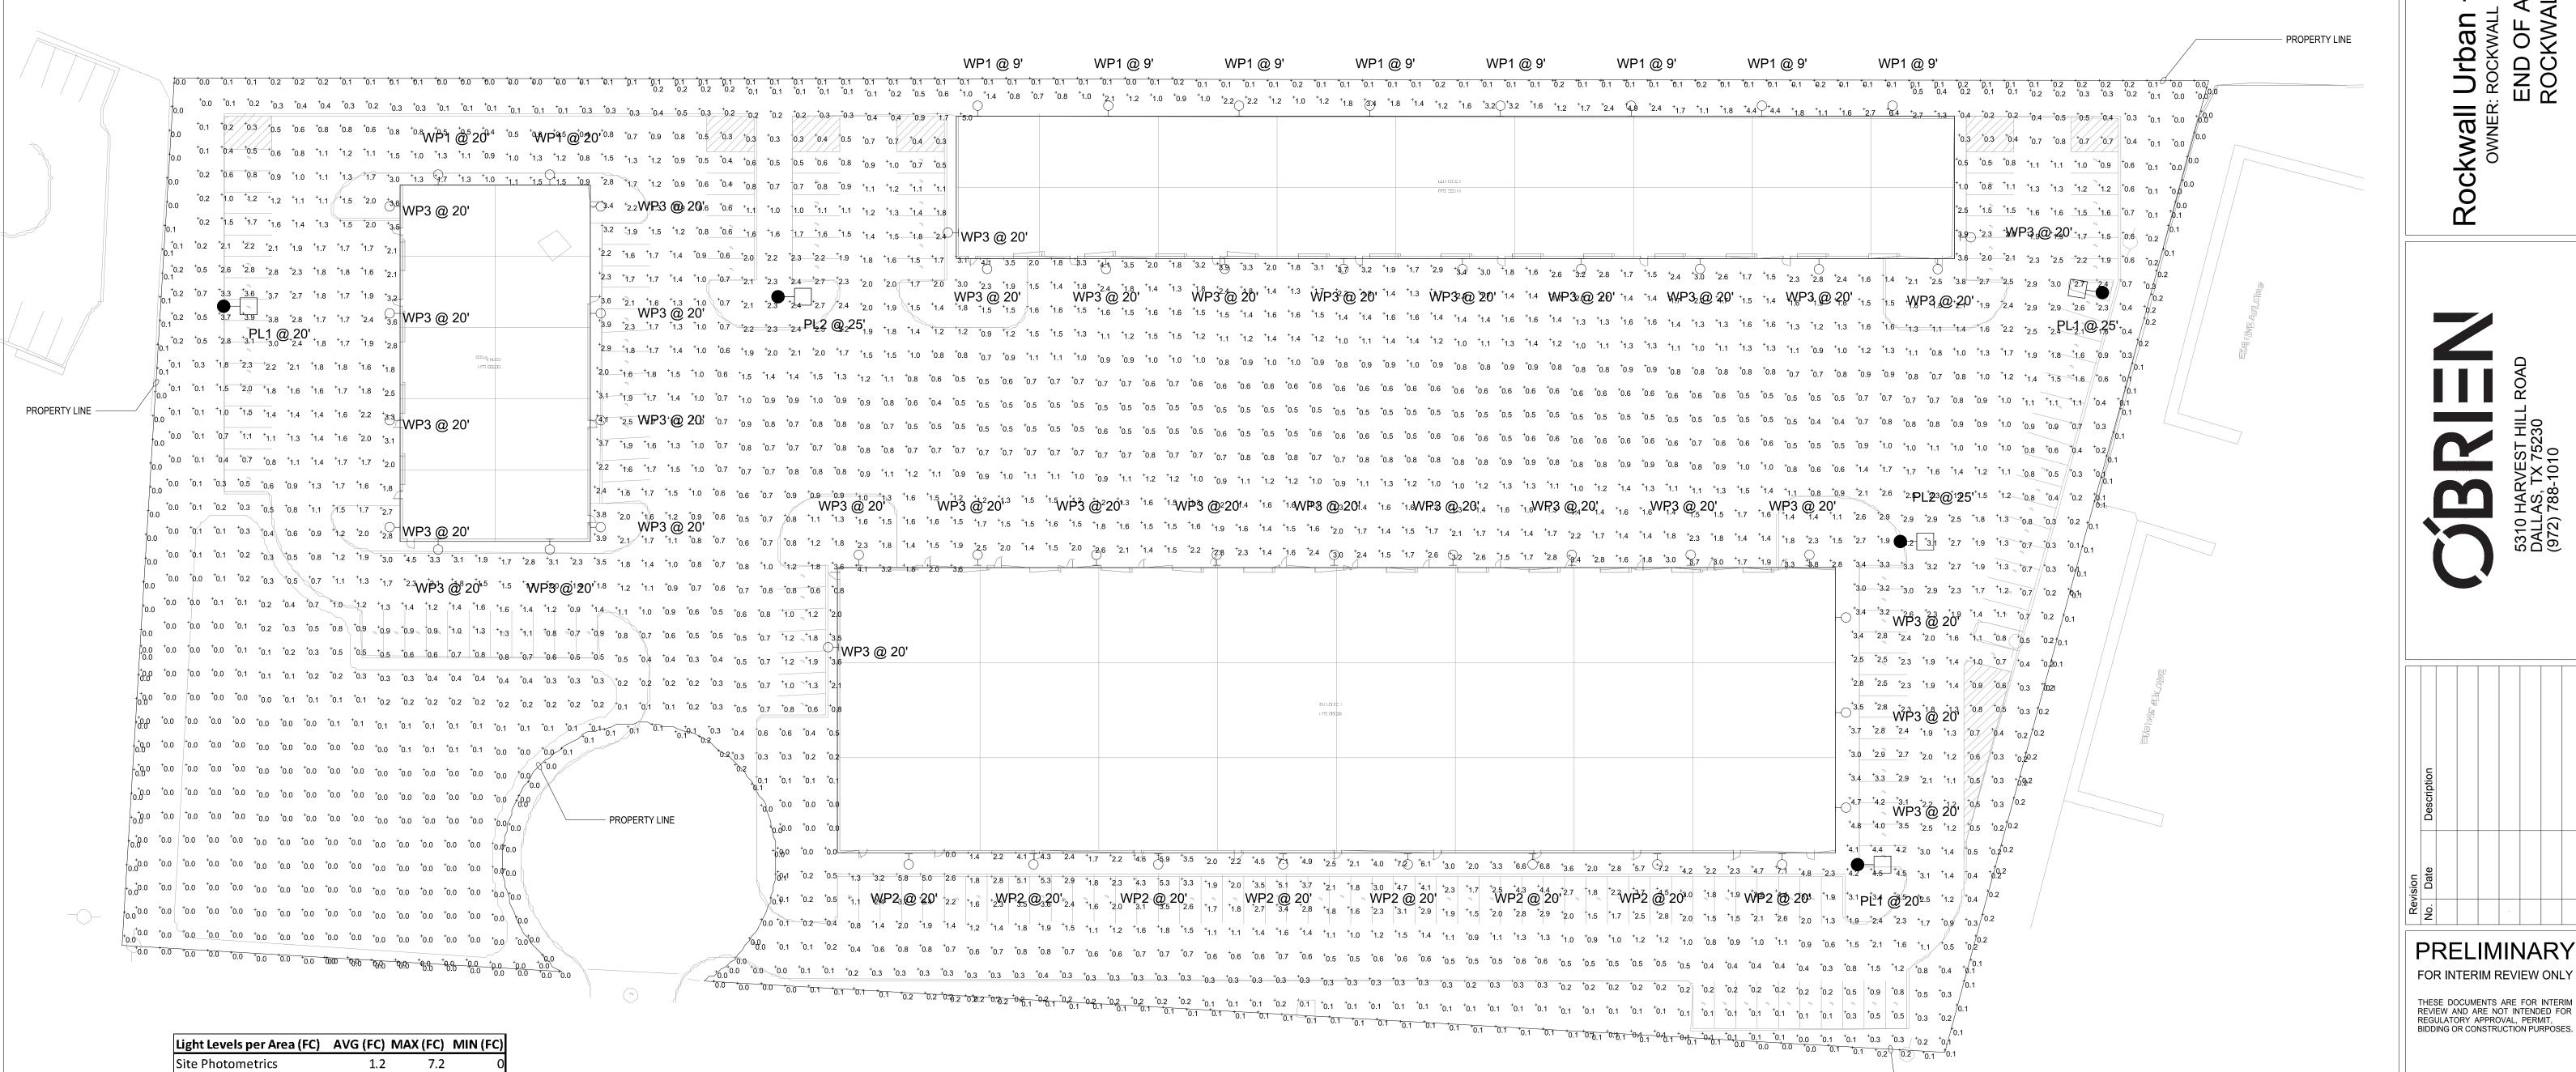

0.2

Description

WSR LED WITH P1-PERFORMANCE PACKAGE, 4000K, AND SR2 OPTIC TYPE WST LED Performance package 3 4000 K, visual comfort forward throw, MVOLT

WSR LED WITH P4-PERFORMANCE PACKAGE, 4000K, AND SR4 OPTIC TYPE

DSX0 LED P5 40K T2M MVOLT with houseside shield

DSX0 LED P6 40K T5M MVOLT with houseside shield

Lamp Lamp Lumens Watts

6609

6388

9550

11955

50

61

89

134

0.1

Along Property Line

Catalog Number

WSR LED P1 SR2 40K MVOLT

WST LED P3 40K VF MVOLT

WP3 WSR LED P4 SR4 40K MVOLT

PL1 DSX0 LED P5 40K T2M MVOLT HS

PL2 DSX0 LED P6 40K T5M MVOLT HS

SITE PHOTOMETRICS SCALE: 1/32" = 1'-0"



- PROPERTY LINE

17855 North Dallas Parkway • Suite 320 Dallas, TX, 75287 p. 469.385.1616 • f. 469.385.1615 Texas Registered Engineering Firm F-4990 Project Number:1930681 Drawn By:DNH Checked By:JW

SHEET SIZE: 24" x 36"

Sheet Number Case Number:

Sheet Title SITE

Project No.:

Checked By:

Issued: Drawn By:

JOSHUA WILEY

OCTOBER 2019


AS SHOWN

**PHOTOMETRICS** 

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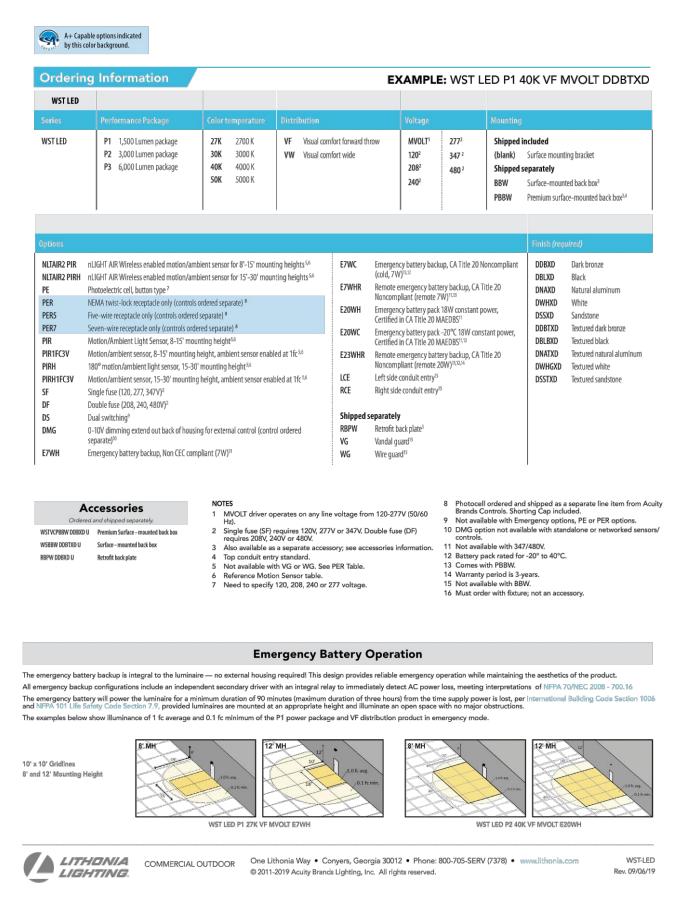
Center, LP.


Rockwall OWNER:

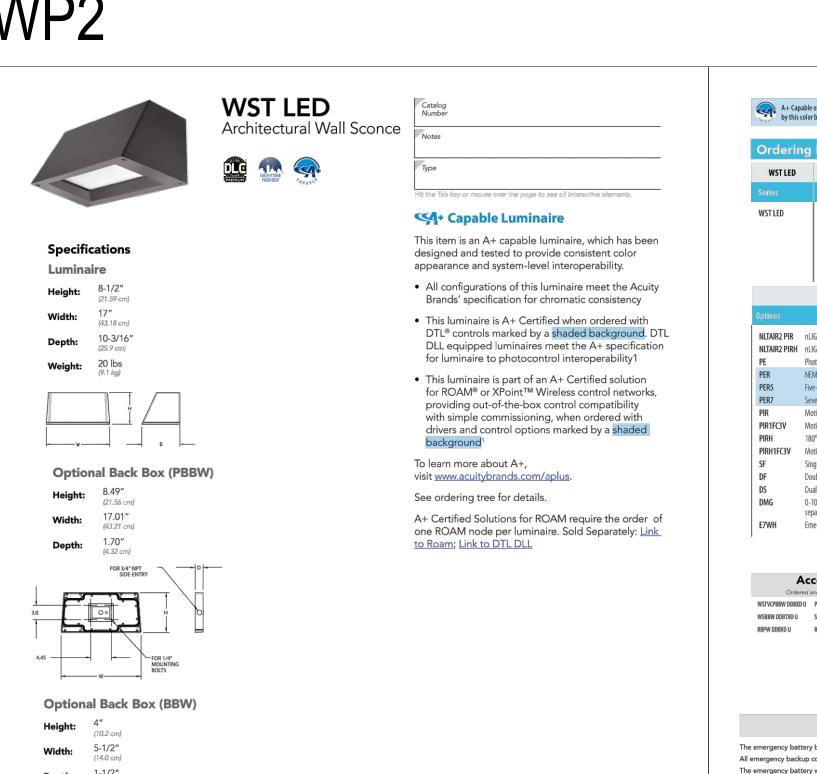


COMMERCIAL OUTDOOR


One Lithonia Way • Conyers, Georgia 30012 • Phone: 800-705-SERV (7378) • www.lithonia.com
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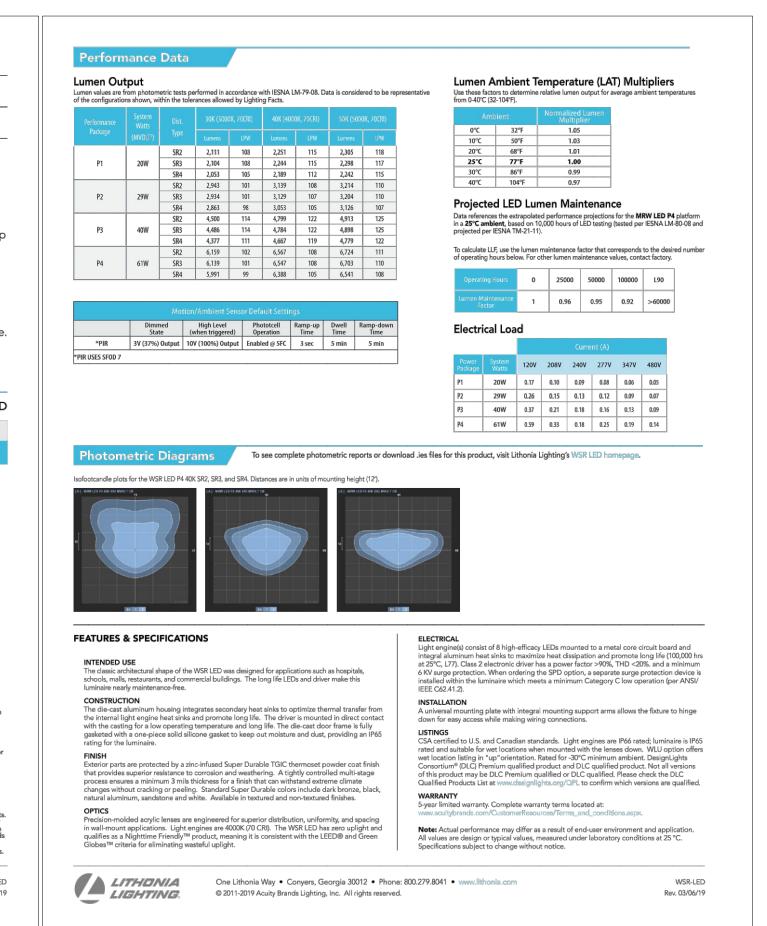




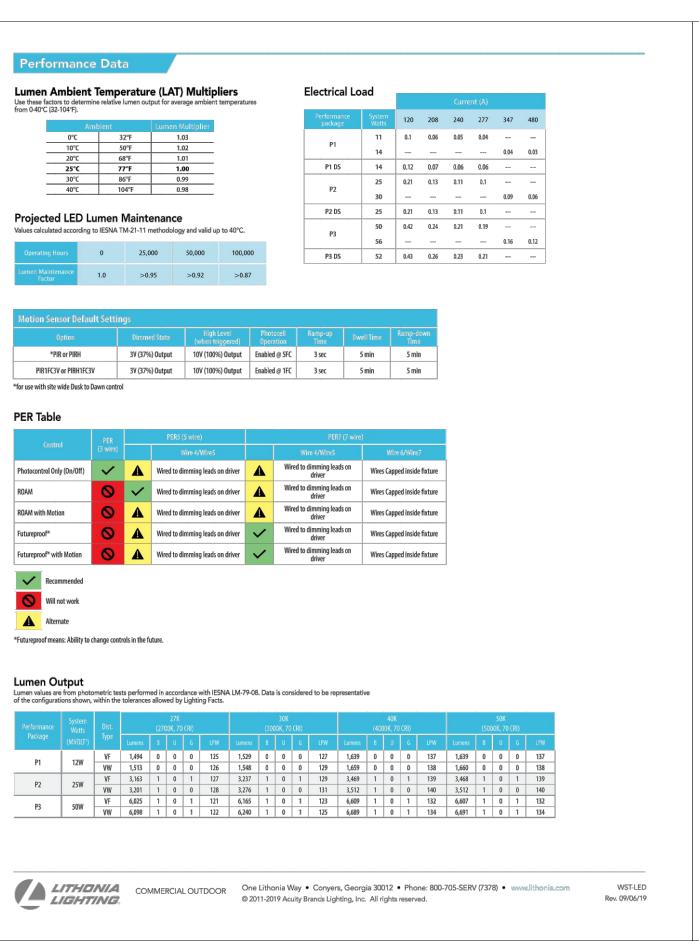

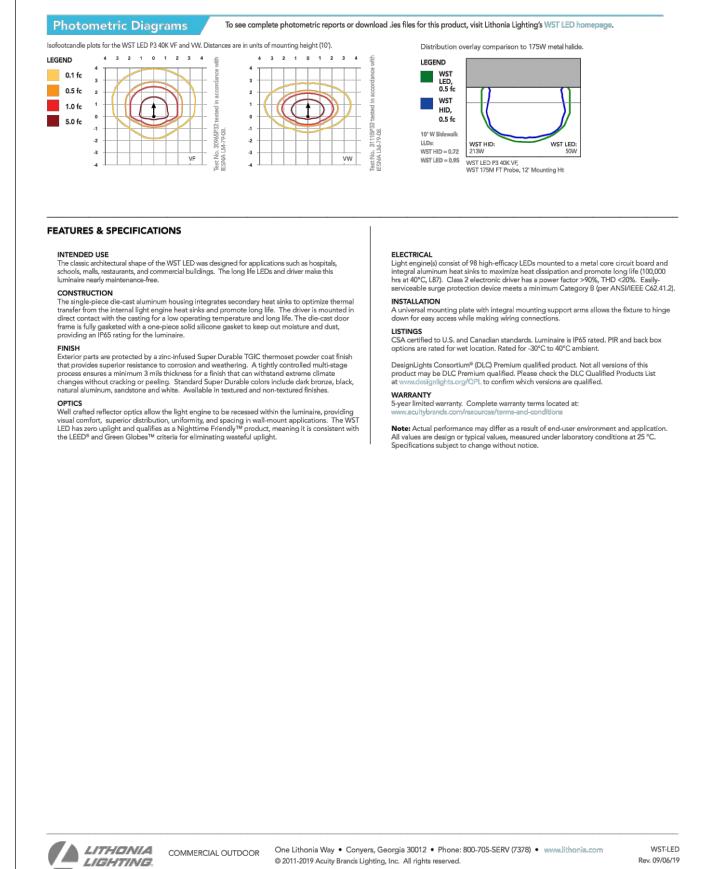Rev. 09/06/19



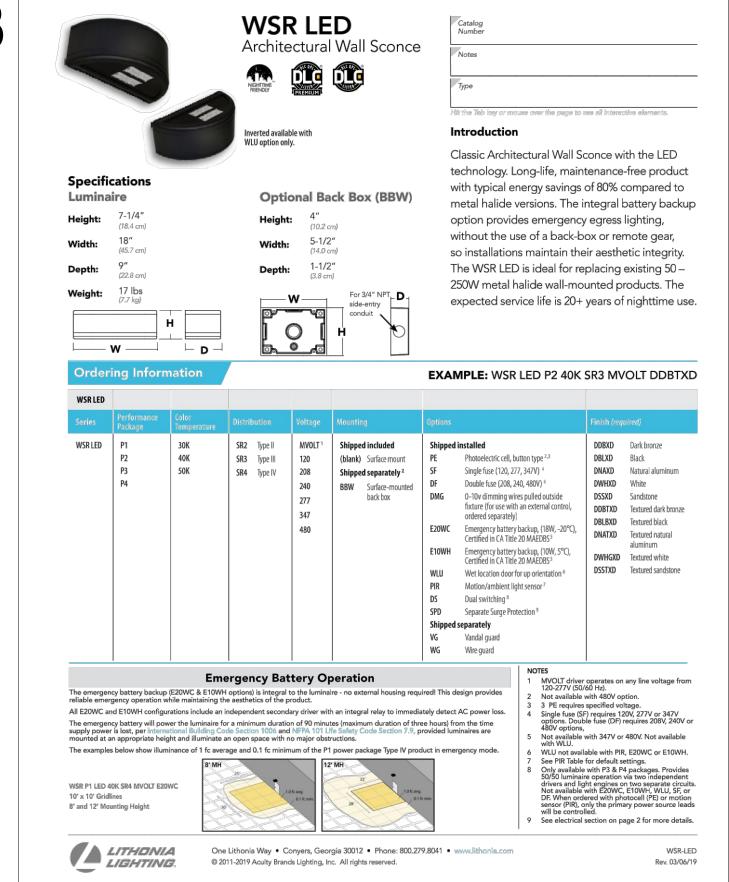



17855 North Dallas Parkway • Suite 320 Dallas, TX, 75287 p. 469.385.1616 • f. 469.385.1615 Texas Registered Engineering Firm F-4990 Project Number:1930681 Drawn By:DNH Checked By:JW

SHEET SIZE: 24" x 36"

Project No.: Issued: Drawn By: Checked By:

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OCTOBER 2019 Scale: AS SHOWN Sheet Title WP1,WP2,WP3 **CUTSHEETS** 

**PRELIMINARY** 

FOR INTERIM REVIEW ONLY

THESE DOCUMENTS ARE FOR INTERIM REVIEW AND ARE NOT INTENDED FOR REGULATORY APPROVAL, PERMIT.

BIDDING OR CONSTRUCTION PURPOSES.

Sheet Number Case Number:

LITHONIA LIGHTING

COMMERCIAL OUTDOOR

One Lithonia Way • Conyers, Georgia 30012 • Phone: 800.705.7378 • www.lithonia.com


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Jordan & Skala Engineers

lighting distribution, uniformity, and pole spacing. Light engines are available in 3000 K, 4000 K or 5000 K (70 CRI) configurations. The D-Series Size 0 has zero

Light engine(s) configurations consist of high-efficacy LEDs mounted to metal-core circuit boards to maximize heat dissipation and promote long life (up to L85/100,000 hours at 25°C). Class 1 electronic drivers are designed to have a power factor >90%, THD <20%, and an expected life of 100,000 hours with <1%

failure rate. Easily serviceable 10kV surge protection device meets a minimum

controls can be utilized via optional NEMA twist-lock photocell receptacles. Integrated motion sensors with on-board photocells feature field-adjustable programing and are suitable for mounting heights up to 30 feet.

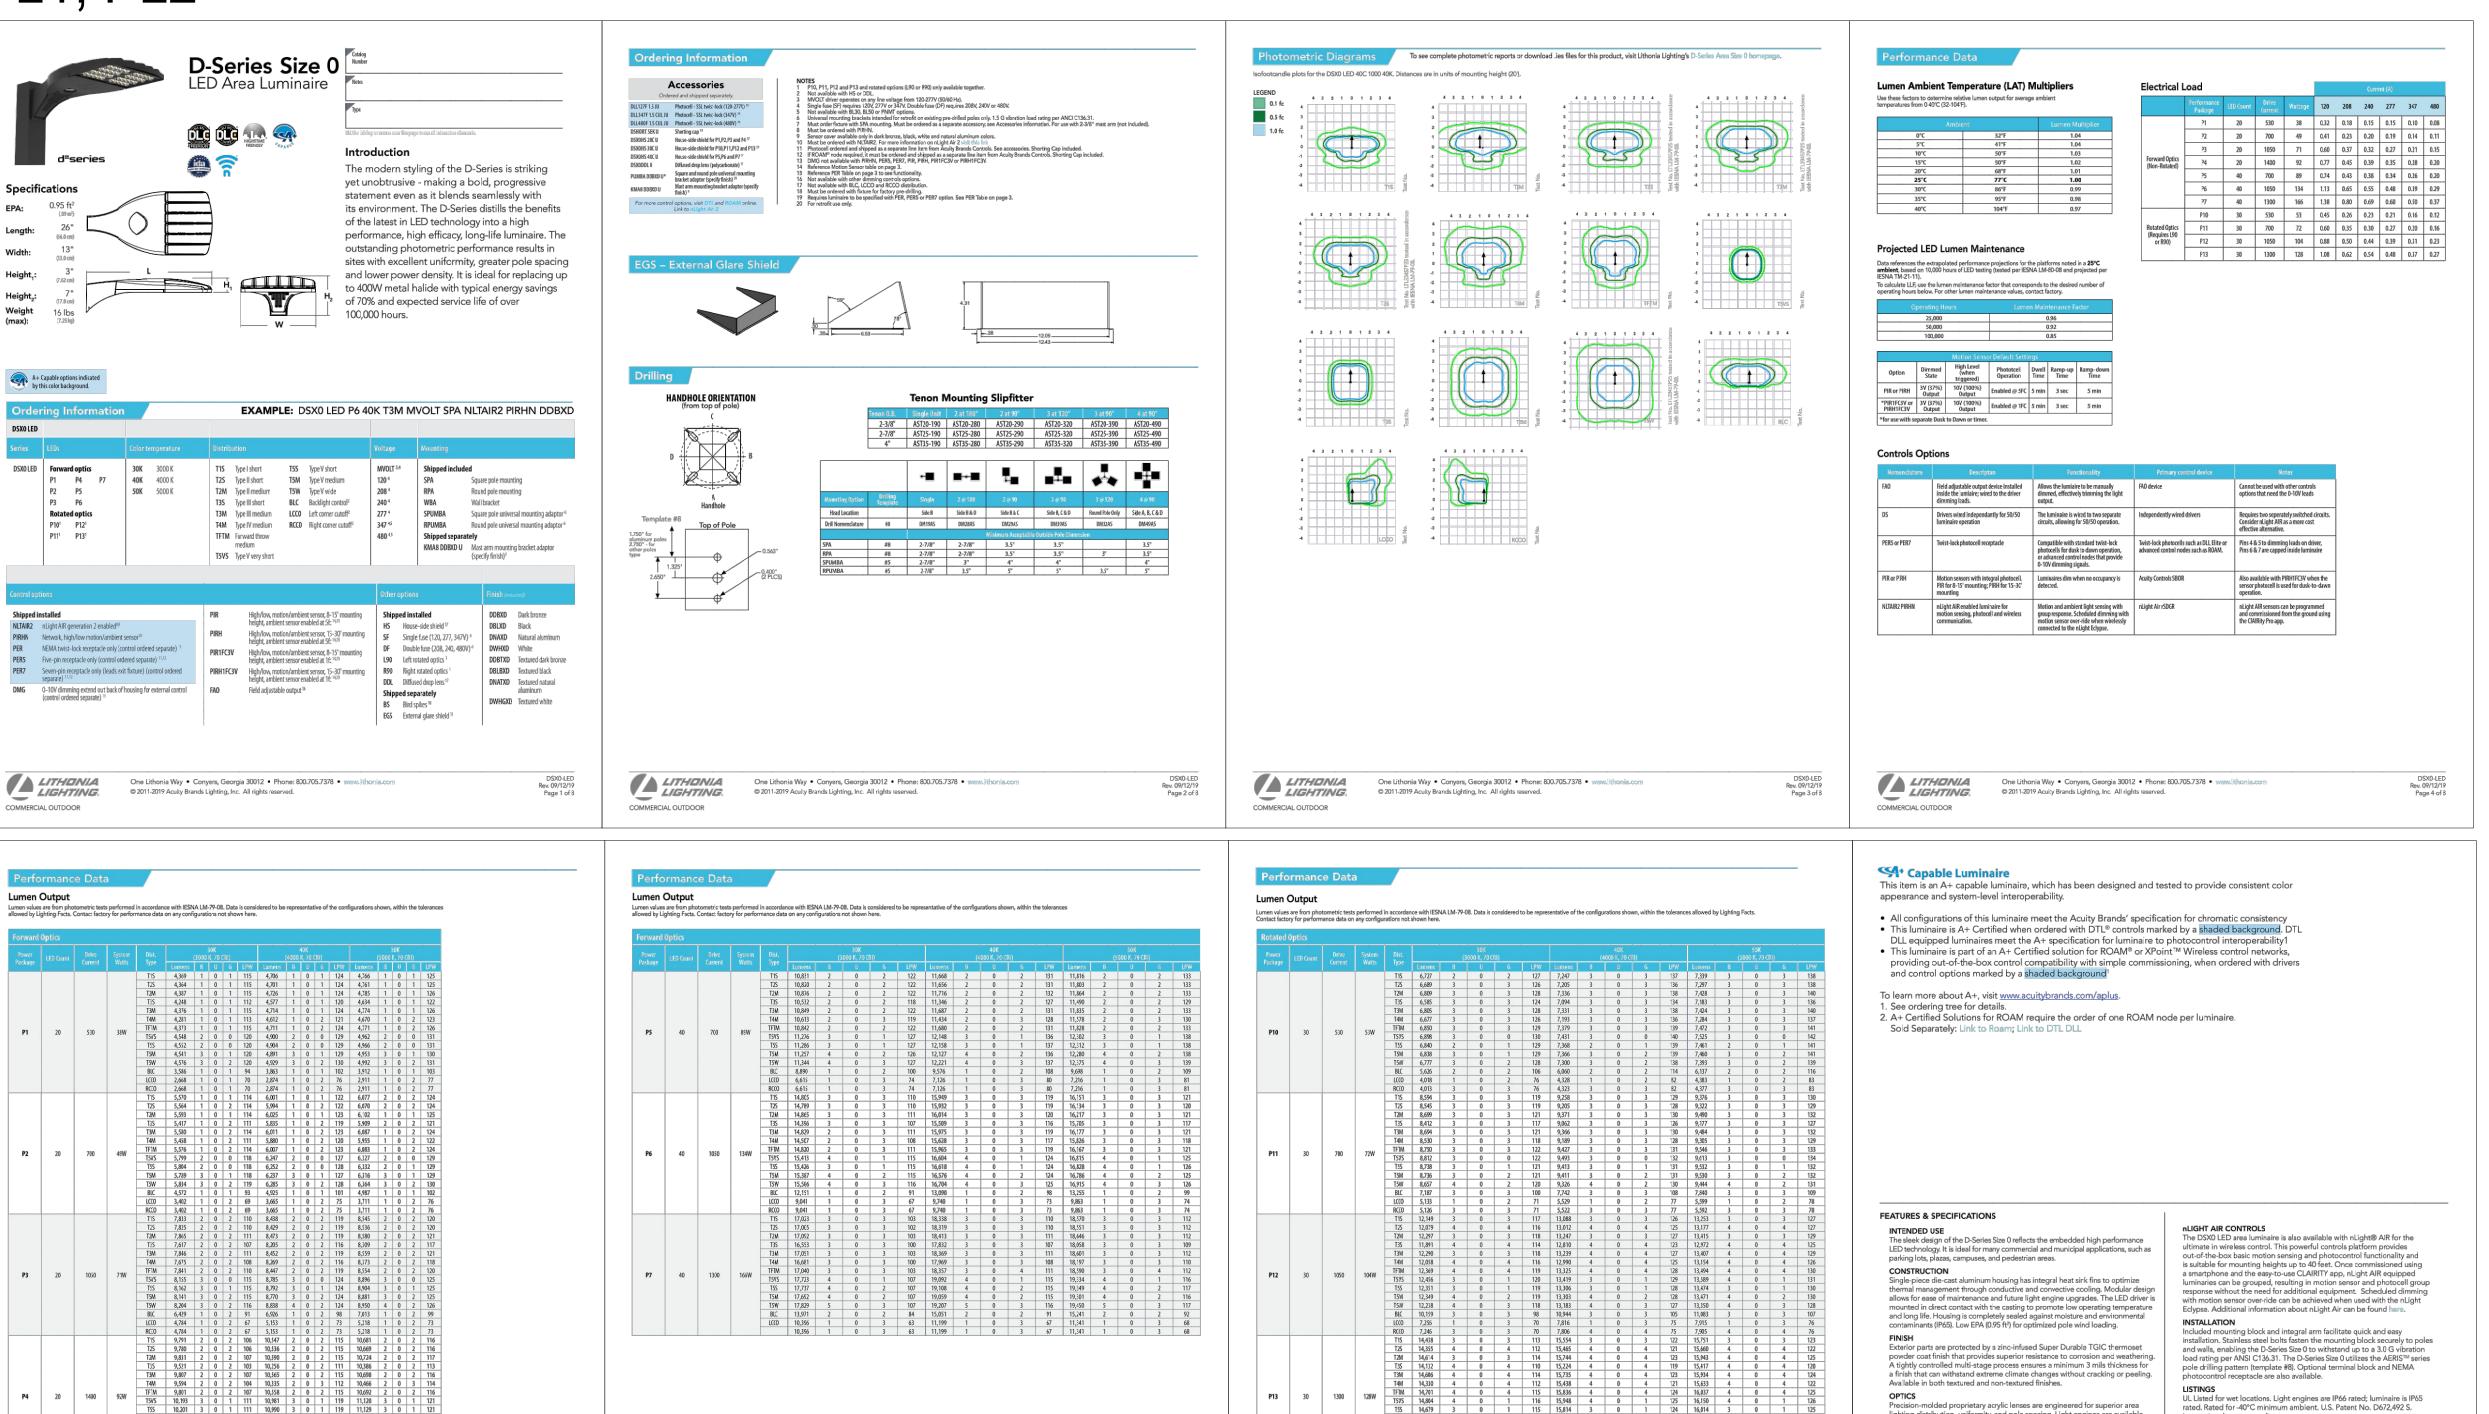The DSX0 LED area luminaire has a number of control options. Dusk to dawn

Category C Low operation (per ANSI/IEEE C62.41.2).

uplight and qualifies as a Nighttime Friendly™ product, meaning it is consiste with the LEED® and Green Globes™ criteria for eliminating wasteful uplight.

ELECTRICAL

STANDARD CONTROLS

LITHONIA LIGHTING

COMMERCIAL OUTDOOR

esignLights Consortium® (DLC) Premium qualified product and DLC

qualified product. Not all versions of this product may be DLC Premium qualified or DLC qualified. Please check the DLC Qualified Products List at www.designlights.org/QPL to confirm which versions are qualified.

International Dark-Sky Association (IDA) Fixture Seal of Approval (FSA) is

Note: Actual performance may differ as a result of end-user environment

DSX0-LED Rev. 09/12/19 Page 8 of 3

and application.
All values are design or typical values, measured under laboratory conditions at 25 °C.

Specifications subject to change without notice.

5-year limited warranty. Complete warranty terms located at:

WARRANTY

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available for all products on this page utilizing 3000K color temperature only.

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SHEET SIZE: 24" x 36"

**Sheet Number** 

Sheet Title PL 1, PL2

**PRELIMINARY** 

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BIDDING OR CONSTRUCTION PURPOSES.

JOSHUA WILEY 129688

19068

OCTOBER 2019

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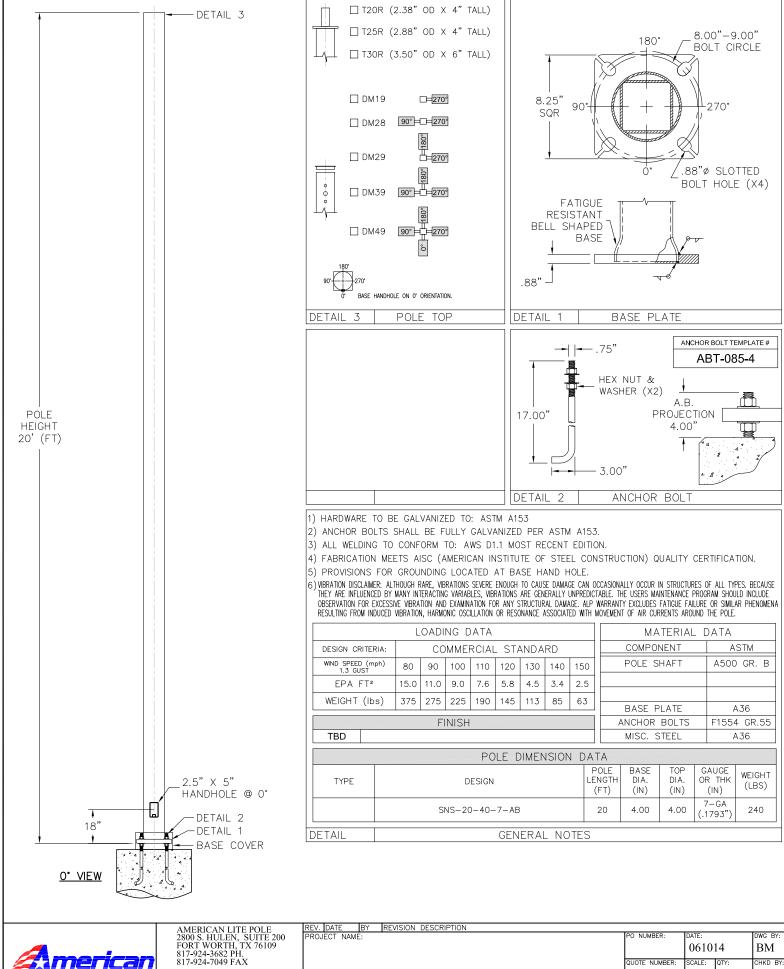
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END ROC

Project No.:

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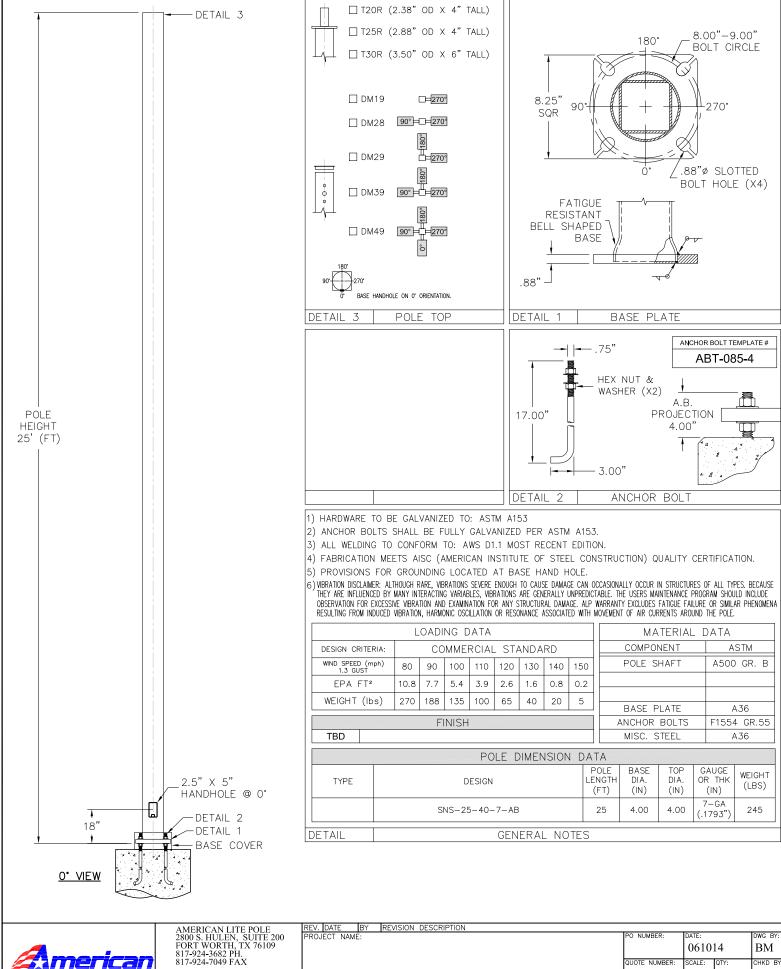


\*\* CONFIDENTIAL\*\*

THE INFORMATION CONTAINED IN THIS DRAWING IS PROPRIETARY AND CONFIDENTIAL UNAUTHORIZED DUPLICATION OR DISSEMINATION OF THIS DOCUMENT IS STRICTLY PROHIBITED WITHOUT PRIOR WRITTEN NOTICE FROM AMERICAN LITE POLE.

DESCRIPTION: SQUARE STRAIGHT STEEL ANCHOR BASE 20' x 4.0" x 7 GA

SCALE: CHKD BY QUOTE NUMBER NTS CKR RAWING NUMB SNS-20-40-7-AB





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DESCRIPTION: SQUARE STRAIGHT STEEL ANCHOR BASE 25' x 4.0" x 7 GA

SCALE: CHKD BY QUOTE NUMBER NTS CKR DRAWING NUMBE SNS-25-40-7-AB



November 7, 2019 AVO 35989

Ryan Miller, AICP Director of Planning Planning & Zoning City of Rockwall 385 S. Goliad St. Rockwall, TX 75087

RE: Requested Variance for Rockwall Urban + Industrial Center (SP2019-040)

Dear Mr. Miller:

On behalf of Reid Caldwell and Rockwall Urban Industrial, LP we request a variance to the following ordinances:

- Article V, District Development Standards, UDC Industrial Districts Section 5.01.A.1.a.1

   Stone. (A minimum 20% stone)
  - a. We added stone at the request of the ARB (10-29-19) with the caveat that the 20% requirement would not be enforced.
- 2. Article V, District Development Standards, UDC Industrial Districts Section 5.01.C.2 Building Articulation for Secondary Facades.
  - a. This is a worth request, because having a flat façade provides flexibility to the property owner and future tenants with the intended utilitarian use of these loading/dock sides of the buildings for future utility and door locations. These facades will still maintain the vertical articulation prescribed for secondary facades. The specific variance being requested is for the North façade of Building 1, a loading dock with overhead coiling doors and West façade of Building 3 with on grade loading overhead coiling doors, neither face a street. Also, for the North façade of Building 2 that faces a property line that is currently screened by trees on the adjacent property, and any likely future development on that property would likely require screening based on differing uses. This façade also does not face a street or is easily seen from any adjacent property.



- 3. 3.4A of the City of Rockwall Standards of Design and Construction "Detention ponds shall have a side slope 4:1 or flatter."
  - a. Based on maximizing the value of this property and the proposed site layout the detention pond will need to have retaining walls in order to meet the City of Rockwall drainage design. We believe this variance request is reasonable because it is consistent with the developments directly around our site. The site located directly to our south at the NE Corner of Alpha Dr. and Sigma Ct. has retaining walls built as part of its detention system.

Our compensatory measures are for the variance requests are as follows:

- 1. Stone was added to the façade after not originally being included and based on ARB comments on (10-29-19) the 20% requirement would not be enforced.
- 2. The landscape plan as shown is at 21% coverage, which is over the minimum of 15%.
- 3. Landscape screening will be added to the detention pond to screen along Alpha Drive.

If there are any questions, please don't hesitate to contact me.

Sincerely,

Matthew Gardner, P.E.


Civil Engineer


mgardner@halff.com

214-346-6308

HALFF ASSOCIATES, INC.


Matthew Sandner

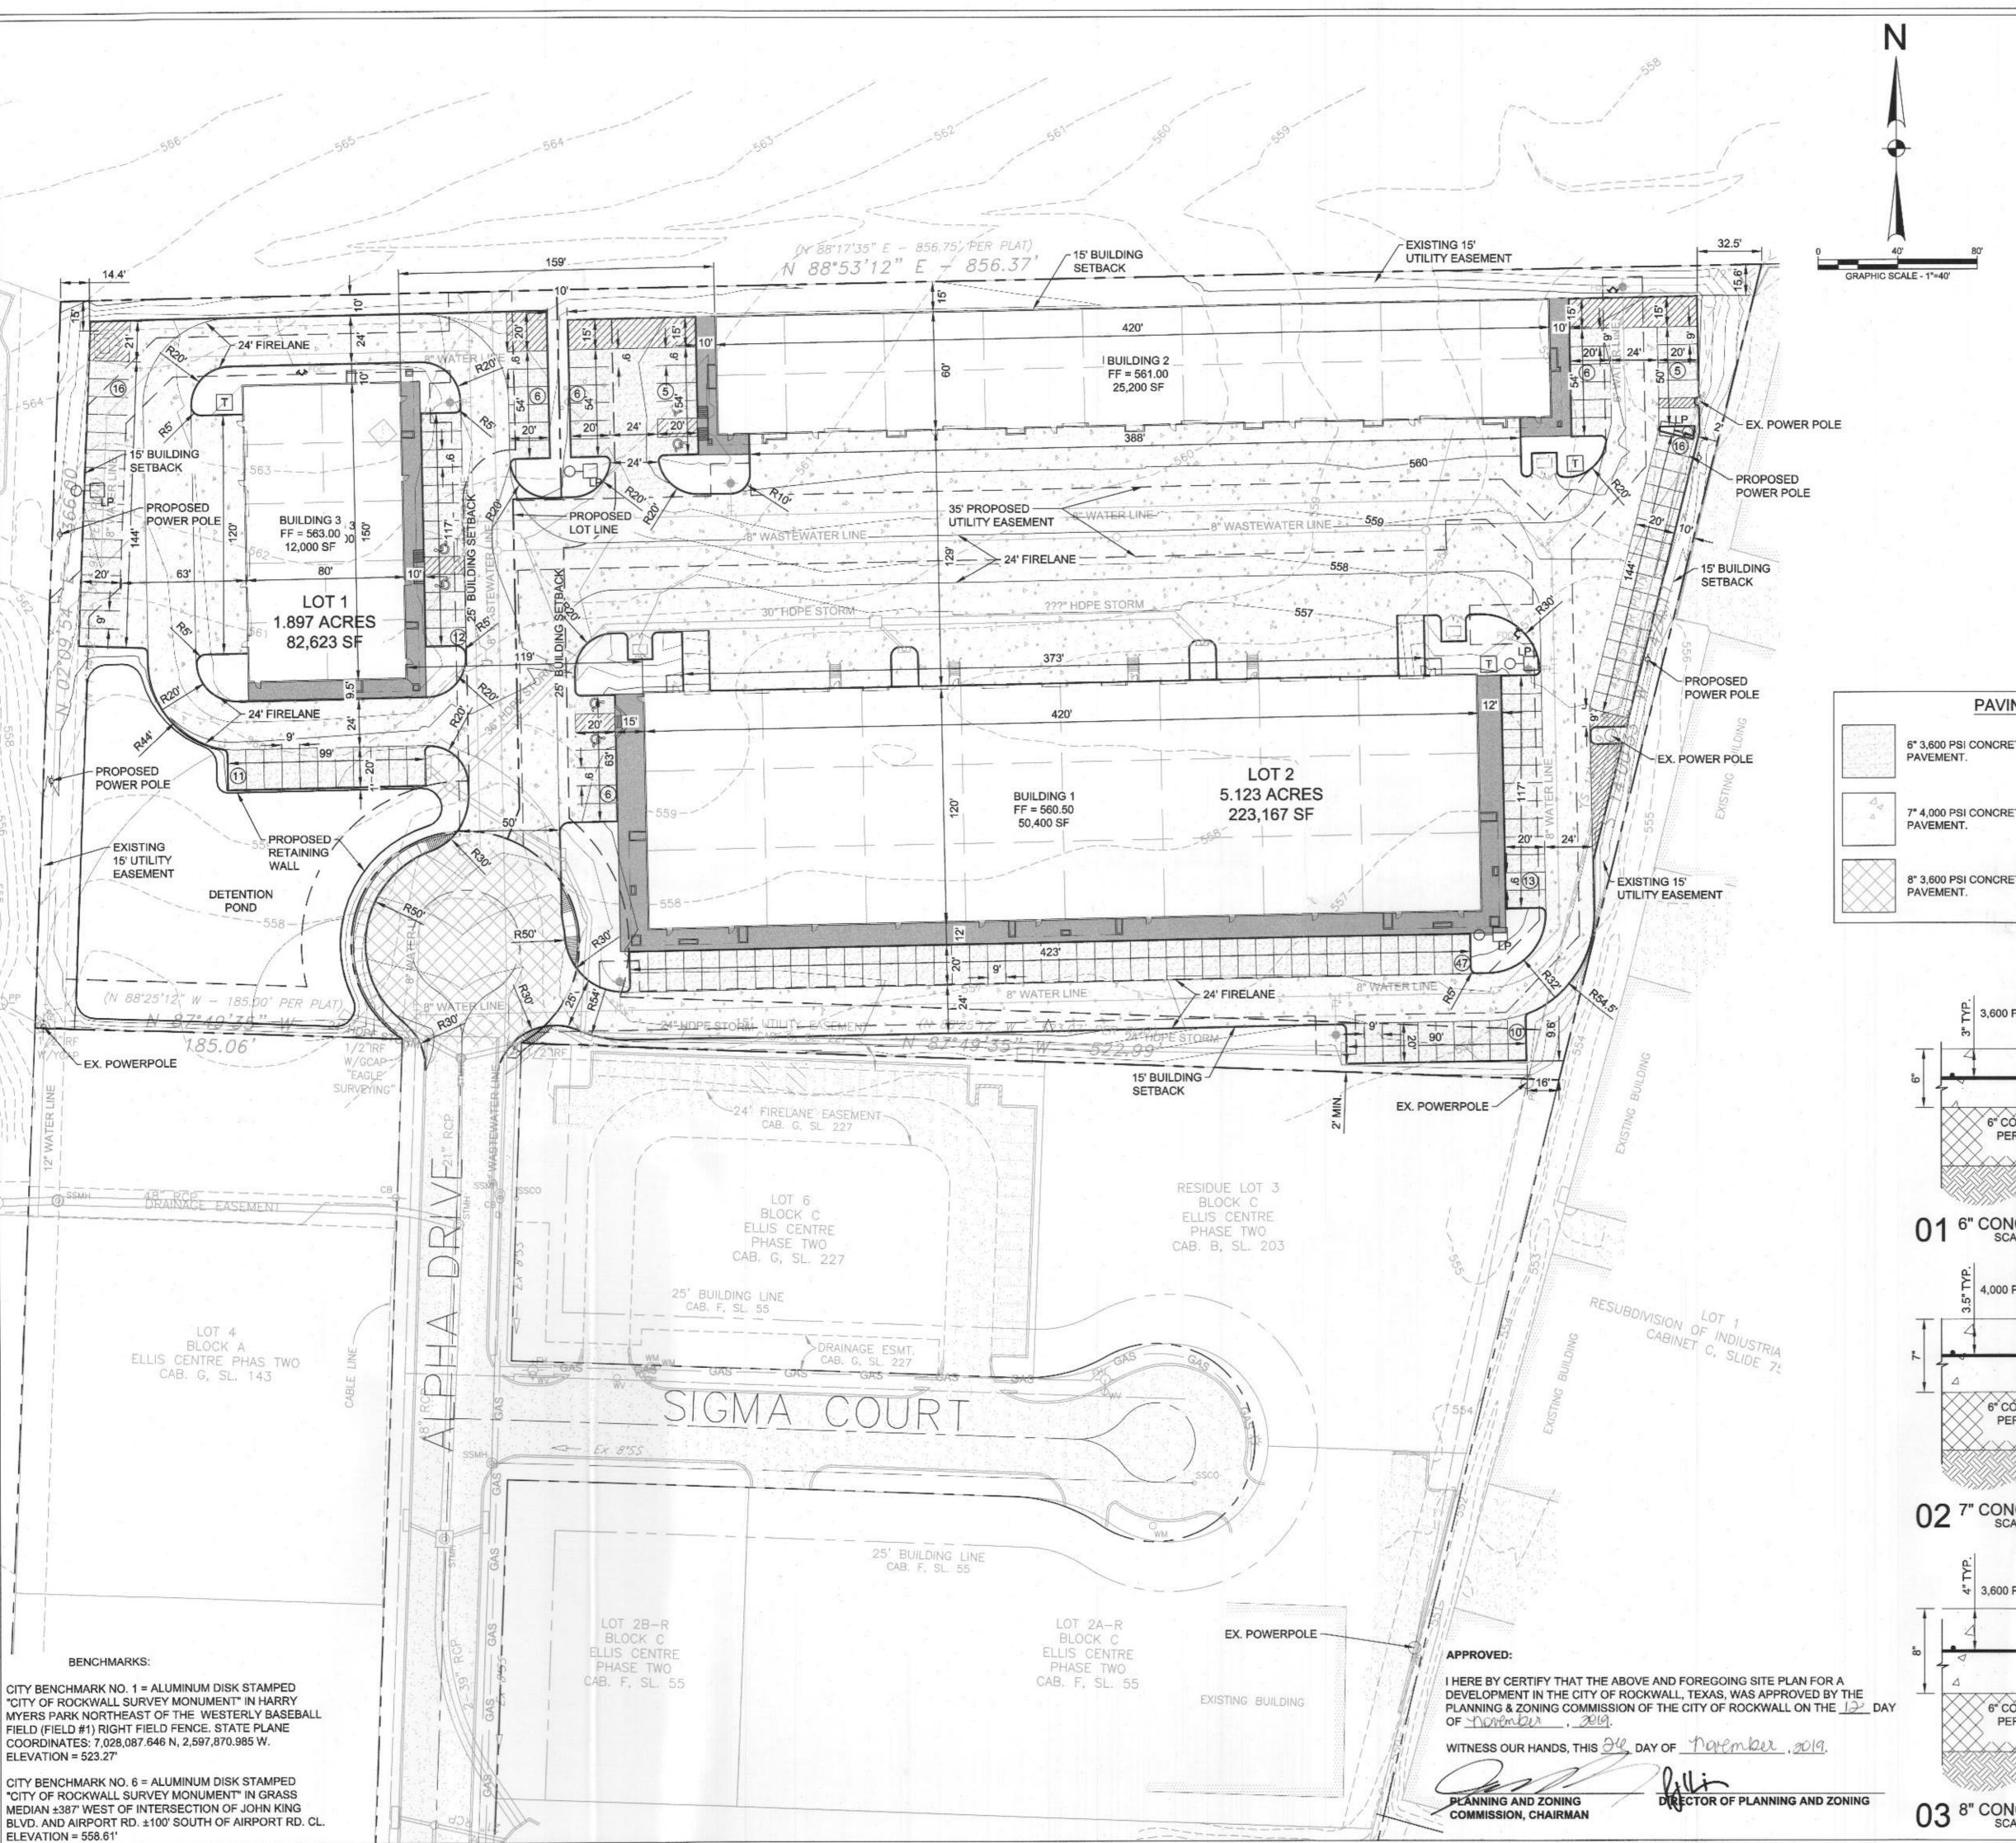


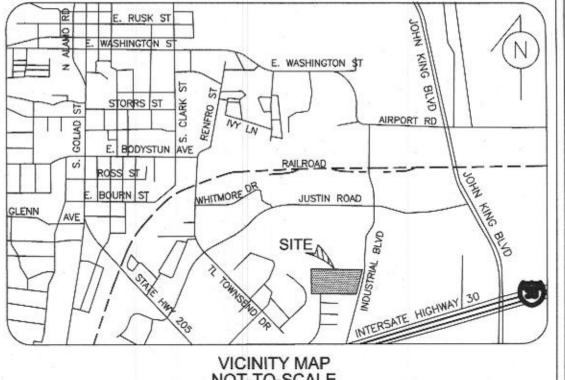


## NOT-TO-SCALE

SHEE	T DATA	<b>\:</b>	
CURRENT ZONING		LIGHT IN	DUSTRIAL
PROPOSED LAND USE:		LIGHT IN	DUSTRIAL
TOTAL SITE AREA:		7.02	ACRES
BUILDING:			. E.,
BUILDING 1		50,400	SF
BUILDING 2		25,200	SF
BUILDING 3		12,000	SF
PARKING:			
REQUIRED: 1 SPACE/1,000 SF (75%)	1 SPACE/30	00 SF (25%)	
TOTAL REQUIRED:		139	SPACES
PROVIDED:		159	SPACES
ACCESSIBLE SPACES PROVIDED:		6*	SPACES

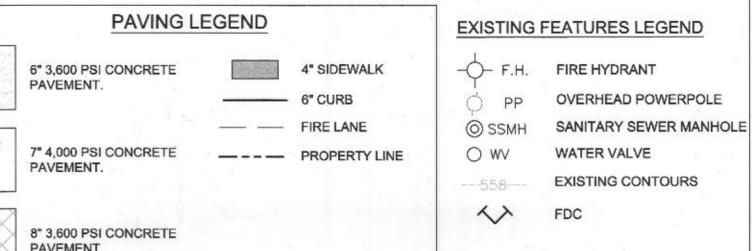


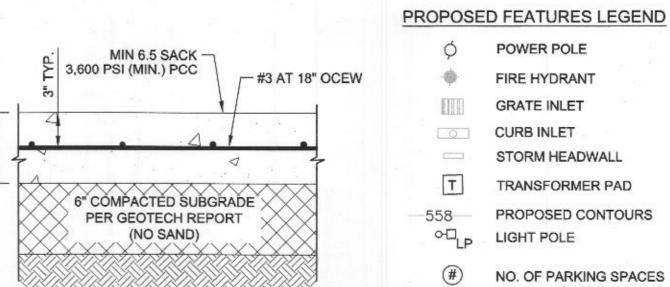

# 01 6" CONCRETE PAVEMENT SECTION SCALE: N.T.S.

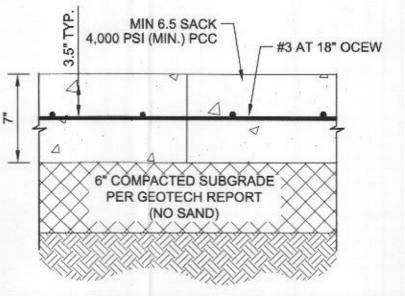

# 02 7" CONCRETE PAVEMENT SECTION SCALE: N.T.S.

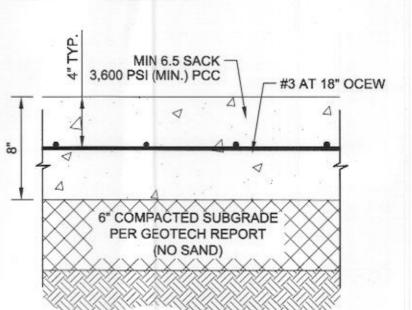

# 03 8" CONCRETE PAVEMENT SECTION


 ALL DIMENSIONS ARE TO FACE OF CURB UNLESS OTHERWISE

### OWNER/ DEVELOPER ROCKWALL URBAN INDUSTRIAL, LP 13150 COIT ROAD DALLAS, TX. 75240 CONTACT: REID CALDWELL EMAIL: reid@longbowinterests.com

TEL: (214) 457-8198 **ENGINEER** HALFF ASSOCIATES, INC. 1201 NORTH BOWSER ROAD RICHARDSON, TX. 75081 CONTACT: DYLAN HEDRICK EMAIL: dhedrick@halff.com TEL: (214) 217-6426

TBPE FIRM# F-312 ALL RESPONSIBILITY FOR ADEQUACY OF DESIGN REMAIN WITH THE DESIGN ENGINEER. THE CITY OF ROCKWALL, IN REVIEWING AND RELEASING PLANS FOR CONSTRUCTION, ASSUMES NO RESPONSIBILITY FOR ADEQUACY OF DESIGN.

DRIVE 75087 END OF ALI

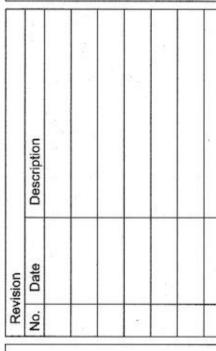

**PRELIMINARY** FOR INTERIM REVIEW ONLY


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roject No.:	35989
ssued:	NOVEMBER 2019
rawn By:	REP
hecked By:	DBH
cale:	AS SHOWN
heet Title	

DETAILED

Sheet Number

SITE PLAN 1 OF 1

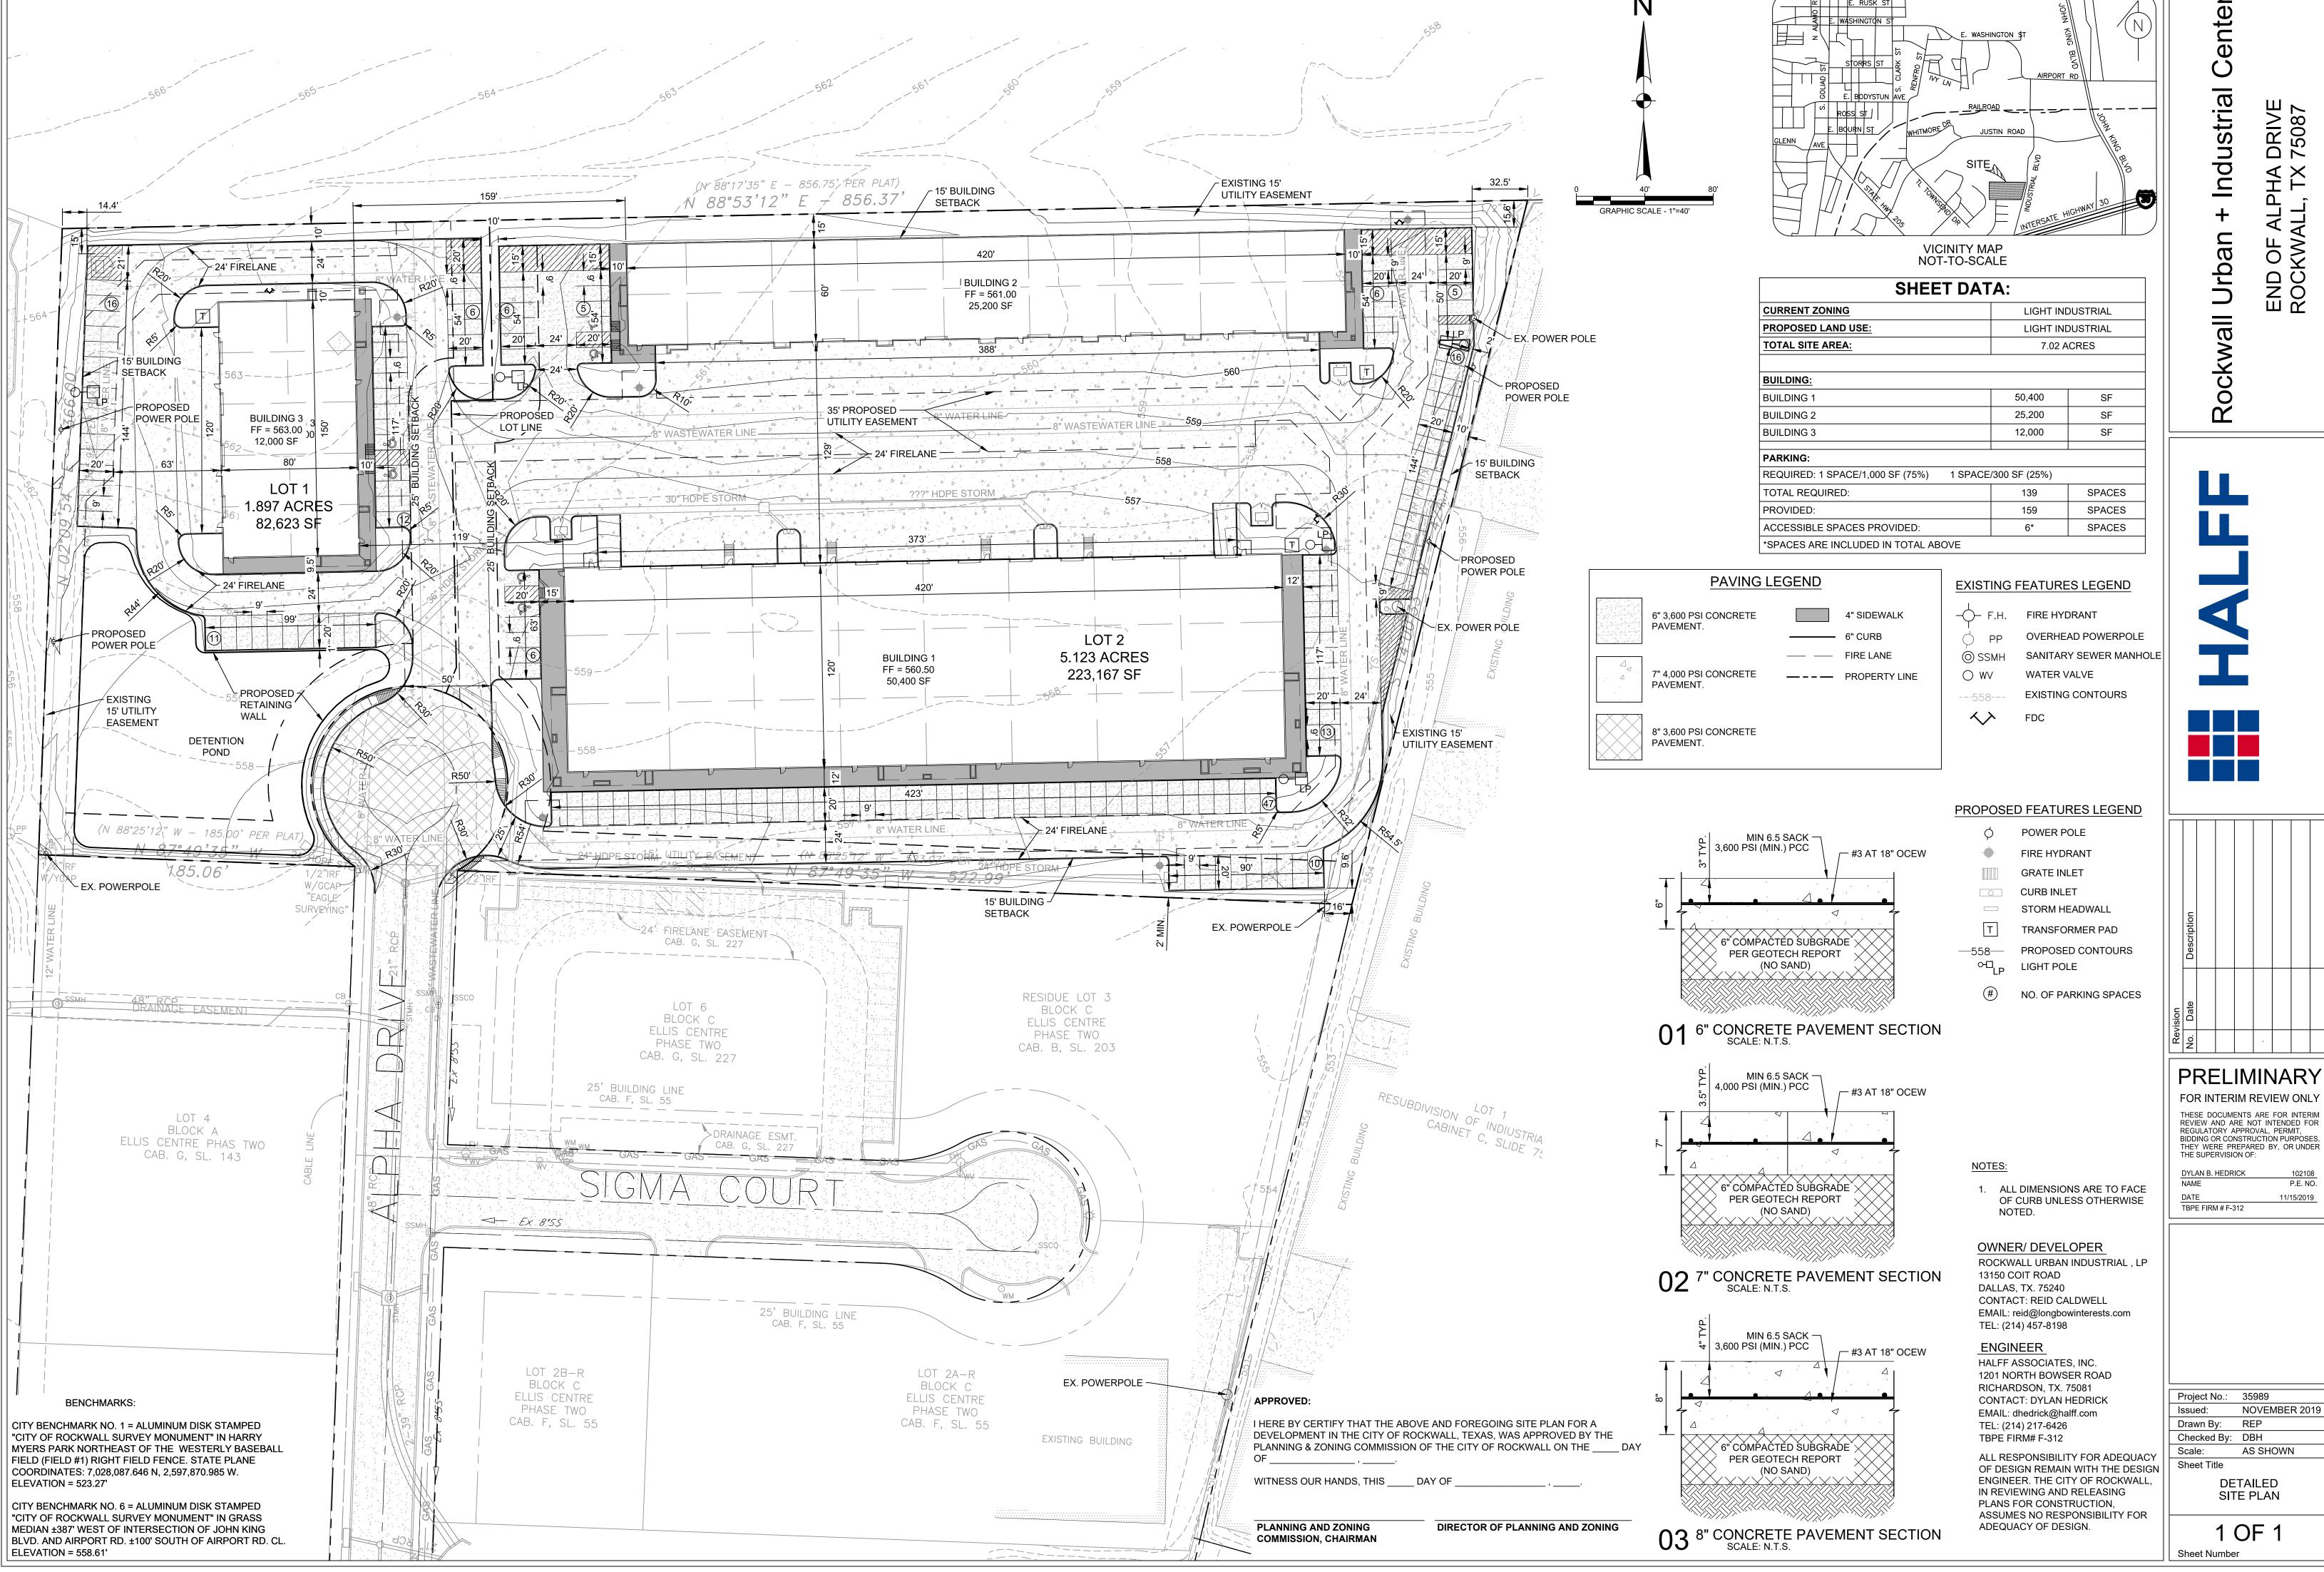

Industrial DRIVE 75087 P ≷ END Rockwall

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DYLAN B. HEDRICK TBPE FIRM # F-312


> 1 OF 1 Sheet Number

DETAILED

SITE PLAN

NOVEMBER 2019

AS SHOWN

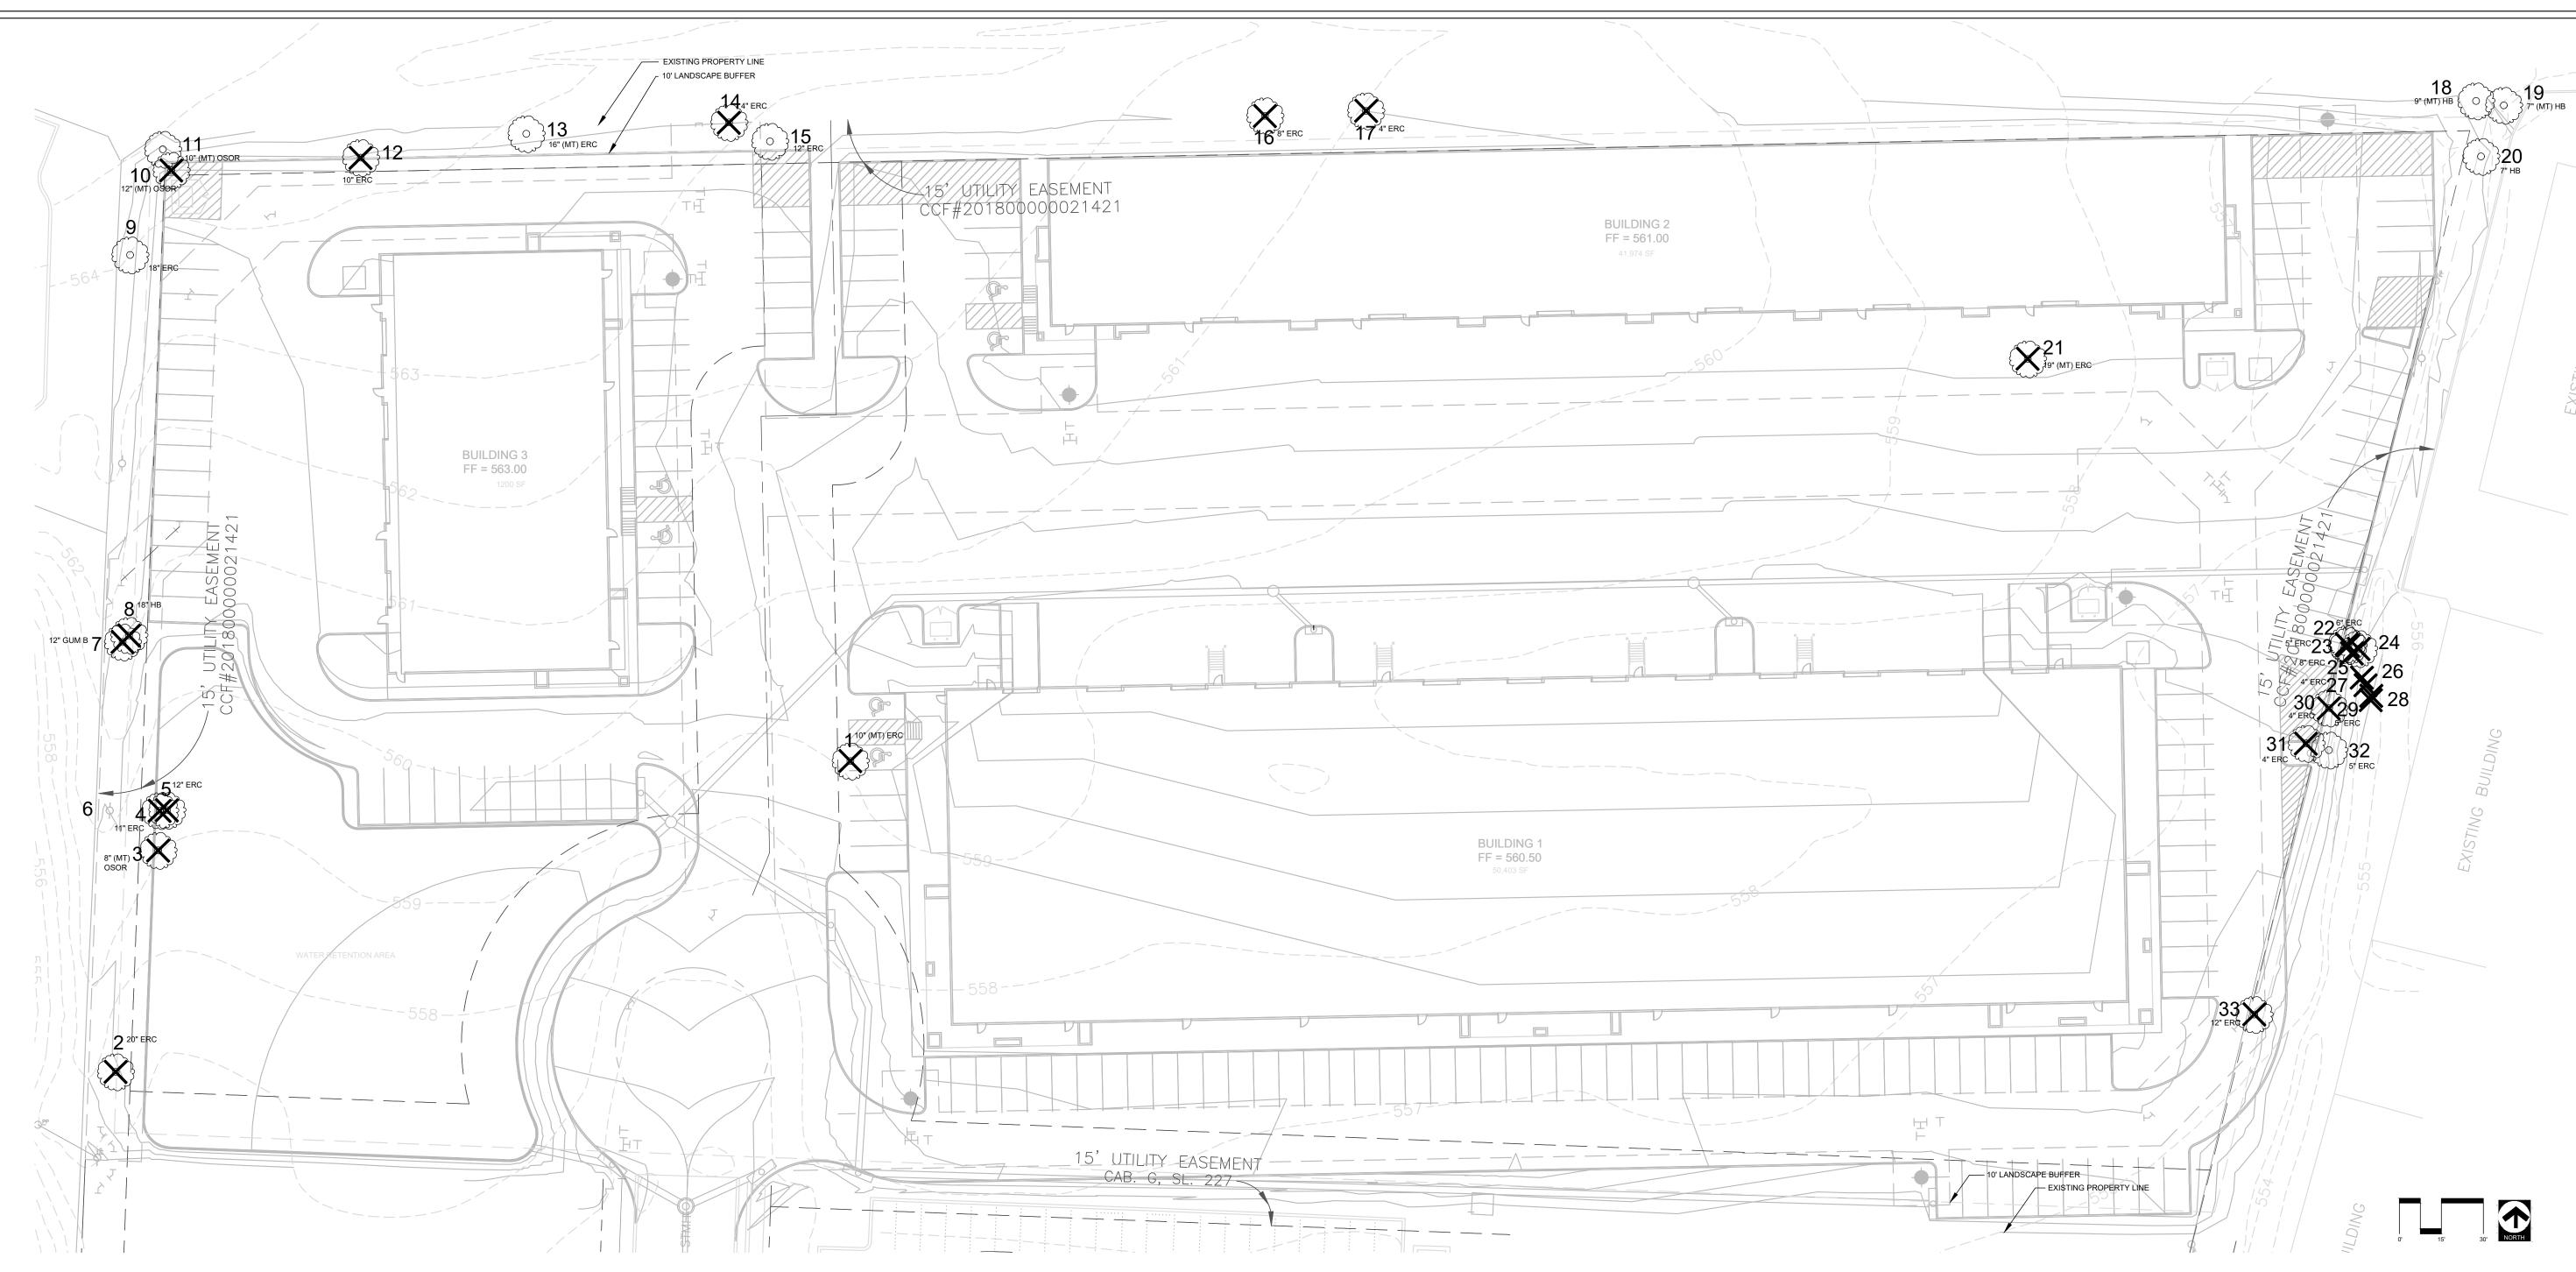

### TREE INVENTORY / MITIGATION

TREE#	SPECIES	SIZE (inches)	CLASSIFICATION	STATUS	REQ. MITIGATION (Inches
1	EASTERN RED CEDAR	10 MULTI-TK	NON-PROTECTED	REMOVE	
2	EASTERN RED CEDAR	20	SECONDARY	REMOVE	10
3	OSAGE ORANGE	8 MULTI-TK	NON-PROTECTED	REMOVE	
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**EXISTING TREES** 

**TREE MITIGATION** 

REQUIRED TREES (inches)

PROVIDED TREES (inches)

\* See Sheet L 2.01 for Planting Locations


EXISTING TREE TO REMAIN

EXISTING TREE TO BE REMOVED

LANDSCAPE REQUIREMENTS

59" CALIPER\* 144" CALIPER

# PLAN VIEW

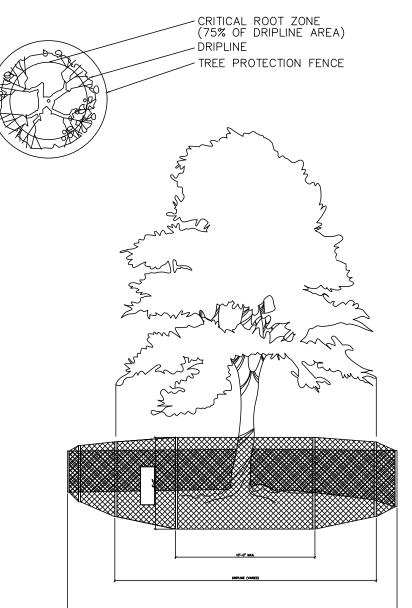

1 TREE PROTECTION DETAIL scale: n.t.s.

STANDARD PRESERVATION NOTES FOR TREE AND NATURAL AREA PROTECTION

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B. Root zone disturbances due to grade changes (greater than 6 inches cut or fill), or trenching not reviewed and authorized by the City Parks Department;
C. Wounds to exposed roots, trunk or limbs by mechanical equipment;
D. Other activities detrimental to trees such as chemical storage, cement truck cleaning, and fires.

6. Exceptions to installing fences at tree drip lines may be permitted in the following cases:

A. Where there is to be an approved grade change, impermeable paving surface, tree well, or other such site development, erect the fence approximately 2 to 4 feet beyond the area disturbed;
B. Where permeable paving is to be installed within a tree's drip line, erect the fence at the outer limits of the

All trees and natural areas shown on plan to be preserved shall be protected during construction with temporary fencing and other measures as needed which may include retaining walls, pruning of limbs, roots, etc.
 Protective fences shall be erected according to City Standards for Tree Protection.
 Protective fences shall be installed prior to the start of any site preparation work (clearing, grubbing or grading), and shall be maintained throughout all phases of the construction project.
 Erosion and sedimentation control barriers shall be installed or maintained in a manner which does not result in soil build—up within tree drip lines.

B. Where permeable paving is to be installed within a tree's drip line, erect the fence at the outer limits of the permeable paving area (prior to site grading so that this area is graded separately by hand prior to paving installation to minimized root damage);

C. Where trees are close to proposed buildings, erect the fence to allow root pruning in the work space between the fence and the building, prior to disturbance. The fence can be erected at the point of root pruning;

D. Where there are severe space constraints due to tract size, or other special requirements, contact an Arborist to discuss alternatives.

Special Note: Exceptions are permitted for areas outside the critical root zone. No disturbances are permitted within the critical root zone (75% of the dripline area). For the protection of natural areas, no exceptions to installing fences at the Limit`of Construction line will be permitted, and no silting of stock piling of material or dirt is allowed around trees.

allowed around trees.

7. Where any of the above exceptions result in a fence being closer than 4 feet to a tree trunk, protect the trunk with strapped—on planking to a height of 8 ft. in addition to the reduced fencing provided.

8. Trees approved for removal shall be removed in a manner which does not impact trees to be preserved.


9. Any roots exposed by construction activity shall be pruned flush with the soil. Backfill root areas with good quality top soil as soon as possible. If exposed root areas are not backfilled within 2 days, cover them with organic material in a manner which reduces soil temperature and minimizes water loss due to evaporation.

10. Trenching required for the installation of irrigation shall be placed as far from existing tree trunks as possible.

11. No landscape topsoil dressing greater than 2 inches shall be permitted within the drip line of trees. No soil or mulch is permitted on the root flare of any tree.

12. Limbing & pruning to provide clearance for structures, traffic and equipment shall take place before damage occurs.

13. All finished pruning shall be done according to recognized, approved standards of the industry (Reference the National Arborist Association Pruning Standards for Shade Trees).

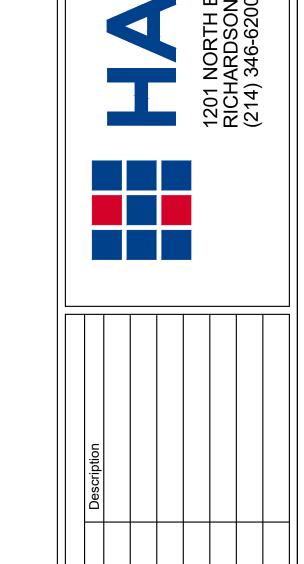

THE SEAL APPEARING ON THIS DOCUMENT WAS AUTHORIZE BY MICHAEL A. WILSON, R.L.A. #3068 ON 5 NOV 2019. ALTERATION OF A SEALED DOCUMENT WITHOUT PROPER NOTIFICATION TO THE RESPONSIBLE LANDSCAPE ARCHITEC

IS AN OFFENSE UNDER TITLE 22, TEXAS ADMINISTRATIVE CODE, CHAPTER 3 LANDSCAPE ARCHITECTS. THE RECORD COPY OF THIS PRAWING IS ON FILE AT THE OFFICES OF HALFF ASSOCIATES, INC. 4000 FOSSIL CREEK BLVD. FORT WORTH, TX 76137-2720. TBPE FIRM #F-312

Project No.: 35989

Scale:

Sheet Title

Issued: 11-5-19 Drawn By: CAP Checked By: MAW


AS SHOWN

TREESCAPE PLAN

L 1.01

Rockwall

SHEET SIZE: 24" x 36" | Sheet Number

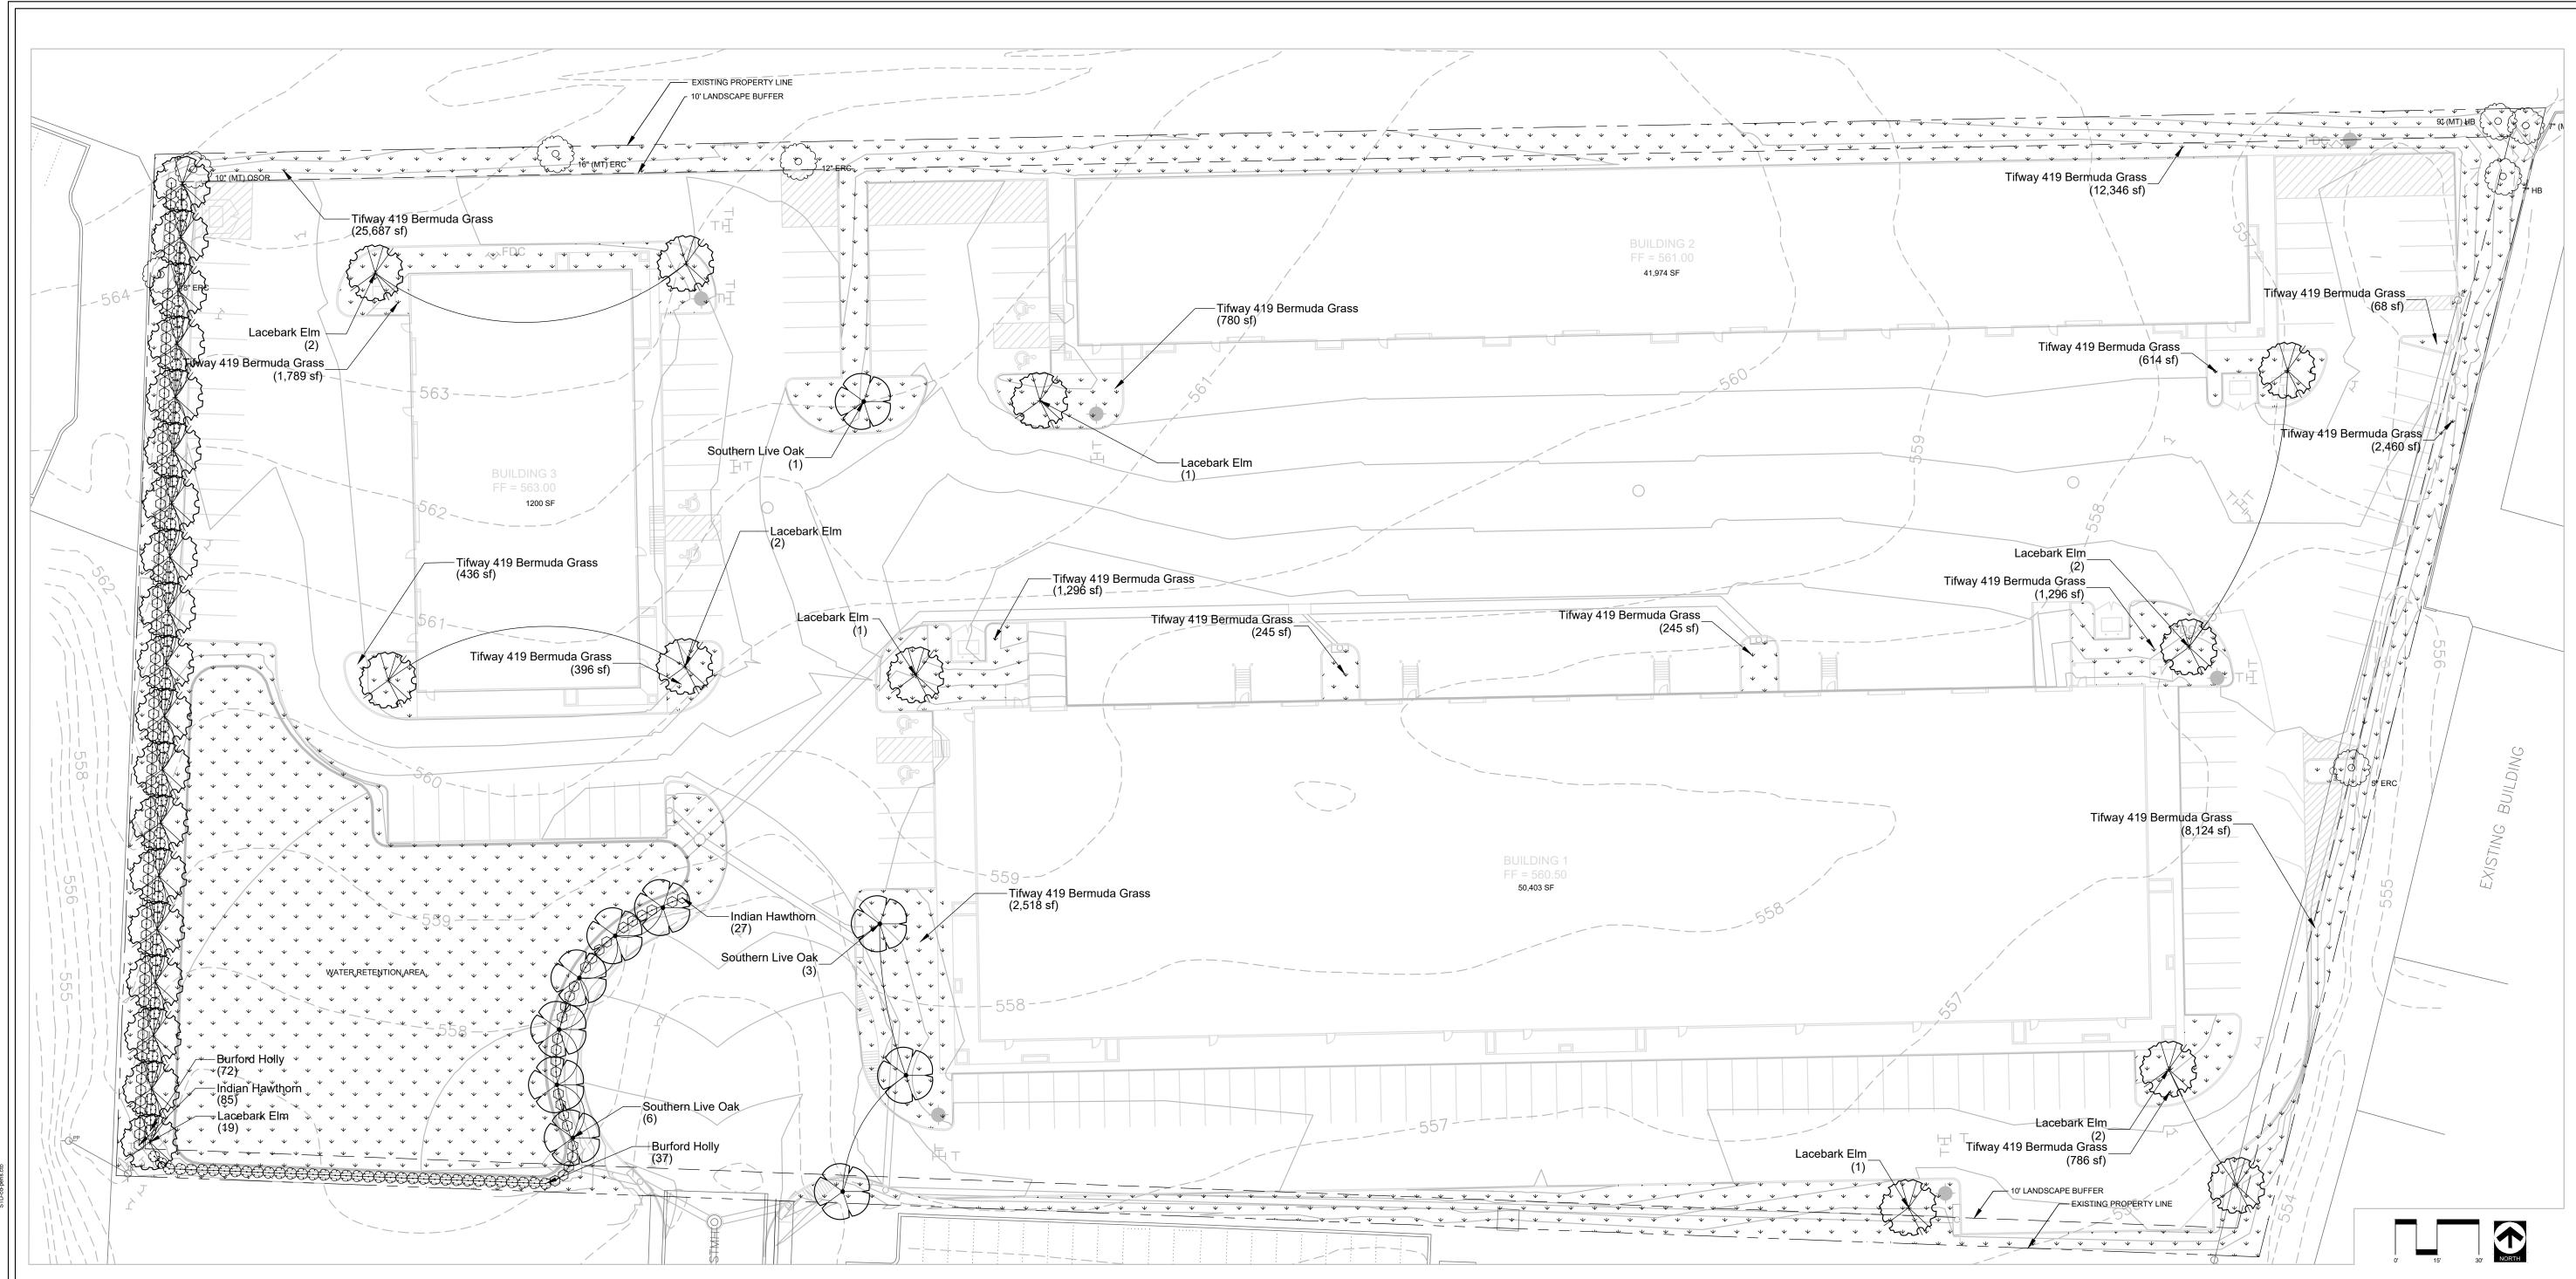

## PLANT SCHEDULE

TREES	BOTANICAL / COMMON NAME	CONT	CAL	HT	SPD	QTY
	Quercus virginiana / Southern Live Oak	B & B	4" Cal	10`-12` Ht.	6`-8`	10
	Ulmus parvifolia / Lacebark Elm	B & B	4" Cal	10`-12` Ht.	6`-8`	30
SHRUBS	BOTANICAL / COMMON NAME	SIZE	HT	SPD		QTY
$\odot$	Ilex cornuta `Burfordii` / Burford Holly	5 gal	18"-24"	12"-18"		109
$\odot$	Rhaphiolepis indica / Indian Hawthorn	5 gal	18"-24"	12"-18"		112
GROUND COVERS	BOTANICAL / COMMON NAME	CONT	SIZE			QTY
\(\psi\) \(\	Cynodon dactylon `Tifway 419` / Tifway 419 Bermuda Grass	SOLID SOD				59,764 st

## **EXISTING TREES**

EXISTING TREE TO REMAIN

# LANDSCAPE REQUIREMENTS

REQUIRED LANDSCAPING		
ZONED LIGHT INDUSTRIAL	REQUIRED	PROVIDED
TOTAL LANDSCAPE AREA PROVIDED (%)	15% OF SITE	21% OF SITE
TOTAL LANDSCAPE AREA PROVIDED (SF)	45,869 SF	63,914 SF
TREE MITIGATION		
	REQUIRED	PROVIDED
MITIGATION REQUIREMENTS (inches)	59" CALIPER*	160" CALIPER
* See Sheet L 1.01 for calculations		
	REQUIRED	PROVIDED
PARKING LOT LANDSCAPING		ı
	REQUIRED	+
200 SF MIN/ 2 ROWS OR MORE		✓
3 AREAS 200 FT/SQ X 3	600 SF	✓
ONE TREE WITHIN 80' OF REQ. PARKING		✓
PERMIABLE LANDSCAPE PROVIDED		3,756 SF
1 TREE / 10 PARKING SPACES	16	16
SCREENING REQUIREMENTS		
	REQUIRED	PROVIDED
SCREEN TRASH AREAS	N/A	
SCREEN RESIDENTIAL OR MULTI-FAMILY	N/A	
STREET TREES		
	REQUIRED	PROVIDED
1 TREE /50' FRONTAGE	1	1

## PLANTING NOTES

PREPARATION
LANDSCAPE CONTRACTOR SHALL BE RESPONSIBLE FOR VERIFYING THE CORRECT LOCATION OF ALL UNDERGROUND UTILITIES, PIPES, STRUCTURES, AND LINE RUNS IN THE FIELD PRIOR TO THE INSTALLATION OF ANY PLANT MATERIALS.

REFER TO PLANTING PLAN FOR PIANTING LOCATION AND PLANT MATERIAL LEGEND FOR SPECIFICATIONS. PLANT MATERIAL LOCATION TO BE STAKED IN THE FIELD AND APPROVED BY LANDSCAPE ARCHITECT PRIOR TO PLANTING.

LANDSCAPE CONTRACTOR SHALL BE RESPONSIBLE FOR ANY COORDINATION WITH OTHER CONTRACTORS ON SITE AS REQUIRED TO ACCOMPLISH ALL PLANTING OPERATIONS.

LANDSCAPE CONTRACTOR SHALL BE RESPONSIBLE FOR MAINTAINING ALL PLANTING BEDS IN A WEED AND DEBRIS FREE CONDITION AND SHALL ACCOMPLISH WATERING BY HAND AS DEEMED NECESSARY UNTIL SUBSTANTIAL COMPLETION AND ACCEPTANCE BY THE OWNER. THE CONTRACTOR SHALL MAINTAIN ALL WORK FOR A PERIOD OF 30 DAYS AFTER SUBSTANTIAL COMPLETION AND ACCEPTANCE.

LANDSCAPE CONTRACTOR SHALL BE RESPONSIBLE FOR ALL QUANTITIES PER DRAWINGS AND SPECIFICATION BY IANDSCAPE ARCHITECT. PLANT QUANTITIES HAVE BEEN PROVIDED AS A CONVENIENCE ONLY AND SHALL NOT BE CONSIDERED ABSOLUTE. LANDSCAPE ARCHITECT TO BE NOTIFIED IF DISCREPANCIES OCCUR. OTHERWISE, THE CONTRACTOR IS TO BID THEIR OWN VERIFIED QUANTITIES PER LANDSCAPE PLAN.

ALL BED AREAS ARE TO BE FLUSH WITH FINISHED GRADE AT ADJACENT PAVEMENT. ALL BED AREAS SHALL BE ROTOTILLED TO BE A DEPTH OF 6", ADDING PREPARED SOIL MIXTURE AS REQUIRED.


AFTER SETTLEMENT, ALL PLANTING BED MULCH DEPTHS SHALL BE A MIN. OF 3". ALL AREAS DISTURBED BY PLANTING OPERATIONS SHALL BE FINE GRADED AND REPLANTED. MULCH SHALL BE TEXAS NATIVE CEDAR

ALL PLANT MATERIAL SHALL CONFORM TO THE SIZES GIVEN IN THE PLANT LIST AND SHALL BE NURSERY GROWN IN ACCORDANCE WITH THE "AMERICAN STANDARD FOR NURSERY STOCK", LATEST EDITION. ALL PLANTING SHALL BE IN ACCORDANCE WITH STANDARD AMERICAN ASSOCIATION OF NURSERYMEN PROCEDURES AND SPECIFICATIONS.

PROTECTED TREES SHALL BE MARKED AND THE DRIP LINE OF SAID TREES SHALL BE PROTECTED PRIOR TO AND DURING ALL CONSTRUCTION, INCLUDING EARTHWORK.

IRRIGATION WILL MEET ALL TCEQ AND UDC REQUIREMENTS.

\*\*NO TREES SHALL BE PLANTED WITHIN 5' OF UTILITIES\*\*

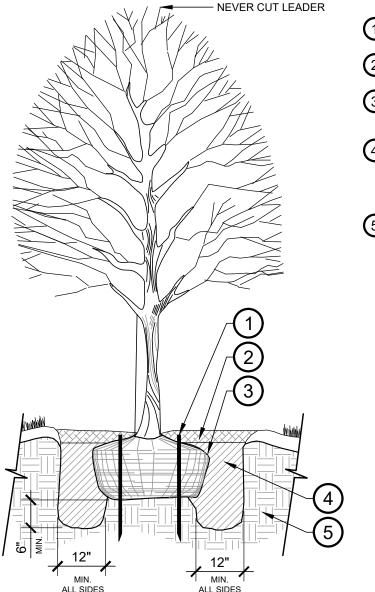

**NEW TREE PLANTING** 

(3) ARBOR STAKES. INSTALL PER MANUFACTURE'S SPECIFICATIONS

2 SPECIFIED MULCH - 3" MIN. DEPTH ENTIRE TREE BASIN 3 SET TOP OF ROOT BALL 3" ABOVE FINISH GRADE. BUILD 3" HT. SAUCER AROUND PLANTING PIT WITH TOPSOIL.

4 LIVING EARTH PLANTING MIX OR APPROVED EQUAL BY LANDSCAPE ARCHITECT. WATER AND TAMP TO REMOVE SIDE AND BOTTOM AIR POCKETS 6" MIN.

5 UNCOMPACTED NATIVE SOIL/UNDISTURBED SUBGRADE

FOR BALL & BURLAP REMOVE WIRE/TWINE FROM AROUND BURLAP, FOLD TOP THIRD DOWN OR CUT/REMOVE PRIOR TO BACKFILL.

> Project No.: 35989 11-21-19 Issued: Drawn By: CAP Checked By: MAW Scale: AS SHOWN Sheet Title

LANDSCAPE PLAN

L 2.01


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TBPE FIRM #F-312



0.2

Description

WSR LED WITH P1-PERFORMANCE PACKAGE, 4000K, AND SR2 OPTIC TYPE WST LED Performance package 3 4000 K, visual comfort forward throw, MVOLT

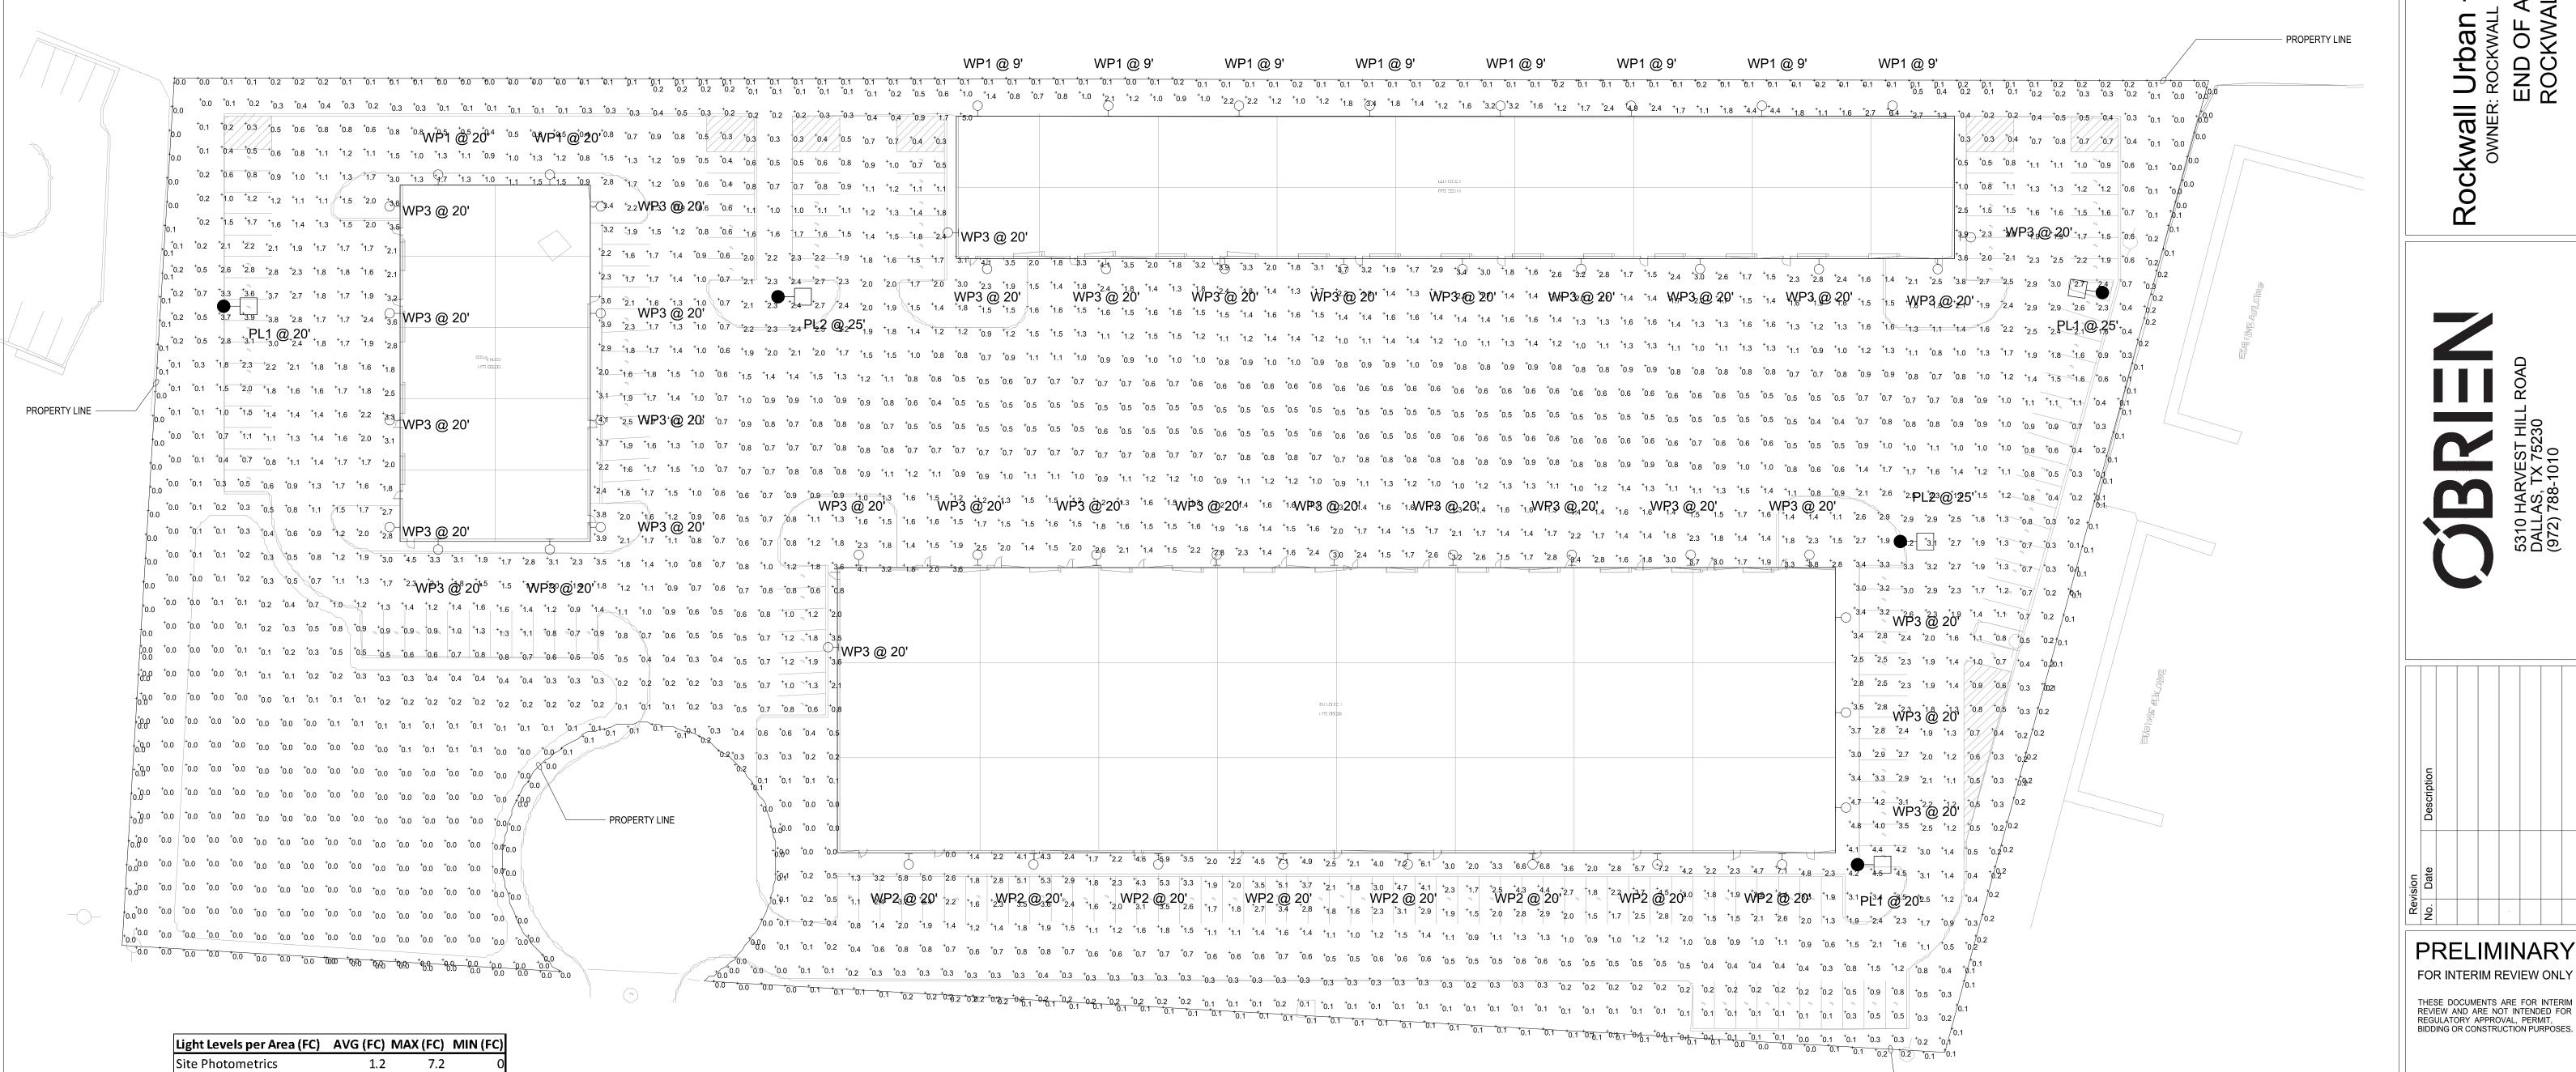WSR LED WITH P4-PERFORMANCE PACKAGE, 4000K, AND SR4 OPTIC TYPE

DSX0 LED P5 40K T2M MVOLT with houseside shield

DSX0 LED P6 40K T5M MVOLT with houseside shield

Lamp Lamp Lumens Watts

6609

6388

9550

11955

50

61

89

134

0.1

Along Property Line

Catalog Number

WSR LED P1 SR2 40K MVOLT

WST LED P3 40K VF MVOLT

WP3 WSR LED P4 SR4 40K MVOLT

PL1 DSX0 LED P5 40K T2M MVOLT HS

PL2 DSX0 LED P6 40K T5M MVOLT HS

SITE PHOTOMETRICS SCALE: 1/32" = 1'-0"



- PROPERTY LINE

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SHEET SIZE: 24" x 36"

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Sheet Title SITE

Project No.:

Checked By:

Issued: Drawn By:

JOSHUA WILEY

OCTOBER 2019


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**PHOTOMETRICS** 

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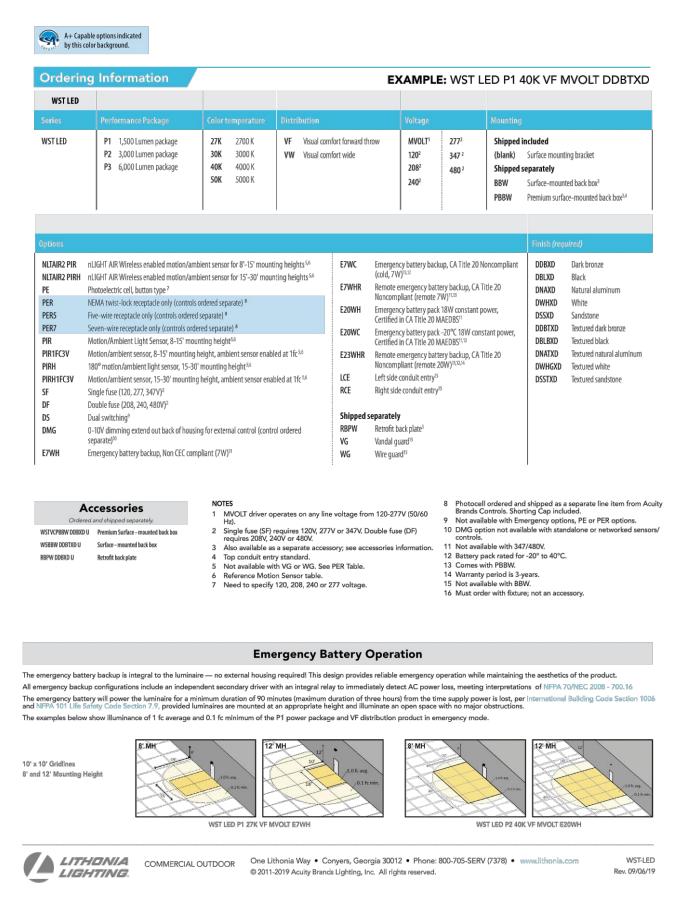
Center, LP.


Rockwall OWNER:




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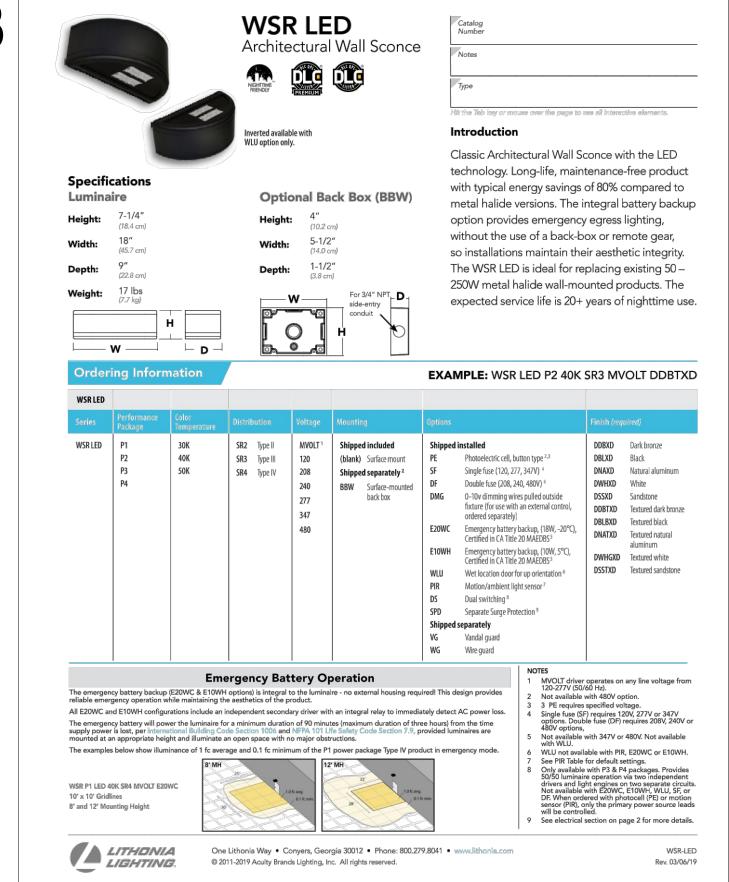
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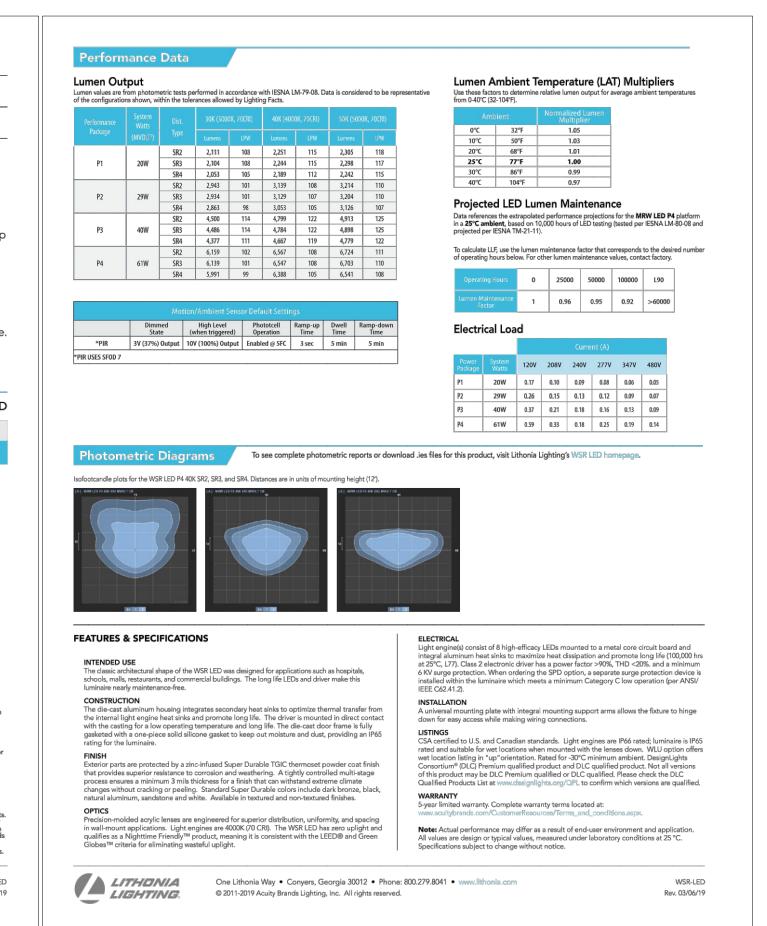


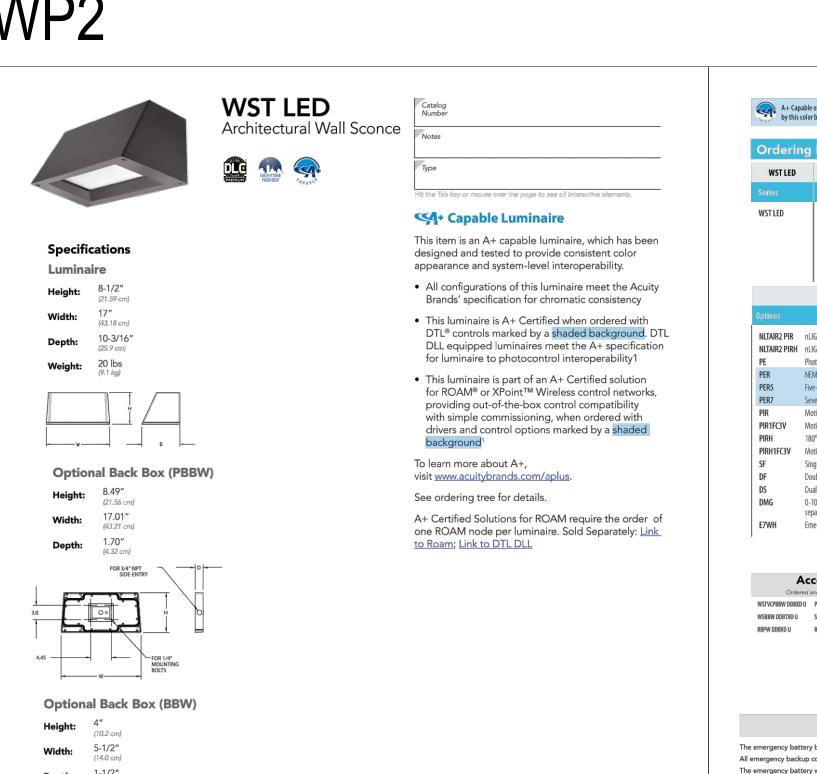

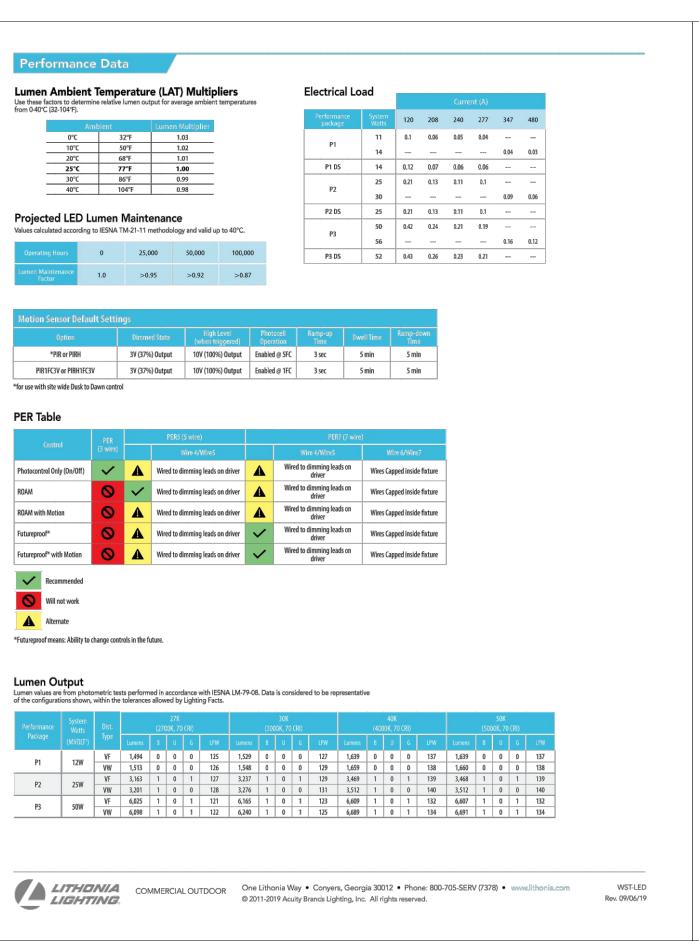

Rev. 09/06/19

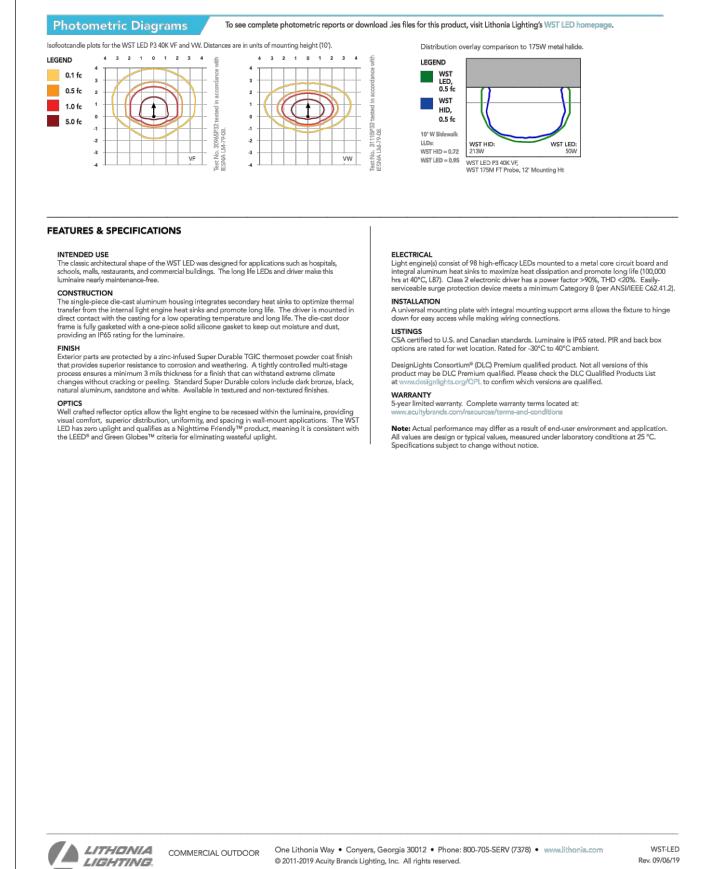





17855 North Dallas Parkway • Suite 320 Dallas, TX, 75287 p. 469.385.1616 • f. 469.385.1615 Texas Registered Engineering Firm F-4990 Project Number:1930681 Drawn By:DNH Checked By:JW

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OCTOBER 2019 Scale: AS SHOWN Sheet Title WP1,WP2,WP3 **CUTSHEETS** 

**PRELIMINARY** 

FOR INTERIM REVIEW ONLY

THESE DOCUMENTS ARE FOR INTERIM REVIEW AND ARE NOT INTENDED FOR REGULATORY APPROVAL, PERMIT.

BIDDING OR CONSTRUCTION PURPOSES.

Sheet Number Case Number:

LITHONIA LIGHTING

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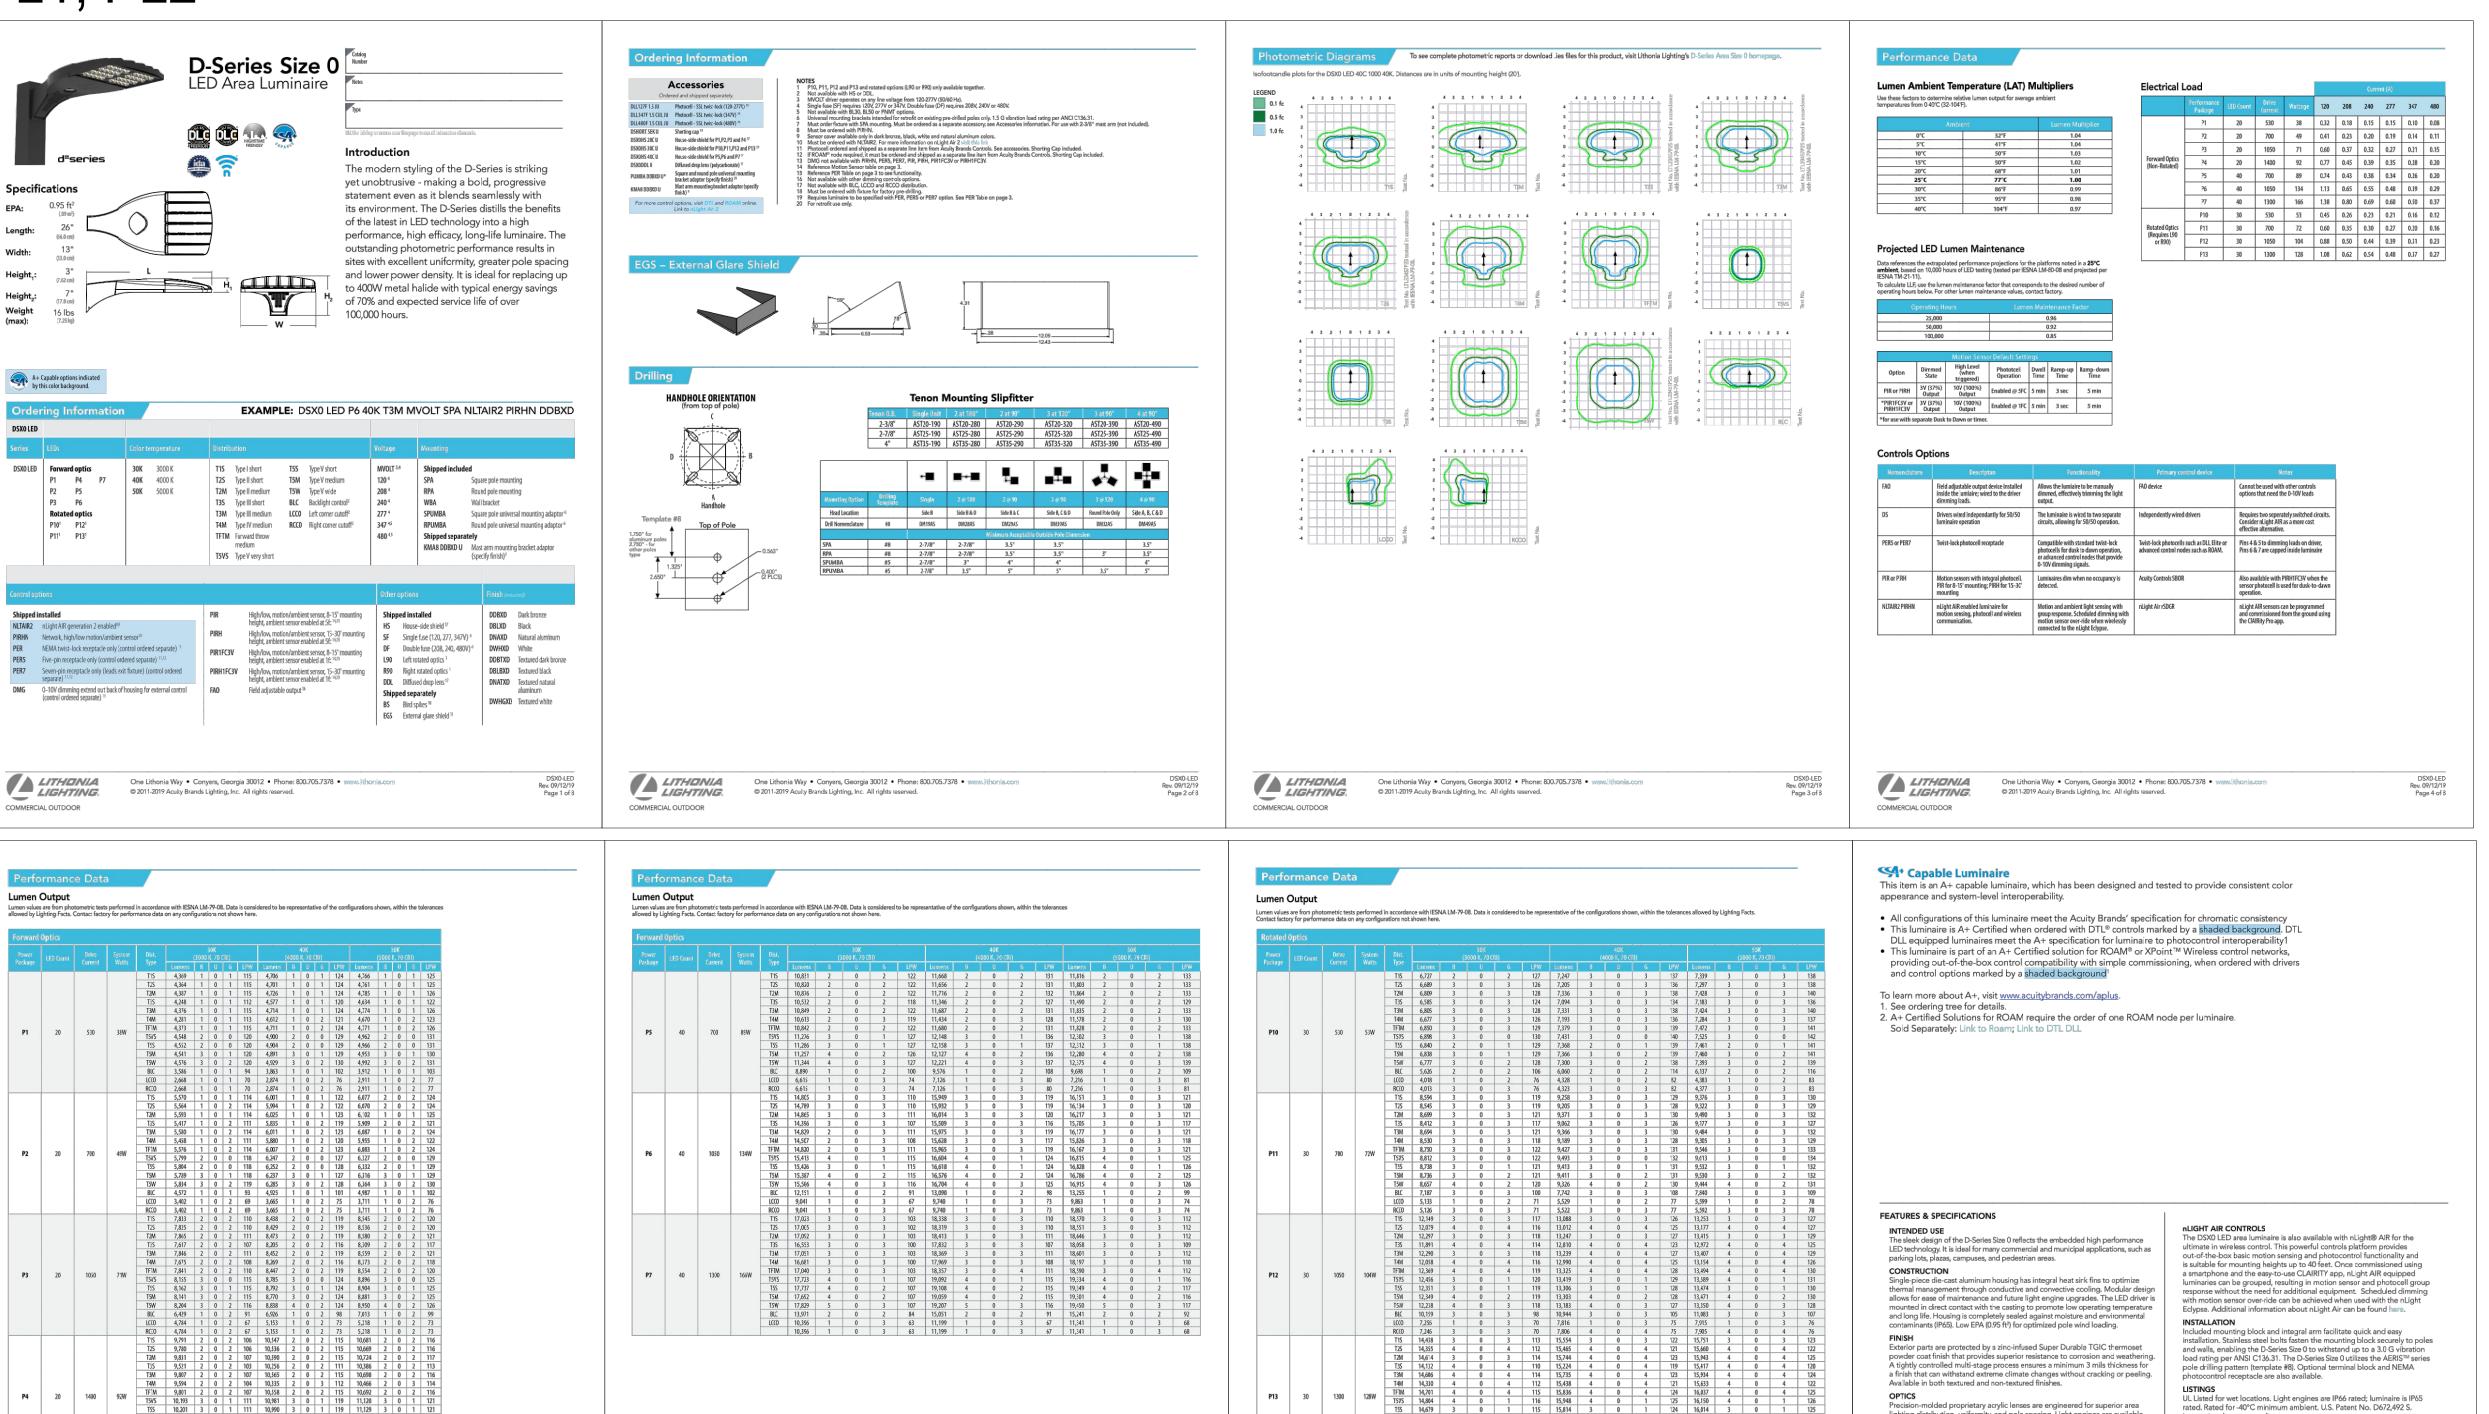
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Jordan & Skala Engineers

lighting distribution, uniformity, and pole spacing. Light engines are available in 3000 K, 4000 K or 5000 K (70 CRI) configurations. The D-Series Size 0 has zero

Light engine(s) configurations consist of high-efficacy LEDs mounted to metal-core circuit boards to maximize heat dissipation and promote long life (up to L85/100,000 hours at 25°C). Class 1 electronic drivers are designed to have a power factor >90%, THD <20%, and an expected life of 100,000 hours with <1%

failure rate. Easily serviceable 10kV surge protection device meets a minimum

controls can be utilized via optional NEMA twist-lock photocell receptacles. Integrated motion sensors with on-board photocells feature field-adjustable programing and are suitable for mounting heights up to 30 feet.

The DSX0 LED area luminaire has a number of control options. Dusk to dawn

Category C Low operation (per ANSI/IEEE C62.41.2).

uplight and qualifies as a Nighttime Friendly™ product, meaning it is consiste with the LEED® and Green Globes™ criteria for eliminating wasteful uplight.

ELECTRICAL

STANDARD CONTROLS

LITHONIA LIGHTING

COMMERCIAL OUTDOOR

esignLights Consortium® (DLC) Premium qualified product and DLC

qualified product. Not all versions of this product may be DLC Premium qualified or DLC qualified. Please check the DLC Qualified Products List at www.designlights.org/QPL to confirm which versions are qualified.

International Dark-Sky Association (IDA) Fixture Seal of Approval (FSA) is

Note: Actual performance may differ as a result of end-user environment

DSX0-LED Rev. 09/12/19 Page 8 of 3

and application.
All values are design or typical values, measured under laboratory conditions at 25 °C.

Specifications subject to change without notice.

5-year limited warranty. Complete warranty terms located at:

WARRANTY

One Lithonia Way • Conyers, Georgia 30012 • Phone: 800.705.7378 • www.lithonia.com

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available for all products on this page utilizing 3000K color temperature only.

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Sheet Title PL 1, PL2

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JOSHUA WILEY 129688

19068

OCTOBER 2019

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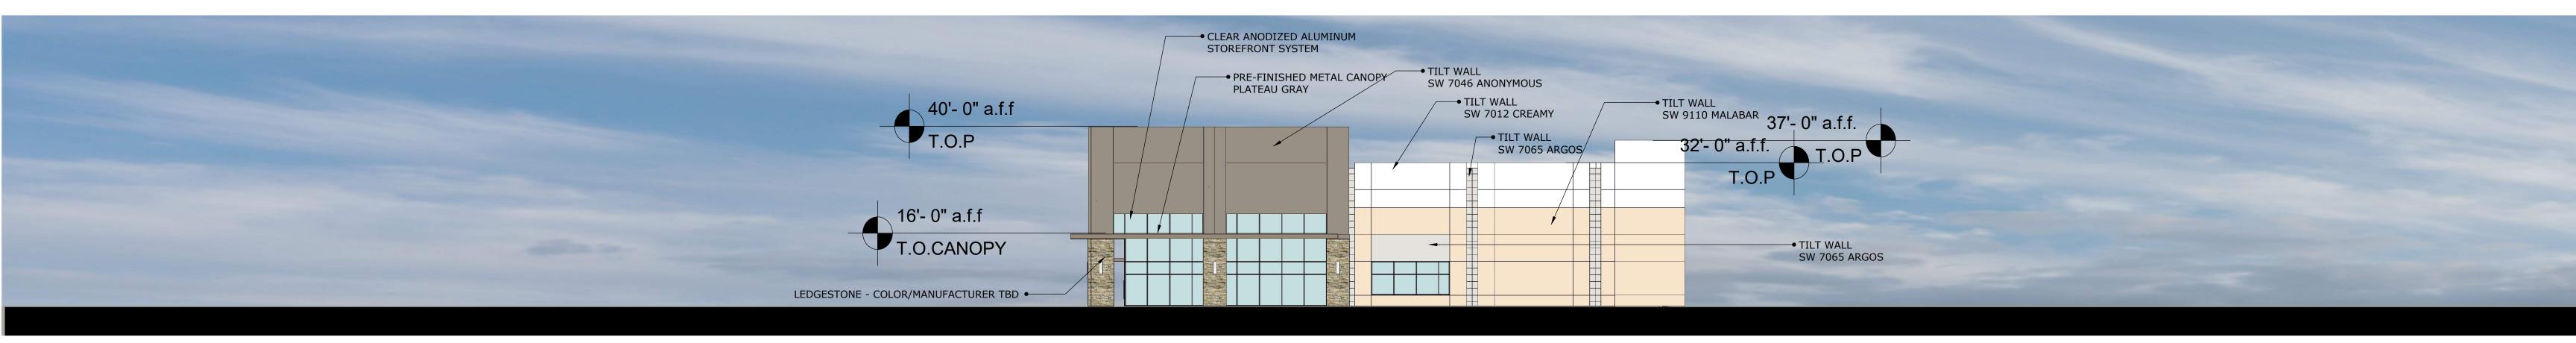
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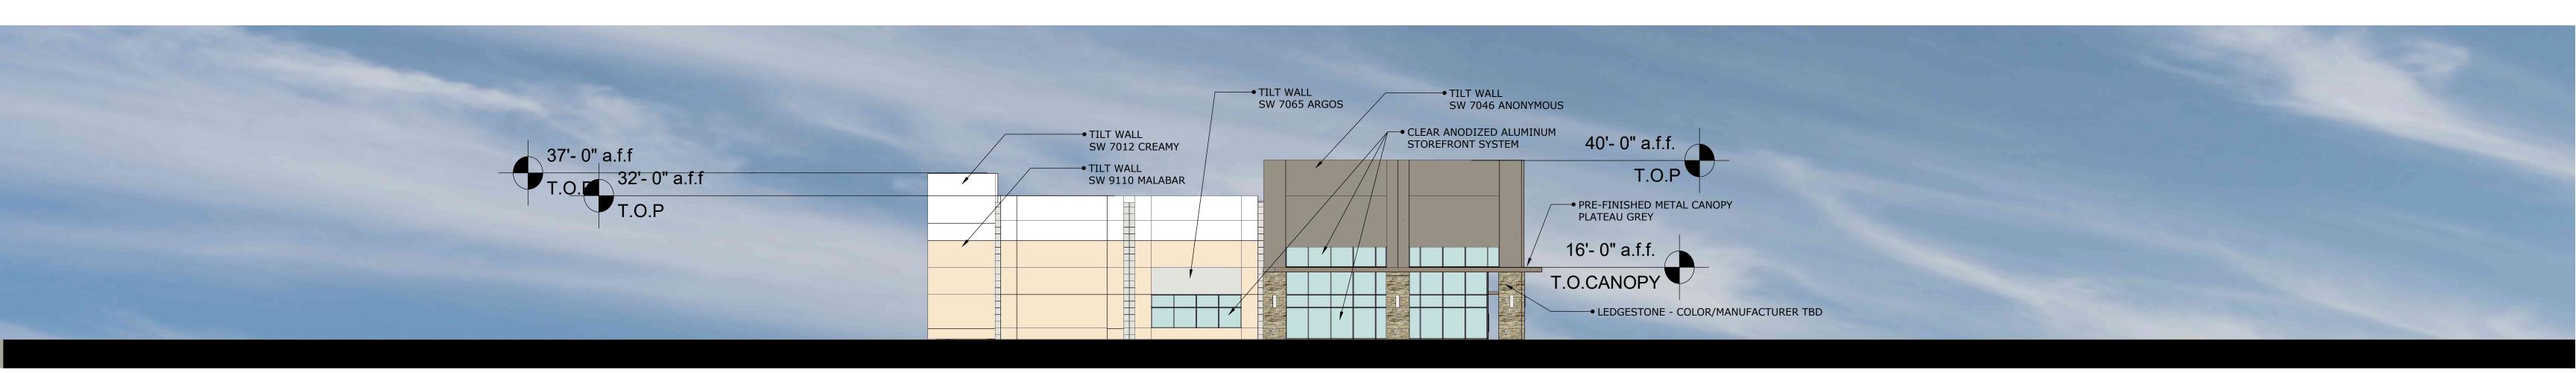
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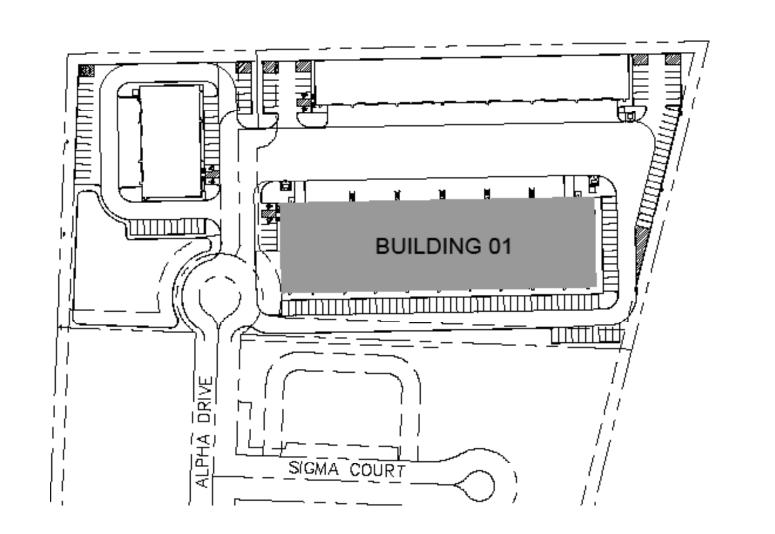
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WEST




FAÇADE				
BLDG 1				
	METAL CANOPY	MASONRY	PRIMARY MASONRY: PAINTED CONCRETE TILT WALL	FAÇADE TOTAL SF (EXCLUSIVE OF DOORS WINDOWS)
NORTH	0	0	14,051	14,051
SOUTH	235	580	10,586	11,401
EAST	59	241	3,533	3,833
WEST	59	241	3,533	3,833
				TOTAL
SF of Materials	353	1,062	31,702	33,117
Percentage of Material	1%	3%	96%	100%

**ÓBRIEN** BUILDING ELEVATIONS





NORTH

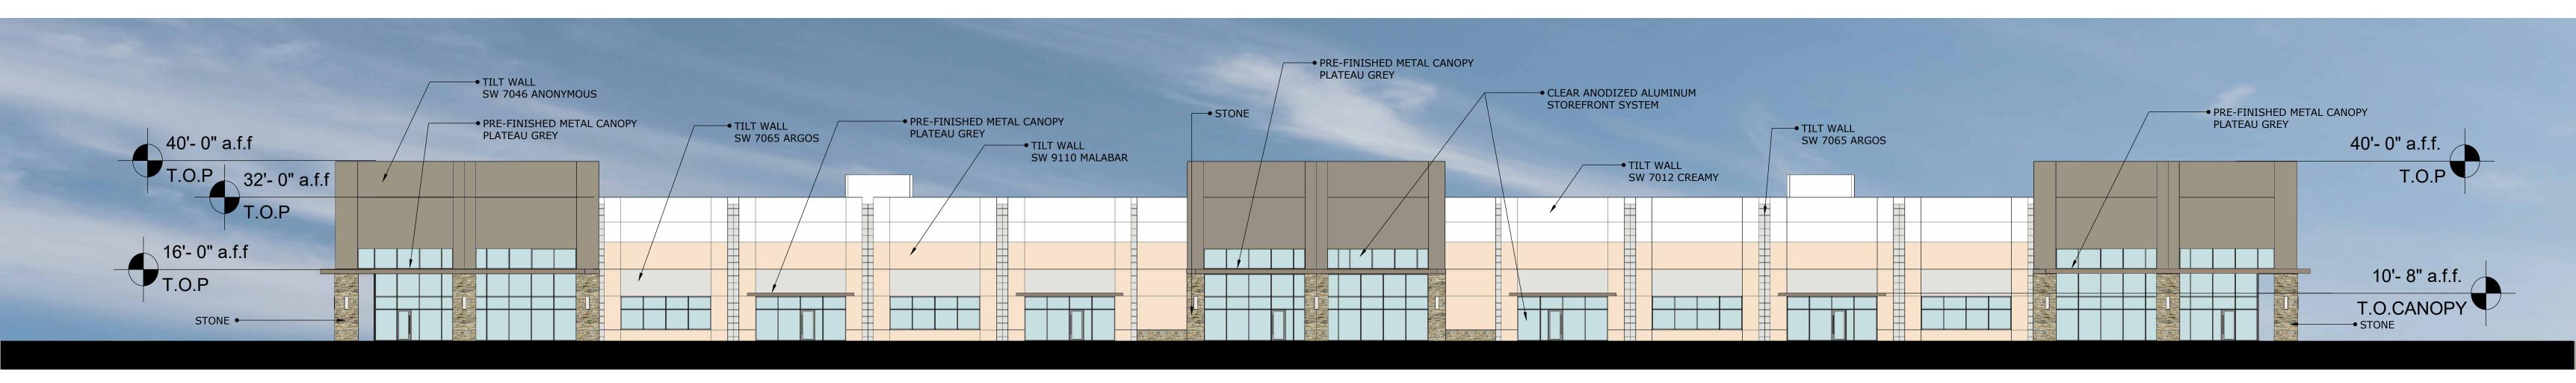

SOUTH

# TYPICAL DUMPSTER ENCLOSURE ELEVATIONS

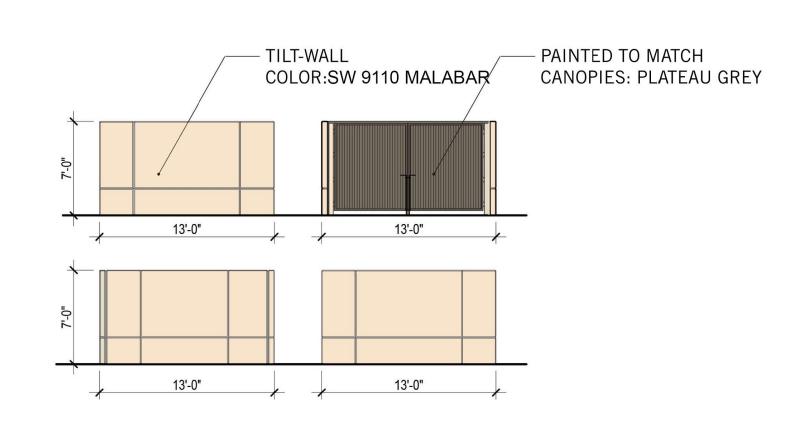

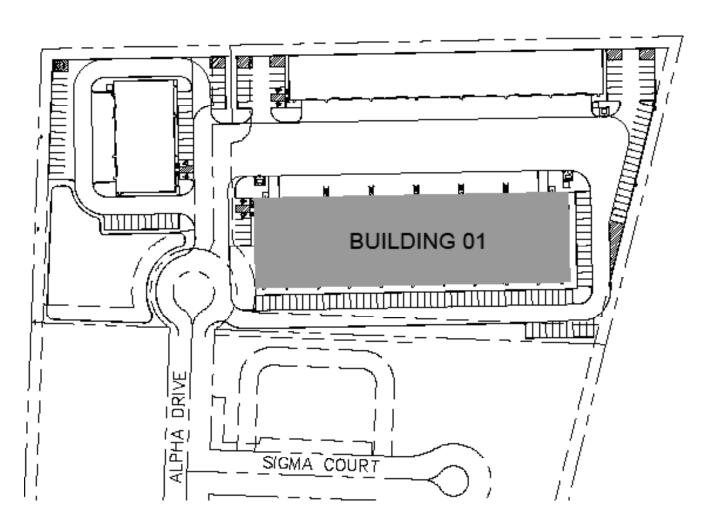


FAÇADE				
BLDG 1				
	METAL CANOPY	MASONRY	PRIMARY MASONRY: PAINTED CONCRETE TILT WALL	FAÇADE TOTAL SF (EXCLUSIVE OF DOORS & WINDOWS)
NORTH	0	0	14,051	14,051
SOUTH	235	580	10,586	11,401
EAST	59	241	3,533	3,833
WEST	59	241	3,533	3,833
				TOTAL
SF of Materials	353	1,062	31,702	33,117
Percentage of Material	1%	3%	<b>96</b> %	100%


URBAN INDUSTRIAL CENTER - BLDG 1




SOUTH

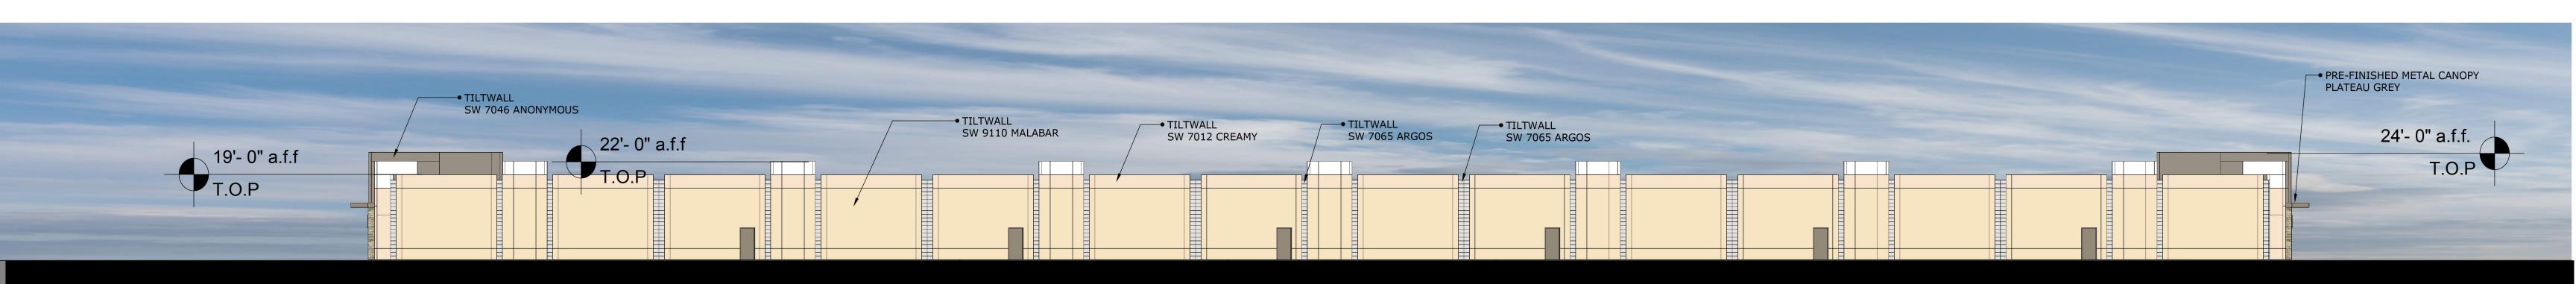


NORTH

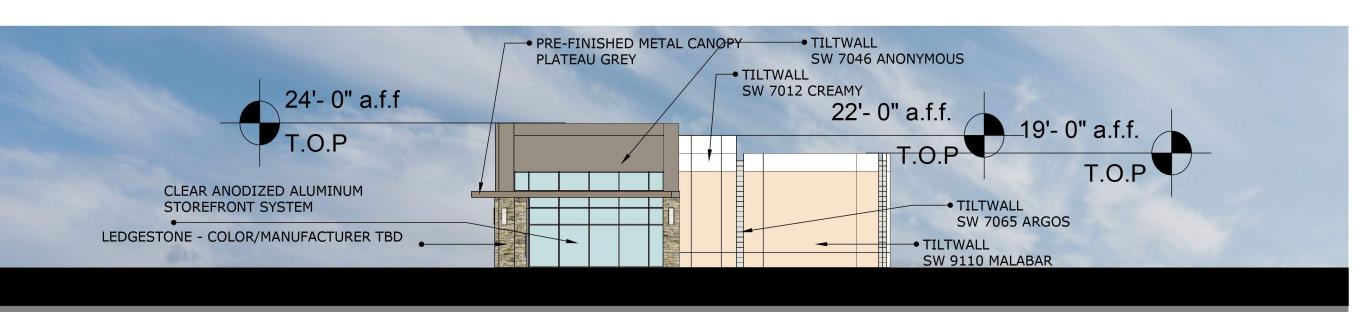

EAST

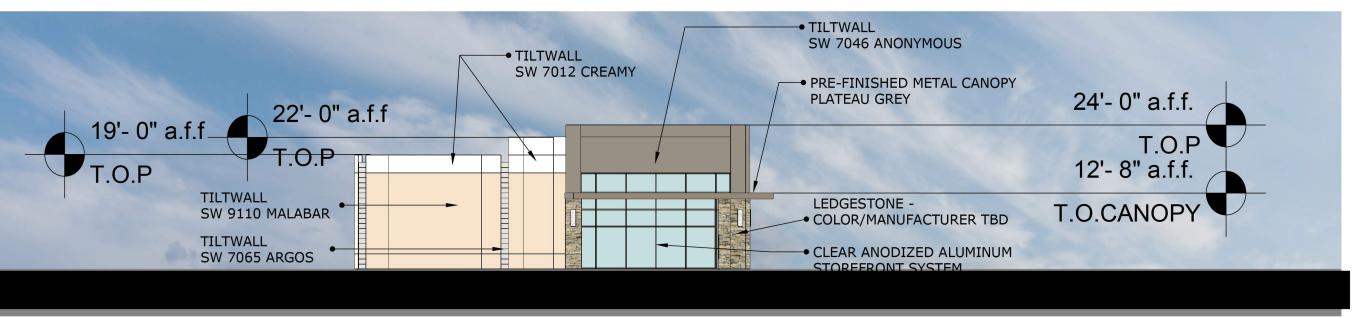


WEST

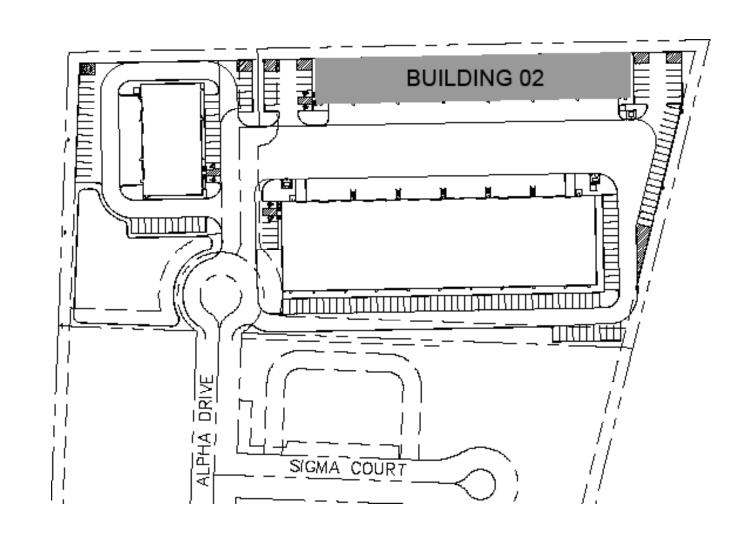


BLDG 2				
	METAL CANOPY	MASONRY	PRIMARY MASONRY: PAINTED CONCRETE TILT WALL	FAÇADE TOTAL SF (EXCLUSIVE OF DOORS & WINDOWS)
NORTH	0	0	9,178	9,178
SOUTH	66	190	3,592	3,848
EAST	33	73	946	1,052
WEST	33	73	946	1,052
				TOTAL
SF of Materials	132	336	14,662	15,129
Percentage of Material	1%	2%	97%	100%

**OBRIEN** 


**BUILDING ELEVATIONS** 

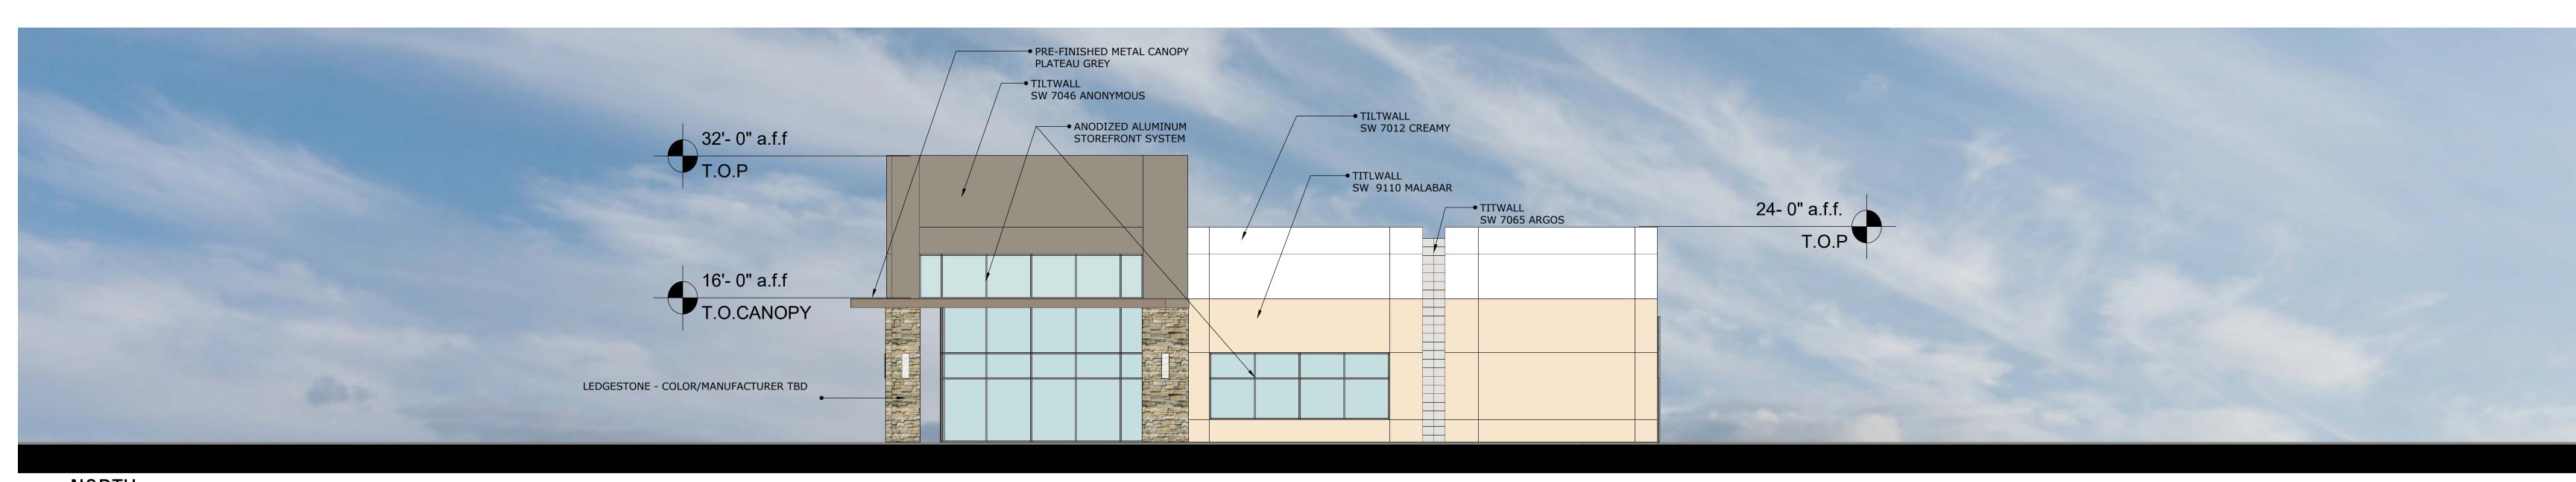

NORTH

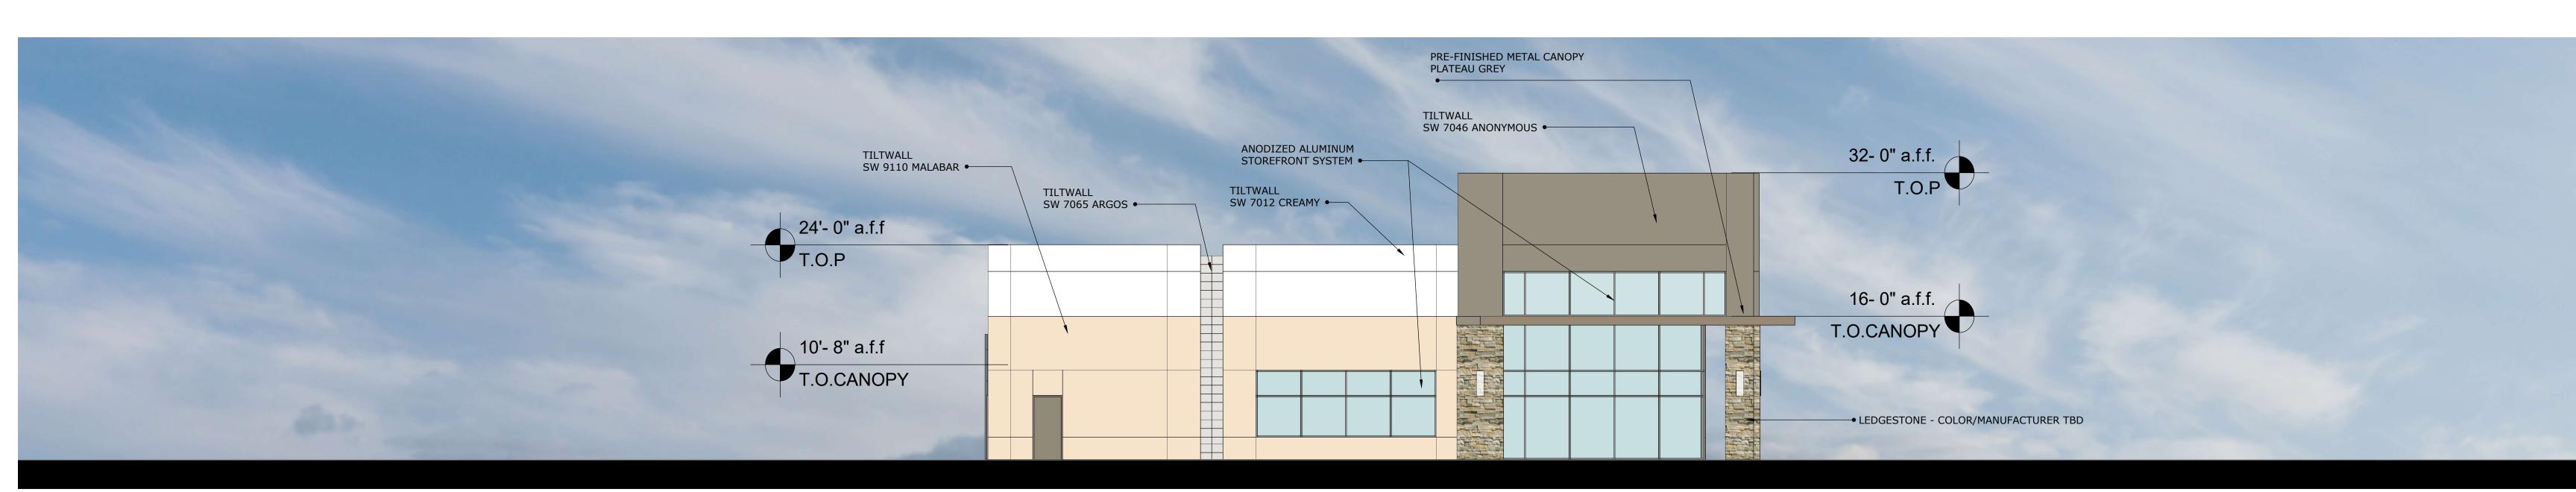


SOUTH

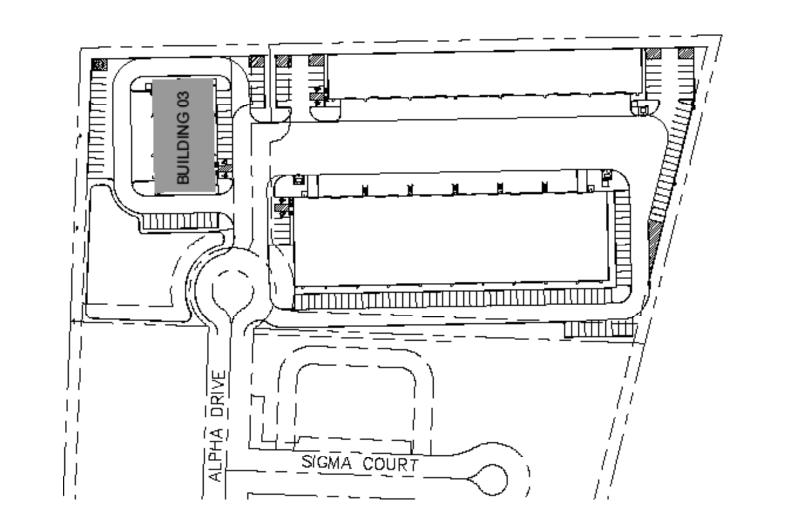


BLDG 3				
	METAL CANOPY	MASONRY	PRIMARY MASONRY: PAINTED CONCRETE TILT WALL	FAÇADE TOTAL SF (EXCLUSIVE OF DOOR WINDOWS)
NORTH	35	136	1,495	1,666
SOUTH	35	136	1,495	1,666
EAST	74	230	2,592	2,896
WEST	0	0	3,000	3,000
				TOTAL
SF of Materials	144	502	9 593	
			8,582	9,228
Percentage of Material	2%	5%	93%	100%

ÓBRIEN


**BUILDING ELEVATIONS** 

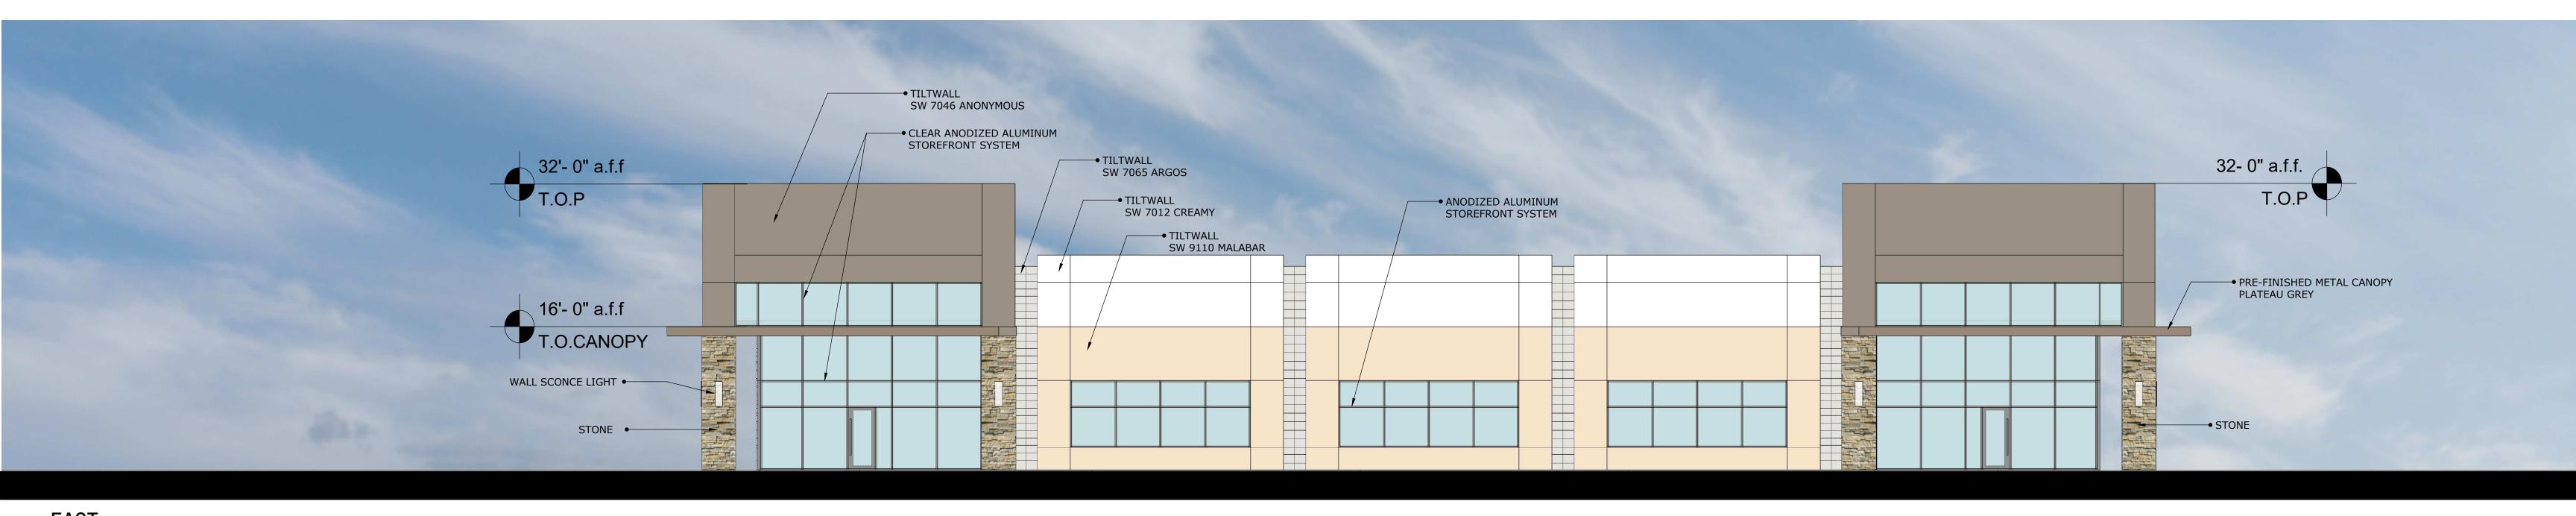

EAST

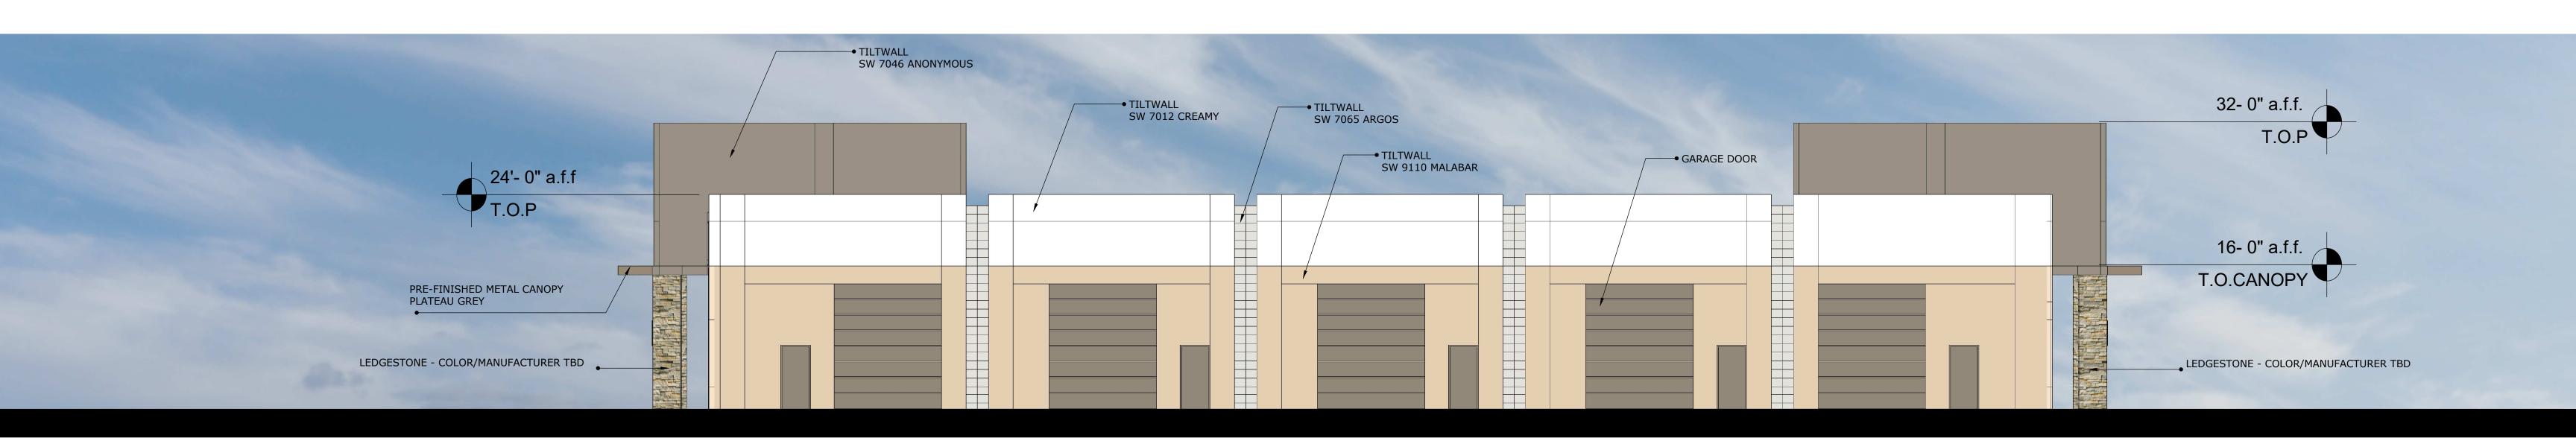

WEST

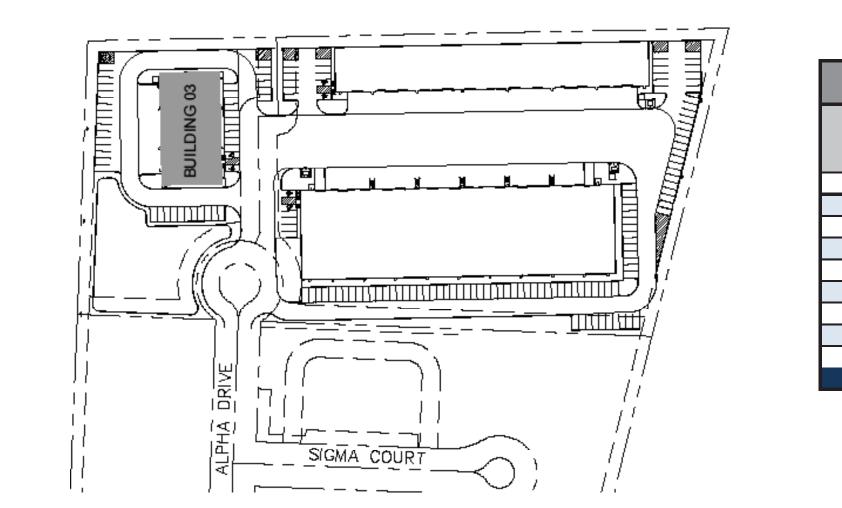

BLDG 3				
	METAL CANOPY	MASONRY	PRIMARY MASONRY: PAINTED CONCRETE TILT WALL	(EXC
NORTH	35	136	1,495	
SOUTH	35	136	1,495	
EAST	74	230	2,592	
WEST	0	0	3,000	
SF of Materials	144	502	8,582	
Percentage of Material	2%	5%	93%	

Y:	FAÇADE TOTAL SF
ΓE	(EXCLUSIVE OF DOORS &
	WINDOWS)
	1,666
	1,666
	2,896
	3,000
	TOTAL
	9,228
	100%

URBAN INDUSTRIAL CENTER - BLDG 3



#### November 26, 2019

TO:

Halff Associates C/O Matthew Gardner 1201 North Bouser Richardson, TX 75081

CC:

Rockwall Urban Institute, LP

C/O Reid Caldwell

13150 Coit Road, Suite 205

Dallas, TX 75240

FROM:

David Gonzales, AICP

City of Rockwall Planning and Zoning Department

385 S. Goliad Street Rockwall, TX 75087

SUBJECT:

SP2019-040; Site Plan for Ellis Center, Phase 2 Addition

Mr. Gardner:

This letter serves to notify you that the above referenced site plan case, that you submitted for consideration by the City of Rockwall, was approved by the Planning and Zoning Commission on November 12, 2019. The following is a record of all recommendations, voting records and conditions of approval:

#### Conditions of Approval

- (1) All staff comments provided by the Planning, Engineering and Fire Department must be addressed prior to the submittal of a building permit;
- (2) Approval by the Planning and Zoning Commission of all exceptions requested as outlined in staff's report;
- (3) The applicant will be required to revise the landscape plan to incorporate a mixture of trees and shrubs to screen the detention pond adjacent to the entryway off of Alpha Drive prior to submitting civil plans;
- (4) All Roof Top Units (RTU's) will need to be screened and not visible from adjacent properties or public rights-of-way; and
- (5) Any construction resulting from the approval of this site plan shall conform to the requirements set forth by the Unified Development Code (UDC), the International Building Code (IBC), the Rockwall Municipal Code of Ordinances, city adopted engineering and fire codes and with all other applicable regulatory requirements administered and/or enforced by the state and federal government

#### Planning and Zoning Commission

On November 12, 2019, the Planning and Zoning Commission's motion to approve the site plan with ARB recommendations and staff conditions passed by a vote of 5-0, with Commissioners Welch and Fishman absent. Additionally, the motion included approval of the exceptions requested for 1) building materials, 2) articulation, 3) residential screening fence, and 4) vertical walls within the detention pond as outlined in staff's report.

Prior to submitting your civil engineering plans to the Engineering Department, you will need to submit bonded and digital copies of the site plan showing that all outstanding comments have been addressed. Specifically, the following outstanding departmental comments will need to be addressed:

#### Outstanding Departmental Comments

#### Planning and Zoning

(1) The subject property will require submittal and approval of a replat prior to the issuance of a building permit (*Chapter 38, Subdivision, Unified Development Code*).

Please note that site plans that have not been completed within two (2) years of the final approval date shall be deemed to have expired. An extension may be granted by the Planning and Zoning Commission upon submission of a written request a least 90-days prior to the expiration date. Should you have any questions or concerns regarding your site plan or the site plan process, please feel free to contact me a (972) 771-7745.

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Sincerely,

David Gonzales, AICP
Planning and Zoning Manager