
ENGINEERING CONSTRUCTION PLANS FOR LAKE POINTE CHURCH

NEW CHAPEL/EDUCATIONAL BUILDING PART OF LOT 1 BLOCK A CITY OF ROCKWALL, ROCKWALL COUNTY, TEXAS

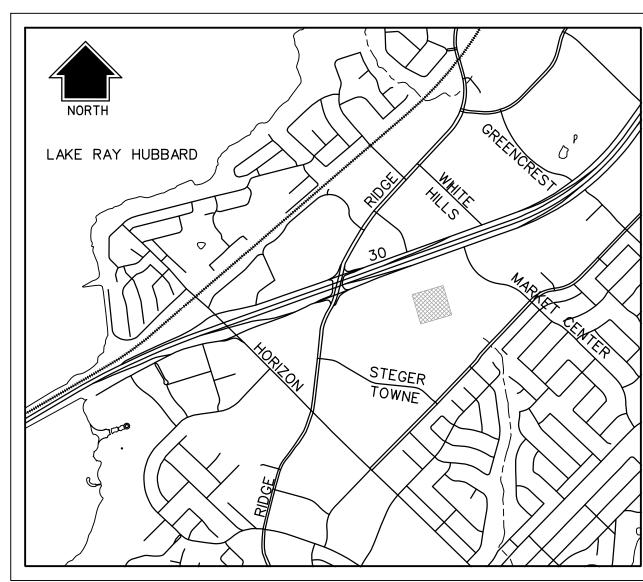

LOCATION MAP N.T.S. MAPSCO NO. 30C-G

HALFF®

3803 PARKWOOD BLVD., SUITE 800 FRISCO, TEXAS 75034-8640 TEL (214) 618-4570 FAX (214) 618-4574 TBPÈ FIŔM #F-312

RECORD DRAWING TO THE BEST OF OUR KNOWLEDGE HALFF ASSOCIATES, INC. HEREBY STATES THAT THIS PLAN IS A RECORD DRAWING. THESE RECORD DRAWINGS HAVE BEEN PREPARED BASED ON INFORMATION PROVIDED BY THE GENERAL CONTRACTOR MEDCO CONSTRUCTION L.L.C. DURING MAY 2018, FIELD OBSERVATIONS, ON 05/09/2018, AND FIELD SURVEY WORK CONDUCTED AT THE SITE. THIS INFORMATION INCLUDES MODIFICATIONS BY ADDENDA AND CHANGE ORDERS. THE PRAWINGS ARE ON FILE AT THE OFFICES HALFF ASSOCIATES, INC., TBPE FIRM #312

DATE 06/11/2018

10-3-2017 on 10-03-2017 Alteration of a sealed document without proper notification to the responsible engineer is an offense under the copy of this drawing is on file at the offices of Halff Associates, Inc., 3803 Parkwood Blvd., Frisco, Texas 75034. TBPE FIRM #F-312.

SHEET INDEX

C3.02

C4.01

C4.02

C5.01

C5.02

C6.01

C6.04

C6.05

C8.01

C9.01

C6.02-C6.03

COVER SHEET

GENERAL NOTES

DEMOLITION PLAN

SITE LOCATION PLAN

EROSION CONTROL PLAN

GRADING INSET DETAIL

STORM DRAIN PROFILE

STORM DRAIN CALCULATIONS

PRIVATE WASTE WATER PLAN

Revision

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STORM DRAIN PLAN

PUBLIC WATER PLAN

UTILITY PLAN

EROSION CONTROL NOTES & DETAILS

REPLAT

SITE PLAN

PAVING PLAN

PAVING DETAILS

GRADING PLAN

Description 04/25/2017 REVISED TO ADDRESS CITY COMMENTS GRADING, ADDED F.H, RAISED FL AND STORM DRAINAGE ·06/11/2018 | RECORD DRAWINGS

OWNER / DEVELOPER

LAKE POINTE CHURCH- ROCKWALL CAMPUS 701 INTERSTATE 30 ROCKWALL, TX 75087 **CONTACT: JOHN WARDELL** (PH) 469-698-2244

ARCHITECT


SHANKS ARCHITECTS 5151 BELTLINE ROAD, SUITE 840 DALLAS, TX 75254 CONTACT: TIM BROYLES, RA (PH) 972-788-9300


CIVIL ENGINEER

HALFF ASSOCIATES, INC. 3803 PARKWOOD BLVD., SUITE 800 FRISCO, TX 75034 TBPE FIRM #F-312 CONTACT: DAN WARFIELD, P.E. (PH) 214-618-4570

* DANIEL W. WARFIELD 95947

APRIL 2017 PROBABLE START OF CONSTRUCTION

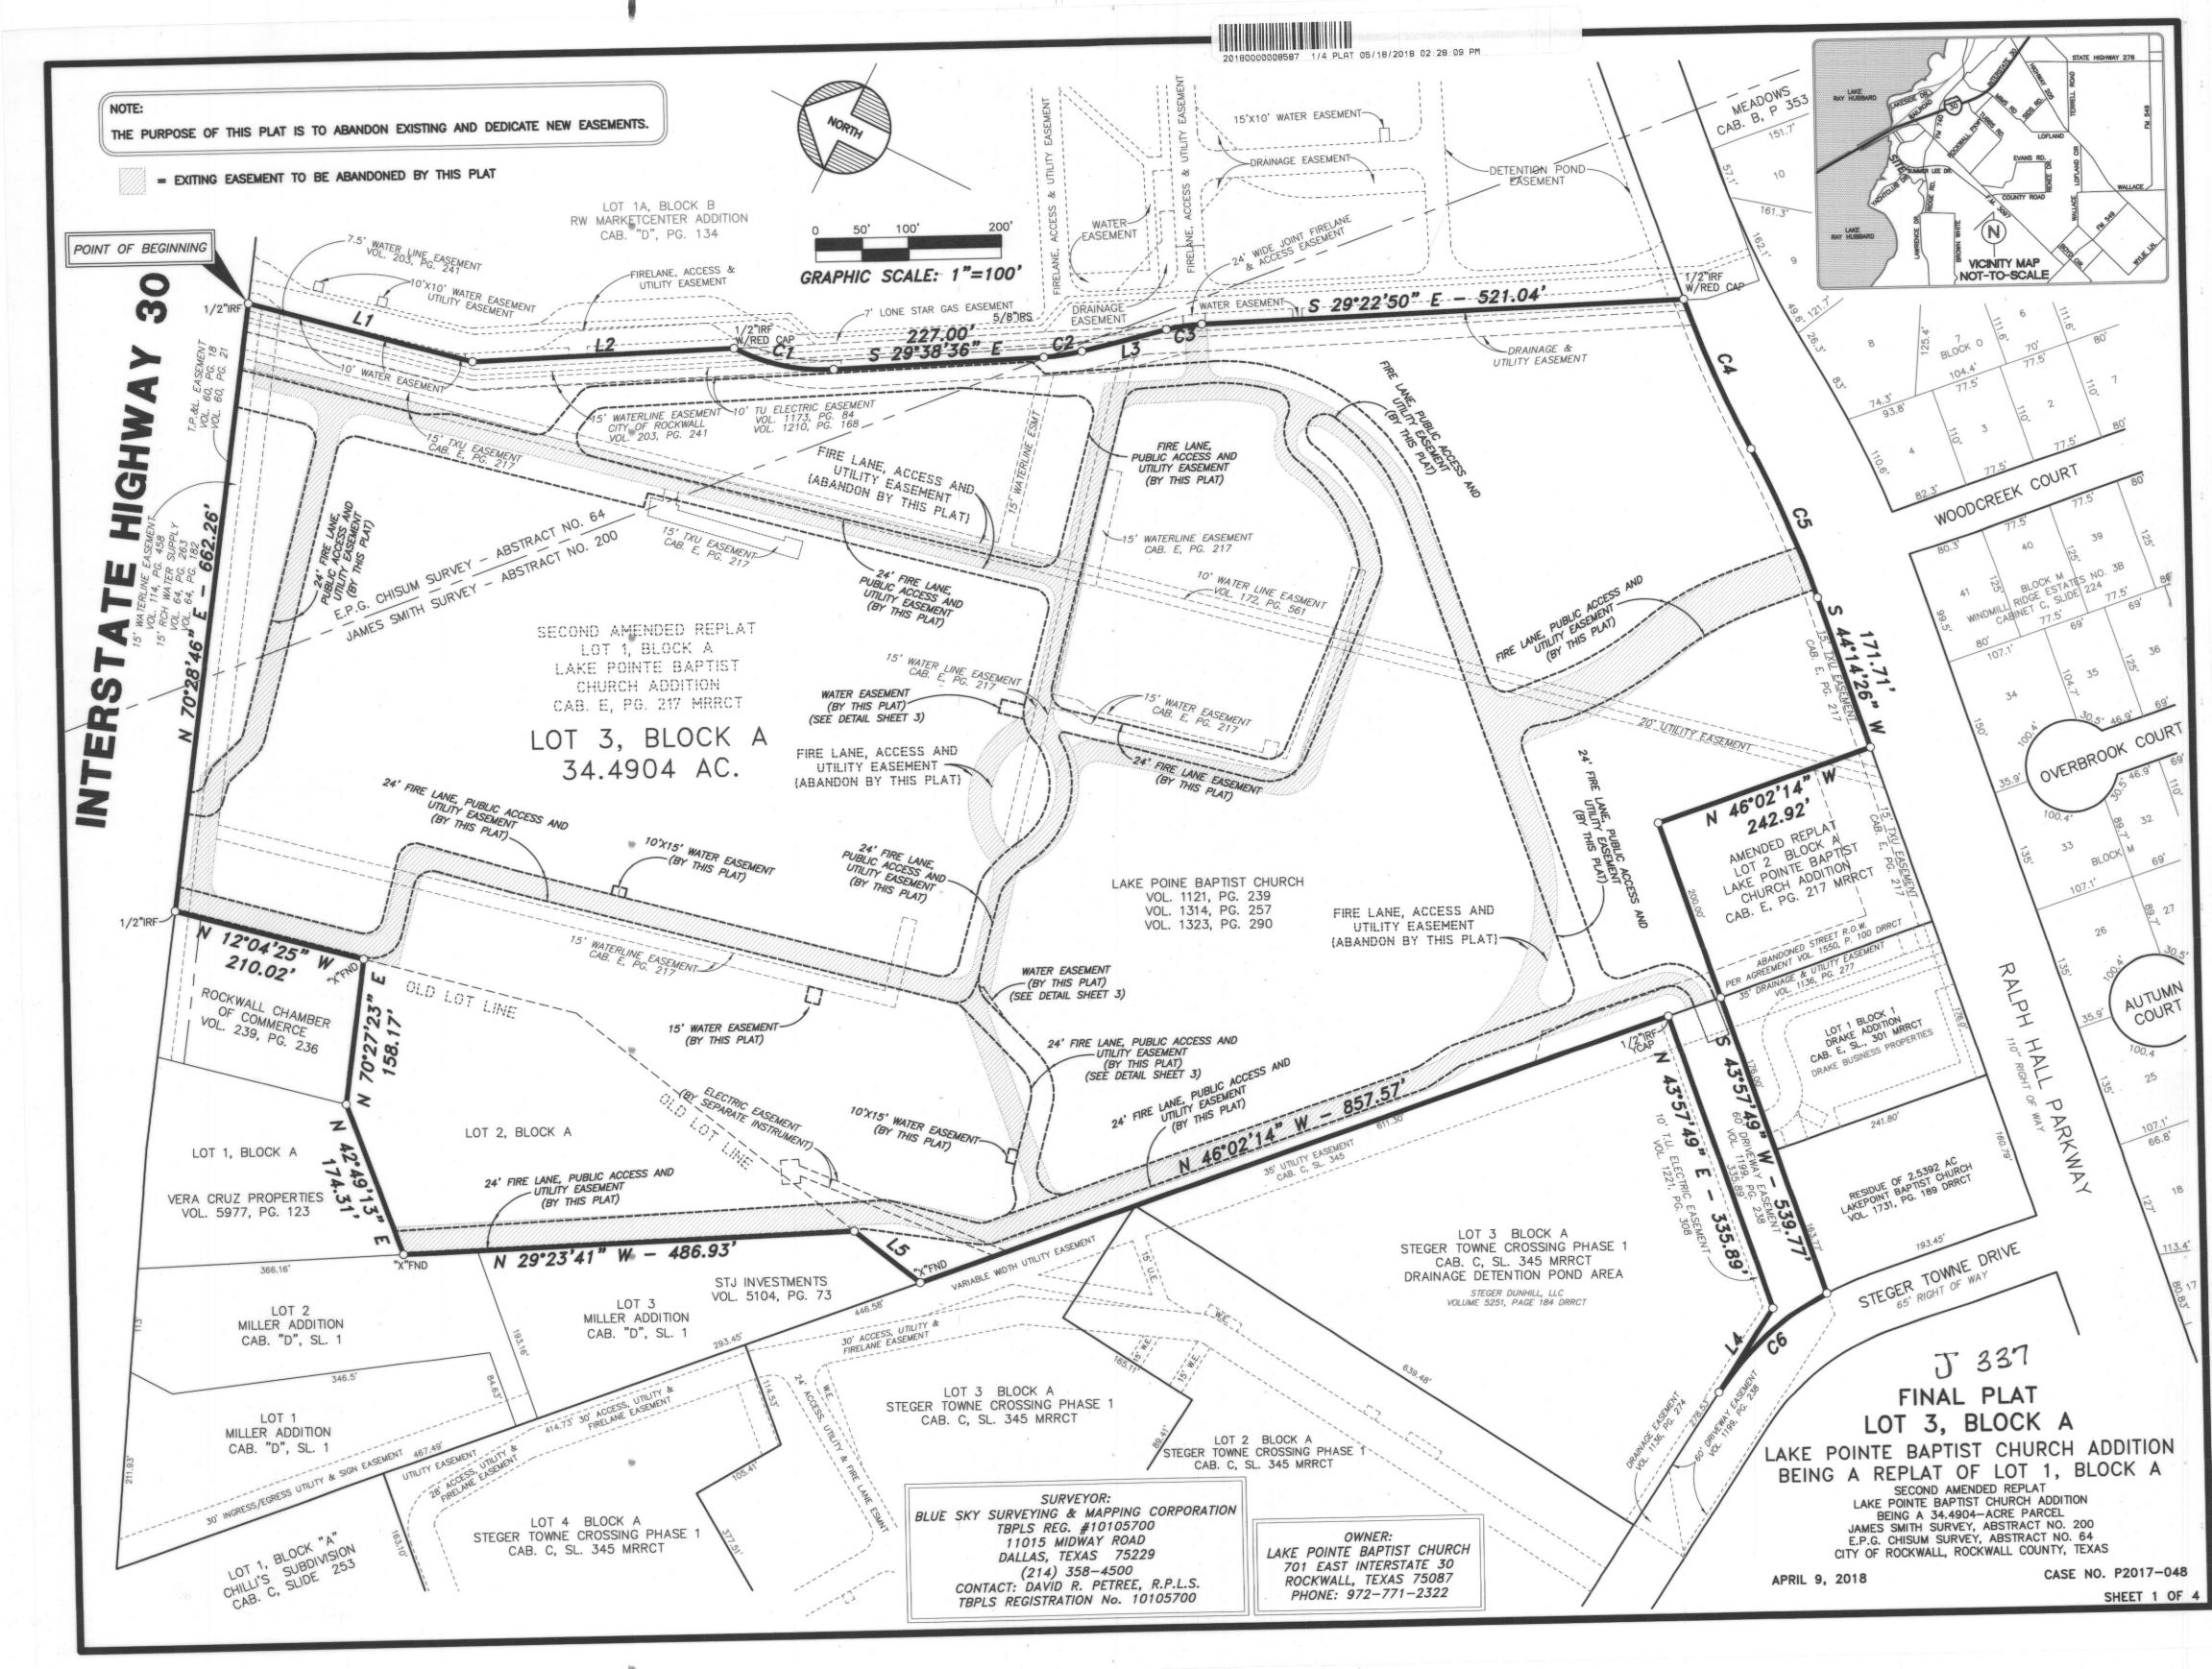

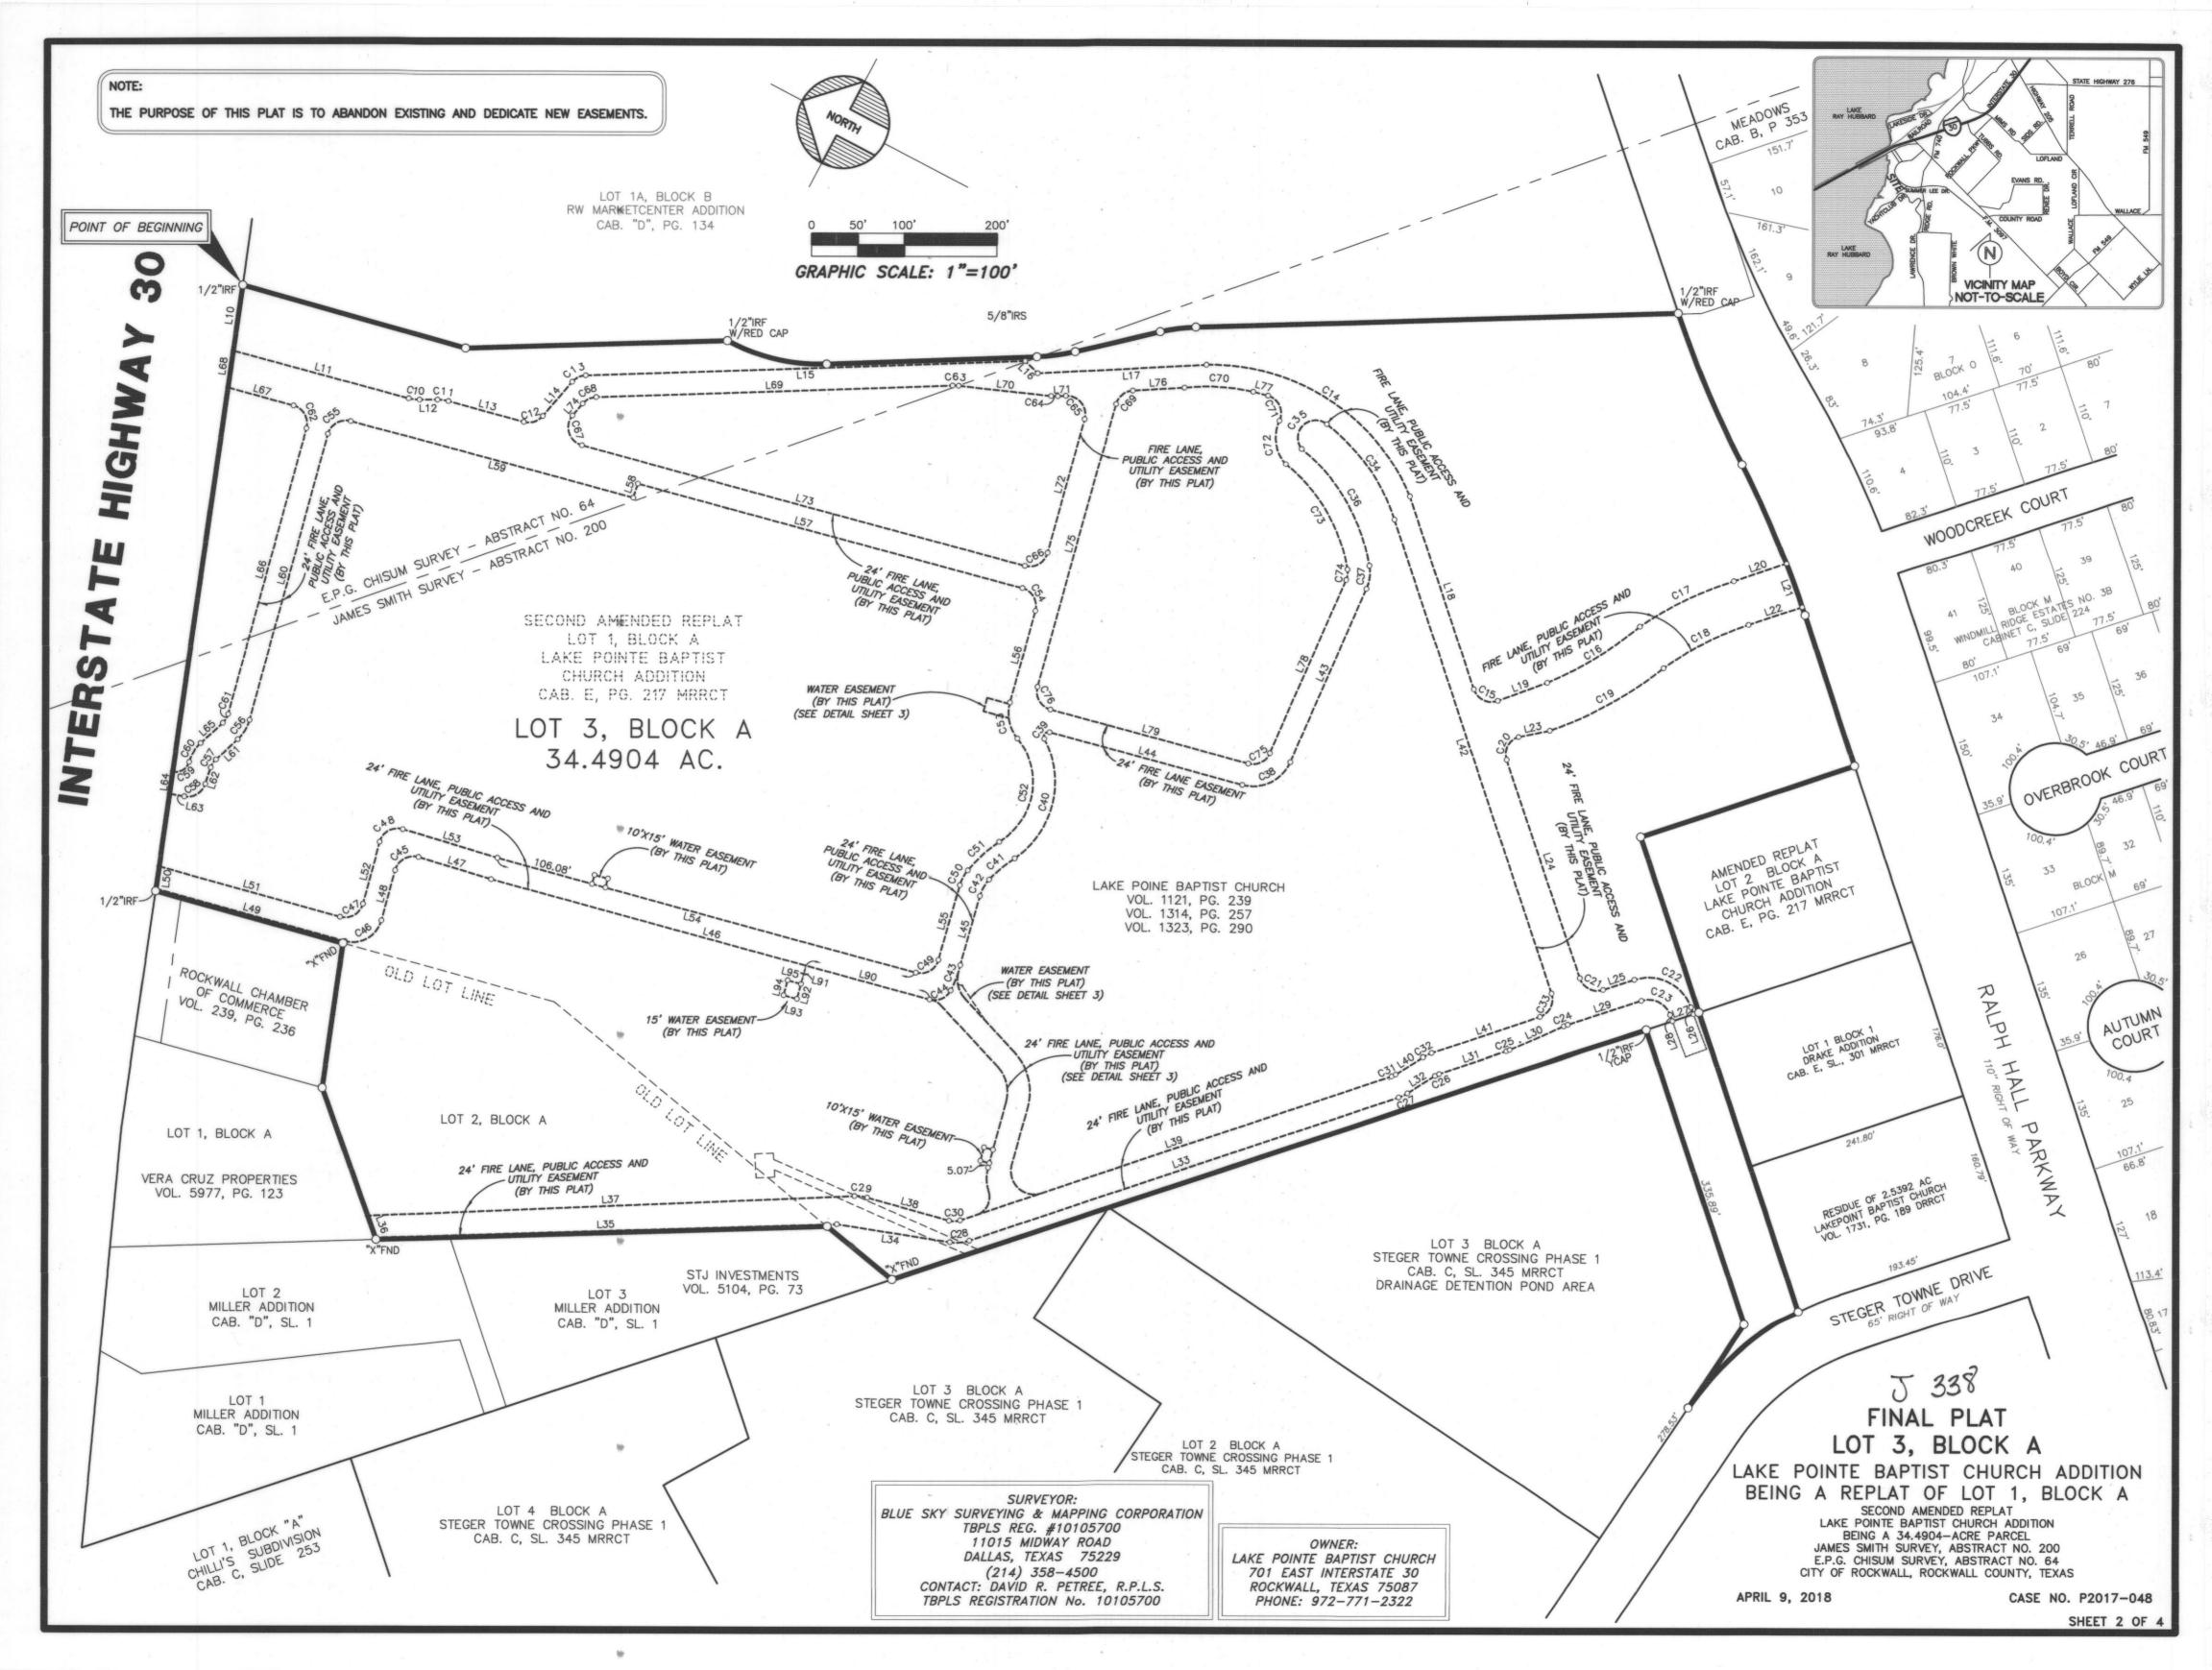

0	EASE	MENT	LINE	TABLE	~
	T	and the same of the same			

~ EASI	EMENT LINE	TABLE ~
NO.	BEARING	DISTANCE
L10	S70°28'46"W S12°27'15"E	72.02' 196.37'
L11	S27°42'55"E	196.37
L13	S12°16'56"E	84.59
L14	S77*24'22"E	48.77'
L15	S29°36'18"E	474.52
L16	S17*01'31"W	19.00'
L17	S30°42'18"E S44°00'31"W	182.24' 219.95'
L19	S47*54'54"E	56.81
L20	S46°20'41"E	59.74
L21	S42°31'14"W	50.01
L22	N46°20'41"W	60.73
L23	N39°15'47"W S43°50'33"W	34.45° 249.48°
L24	S45°45'57"E	35.43
L26	S42°17'11"W	7.88'
L27	N46°02'14"W	24.01'
L28	N42°17'11"E	7.18'
L29	N45°45'57"W N51°42'01"W	83.33' 63.97'
L30	N46°23'26"W	76.78
L32	N59*53'58"W	35.10'
L33	N46°08'27"W	488.25'
L34	N18*33'21"W	123.63'
L35	N29°23'41"W	498.11'
L36	N42°49'13"E S30°02'27"E	25.11' 525.84'
L38	S11'51'30"E	91.71
L39	S46°08'27"E	490.80'
, L40	S59*53'58"E	35.10'
L41	S46°23'26"E	123.46'
L42 L43	N43'59'46"E S86'03'09"W	540.14' 204.57'
L43	N12'24'29"W	215.32'
L45	S78°15'32"W	77.91
L46	N12°20'35"W	490.68
L47	N10°43'32"W	81.95'
L48	S77'32'09"W N12'04'25"W	56.30° 211.77°
L49 L50	N70°28'46"E	24.20'
L51	S12'04'25"E	202.82'
L52	N77*32'09"E	68.96'
L53	S10°43'32"E	106.35
L54	S12°20'35"E N78°15'32"E	468.27' 84.03'
L55	N77*43'40"E	102.79
L57	N12°27'15"W	429.99'
L58	S80°33'58"W	16.02'
L59	N12°27'15"W	316.11
L60 L61	S77*34'02"W N70*08'34"W	320.98' 32.23'
L62	S80°01'01"W	18.65
L63	N16'57'12"W	16.29'
L64	N70°28'46"E	24.04
L65	S70°08'34"E	32.23'
L66	N77*34'02"E N12*27'15"W	320.96' 73.30'
L67	N70°28'46"E	40.31
L69	S29'36'18"E	384.75
L70	S21°19'01"E	100.63'
L71	S30°42'18"E	8.67'
L72	S77*43'40"W N12*27'15"W	150.28' 495.58'
L73	S77*24'22"E	16.96
L75	N77°43'40"E	317.99'
L76	S31°03'47"E	55.81'
L77	S12*58'57"E	16.54'
L78	S86°03'09"W N12°24'29"W	204.57° 220.95°
L80	S46*08'27"E	19.31
L81	N77°41'53"E	73.86'
L82	N19°41'53"E	90.84
L83	S19°41'53"W	78.88'
L84 L85	S77*41'53"W N46*08'27"W	64.48' 73.37'
L86	N19'41'52"E	44.77
L87	N19°41'53"E	34.11'
L88	S12*16'27"E	4.88'
L89	S28'42'14"W	46.71
L90	N12°20'35"W S77°33'50"W	138.26' 20.46'
L91	\$77°33°50°W	16.74
L93	N12*26'10"W	15.00'
L94	N77°33'50"E	16.75
L95	S12°03'08"E	15.00'
L96	N12'16'20"W	28.44'
L97	N77°43'40"E	15.00' 25.18'

L98 S12'16'20"E 25.18'

~ EASEMENT CURVE TABLE ~ NO RADIUS DELTA ARC CH BEARING CHORD

					T
NO.	RADIUS	DELTA	ARC	CH. BEARING	CHORD
C10	44.00'	15°15'40"	11.72	S20°05'05"E	11.69
C11	44.00'	15*25'59"	11.85	S19'59'56"E	11.82'
C12	20.00'	65°07'25"	22.73'	S44'50'39"E	21.53
C13	20.00'	47°48'04"	16.69	S53°30'20"E	16.21
C14	230.52	69°20'46"	279.01	S05'23'15"W	262.29
C15	20.00'	91°55'24"	32.09	S01°57'11"E	28.76
		17'04'12"			
C16	394.06		117.40	S58'59'07"E	116.97
C17	366.93	17'40'37"	113.20'	S53°34'10"E	112.76
C18	332.28	17°53'01"	103.71	N54'41'18"W	103.29
C19	407.45	19'44'32"	140.39	N56°23'43"W	139.70
C20	19.69'	90°16'24"	31.02'	N89°38'56"W	27.91
C21	20.00'	89'36'30"	31.28'	S00°57'42"E	28.19
C22	49.00'	88.03,08,	75.30'	S01'44'23"E	68.11
		88.03,08			
C23	25.00'		38.42'	N01'44'23"W	34.75
C24	44.00'	5*56'03"	4.56'	N48'43'59"W	4.56
C25	44.00	5*18'35"	4.08'	N49°02'43"W	4.08'
C26	20.00'	13°30'32"	4.72'	N53°08'42"W	4.70
C27	44.00'	13'45'30"	10.57	N53'01'12"W	10.54
C28	44.00'	27°35'06"	21.18'	N32°20'54"W	20.98
C29	44.00'	18'10'57"	13.96'	S20'56'58"E	13.90'
C30	20.00'	34'16'57"	11.97	S28'59'59"E	11.79
					_
C31	20.00'	13°45'30"	4.80'	S53°01'12"E	4.79'
C32	44.00'	13°30'32"	10.37	S53'08'42"E	10.35
C33	20.00	89'46'01"	31.33'	N88°43'34"E	28.23
C34	211.45'	34.55'02"	128.86'	N27°12'04"E	126.88
C35	19.14'	166'46'26"	55.72'	N71°48'46"W	38.03
C36	210.95	40°45'42"	150.07	S32°22'05"W	146.93
C37	44.00'	33'18'13"	25.58	S69*24'02"W	25.22
C38	44.00'	81'32'22"	62.62'	N53*10'40"W	57.47
C39	5.00'	133°21'55"	11.64	N79°05'26"W	9.18'
C40	99.55	83'56'49"	· 145.86'	S76°12'01"W	133.16
C41	133.94'	15°23'00"	35.96	N67°18'07"W	35.85
C42	44.00'	26'44'51"	20.54	N88°22'03"W	20.35
C43	96.69'	17'18'49"	29.22'	N82°33'30"E	29.11
C44	20.00'	76°26'31"	26.68	N50°33'50"W	24.75
		91'44'19"		N56°35'41"W	
C45	20.00'		32.02'		28.71
C46	32.00'	90°23'25"	50.48	N57°16'08"W	45.41
C47	20.00'	90°23'25"	31.55	S57*16'08"E	28.38
C48	20.00'	91'44'19"	32.02	S56°35'41"E	28.71
C49	20.00'	89*23'53"	31.21'	S57*02'32"E	28.14
C50	44.00'	23°43'04"	18.21'	S89°52'56"E	18.08
C51	157.94'	16'42'37"	46.06	S69°40'06"E	45.90'
	75.55	97*24'28"	128.45	N72*19'32"E	113.53
C52			Table 1		
C53	44.00'	54'06'21"	41.55	N50°40'29"E	40.02
C54	20.00'	90°10'55"	31.48'	N32°38'12"E	28.33
C55	20.00'	89*58'42"	31.41	N57*26'36"W	28.28
C56	44.00'	32'17'23"	24.80'	N86°17'16"W	24.47
C57	20.00'	29.50,25"	10.42'	N85°03'47"W	10.30
C58	20.00'	83'01'47"	28.98'	N58'28'06"W	26.51
C59	15.00'	87°00'08"	22.78	S58*15'27"E	20.65
		31'36'57"		S85*57'03"E	23.97
C60	44.00'		24.28'		
C61	20.00'	32°17'23"	11.27'	S86°17'16"E	11.12'
C62	20.00'	90°01'18"	31.42'	N32°33'24"E	28.29
C63	44.00'	8'17'16"	6.36'	S25°27'40"E	6.36'
C64	44.00'	9°23'16"	7.21'	S26°00'40"E	7.20'
C65	20.00'	108*25'58"	37.85	S23'30'41"W	32.45
C66	20.00	89°49'05"	31.35'	N57°21'48"W	28.24
C67	20.00	115'02'53"	40.16'	N45'04'12"E	33.74
C68	20.00'	47°48'04"	16.69'	S53*30'20"E	16.21
C69	20.00'	71°12′33″	24.86'	S66'40'03"E	23.29
C70	228.59	18'44'25"	74.77	S24°25'35"E	74.43
C71	20.01	97*03'32"	33.90'	S37*38'09"W	29.99
C72	43.14'	67°44'04"	51.00'	S54'16'34"W	48.09
C73	186.95	41°23'50"	135.07	S32'03'01"W	132.16
C74		33'18'13"	11.63	S69*24'03"W	11.46
	20.00'				_
C75	20.00'	81°32'22"	28.46'	N53°10'40"W	26.12
C76	20.00	90.08,09,	31.46'	N32°39'36"E	28.32
C77	20.00'	90°00'00"	31.42	N88°51'33"E	28.28
C78	44.00'	33*50'20"	25.99'	N60°46'43"E	25.61
C79	40.00'	58°00'00"	40.49'	N48°41'53"E	38.78
C80	20.00'	31'40'23"	11.06'	N03'51'41"E	10.92
C81	20.00	68'19'08"	23.85	S54°37'31"E	22.46
C82	96.69	12'14'10"	20.65	N85'05'49"E	20.61
C83	30.00	56'22'12"	29.52	S47°52'58"W	28.34
C84	64.00'	58'00'00"	64.79	S48°41'53"W	62.06
C85	25.00'	123'50'20"	54.03'	S15°46'43"W	44.11
C86	30.00'	32'36'26"	17.07	N36°00'06"E	16.84
C87	44.00'	31'47'26"	24.41	S39°31'02"W	24.10
		20.05,31,		S65°27'30"W	15.35
C88	44.00'		15.43'		
C89	44.00'	2'13'24"	· 1.71'	S76°36'58"W	1.71


C89 44.00' 2'13'24" 1.71' S76'36'58"W 1.71'


~ BOUNDARY LINE TABLE ~


	NO.	BEARING	DISTANCE
	L1	S 11'47'11" E	249.84'
	L2	S 29°22'50" E	282.69'
	L3	S 41°04'08" E	94.02'
	L4	S 83'42'50" E	108.03
1	L5	N 11'47'11" E	90.49'
·		-	

~ BOUNDARY CURVE TABLE ~

NO.	RADIUS	DELTA	ARC	CH. BEARING	CHORD
C1	210.00	30°23'51"	111.41	S 14°26'40" E	110.11
C2	210.00'	11°25'32"	41.88	S 35°21'22" E	41.81'
СЗ	190.00'	11'41'18"	38.76	S 35°13'29" E	38.69'
C4	1250.00'	08*10'23"	178.31	S 39°29'51" W	178.16
C5	1150.00'	08*49'46"	177.22	S 39°49'33" W	177.04
C6	315.00'	29*05'23"	159.93'	N 69'09'56" W	158.22'

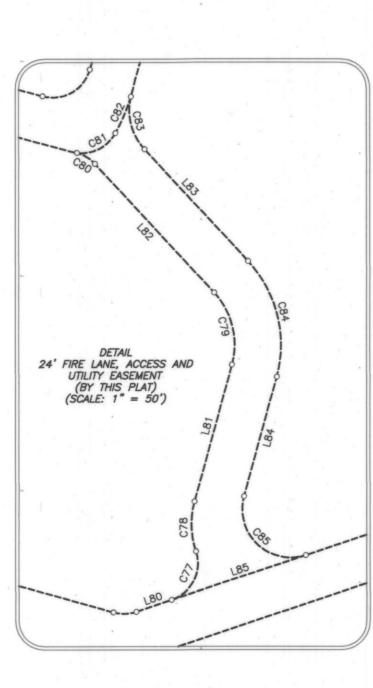

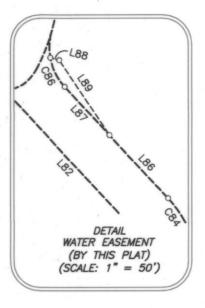

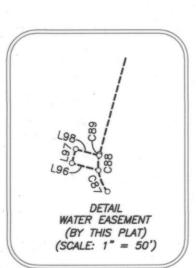

SURVEYOR:
BLUE SKY SURVEYING & MAPPING CORPORATION
TBPLS REG. #10105700
11015 MIDWAY ROAD DALLAS, TEXAS 75229 (214) 358-4500 CONTACT: DAVID R. PETREE, R.P.L.S. TBPLS REGISTRATION No. 10105700

OWNER: LAKE POINTE BAPTIST CHURCH 701 EAST INTERSTATE 30 ROCKWALL, TEXAS 75087 PHONE: 972-771-2322

THE PURPOSE OF THIS PLAT IS TO ABANDON EXISTING AND DEDICATE NEW EASEMENTS.

J 339 FINAL PLAT LOT 3, BLOCK A

LAKE POINTE BAPTIST CHURCH ADDITION

BEING A REPLAT OF LOT 1, BLOCK A

SECOND AMENDED REPLAT

LAKE POINTE BAPTIST CHURCH ADDITION

BEING A 34.4904—ACRE PARCEL

JAMES SMITH SURVEY, ABSTRACT NO. 200

E.P.G. CHISUM SURVEY, ABSTRACT NO. 64

CITY OF ROCKWALL, ROCKWALL COUNTY, TEXAS

APRIL 9, 2018

CASE NO. P2017-048

SHEET 3 OF 4

OWNER'S CERTIFICATE

STATE OF TEXAS
COUNTY OF ROCKWALL

WHEREAS, LAKEPOINTE BAPTIST CHURCH IS THE OWNER OF ALL THAT CERTAIN LOT, TRACT OR PARCEL OF LAND SITUATED IN THE E.P. GAINES CHISUM SURVEY, ABSTRACT NO. 64 AND THE JAMES SMITH SURVEY, ABSTRACT NO. 200 IN THE CITY OF ROCKWALL, ROCKWALL COUNTY, TEXAS, AND BEING ALL OF LOT 1 IN BLOCK A OF SECOND AMENDED REPLAT OF LOT 1 IN BLOCK A OF LAKE POINT BAPTIST CHURCH ADDITION, AN ADDITION TO THE CITY OF ROCKWALL, TEXAS ACCORDING TO THE PLAT THEREOF RECORDED IN CABINET E, SLIDE 217 OF THE PLAT RECORDS OF ROCKWALL COUNTY, TEXAS, AND BEING ALL OF THOSE TRACTS OF LAND AS DESCRIBED IN WARRANTY DEED TO THE CHURCH ON THE ROCK AS RECORDED IN VOLUME 286, PAGE 11 AND VOLUME 248, PAGE 323 OF THE DEED RECORDS OF ROCKWALL COUNTY, TEXAS, AND BEING MORE PARTICULARLY DESCRIBED BY METES AND BOUNDS AS FOLLOWS:

BEGINNING AT A 1/2" IRON ROD FOUND FOR CORNER IN THE SOUTH RIGHT-OF-WAY LINE OF INTERSTATE HIGHWAY 30, SAID POINT BEING THE NORTHEAST CORNER OF SAID LOT 1 IN BLOCK A;

THENCE FOLLOWING ALONG THE EAST LINE OF SAID LOT IN BLOCK A OF LAKE POINT BAPTIST CHURCH ADDITION AND THE WEST LINE OF SAID LOT 1A IN BLOCK B OF RW MARKETCENTER ADDITION THE FOLLOWING COURSES AND DISTANCES NUMBERED (1) THROUGH (8);

1. SOUTH 11' 47' 11" EAST FOR A DISTANCE OF 249.84 FEET TO A POINT FOR CORNER;

2. SOUTH 29° 22' 50" EAST FOR A DISTANCE OF 282.69 FEET TO A 1/2" IRON ROD WITH RED CAP FOUND FOR CORNER, SAID POINT BEING THE BEGINNING OF A CURVE TO THE LEFT HAVING A RADIUS OF 210.00 FEET WITH A CENTRAL ANGLE OF 30° 23' 51" AND A CHORD BEARING SOUTH 14° 26' 40" EAST AT A DISTANCE OF 110.11 FEET;

3. SOUTHEASTERLY AND FOLLOWING ALONG SAID CURVE TO THE LEFT FOR AN ARC DISTANCE OF 111.41 FEET TO A POINT FOR CORNER.

4. SOUTH 29° 38' 36" EAST FOR A DISTANCE OF 227.00 FEET TO A POINT FOR CORNER, SAID POINT BEING THE BEGINNING OF A CURVE TO THE LEFT HAVING A RADIUS OF 210.00 FEET WITH A CENTRAL ANGLE OF 11° 25' 32" AND A CHORD BEARING SOUTH 35° 21' 22" EAST AT A DISTANCE OF 41.81 FEET;

5. SOUTHEASTERLY AND FOLLOWING ALONG SAID CURVE TO THE LEFT FOR AN ARC DISTANCE OF 41.88 FEET TO A POINT FOR CORNER:

6. SOUTH 41° 04' 08" EAST FOR A DISTANCE OF 94.02 FEET TO A POINT FOR CORNER, SAID POINT BEING THE BEGINNING OF A CURVE TO THE RIGHT HAVING A RADIUS OF 190.00 FEET WITH A CENTRAL ANGLE OF 11° 41' 18" AND A CHORD BEARING SOUTH 35° 13' 29" EAST AT A DISTANCE OF 38.69 FEET;

7. SOUTHEASTERLY AND FOLLOWING ALONG SAID CURVE TO THE RIGHT FOR AN ARC DISTANCE OF 38.76 FEET TO A POINT FOR CORNER:

8. SOUTH 29° 22' 50" EAST FOR A DISTANCE OF 521.04 FEET TO A 1/2" IRON ROD WITH RED CAP FOUND FOR CORNER, SAID POINT BEING THE SOUTHEASTERLY CORNER OF AFORESAID LOT 1 IN BLOCK A OF LAKEPOINTE BAPTIST CHURCH ADDITION AND BEING IN THE NORTHWEST RIGHT-OF-WAY LINE OF RALPH HALL PARKWAY (110' RIGHT-OF-WAY), SAID POINT ALSO BEING THE SOUTHWEST CORNER OF AFORESAID LOT 1A IN BLOCK B OF RW MARKETCENTER ADDITION, SAID POINT BEING THE BEGINNING OF A CURVE TO THE LEFT HAVING A RADIUS OF 1250.00 FEET WITH A CENTRAL ANGLE OF 08' 10' 23" AND A CHORD BEARING SOUTH 39° 29' 51" WEST AT A DISTANCE OF 178.16 FEET;

THENCE SOUTHWESTERLY AND FOLLOWING ALONG SAID CURVE TO THE LEFT AND ALONG THE NORTHWEST RIGHT-OF-WAY LINE OF SAID RALPH HALL PARKWAY FOR AN ARC DISTANCE OF 178.31 FEET TO A POINT FOR CORNER, SAID POINT BEING THE BEGINNING OF A CURVE TO THE RIGHT HAVING A RADIUS OF 1150.00 FEET WITH A CENTRAL ANGLE OF 08' 49' 46" AND A CHORD BEARING SOUTH 39' 49' 33" WEST AT A DISTANCE OF 177.04 FEET;

THENCE SOUTHWESTERLY AND FOLLOWING ALONG SAID CURVE TO THE RIGHT AND ALONG THE NORTHWEST RIGHT-OF-WAY LINE OF SAID RALPH HALL PARKWAY FOR AN ARC DISTANCE OF 177.22 FEET TO A POINT FOR CORNER;

THENCE SOUTH 44° 14' 26" WEST AND CONTINUING ALONG THE NORTHWEST RIGHT-OF-WAY LINE OF SAID RALPH HALL PARKWAY FOR A DISTANCE OF 171.71 FEET TO A POINT FOR CORNER, SAID POINT BEING THE EASTERLY CORNER OF LOT 2 IN BLOCK A OF AMENDED REPLAT OF LAKE POINTE BAPTIST CHURCH ADDITION, AN ADDITION TO THE CITY OF ROCKWALL, TEXAS ACCORDING TO THE PLAT THEREOF RECORDED IN CABINET E, SLIDE 217 OF THE PLAT RECORDS OF ROCKWALL COUNTY, TEXAS;

THENCE NORTH 46' 02' 14" WEST AND DEPARTING THE NORTHWEST RIGHT-OF-WAY LINE OF SAID RALPH HALL PARKWAY AND ALONG THE COMMON LINE OF AFORESAID LOTS 1 AND 2 IN BLOCK A OF LAKEPOINTE BAPTIST CHURCH ADDITION FOR A DISTANCE OF 242.92 FEET TO A POINT FOR CORNER;

THENCE SOUTH 43° 57' 49" WEST ALONG THE COMMON LINE OF AFORESAID LOTS 1 AND 2 IN BLOCK A OF LAKEPOINTE BAPTIST CHURCH ADDITION AND PASSING THE WESTERLY CORNER OF SAID LOT 2 AND THE NORTHERLY CORNER OF LOT 1 IN BLOCK 1 OF DRAKE ADDITION, AN ADDITION TO THE CITY OF ROCKWALL, ROCKWALL COUNTY, TEXAS ACCORDING TO THE PLAT THEREOF RECORDED IN CABINET E, SLIDE 301 OF THE MAP RECORDS OF ROCKWALL COUNTY, TEXAS AND ALONG THE SOUTHEASTERLY LINE OF A 60' DRIVEWAY EASEMENT FOR A DISTANCE OF 539.77 FEET TO A POINT FOR CORNER IN THE NORTHEAST RIGHT—OF—WAY LINE OF STEGER TOWNE DRIVE (65' RIGHT—OF—WAY), SAID POINT BEING THE BEGINNING OF A CURVE TO THE RIGHT HAVING A RADIUS OF 315.00 FEET WITH A CENTRAL ANGLE OF 29' 05' 23" AND A CHORD BEARING NORTH 69' 09' 56" WEST AT A DISTANCE OF 158.22 FEET;

THENCE NORTHWESTERLY ALONG THE NORTHEAST RIGHT-OF-WAY LINE OF SAID STEGER TOWNE DRIVE FOR AN ARC DISTANCE OF 159.93 FEET TO A POINT FOR CORNER, SAID POINT BEING IN THE SOUTH LINE OF LOT 3 IN BLOCK A OF STEGER TOWNE CROSSING PHASE 1, AN ADDITION TO THE CITY OF ROCKWALL, ROCKWALL COUNTY, TEXAS ACCORDING THE THE PLAT THEREOF RECORDED IN CABINET "C", SLIDE 345 OF THE MAP RECORDS OF ROCKWALL COUNTY, TEXAS, SAID POINT ALSO BEING IN THE SOUTH LINE OF A TRACT OF LAND DESCRIBED IN DEED TO STEGER DUNHILL, LLC AS RECORDED IN VOLUME 5251, PAGE 184 OF THE DEED RECORDS OF ROCKWALL COUNTY, TEXAS;

THENCE SOUTH 83' 42' 50" EAST ALONG THE SOUTH LINE OF SAID LOT 3 IN BLOCK A OF STEGER TOWNE CROSSING PHASE I AND THE COMMON NORTH LINE OF SAID 60' DRIVEWAY EASEMENT FOR A DISTANCE OF 108.03 FEET TO A POINT FOR CORNER;

THENCE NORTH 43° 57' 49" EAST ALONG THE EASTERLY LINE OF SAID LOT 3 IN BLOCK A OF STEGER TOWNE CROSSING PHASE I AND THE COMMON NORTH LINE OF SAID 60' DRIVEWAY EASEMENT FOR A DISTANCE OF 335.89 FEET TO A 1/2" IRON ROD FOUND FOR CORNER, SAID POINT BEING THE EASTERLY CORNER OF SAID LOT 3 IN BLOCK A OF STEGER TOWNE CROSSING PHASE I ADDITION AND BEING IN THE WESTERLY LINE OF LOT 1 IN BLOCK A OF LAKE POINTE BAPTIST ADDITION;

THENCE NORTH 46° 02' 14" WEST ALONG THE WESTERLY LINE OF SAID LOT 1 IN BLOCK A OF LAKE POINTE BAPTIST ADDITION AND THE NORTHEASTERLY LINE OF SAID LOT 3 IN BLOCK A OF STEGER TOWNE CROSSING PHASE 1 FOR A DISTANCE OF 857.57 FEET TO AN "X" CUT IN CONCRETE FOUND FOR CORNER, SAID POINT BEING THE MOST SOUTHERLY SOUTHEAST CORNER OF LOT 3 OF MILLER ADDITION, AN ADDITION TO THE CITY OF ROCKWALL, ROCKWALL COUNTY, TEXAS ACCORDING TO THE PLAT THEREOF RECORDED IN CABINET D, SLIDE 1 OF THE PLAT RECORDS OF ROCKWALL COUNTY, TEXAS;

THENCE NORTH 11' 47' 11" EAST ALONG THE COMMON LINE OF SAID LOT 3 OF MILLER ADDITION AND SAID LOT 1 IN BLOCK A OF LAKE POINTE BAPTIST ADDITION FOR A DISTANCE OF 90.49 FEET TO A POINT FOR CORNER;

THENCE NORTH 29° 23' 41" WEST ALONG THE EASTERLY LINE OF SAID MILLER ADDITION AND THE WEST LINE OF SAID LOT 1 IN BLOCK A OF LAKE POINTE BAPTIST ADDITION FOR A DISTANCE OF 486.93 FEET TO AN "X" CUT IN CONCRETE FOUND FOR CORNER, SAID POINT BEING IN THE EAST LINE OF LOT 2 OF SAID MILLER ADDITION, SAID POINT ALSO BEING THE SOUTHERLY CORNER OF A TRACT OF LAND DESCRIBED IN DEED TO VERA CRUZ PROPERTIES AS RECORDED IN VOLUME 5977, PAGE 123 OF THE DEED RECORDS OF ROCKWALL COUNTY. TEXAS:

THENCE NORTH 42° 49' 13" EAST ALONG THE SOUTH LINE OF SAID VERA CRUZ TRACT FOR A DISTANCE OF 174.31 FEET TO A POINT FOR CORNER, SAID POINT BEING THE SOUTHEAST CORNER OF SAID VERA CRUZ TRACT AND THE SOUTHWEST CORNER OF A TRACT OF LAND DESCRIBED IN DEED TO ROCKWALL CHAMBER OF COMMERCE AS RECORDED IN VOLUME 239, PAGE 236 OF THE DEED RECORDS OF ROCKWALL COUNTY, TEXAS;

THENCE NORTH 70° 27' 23" EAST ALONG THE SOUTH LINE OF SAID ROCKWALL CHAMBER OF COMMERCE FOR A DISTANCE OF 158.17 FEET TO AN "X" CUT IN CONCRETE FOUND FOR CORNER;

THENCE NORTH 12" 04' 25" WEST ALONG THE EAST LINE OF SAID ROCKWALL CHAMBER OF COMMERCE FOR A DISTANCE OF 210.02 FEET TO A 1/2" IRON ROD FOUND FOR CORNER IN THE SOUTH RIGHT-OF-WAY LINE OF INTERSTATE HIGHWAY 30;

THENCE NORTH 70° 28' 46" EAST FOLLOWING ALONG THE SOUTH RIGHT-OF-WAY LINE OF INTERSTATE HIGHWAY 30 FOR A DISTANCE OF 662.26 FEET TO THE POINT OF BEGINNING AND CONTAINING 34.4904 ACRES OF LAND, MORE OR LESS.

NOW, THEREFORE, KNOW ALL MEN BY THESE PRESENTS:

STATE OF TEXAS
COUNTY OF ROCKWALL

WE, THE UNDERSIGNED OWNERS OF THE LAND SHOWN ON THIS PLAT, AND DESIGNATED HEREIN AS LOT 3, BLOCK A, LAKE POINTE BAPTIST CHURCH ADDITION, A SUBDIVISION TO THE CITY OF ROCKWALL, TEXAS, AND WHOSE NAME IS SUBSCRIBED HERETO, HEREBY DEDICATE TO THE USE OF THE PUBLIC FOREVER ALL STREETS, ALLEYS, PARKS, WATER COURSES, DRAINS, EASEMENTS AND PUBLIC PLACES THEREON SHOWN ON THE PURPOSE AND CONSIDERATION THEREIN EXPRESSED. WE FURTHER CERTIFY THAT ALL OTHER PARTIES WHO HAVE A MORTGAGE OR LIEN INTEREST IN LAKE POINTE BAPTIST CHURCH ADDITION HAVE BEEN NOTIFIED AND SIGNED THIS PLAT.

WE UNDERSTAND AND DO HEREBY RESERVE THE EASEMENT STRIPS SHOWN ON THIS PLAT FOR THE PURPOSES STATED AND FOR THE MUTUAL USE AND ACCOMMODATION OF ALL UTILITIES DESIRING TO USE OR USING SAME. WE ALSO UNDERSTAND THE FOLLOWING:

(1) NO BUILDINGS SHALL BE CONSTRUCTED OR PLACED UPON, OVER, OR ACROSS THE UTILITY EASEMENTS AS DESCRIBED

(2) ANY PUBLIC UTILITY SHALL HAVE THE RIGHT TO REMOVE AND KEEP REMOVED ALL OR PART OF ANY BUILDINGS, FENCES, TREES, SHRUBS, OR OTHER GROWTHS OR IMPROVEMENTS WHICH IN ANY WAY ENDANGER OR INTERFERE WITH CONSTRUCTION, MAINTENANCE OR EFFICIENCY OF THEIR RESPECTIVE SYSTEM ON ANY OF THESE EASEMENT STRIPS; AND ANY PUBLIC UTILITY SHALL AT ALL TIMES HAVE THE RIGHT OF INGRESS OR EGRESS TO, FROM AND UPON THE SAID EASEMENT STRIPS FOR PURPOSE OF CONSTRUCTION, RECONSTRUCTION, INSPECTING, PATROLLING, MAINTAINING, AND EITHER ADDING TO OR REMOVING ALL OR PART OF THEIR RESPECTIVE SYSTEM WITHOUT THE NECESSITY OF, AT ANY TIME, PROCURING THE PERMISSION OF ANYONE

(3) THE CITY OF ROCKWALL WILL NOT BE RESPONSIBLE FOR ANY CLAIMS OF ANY NATURE RESULTING FROM OR OCCASIONED BY THE ESTABLISHMENT OF GRADE OF STREETS IN THE SUBDIVISION.

(4) THE DEVELOPER AND SUBDIVISION ENGINEER SHALL BEAR TOTAL RESPONSIBILITY FOR STORM DRAIN IMPROVEMENTS.

(5) THE DEVELOPER SHALL BE RESPONSIBLE FOR THE NECESSARY FACILITIES TO PROVIDE DRAINAGE PATTERNS AND DRAINAGE CONTROLS SUCH THAT PROPERTIES WITHIN THE DRAINAGE AREA ARE NOT ADVERSELY AFFECTED BY STORM DRAINAGE FROM THE DEVELOPMENT.

(6) NO HOUSE DWELLING UNIT, OR OTHER STRUCTURE SHALL BE CONSTRUCTED ON ANY LOT IN THIS ADDITION BY THE OWNER OR ANY OTHER PERSON UNTIL THE DEVELOPER AND/OR OWNER HAS COMPLIED WITH ALL REQUIREMENTS OF THE SUBDIVISION REGULATIONS OF THE CITY OF ROCKWALL REGARDING IMPROVEMENTS WITH RESPECT TO THE ENTIRE BLOCK ON THE STREET OR STREETS ON WHICH PROPERTY ABUTS, INCLUDING THE ACTUAL INSTALLATION OF STREETS WITH THE REQUIRED BASE AND PAVING, CURB AND GUTTER, WATER AND SEWER, DRAINAGE STRUCTURES, STORM STRUCTURES, STORM SEWERS, AND ALLEYS, ALL ACCORDING TO THE SPECIFICATIONS OF THE CITY OF ROCKWALL; OR

UNTIL AN ESCROW DEPOSIT, SUFFICIENT TO PAY FOR THE COST OF SUCH IMPROVEMENTS, AS DETERMINED BY THE CITY'S ENGINEER AND/OR CITY ADMINISTRATOR, COMPUTED ON A PRIVATE COMMERCIAL RATE BASIS, HAS BEEN MADE WITH THE CITY SECRETARY, ACCOMPANIED BY AN AGREEMENT SIGNED BY THE DEVELOPER AND/OR OWNER, AUTHORIZING THE CITY TO MAKE SUCH IMPROVEMENTS AT PREVAILING PRIVATE COMMERCIAL RATES, OR HAVE THE SAME MADE BY A CONTRACTOR AND PAY FOR THE SAME OUT OF THE ESCROW DEPOSIT, SHOULD THE DEVELOPER AND/OR OWNER FAIL OR REFUSE TO INSTALL THE REQUIRED IMPROVEMENTS WITHIN THE TIME STATED IN SUCH WRITTEN AGREEMENT, BUT IN NO CASE SHALL THE CITY BE OBLIGATED TO MAKE SUCH IMPROVEMENTS ITSELF. SUCH DEPOSIT MAY BE USED BY THE OWNER AND/OR DEVELOPER AS PROGRESS PAYMENTS AS THE WORK PROGRESSES IN MAKING SUCH IMPROVEMENTS BY MAKING CERTIFIED REQUISITIONS TO THE CITY SECRETARY, SUPPORTED BY EVIDENCE OF WORK DONE; OR

UNTIL THE DEVELOPER AND/OR OWNER FILES A CORPORATE SURETY BOND WITH THE CITY SECRETARY IN A SUM EQUAL TO THE COST OF SUCH IMPROVEMENTS FOR THE DESIGNATED AREA, GUARANTEEING THE INSTALLATION THEREOF WITHIN THE TIME STATED IN THE BOND, WHICH TIME SHALL BE FIXED BY THE CITY COUNCIL OF THE CITY OF ROCKWALL.

WE FURTHER ACKNOWLEDGE THAT THE DEDICATIONS AND/OR EXACTION'S MADE HEREIN ARE PROPORTIONAL TO THE IMPACT OF THE SUBDIVISION UPON THE PUBLIC SERVICES REQUIRED IN ORDER THAT THE DEVELOPMENT WILL COMPORT WITH THE PRESENT AND FUTURE GROWTH NEEDS OF THE CITY; WE, OUR SUCCESSORS AND ASSIGNS HEREBY WAIVE ANY CLAIM, DAMAGE, OR CAUSE OF ACTION THAT WE MAY HAVE AS A RESULT OF THE DEDICATION OF EXACTIONS MADE HEREIN.

NOTE: IT SHALL BE THE POLICY OF THE CITY OF ROCKWALL TO WITHHOLD ISSUING BUILDING PERMITS UNTIL ALL STREETS, WATER, SEWER AND STORM DRAINAGE SYSTEMS HAVE BEEN ACCEPTED BY THE CITY. THE APPROVAL OF A PLAT BY THE CITY DOES NOT CONSTITUTE ANY REPRESENTATION, ASSURANCE OR GUARANTEE THAT ANY BUILDING WITHIN SUCH PLAT SHALL BE APPROVED, AUTHORIZED OR PERMIT THEREFORE ISSUED, NOR SHALL SUCH APPROVAL CONSTITUTE ANY REPRESENTATION, ASSURANCE OR GUARANTEE BY THE CITY OF THE ADEQUACY AND AVAILABILITY FOR WATER FOR PERSONAL USE AND FIRE PROTECTION WITHIN SUCH PLAT, AS REQUIRED UNDER ORDINANCE 83-54.

THIS PLAT APPROVED SUBJECT TO ALL PLATTING ORDINANCES, RULES, REGULATIONS, AND RESOLUTIONS OF THE CITY OF

WITNESS, MY HAND AT DALLAS, TEXAS, THIS THE 10th DAY OF HOLD , 2018

LAKE POINTE CHURCH

JOHN WARDELL, TRUSTEE

STATE OF TEXAS COUNTY OF ROCKWALL

BEFORE ME, THE UNDERSIGNED AUTHORITY, ON THIS DAY PERSONALLY APPEARED **JOHN WARDELL**, KNOWN TO ME TO BE THE PERSON WHOSE NAME IS SUBSCRIBED TO THE FOREGOING INSTRUMENT, AND ACKNOWLEDGED TO ME THAT HE EXECUTED THE SAME FOR THE PURPOSE AND CONSIDERATION THEREIN STATED.

GIVEN UPON MY HAND AND SEAL OF OFFICE THIS LOTH DAY OF HOLD, 2018

SURVEYOR:

BLUE SKY SURVEYING & MAPPING CORPORATION

TBPLS REG. #10105700

11015 MIDWAY ROAD

DALLAS, TEXAS 75229

(214) 358-4500

CONTACT: DAVID R. PETREE, R.P.L.S.

TBPLS REGISTRATION No. 10105700

NOTARY PUBLIC IN AND FOR THE STATE OF TEXAS MY COMMISSION EXPIRES:

BRAD BASSETT
Commission @ 11771880
My Commission Expires
October 20, 2019

Filed and Recorded
Official Public Records
Shelli Miller, County Clerk
Rockwall County, Texas
05/18/2018 02:28:09 PM
\$200.00
20180000008587

LE COUNTY DE LE CO

OWNER:
LAKE POINTE BAPTIST CHURCH
701 EAST INTERSTATE 30
ROCKWALL, TEXAS 75087
PHONE: 972-771-2322

SURVEYOR'S CERTIFICATE

NOW, THEREFORE KNOW ALL MEN BY THESE PRESENTS:
THAT I, DAVID PETREE, DO HEREBY CERTIFY THAT I PREPARED THIS PLAT FROM AN ACTUAL AND ACCURATE SURVEY OF THE LAND, AND THAT THE CORNER MONUMENTS SHOWN THEREON WERE PROPERLY PLACED UNDER MY PERSONAL SURVEY.

DAVID PETREE

STATE OF TEXAS

MY COMMISSION EXPIRES:

COUNTY OF DALLAS }

REGISTERED PROFESSIONAL

LAND SURVEYOR NO. 1890

BEFORE ME, THE UNDERSIGNED AUTHORITY, ON THIS DAY PERSONALLY APPEARED DAVID PETREE, KNOWN TO ME TO BE THE PERSON WHOSE NAME IS SUBSCRIBED TO THE FOREGOING INSTRUMENT, AND ACKNOWLEDGED TO ME THAT HE EXECUTED THE SAME FOR THE PURPOSE AND CONSIDERATION THEREIN STATED.

GIVEN UPON MY HAND AND SEAL OF OFFICE THIS 10 DAY OF HON

NOTARY PUBLIC IN AND FOR THE STATE OF TEXAS

KIMBERLI DONASCIMENTO
Notary Public, State of Texas
Comm. Expires 11-18-2020
Notary ID 130906475

RECOMMENDED FOR FINAL APPROVAL

PLANNING AND ZONING COMMISSION

PLANNING & ZONING

THIS APPROVAL SHALL BE INVALID UNLESS THE APPROVED PLAT FOR SUCH ADDITION IS RECORDED IN THE OFFICE OF THE COUNTY CLERK OF ROCKWALL, COUNTY, TEXAS, WITHIN ONE HUNDRED EIGHTY (180) DAYS FROM SAID DATE OF FINAL APPROVAL.

WITNESS OUR HANDS, THIS 1591 DAY OF May , 2018

SEAL SINGINEER

FINAL PLAT LOT 3, BLOCK A

LAKE POINTE BAPTIST CHURCH ADDITION BEING A REPLAT OF LOT 1, BLOCK A

SECOND AMENDED REPLAT
LAKE POINTE BAPTIST CHURCH ADDITION
BEING A 34.4904—ACRE PARCEL
JAMES SMITH SURVEY, ABSTRACT NO. 200
E.P.G. CHISUM SURVEY, ABSTRACT NO. 64
CITY OF ROCKWALL, ROCKWALL COUNTY, TEXAS

APRIL 9, 2018

CASE NO. P2017-048

SHEET 4 OF 4

- 2. Contractor is responsible for, and must obtain prior to construction, all necessary construction permits required by the City of Rockwall.
- 3. The Contractor shall abide by all applicable federal, state, and local laws governing excavation. The Contractor shall provide detailed plans and specifications for trench safety systems that comply with applicable laws governing excavation. These plans shall be sealed by an Engineer experienced in the design of trench safety systems and licensed by the State of Texas. Submit plan to the Owner prior to commencing work. The Contractor shall be solely responsible for all aspects of work related to excavation.
- 4. Existing utility locations shown are taken from available records provided by the utility Owner and field locations of surface appurtenances. Locations shown are generally schematic in nature and may not accurately reflect the size and location of each particular utility. Some utility lines may not be shown. Contractor shall assume responsibility for actual field location and protection of existing facilities whether shown or not. Contractor shall also assume responsibility for repairs to existing facilities, whether shown or not, damaged by contractor's activities. Differences in horizontal or vertical location of existing utilities shall not be a basis for additional expense.
- 5. Contractor shall locate and adjust existing utility manhole lids, cleanouts, water valves and other surface appurtenances as required for new construction. Contractor shall coordinate utility adjustments with other disciplines and the appropriate utility agencies and provide for all fees for permits, connections, inspections, etc.
- 6. The Contractor shall protect existing property monumentation and primary control. Any such points which the Contractor believes will be destroyed shall have offset points established by the Contractor prior to construction. Any monumentation destroyed by the Contractor shall be reestablished at his expense.
- 7. Any damages that may occur to real property or existing improvements shall be restored by the Contractor to at lease the same condition that the real property or existing improvements were in prior to the damages. This restoration shall be subject to the Owner's approval; moreover, this restoration shall not be a basis for additional compensation to the Contractor. Restoration shall include, but not be limited to, regrassing, revegetation, replacing fences, replacing trees, etc.
- 8. It shall be the responsibility of the Contractor to:
 - A. Prevent any damage to private property and property owner's poles, fences, shrubs, etc.
 - B. Provide access to all drives during construction.C. Protect all underground utilities to remain in service.
 - D. Notify all utility companies and verify location of all utilities prior to start of construction.
- 9. Contractor shall maintain positive drainage at all time during construction. Ponding of water in streets, drives, truck courts, trenches, etc. will not be allowed.
- 10. Contractor shall maintain existing sanitary sewer and water service at all times during construction.
- 11. Contractor is responsible for coordination with utility companies and adjustment of existing sanitary sewer cleanouts, water meters and any other appurtenances to new grade as required.
- 12. Pavement removal and repair shall conform to the City of Rockwall requirements. All sawcuts shall be full depth cuts. Contractor shall make efforts to protect concrete and/or asphalt edges. Any large spalled or broken edges shall be removed by sawcutting pavement prior to replacement.
- 13. Fire service shall be sized and designed by a State of Texas licensed fire protection engineer/contractor registered in the State of Texas
- 14. All underground fire lines shall be installed by a state licensed fire protection contractor.

provided to the City of Rockwallby others prior to start of construction.

15. All utility crossings shall comply with TCEQ Chapter 217 and 290 regulations.

EROSION CONTROL NOTES:

1. Refer to the Erosion Control Sheets, sheets C3.01 and C3.02, for Erosion Control notes.

DEMOLITION NOTES:

- 1. For additional extents for demolition, refer to grading, storm drainage, paving, and dimension control, water and
- sanitary sewer plans.
 2. Information provided on this plan does not delineate any underground foundation or objects that currently may be
- The contract shall be responsible for proper removal and disposal of materials as required by the Owner or Owner's representative.
- GRADING NOTES:
- No grading or earthwork shall commence until filing of a Notice of Intent to the Texas Commission of
 Environmental Quality (TCEQ) if applicable and Implementation of the Storm water Pollution Prevention Plan by
 the Contractor. A site erosion control plan and stormwater pollution prevention plan shall be prepared and
- 2. The existing ground surface shall be stripped of vegetation, roots, old construction debris, and other organic materials. Material unsuitable for fill shall be removed from the site and properly disposed of.
- 3. The subgrade should be firm and able to support the construction equipment without displacement. Soft or yielding subgrade should be corrected and made stable before construction proceeds. The subgrade shall be
- 4. All areas to receive fill shall be stripped of vegetation and the top six (6) inches scarified prior to receiving any fill. Fill material shall be placed in loose lifts not exceeding 8-inches in uncompacted thickness. The fill material shall be uniform with respect to material type and moisture content. Clods and chunks of material shall be broken down and the fill material mixed by disking, blading, or plowing, as necessary, so that a material of uniform moisture and density is obtained for each lift. Water required to bring the fill material to the proper moisture content should be sprinkled evenly through each layer.

proof rolled using a heavy pneumatic tire roller, loaded dump truck or similar piece of heavy equipment.

- 5. The on-site soils are suitable for use in site grading. Imported fill material shall be clean soil with a Liquid Limit less than 40 and no rock greater than 4 inches in maximum dimension. The fill material shall be free of vegetation and
- 6. The fill material shall be compacted between 95 and 98 percent of the maximum dry density as determined by the Standard Proctor test, ASTM D 698. In conjunction with the compacting operation, the fill material shall be brought to the proper moisture content. The moisture content of the compacted soils should be maintained between -2 and +2 percent of the optimum value (determined from ASTM D 698). All fill to be compacted using a sheep's foot roller.
- 7. The Contractor shall administer sprinklers for dust control, earthwork or base construction as required or as directed by the Engineer in accordance with the TXDOT Standard Specification for Construction, Item 204-Sprinklering.
- 8. Contractor's work shall include pavement removal and disposal required for new walk, drive, curb, gutter and other grading features. Contractor shall be responsible for all coordination, inspection and testing required by the
- 9. All sidewalks shall maintain 2% cross slope maximum. Longitudinal slopes along sidewalks and accessible routes shall not exceed 5% in the direction of travel. Slopes within designated handicap parking or loading areas shall not exceed 2% in any direction.
- 10. 4:1 Horizontal: Vertical is the maximum allowable slope within the earthen areas.
- 11. Site grading and pavement subgrade shall be prepared in accordance with the Geotechnical Report No. G161157 prepared by ALPHA TESTING dated 06/10/2016.
- 12. Proposed spot elevations represent gutter elevation unless noted otherwise.

PAVING NOTES:

- Pavement removal and repair shall conform to City of Rockwall requirements. All sawcuts shall be full depth cuts.
 Contractor shall make efforts to protect concrete. Any large spalled or broken edges shall
 be removed by sawcutting pavement prior to replacement.
- 2. Contractor's work shall include pavement removal and disposal required for new walk, drive, curb, gutter and other paving features. Contractor shall be responsible for all coordination, inspection and testing required by the Owner and/or the City of Rockwall.
- 3. Concrete paving joints shall be constructed as recommended in the geotechnical report noted below. Expansion joints shall be placed at changes in direction of paving, at driveways and/or as shown on the drawings. Seal all joints as shown on the drawings.
- 4. Paving sections shall be sawcut in 15' x15' squares.

PRIVATE WATER AND SANITARY SEWER NOTES:

- 5. Site grading and pavement subgrade shall be prepared in accordance with the Geotechnical Report No. G161157 prepared by ALPHA TESTING dated 06/10/2016.
- 6. Unless otherwise indicated on plans, all dimensions are to face of curb or face of building and are perpendicular to property line. These dimensions are provided to tie the Architect's Site Plan to the property lines.
- 7. All sidewalks and handicap parking areas shall meet current ADA standards for minimum and maximum slopes.
- 1. All materials and workmanship for private utility construction shall conform to the Standard Specifications for Public Works Construction for North Central Texas, latest edition, and the City of Rockwall requirements.
- 2. Pipe material for water and sanitary sewer lines shall conform to the notes shown on this drawing and to requirements of the project specifications. Water line for fire service shall be C900 PVC, DR 14 Class 200, Water lines for domestic use shall be Type 'K' Copper from tap to meter and copper or AWWA C900 PVC, DR-18 Class 235 from meter to building.
- 3. All water lines for domestic use shall be Type 'K' Copper from tap to meter and copper or
- 4. All bends and tees in water mains shall have thrust blocking provided in accordance with City of Rockwall standard details.
- 5. No water jetting shall be allowed.
- 6. All sanitary sewer pipe 12" and smaller shall be PVC SDR 26 pipe, heavy wall, in compliance with ASTM D 2241, latest revision. All pipe joints shall be in compliance with ASTM D 3139, latest, revision. Other pipe material shall be subject to approval by the City Engineer.
- 7. Water mains shall have the following minimum cover below street grades:



- 8. Coordinate utility service locations with most current Architectural/MEP Plans for this project. Notify Engineer with any discrepancies.
- 9. Fire service shall be sized and designed by a State of Texas licensed fire protection engineer/contractor registered in the State of Texas.
- 10. All underground fire lines shall be installed by a state licensed fire protection contractor.
- 11. Refer to City of Rockwall standard details for DDC valve and vault construction, Water and Sanitary Sewer embedment and water thrust blocking.
- 12. Field adjustments shall not be made without notification of the Owner and engineer.
- 13. Utility service locations shall be plugged 5' from future building. Refer to Architectural /MEP Plans for this project for future continuation of building utilities.
- 14. All water and sanitary sewer services shall be tested as required by the City of Rockwall. Paving shall not take place until utilities are tested and accepted by the City of Rockwall.
- 15. All utility crossings shall comply with TCEQ Chapter 217 and 290 regulations.
- 16. All public water lines shall be DR-14 Class 200.
- 7. Contractor shall install blue EMS disks on the water line at every change in direction, valve, service connection, fire hydrant, and 250'.

DRAINAGE NOTES:

- 1. All materials and workmanship for storm drain construction shall conform to the Standard Specifications for Public Works Construction for North Central Texas, latest edition, and the City of Rockwall General Design Standards, latest edition.
- 2. During the construction of these improvements, any interpretation of the Standard Specifications for Public Works Construction for North Central Texas, and any matter which requires the approval of the Owner, must be approved by the appropriate governmental official before any construction involving that decision commences. Assumptions about what these decisions might be which are made during the bidding phase will have no bearing on the decision.

POINTE CHURCH EL / EDUCATION BUILDIN

3803 PARKWOOD BLVD, SUITE 800 FRISCO, TEXAS 75034-8640 FAX (214) 618-4570 FAX (14) 618-4574 FAB 619-4574



The seal appearing on this document was authorized by Daniel W. Warfield, P.E. 95947 on 10-03-2017 Alteration of a sealed document without proper notification to the responsible engineer is an offense under the Texas Engineering Practice Act. The record copy of this drawing is on file at the offices of Halff Associates, Inc., 3803 Parkwood Blvd., Frisco, Texas 75034. TBPE FIRM #F-312.

Project No.: 31697

Checked By: DWW

08/01/2017

AS NOTED

TRS

GENERAL NOTES

Issued:

Scale:

Drawn By:

Sheet Title


HALFF ASSOCIATES, INC. HEREBY STATES THAT THIS PLAN IS A RECORD DRAWING. THESE RECORD DRAWINGS HAVE BEEN PREPARED BASED ON INFORMATION PROVIDED BY THE GENERAL CONTRACTOR, MEDCO CONSTRUCTION L.L.C.


DURING MAY 2018, FIELD OBSERVATIONS, ON 05/09/2018, AND FIELD SURVEY WORK CONDUCTED AT THE SITE. THIS INFORMATION INCLUDES MODIFICATIONS BY ADDENDA AND CHANGE ORDERS. THE ORIGINAL SEALED CONSTRUCTION DRAWINGS ARE ON FILE AT THE OFFICES OF:

RECORD DRAWING
TO THE BEST OF OUR KNOWLEDGE

DANIEL W. WARFIELD, P.E. 95947 HALFF ASSOC. TBPE FIRM #312 DATE 06/11/2018


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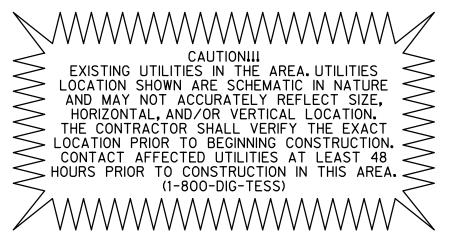


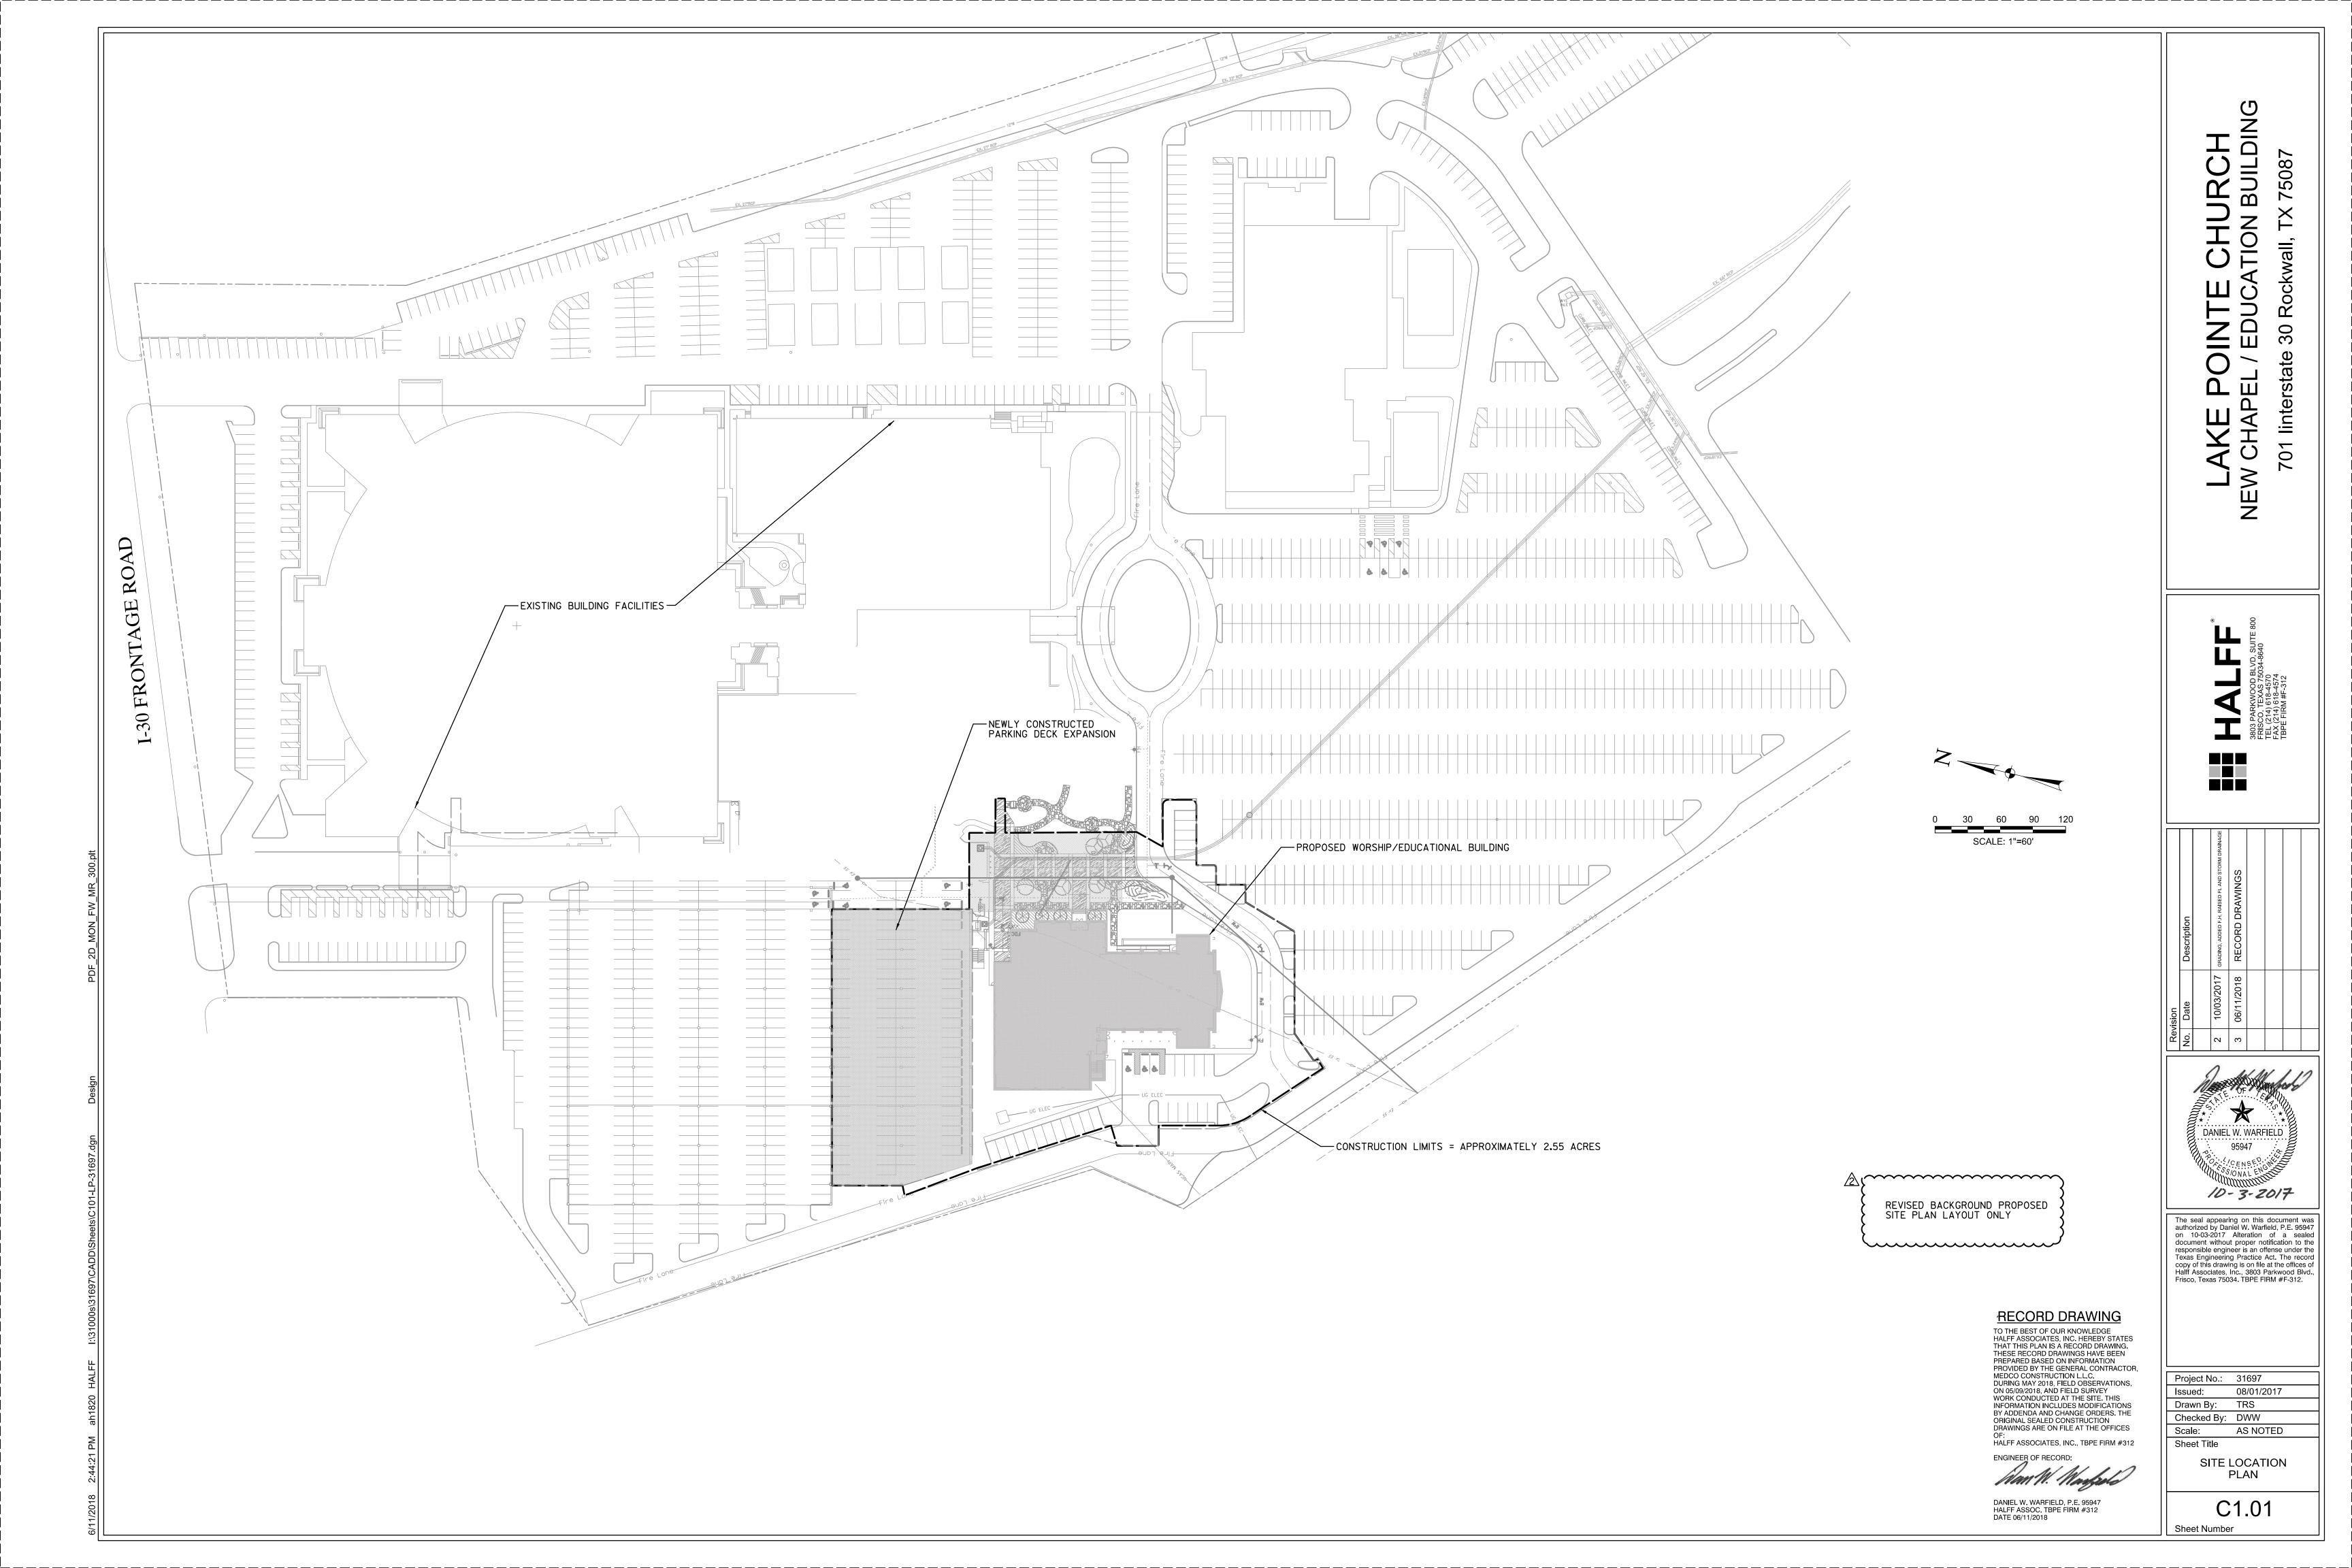


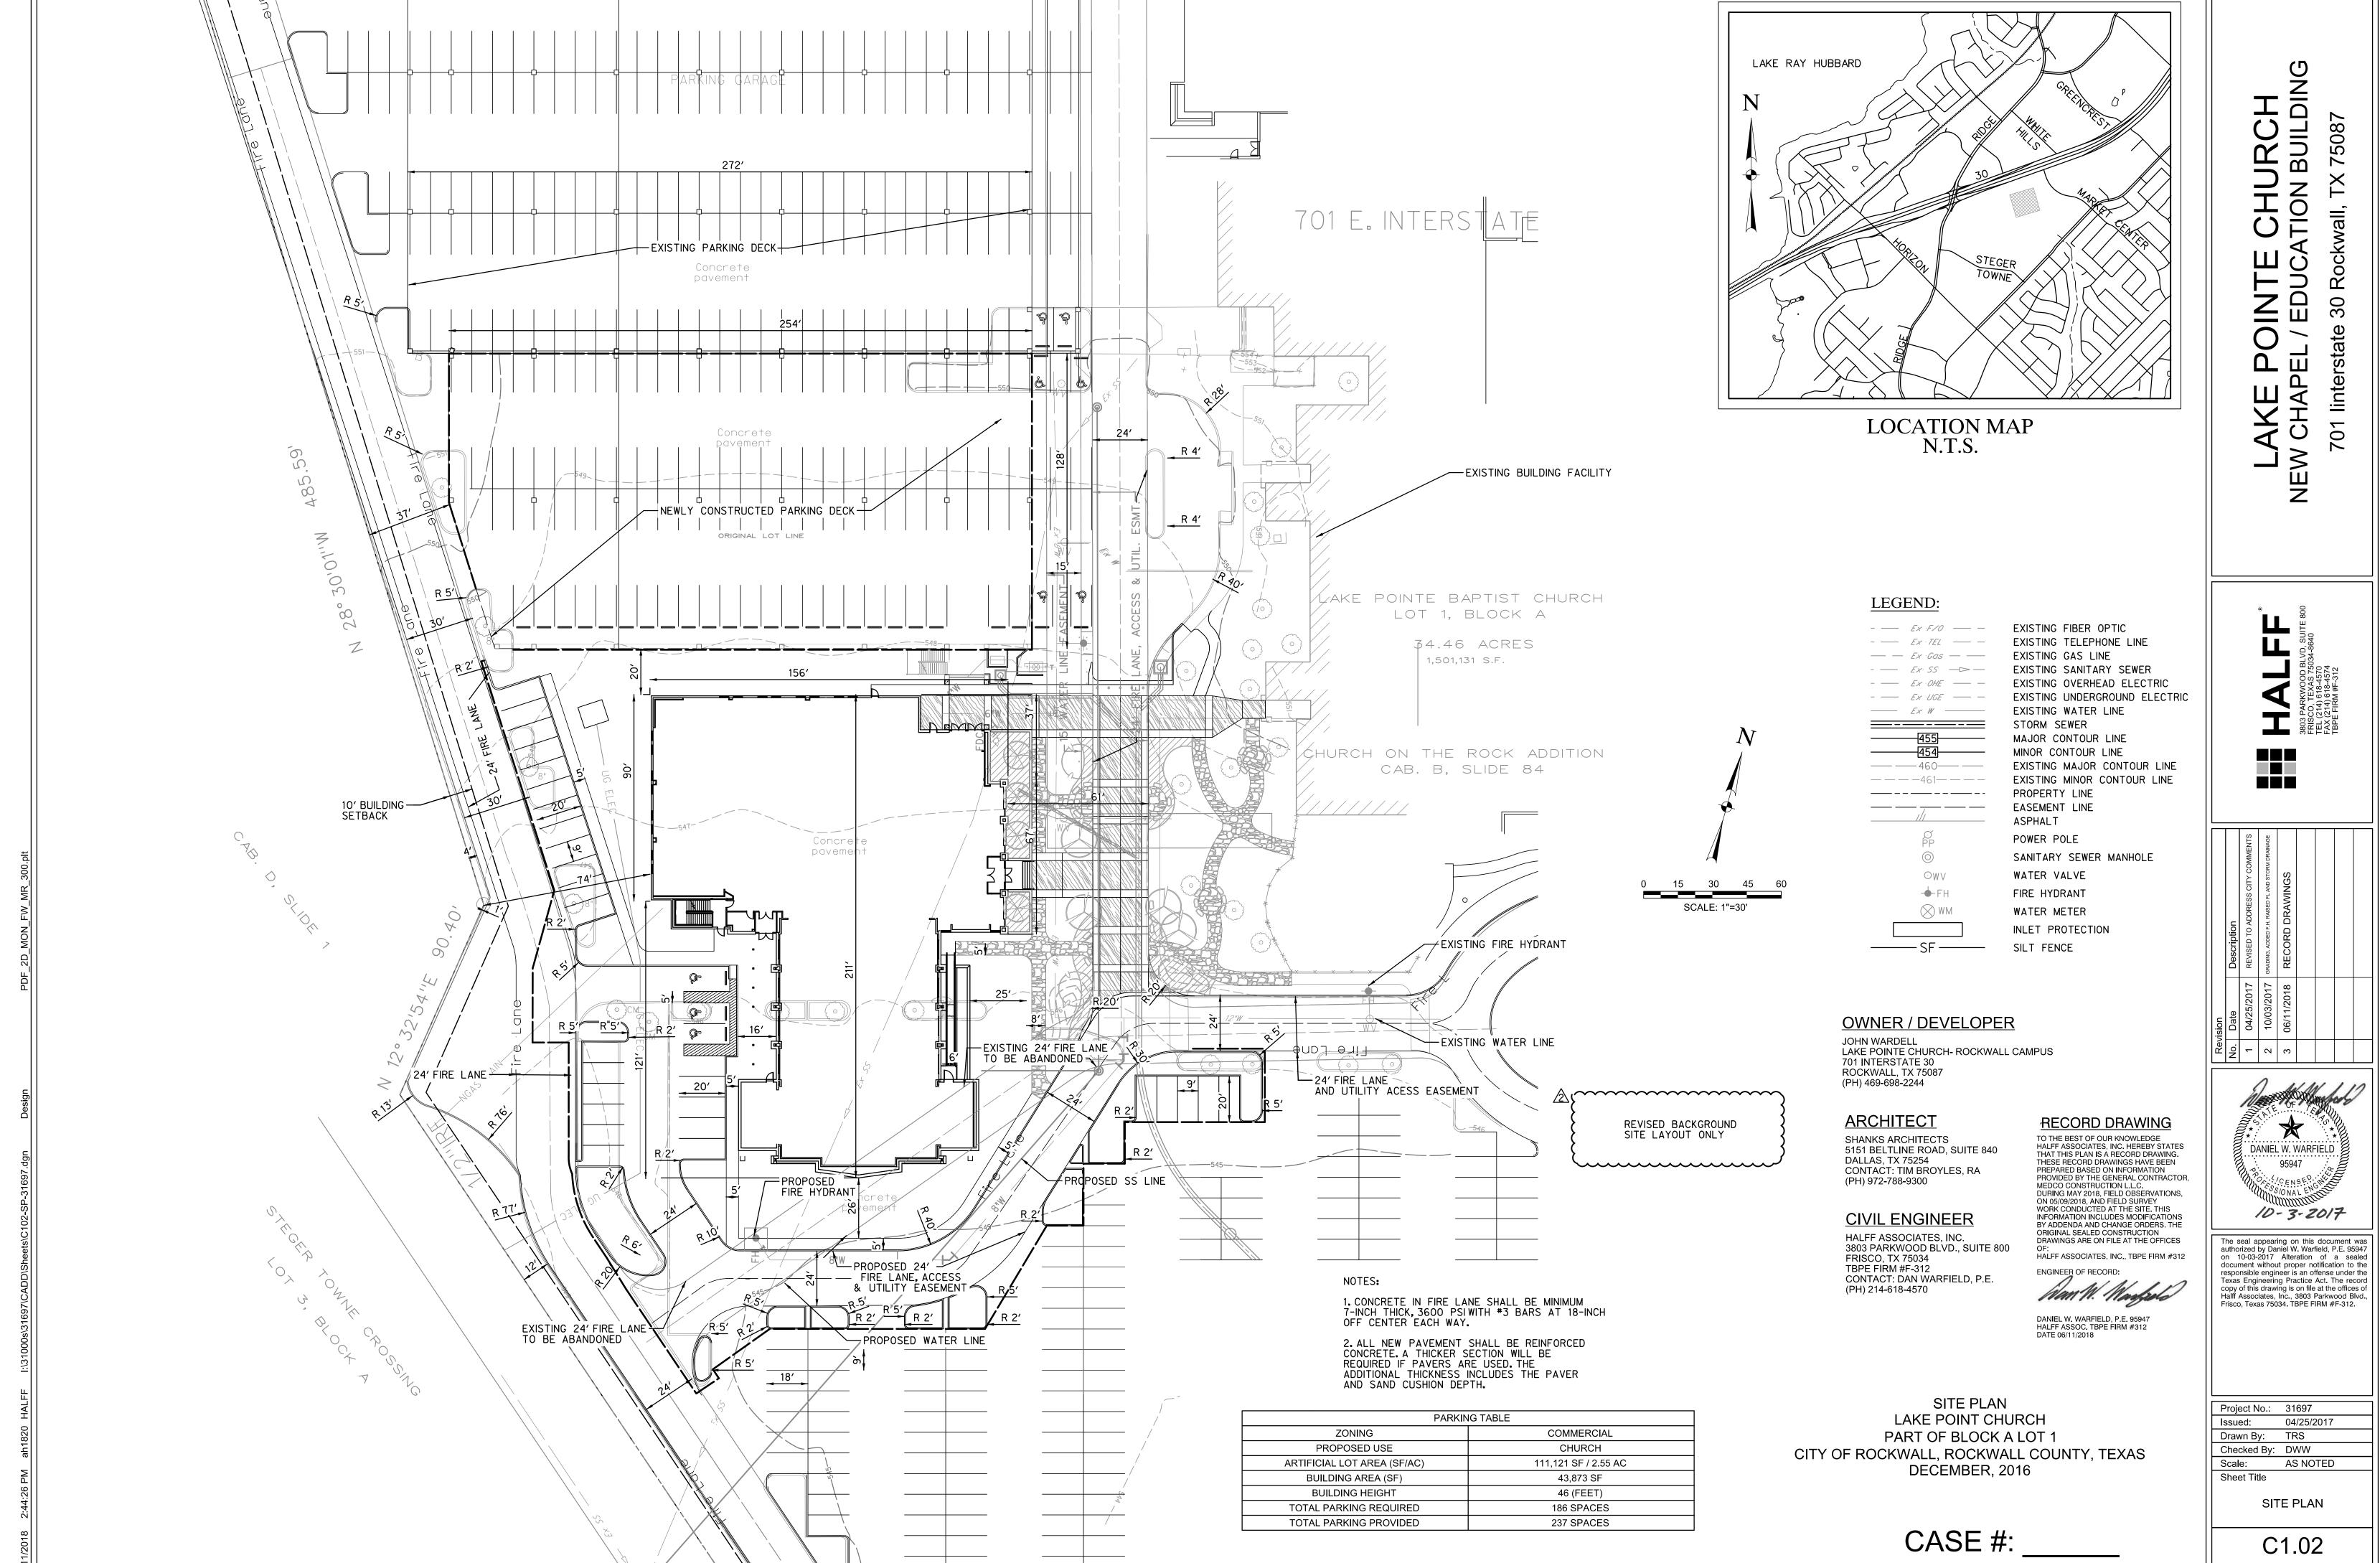The seal appearing on this document was authorized by Daniel W. Warfield, P.E. 95947 on 10-03-2017 Alteration of a sealed document without proper notification to the

Sheet Number



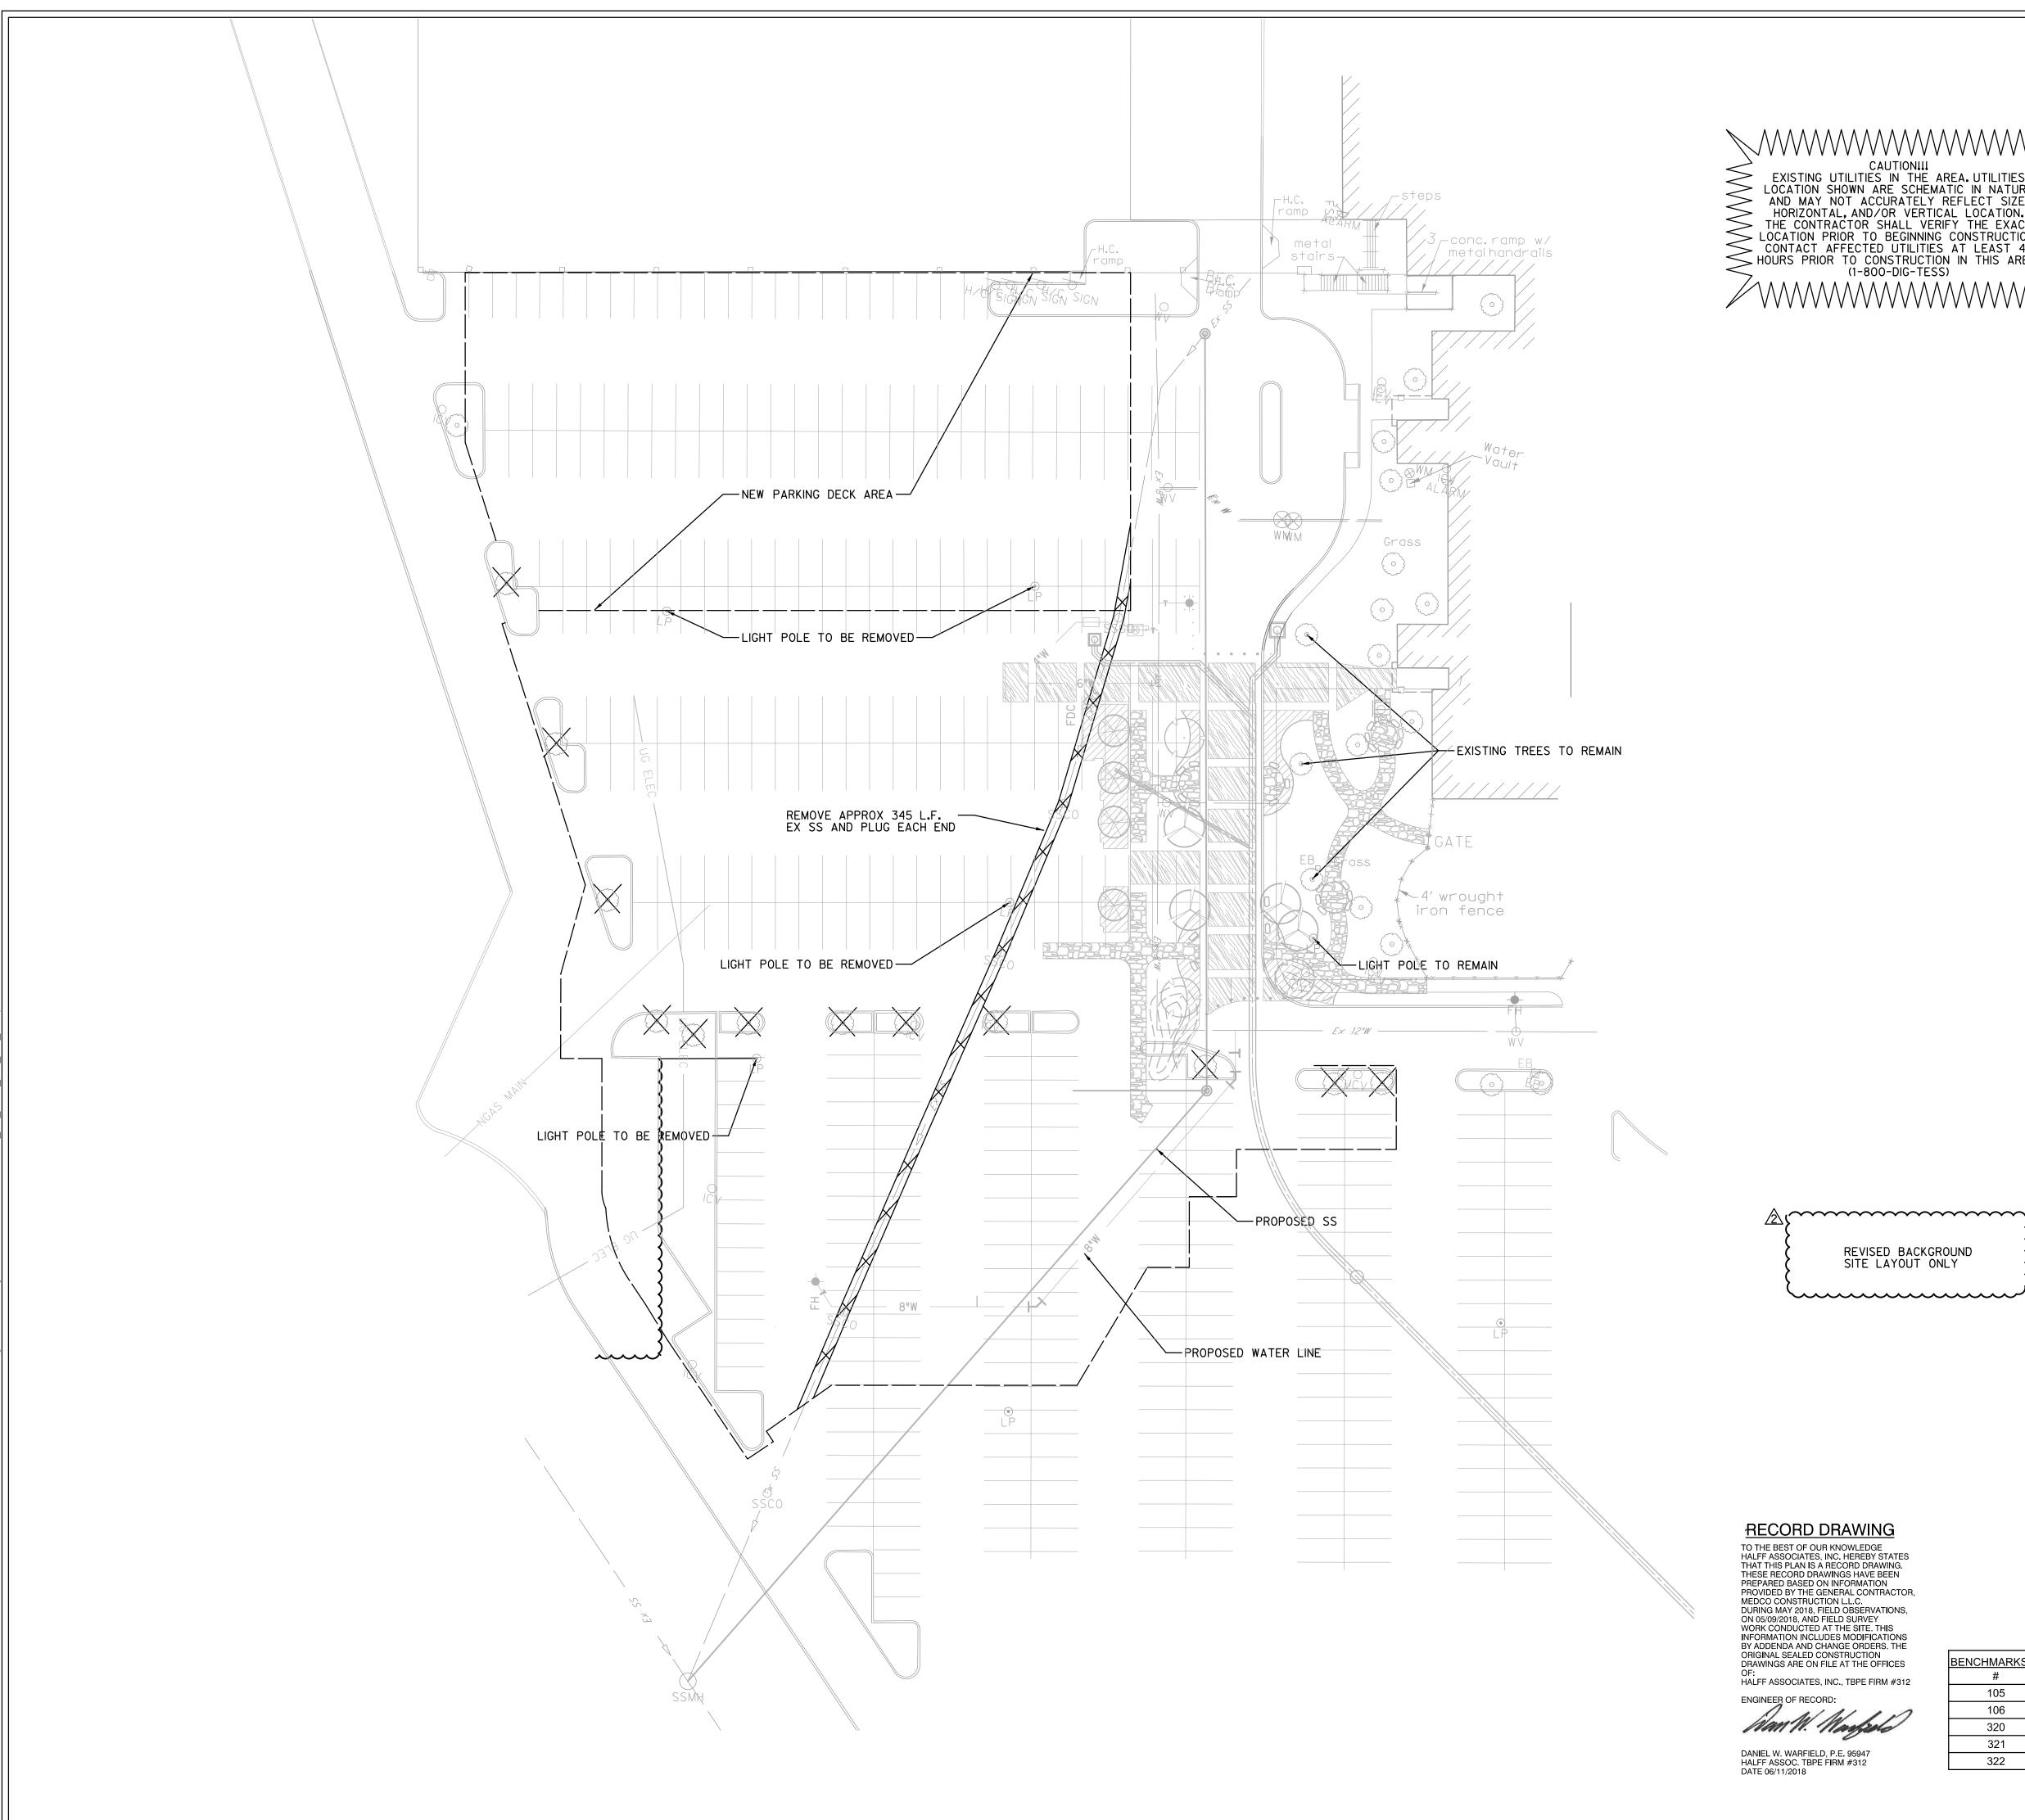

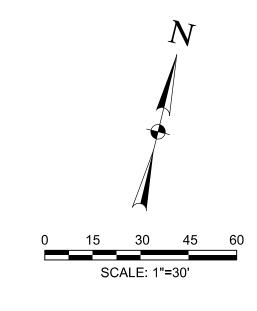

I ECEND.

LEGEND:	
— Ex ·F/O — —	EXISTING FIBER OPTIC
— Ex · TEL — —	EXISTING TELEPHONE LINE
— — Ex Gas — —	EXISTING GAS LINE
— Ex: SS — — —	EXISTING SANITARY SEWER
Ex · OHE	EXISTING OVERHEAD ELECTRIC
—— Ex · UGE —— —	EXISTING UNDERGROUND ELECTRIC
———	EXISTING WATER LINE
	STORM SEWER
455	MAJOR CONTOUR LINE

 \bigcirc W \lor

TREE TO BE REMOVED PAVEMENT REMOVAL/ CONSTRUCTION LIMITS

INLET PROTECTION

MINOR CONTOUR LINE

PROPERTY LINE EASEMENT LINE

ASPHALT

POWER POLE

WATER VALVE

FIRE HYDRANT WATER METER

EXISTING MAJOR CONTOUR LINE EXISTING MINOR CONTOUR LINE

SANITARY SEWER MANHOLE

NOTES:

1. SEE PAVING, GRADING, AND UTILITY PLANS FOR FURTHER DETAILS ON DEMOLITION LIMITS

REVISED BACKGROUND SITE LAYOUT ONLY

> SEE SHEET C0.01 FOR GENERAL NOTES

NCHMARKS				
#	NORTHING	EASTING	ELEVATION	DESCRIPTION
105	7015991.2980	2592962.1928	550.06	SXTP
106	7015431.9569	2593196.4381	543.24	SXTP
320	7015521.4980	2592947.0430	546.21	SXTP
321	7015870.0270	2593095.7245	548.29	SXTP
322	7015977.2058	2593078.3578	549.54	SXTP
	•			

LAKE POINTE CHURCH NEW CHAPEL / EDUCATION BUILDING

Description TREES TO REMAIN

3 2 2 8

DANIEL W. WARFIELD

95947


10-3-2017


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responsible engineer is an offense under the Texas Engineering Practice Act. The record copy of this drawing is on file at the offices of Halff Associates, Inc., 3803 Parkwood Blvd., Frisco, Texas 75034. TBPE FIRM #F-312.

Project No.: 31697 04/25/2017 Issued: TRS Drawn By: Checked By: DWW Scale: AS NOTED Sheet Title DEMOLITION PLAN

C2.01 Sheet Number



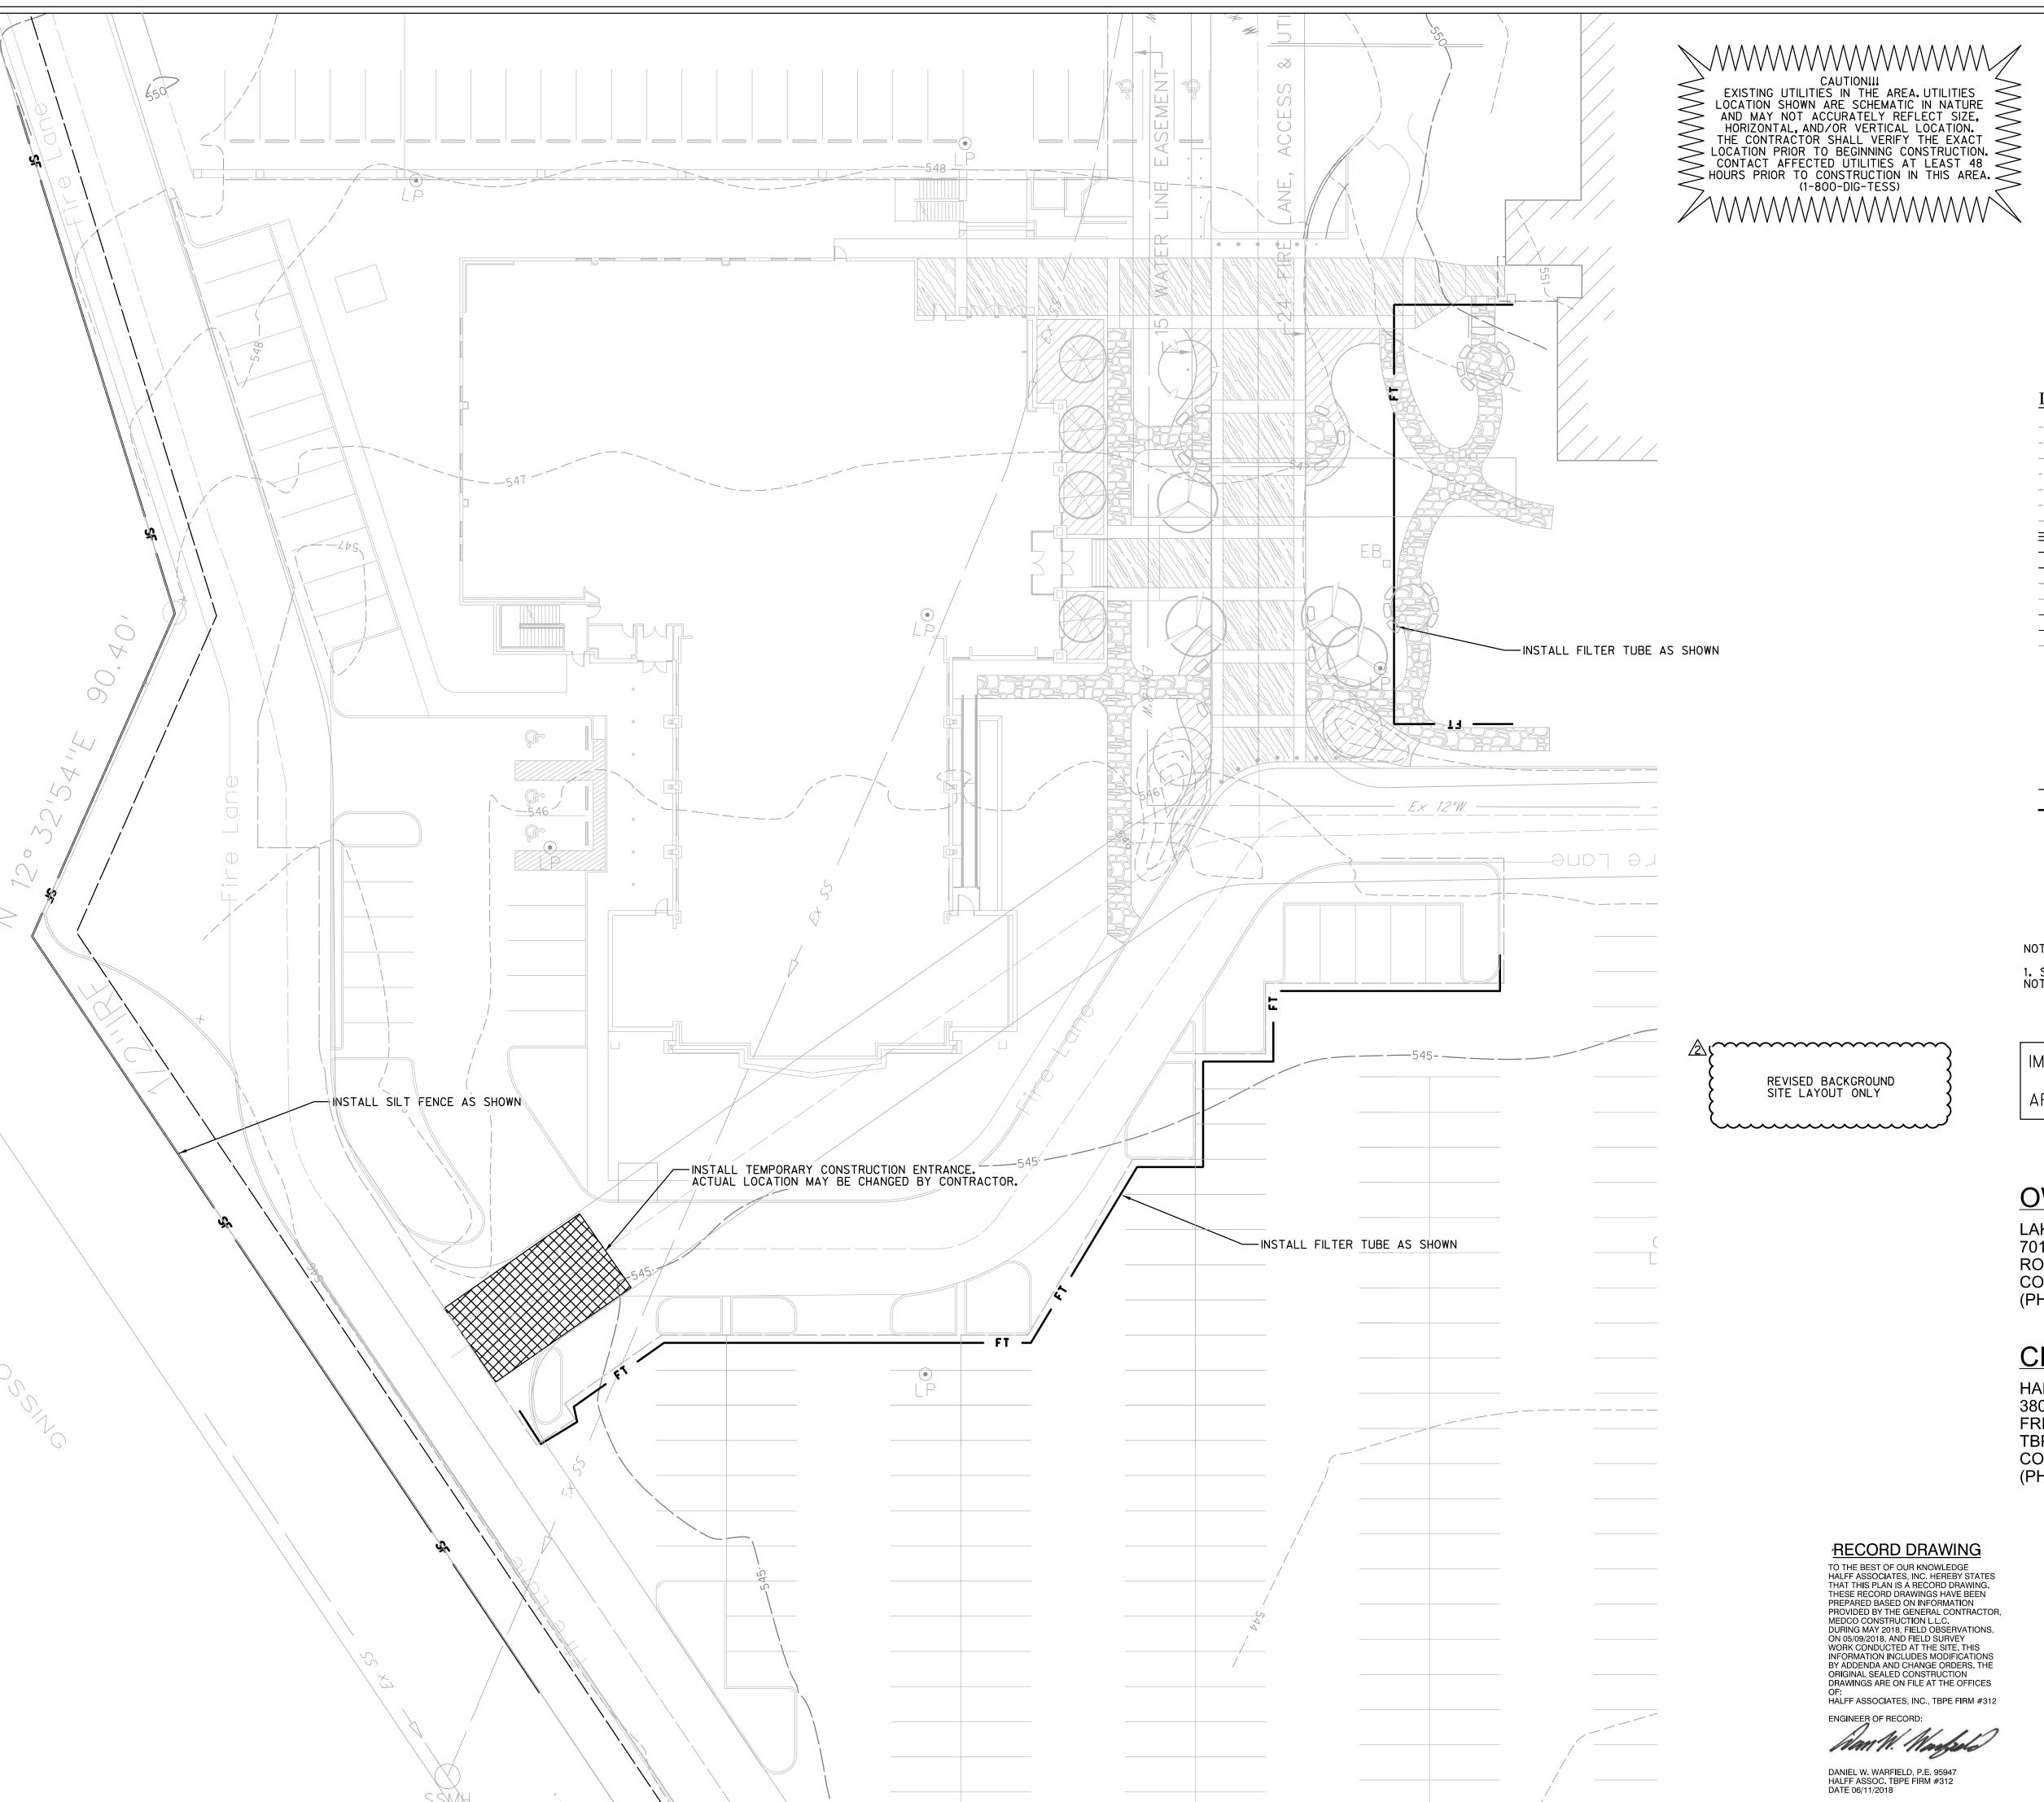

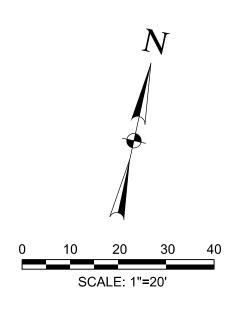LEGEND:

EXISTING FIBER OPTIC EXISTING TELEPHONE LINE EXISTING GAS LINE EXISTING SANITARY SEWER EXISTING OVERHEAD ELECTRIC EXISTING UNDERGROUND ELECTRIC EXISTING WATER LINE STORM SEWER MAJOR CONTOUR LINE MINOR CONTOUR LINE EXISTING MAJOR CONTOUR LINE EXISTING MINOR CONTOUR LINE PROPERTY LINE EASEMENT LINE ASPHALT

POWER POLE SANITARY SEWER MANHOLE WATER VALVE FIRE HYDRANT

WATER METER INLET PROTECTION SILT FENCE FILTER TUBE

1. SEE SHEET C3.02 FOR EROSION CONTROL NOTES AND DETAILS.

IMPROVED SITE AREA: 2.5 ACRES

AREA OF DISTURBANCE: 2.5 ACRES

OWNER / DEVELOPER

LAKE POINTE CHURCH- ROCKWALL CAMPUS 701 INTERSTATE 30 ROCKWALL, TX 75087 CONTACT: JOHN WARDELL (PH) 469-698-2244

CIVIL ENGINEER

HALFF ASSOCIATES, INC. 3803 PARKWOOD BLVD., SUITE 800 FRISCO, TX 75034 TBPE FIRM #F-312 CONTACT: DAN WARFIELD, P.E. (PH) 214-618-4570

SEE SHEET C0.01 FOR GENERAL NOTES

CHURCH ATION BUILDING OINTE L/EDUCA 701

| 3 | 2 | R | DANIEL W. WARFIELD

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95947

Project No.: 31697 04/25/2017 Issued: TRS Drawn By: Checked By: DWW

Scale: AS NOTED Sheet Title **EROSION CONTROL**

C3.01

PLAN

Sheet Number

2. It is the intent of the information provided on these documents to be used as a generalguideline for the Contractor. The SWP3 to be prepared shallmeet the current requirements set forth in the TCEQ's TPDES generalpermit for storm water discharges from construction sites as well as any local requirements.

3. The Contractor shall be responsible for maintaining erosion controlduring construction and for obtaining any required construction related drainage permits, or making any construction related notifications. An inspection report that summarizes inspection activities and implementation of the SWP3 shall be performed as required by the PERMIT and retained by the Contractor and made a part of the construction documents. The Contractor shall provide copies of all SWP3 documents including, but not limited to, inspection records, original plans, and modified plans to the Owner at contract close-out. During construction the contractor shall provide copies of the inspection reports to the Owner on a monthly basis.

4. Temporary storm drainage and/or erosion controlmaterial shall be suitable for this application and shall be installed with the proper techniques by the Contractor as required by NCTCOG Standard Specifications for Public Works Construction. Temporary storm drainage and/or erosion controlmaterialshall be removed by the Contractor, in addition to any excavations backfilled by the Contractor, in accordance with NCTCOG Standard Specifications for Public Works Construction when temporary erosion controldevices are no longer needed as specified in the PERMIT. Maintenance of the permanent erosion controlmeasures at the site willbe assumed by the Owner at contract close out and acceptance of the work.

5. The Contractor shall maintain the SWP3 in accordance with the TCEQ Permit and make the SWP3 available, upon request, to the TCEQ and/or Owner.

6. The Contractor must amend the SWP3 whenever there is a change in design, construction, operation, or maintenance of the SWP3, or when the existing SWP3 proves ineffective. Modifications shall not compromise the intent of the requirements of the PERMIT. Modifications including design and all additional materials and work shall be accomplished by the Contractor at no additional expense to the Owner.

7. The Contractor shallinspect his stabilization and erosion control measures at a minimum of once every 14 days, and within 24 hours after any storm event greater than 0.5 inches, or once every 7 days. The Contractor shall repair inadequacies revealed by the inspection before the next storm event and he shall modify his SWP3 within 7 days of the inspection.

8. The Contractor shall adopt and implement appropriate construction site management practices to prevent the discharge of oils, grease, paints, gasoline, and other pollutants to storm water. Appropriate practices shall include, but not be limited to: designating areas for equipment maintenance and repair; collecting wastes periodically; maintaining conveniently located waste receptacles, and designating and controlling equipment washdown.

9. Borrow areas, if excavated, shall be protected and stabilized by the Contractor in a manner acceptable to the Owner and in accordance with PERMIT requirements.


10. All non-paved areas shall be seeded and mulched with erosion protection grass by the Contractor immediately upon completion of final grading. This includes all ditches and embankments. The Contractor shall maintain final grading, and keep seeded areas watered until fully established and accepted by Owner.

11. The Contractor shall construct a silt fence at locations suggested on plans as appropriate or as modified in his SWP3 to fit site conditions at the time of placement, and all borrow and stock pile areas. The silt fence shall be constructed as detailed on this plan. The Contractor shallremove accumulated silt when it reaches a depth of 1/3 the height of the silt fence. The Contractor shall dispose of the removed silt in a location approved by the Owner and in such a manner as to not contribute to erosion and sedimentation. The Contractor shall remove the silt fence when the site is completely stabilized in accordance with the PERMIT.

12. The Contractor shall designate material and equipment storage areas mutually agreed to by the Owner. The storage areas shall be graded for positive drainage, and the surface stabilized with a minimum of 2 inches of compacted flex base on 6 inches of scarified and recompacted subgrade by the Contractor. A silt fence shall be installed by the Contractor around the storage areas to prevent eroded material from leaving the site.

13. All inlets (onsite and offsite) receiving drainage water from disturbed areas shallbe protected by the Contractor as per details shown or other Owner approved methods to prevent eroded material from being transported into inlets. The inlet protection shall be constructed as shown on these plans.

14. The notes and details contained herin do not relieve the Contractor and Owner of meeting and implementing the requirements of the PERMIT.

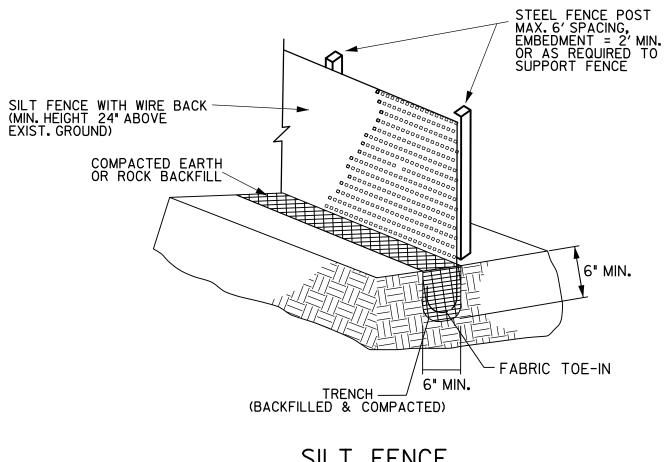

N.T.S.

1, STEEL POSTS WHICH SUPPORT THE SILT FENCE SHALL BE INSTALLED WITH

PERPENDICULAR TO THE LINE OF FLOW. WHERE FENCE CANNOT BE

A SLIGHT ANGLE TOWARD THE ANTICIPATED RUNOFF SOURCE, POST MUST

TRENCHER, SO THAT THE DOWNSLOPE FACE OF THE TRENCH IS FLAT AND

TRENCHED IN (e.g. PAVEMENT), WEIGHT FABRIC FLAP WITH WASHED GRAVEL

3. THE TRENCH MUST BE A MINIMUM OF 6 INCHES DEEP AND 6 INCHES WIDE TO

4. SILT FENCE SHOULD BE SECURELY FASTENED TO EACH STEEL SUPPORT POST

THERE SHALL BE A 6" DOUBLE OVERLAP, SECURELY FASTENED WHERE

5. INSPECTION SHALL BE MADE WEEKLY OR AFTER EACH RAINFALL. REPAIR OR

6. SILT FENCE SHALL BE REMOVED WHEN THE SITE IS COMPLETELY STABILIZED

THE SILT SHALL BE DISPOSED OF IN AN APPROVED SITE AND IN SUCH A

PROFILE

TRANSITION TO ROADWAY

PLAN VIEW

TEMPORARY

N.T.S.

CONSTRUCTION ENTRANCE DETAIL

RADIUS

= 5' MIN.

SO AS NOT TO BLOCK OR IMPEDE STORM FLOW OR DRAINAGE.

MANNER AS TO NOT CONTRIBUTE TO ADDITIONAL SILTATION.

OR TO WOVEN WIRE, WHICH IS IN TURN ATTACHED TO THE STEEL FENCE POST.

7. ACCUMULATED SILT SHALL BE REMOVED WHEN IT REACHES A DEPTH OF 6 INCHES.

CROWN TO MINIMIZE RUNOFF

GETTING INTO THE STREET.

FILTER FABRIC

ROADWAY

 $X \times X \times X \times X \times X$

R.O.W.

L=30 FT FOR

L=50 FT FOR

SITE DEPTH <

150 FT FROM

SITE DEPTH >

150 FT FROM

ENTRANCE

W=WIDTH AT POINT

OF EGRESS

OR INGRESS

TO SITE

ENTRANCE

ALLOW FOR THE SILT FENCE FABRIC TO BE LAID IN THE GROUND AND

2. THE TOE OF THE SILT FENCE SHALL BE TRENCHED IN WITH A SPADE OR MECHANICAL

SILT FENCE GENERAL NOTES:

ENDS OF FABRIC MEET.

BE EMBEDDED A MINIMUM OF TWO FEET.

BACKFILLED WITH COMPACTED MATERIAL.

GRADE TO PREVENT RUNOFF

- EXISTING GRADE

GRADE TO DRAIN AWAY FROM

STABILIZATION AND PAVED ENTRANCE

FROM LEAVING SITE

~~~~~

4"-6" ROCK

CONCRETE


ALLOWED

NO CRUSHED

ON UPHILL SIDE TO PREVENT FLOW UNDER FENCE.

REPLACEMENT SHALL BE MADE PROMPTLY AS NEEDED.

ISOMETRIC VIEW N.T.S. SILT FENCE

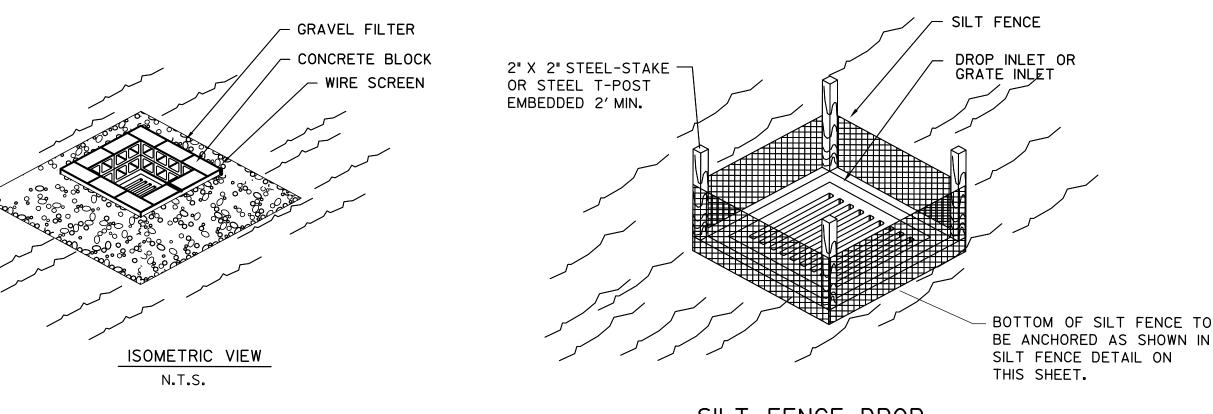

GRAVEL FILTER (APPROXIMATELY

100% PASSING 1" SIEVE 95% RETAINED ON 1/2" SIEVE.

3/4" DIAMETER) PLACED TO

-AREA INLET WITH GRATE

TOP OF CONCRETE BLOCKS

SILT FENCE DROP INLET PROTECTION N.T.S.

CONCENTRATED DITCH FLOW COMING FROM ONE OR MORE SIDES TO


THE DROP INLET MAY REQUIRE A STONE CHECK STRUCTURE TO BE CONSTRUCTED ON ONE SIDE OF THE DROP INLET.


CONCRETE BLOCKS STACKED 2 HIGH - WIRE SCREEN TO PREVENT MOVEMENT OF GRAVEL OVERFLOW


SECTION AA


CONCRETE BLOCK FILTER NOTE: GRAVEL FILTERS MAY BE USED ON PAVEMENT OR BARE GROUND

# GRATE INLET FILTER PROTECTION

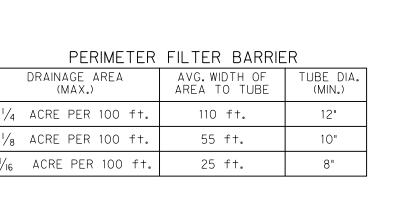

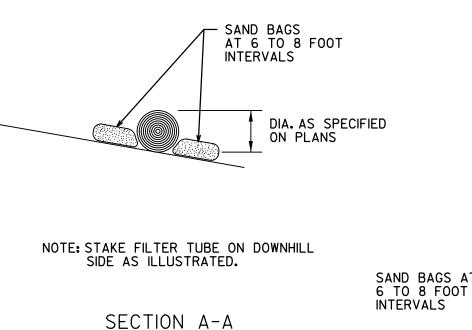

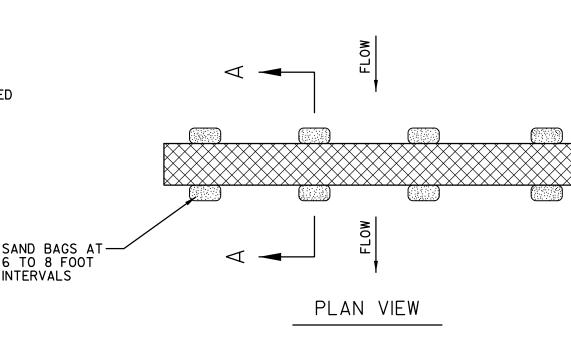

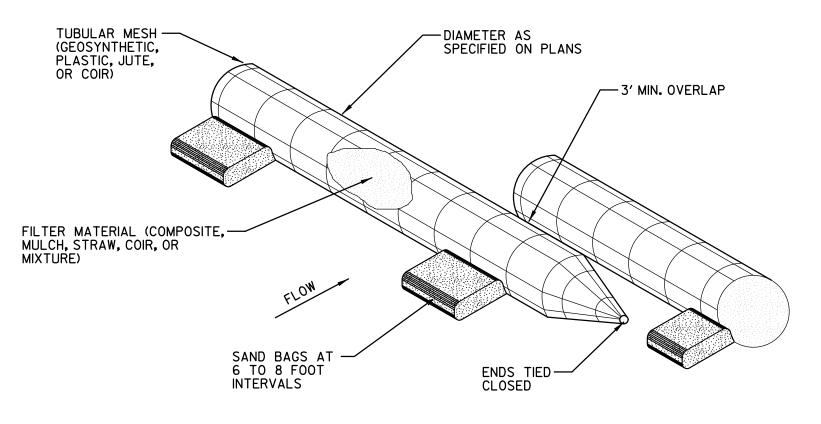

ORGANIC FILTER TUBE DETAIL

THIS IS NOT A STORM WATER POLLUTION PREVENTION PLAN. THE CONTRACTOR MUST PREPARE ALL RELEVANT DOCUMENTS INCLUDING HIS OPERATION SPECIFIC INFORMATION PER THE TCEQ TPDES PERMIT NO. TXR150000, INCLUDING ALL DOCUMENTATION & CERTIFICATIONS AS REQUIRED BY THE PERMIT

RECORD DRAWING

IALFF ASSOCIATES, INC. HEREBY STATES

THAT THIS PLAN IS A RECORD DRAWING

THESE RECORD DRAWINGS HAVE BEEN

MEDCO CONSTRUCTION L.L.C. DURING MAY 2018, FIELD OBSERVATIONS,

INFORMATION INCLUDES MODIFICATIONS

DRAWINGS ARE ON FILE AT THE OFFICES

HALFF ASSOCIATES, INC., TBPE FIRM #312

BY ADDENDA AND CHANGE ORDERS. THI

PREPARED BASED ON INFORMATION PROVIDED BY THE GENERAL CONTRACTOR,

ON 05/09/2018, AND FIELD SURVEY

ORIGINAL SEALED CONSTRUCTION

DANIEL W. WARFIELD, P.E. 95947

HALFF ASSOC. TBPE FIRM #312

ENGINEER OF RECORD

DATE 06/11/2018

WORK CONDUCTED AT THE SITE. THIS

TO THE BEST OF OUR KNOWLEDGE

DANIEL W. WARFIELD 95947 10-3-2017

BUILDIN

NOL

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5087

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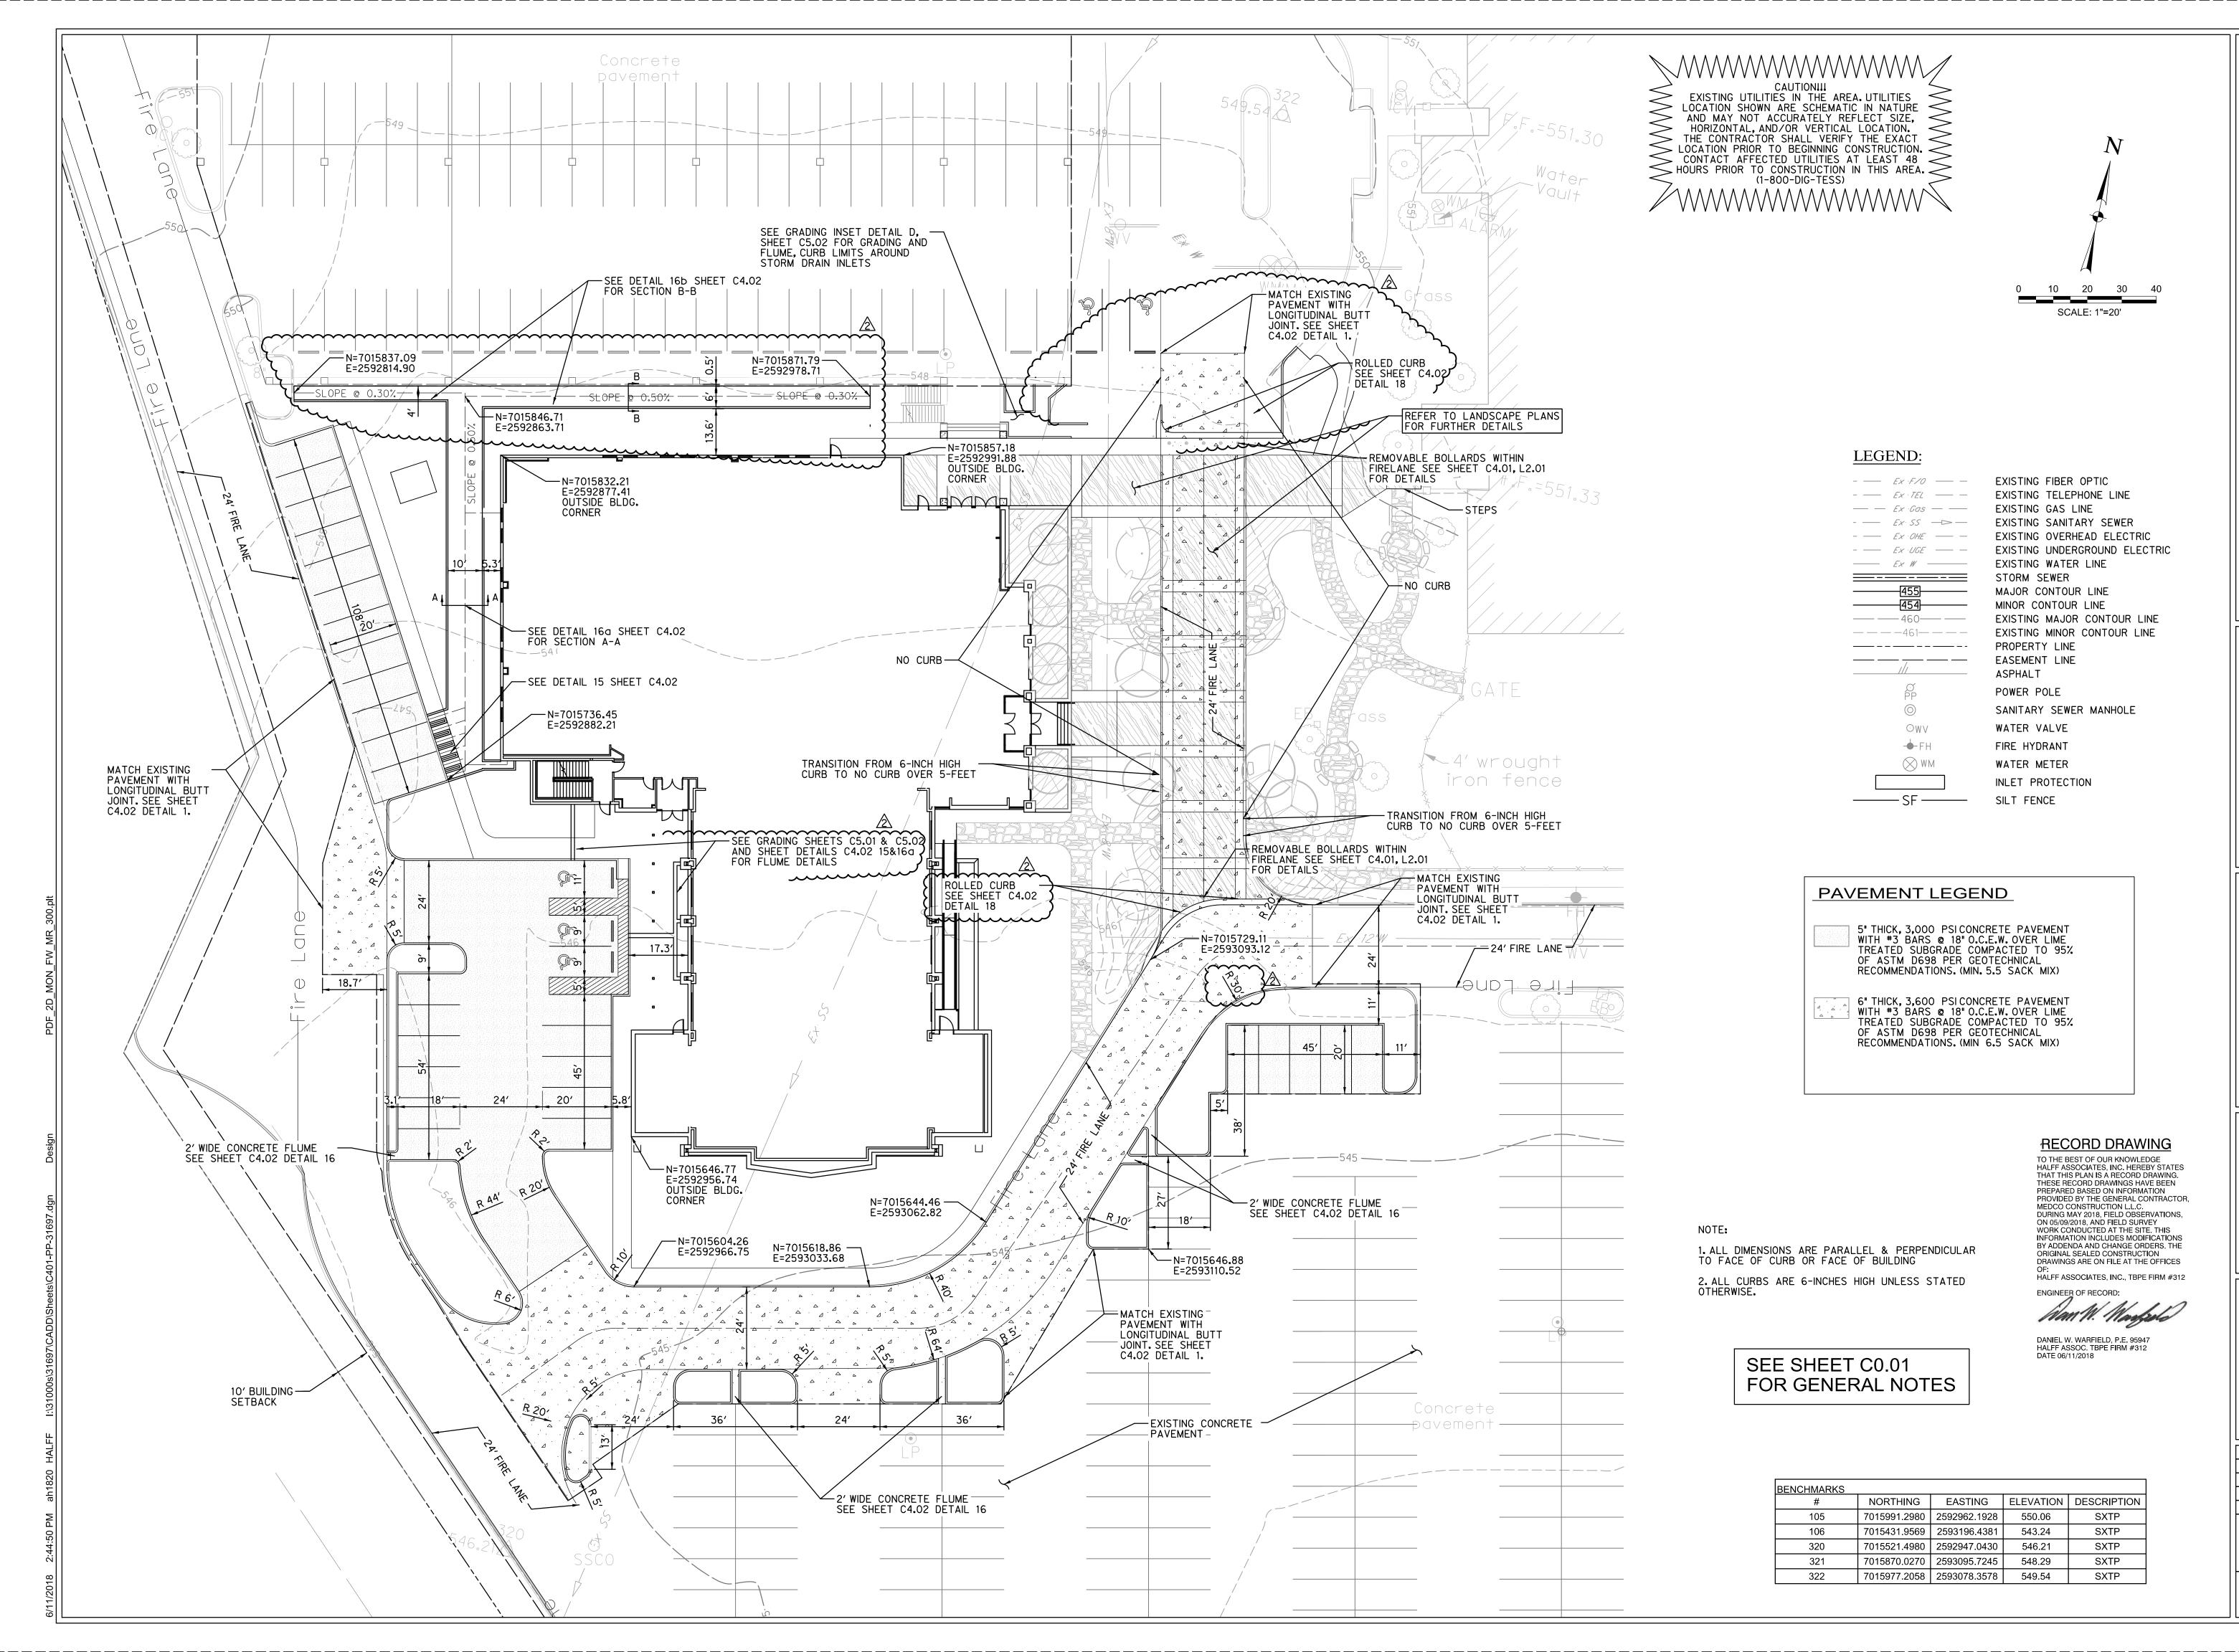
Project No.: 31697 Issued: TRS Drawn By: Checked By: DWW

Scale:

Sheet Title **EROSION CONTROL** NOTES AND DETAILS

AS NOTED

C3.02 Sheet Number



LAKE POINTE CHURCH
EW CHAPEL / EDUCATION BUILDIN
701 linterstate 30 Rockwall, TX 75087

3803 PARKWOOD BLVD, SUITE 800 FRISCO, TEXAS 75034-8640 FAX (214) 618-4570 FAX (214) 618-4574 FAX (214) 618-4574

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 Project No.:
 31697

 Issued:
 08/01/2017

 Drawn By:
 TRS


 Checked By:
 DWW


 Scale:
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 Sheet Title
 PAVING

Sheet Number

C4.01



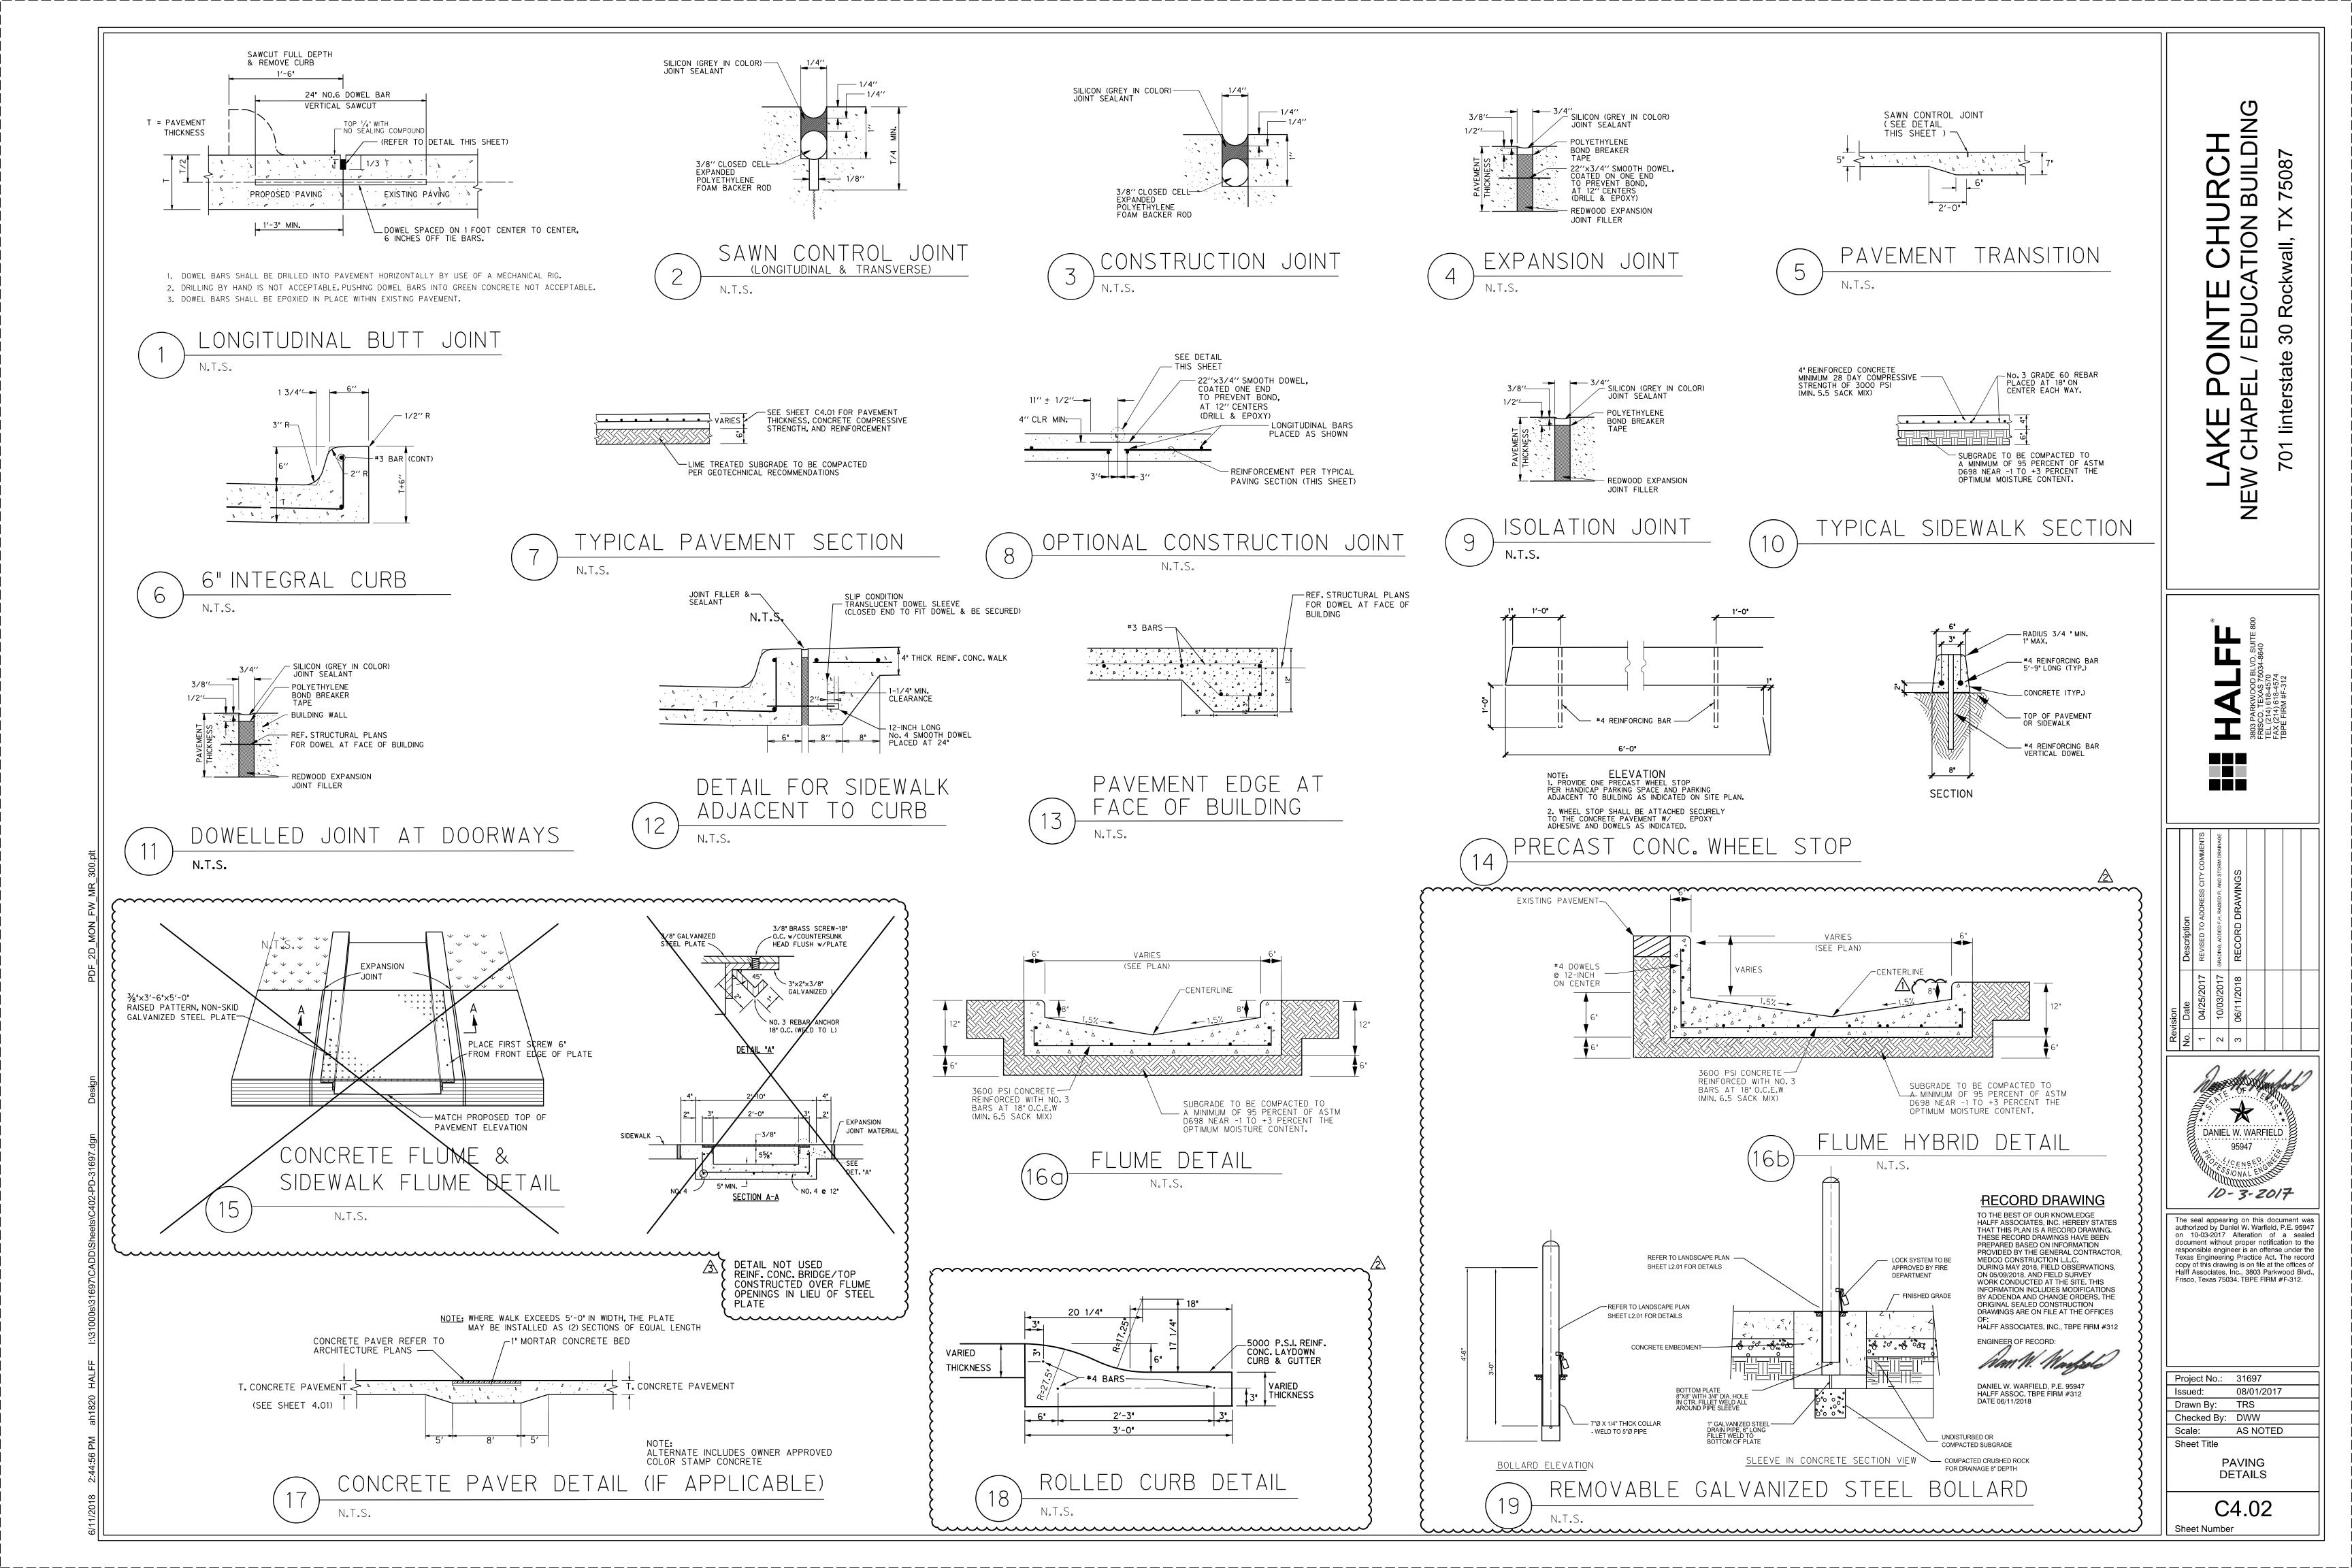

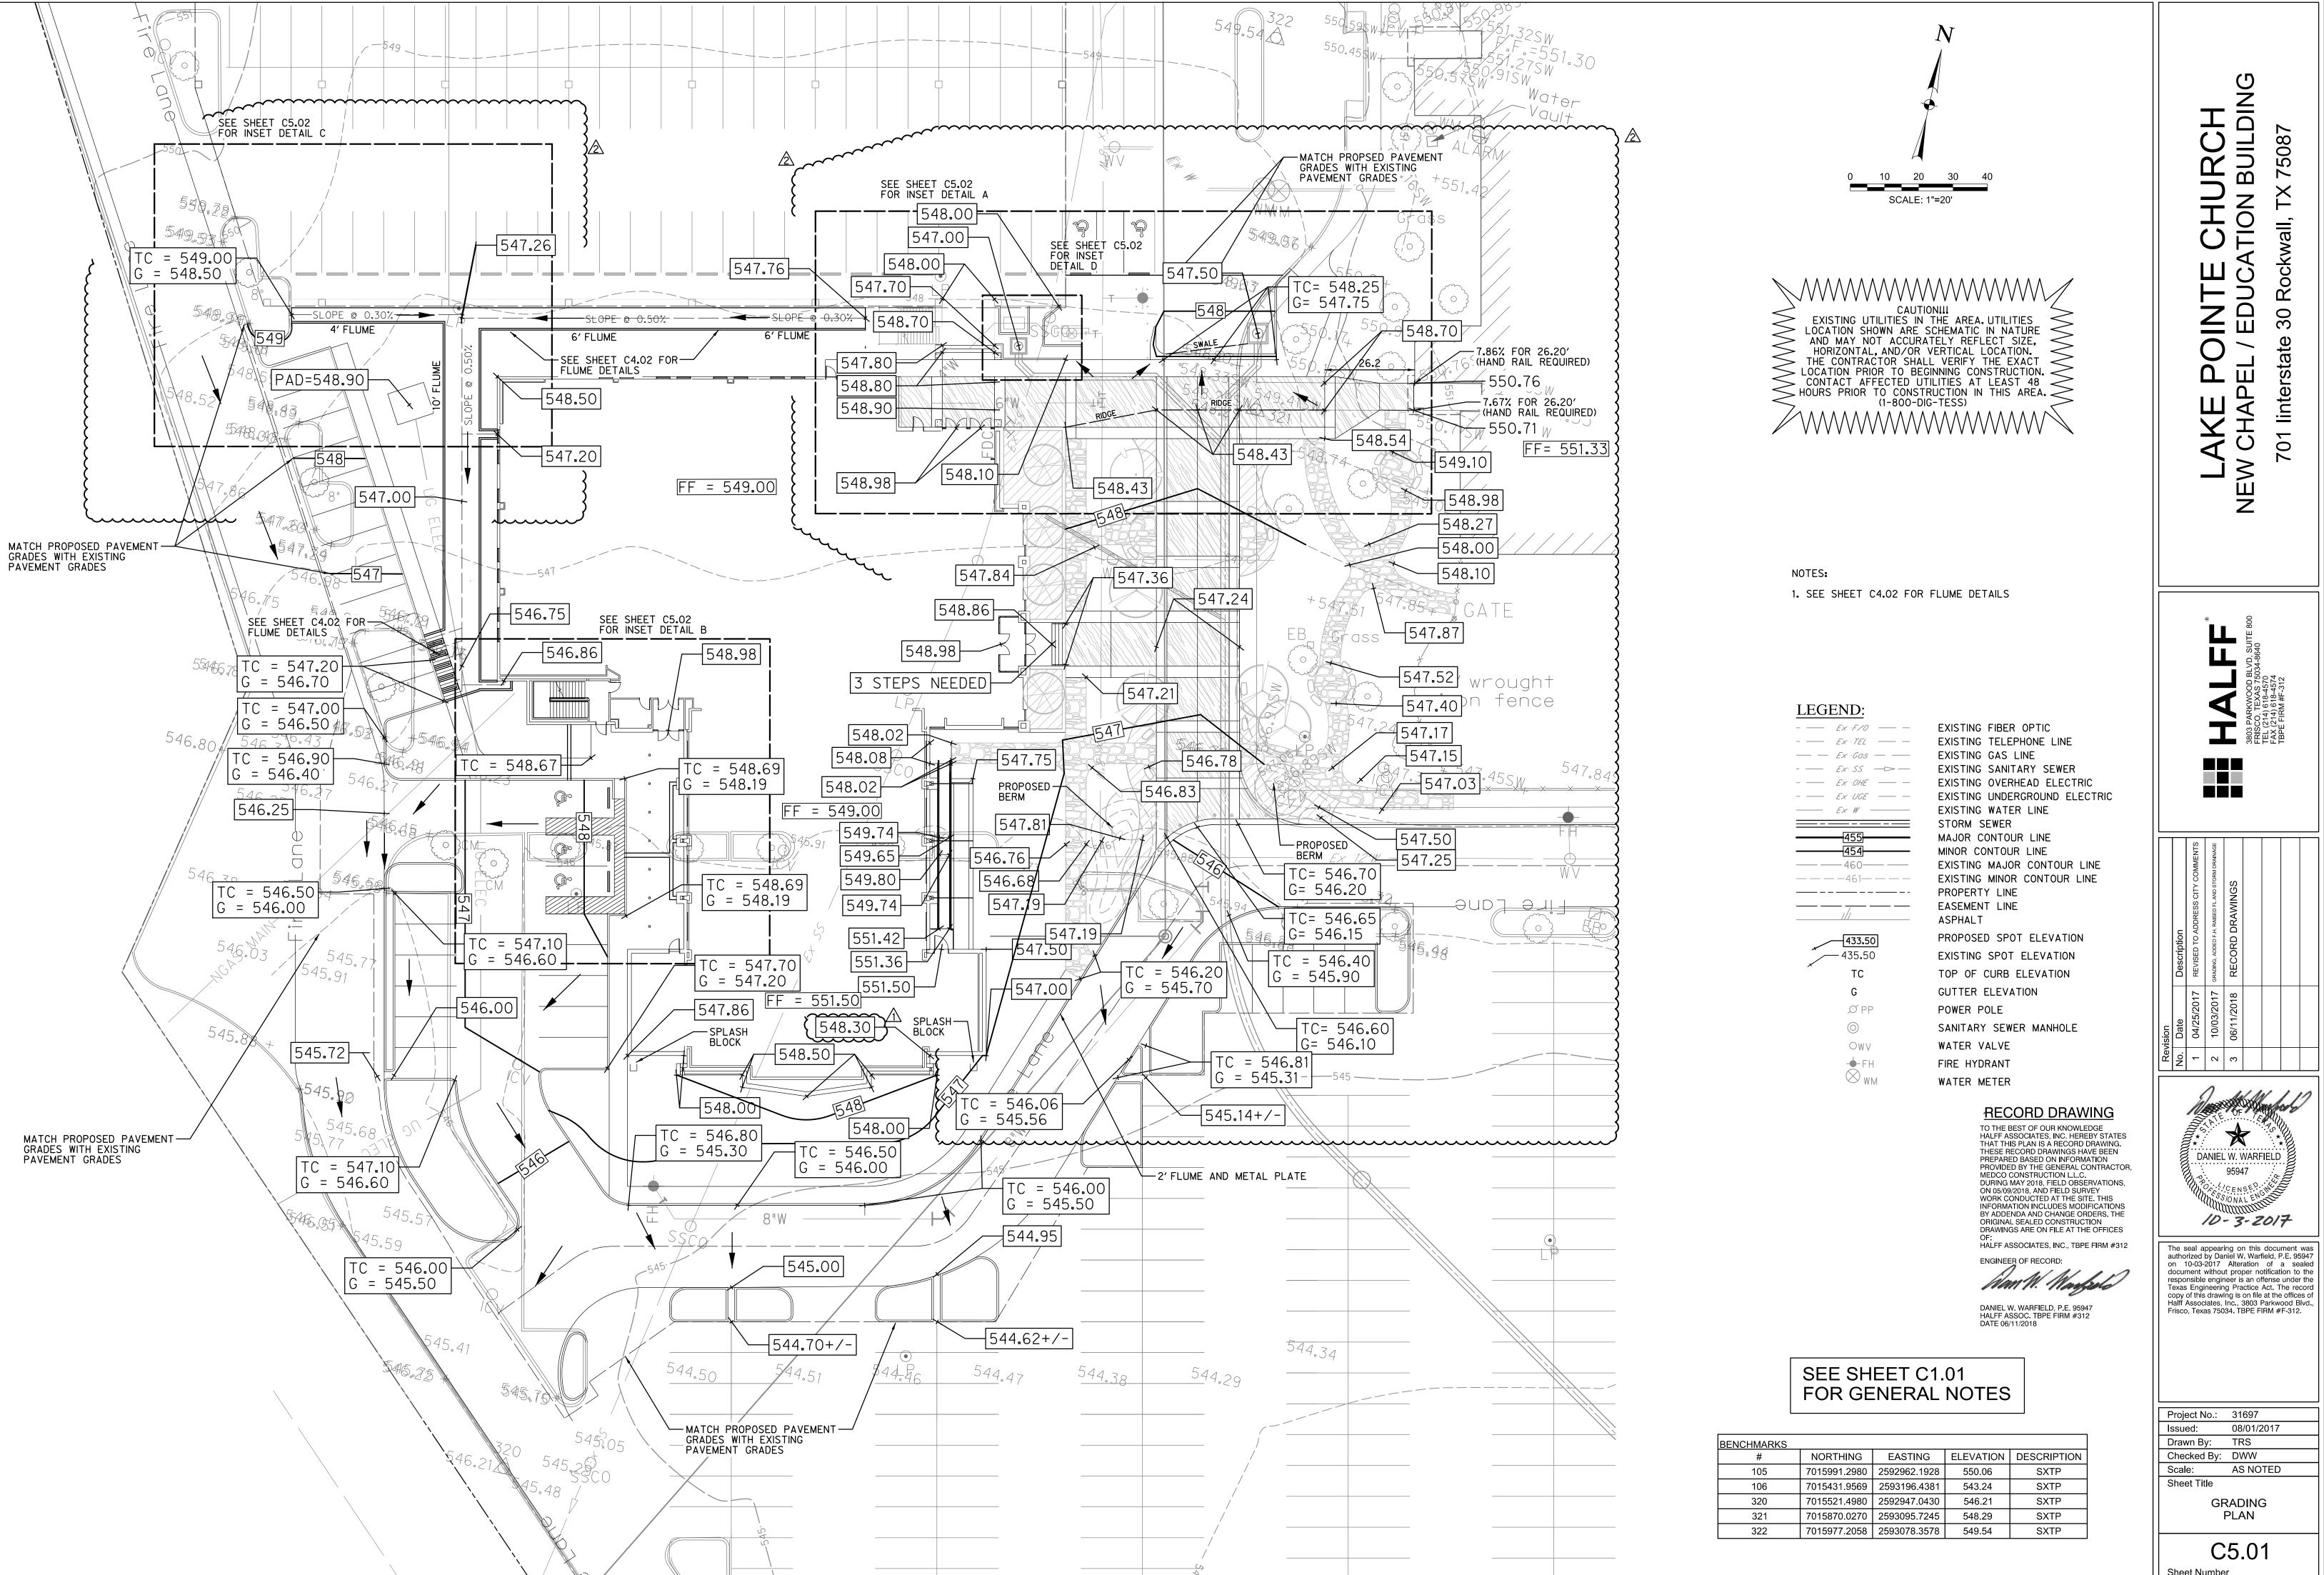BUILDIN 75087 NOL EDUC, 01

Project No.: 31697 08/01/2017 TRS Drawn By: Checked By: DWW AS NOTED Sheet Title GRADING PLAN


DANIEL W. WARFIELD


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2. CENSE!

10-3-2017

C5.01 Sheet Number



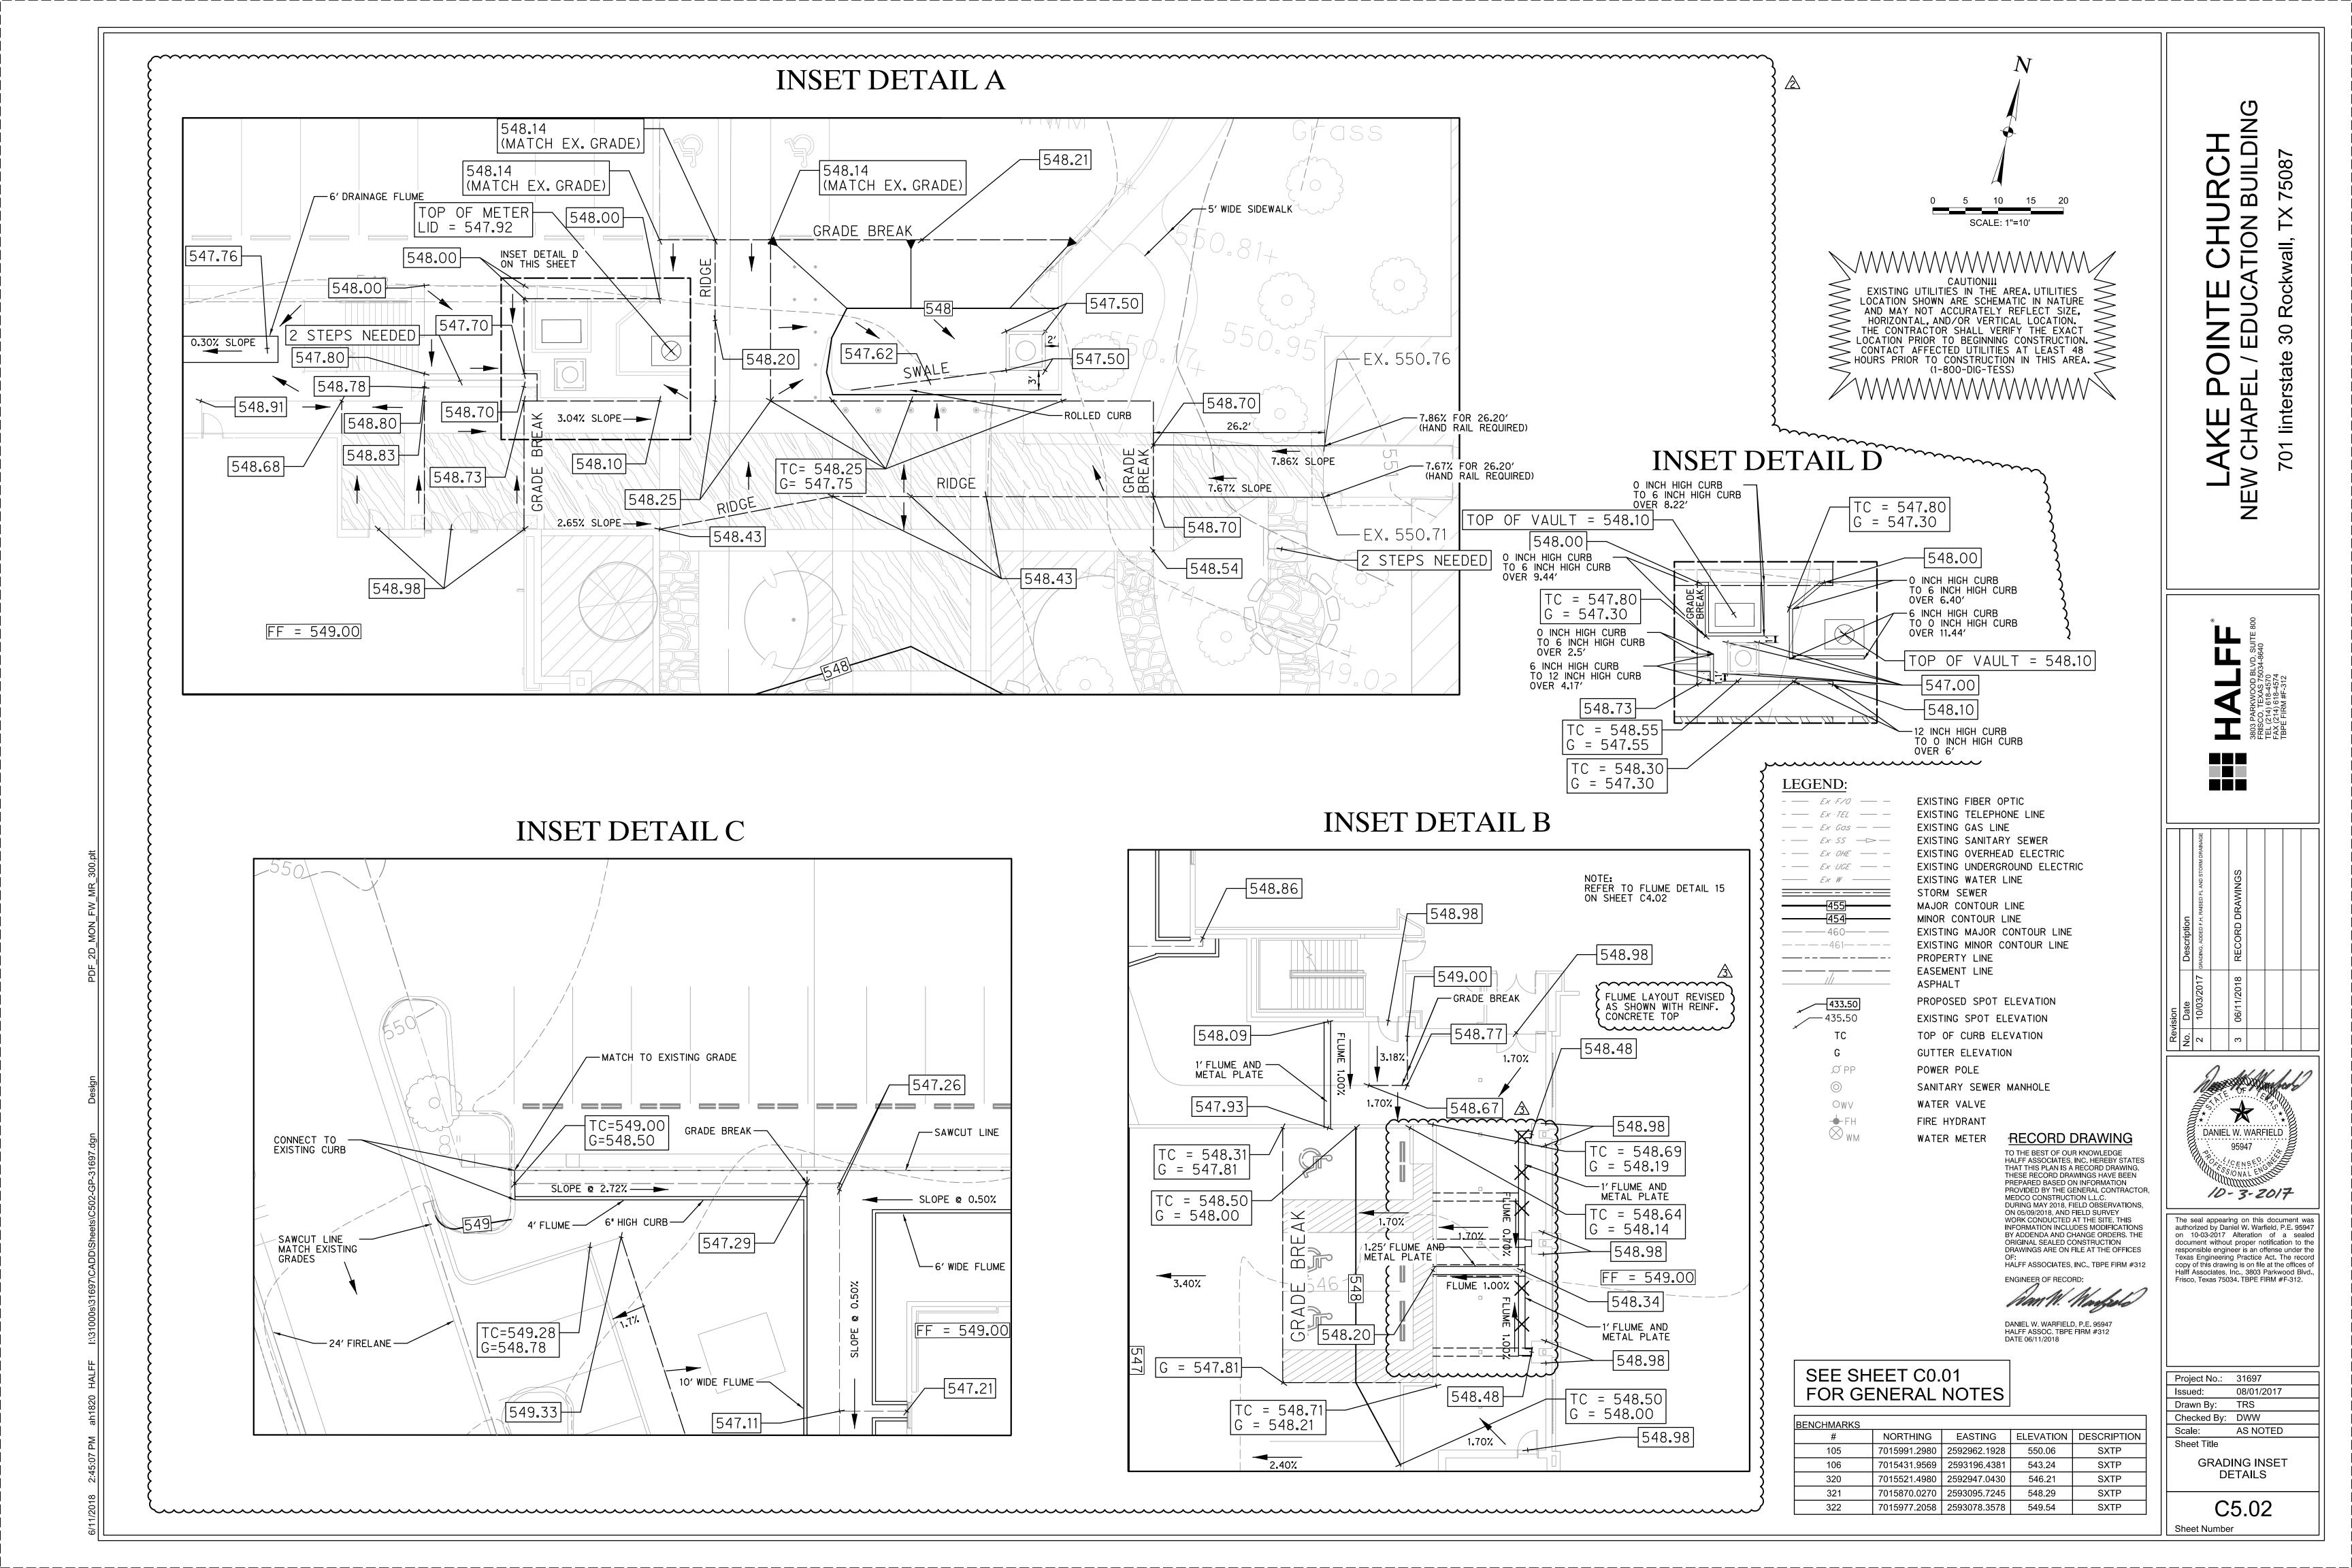

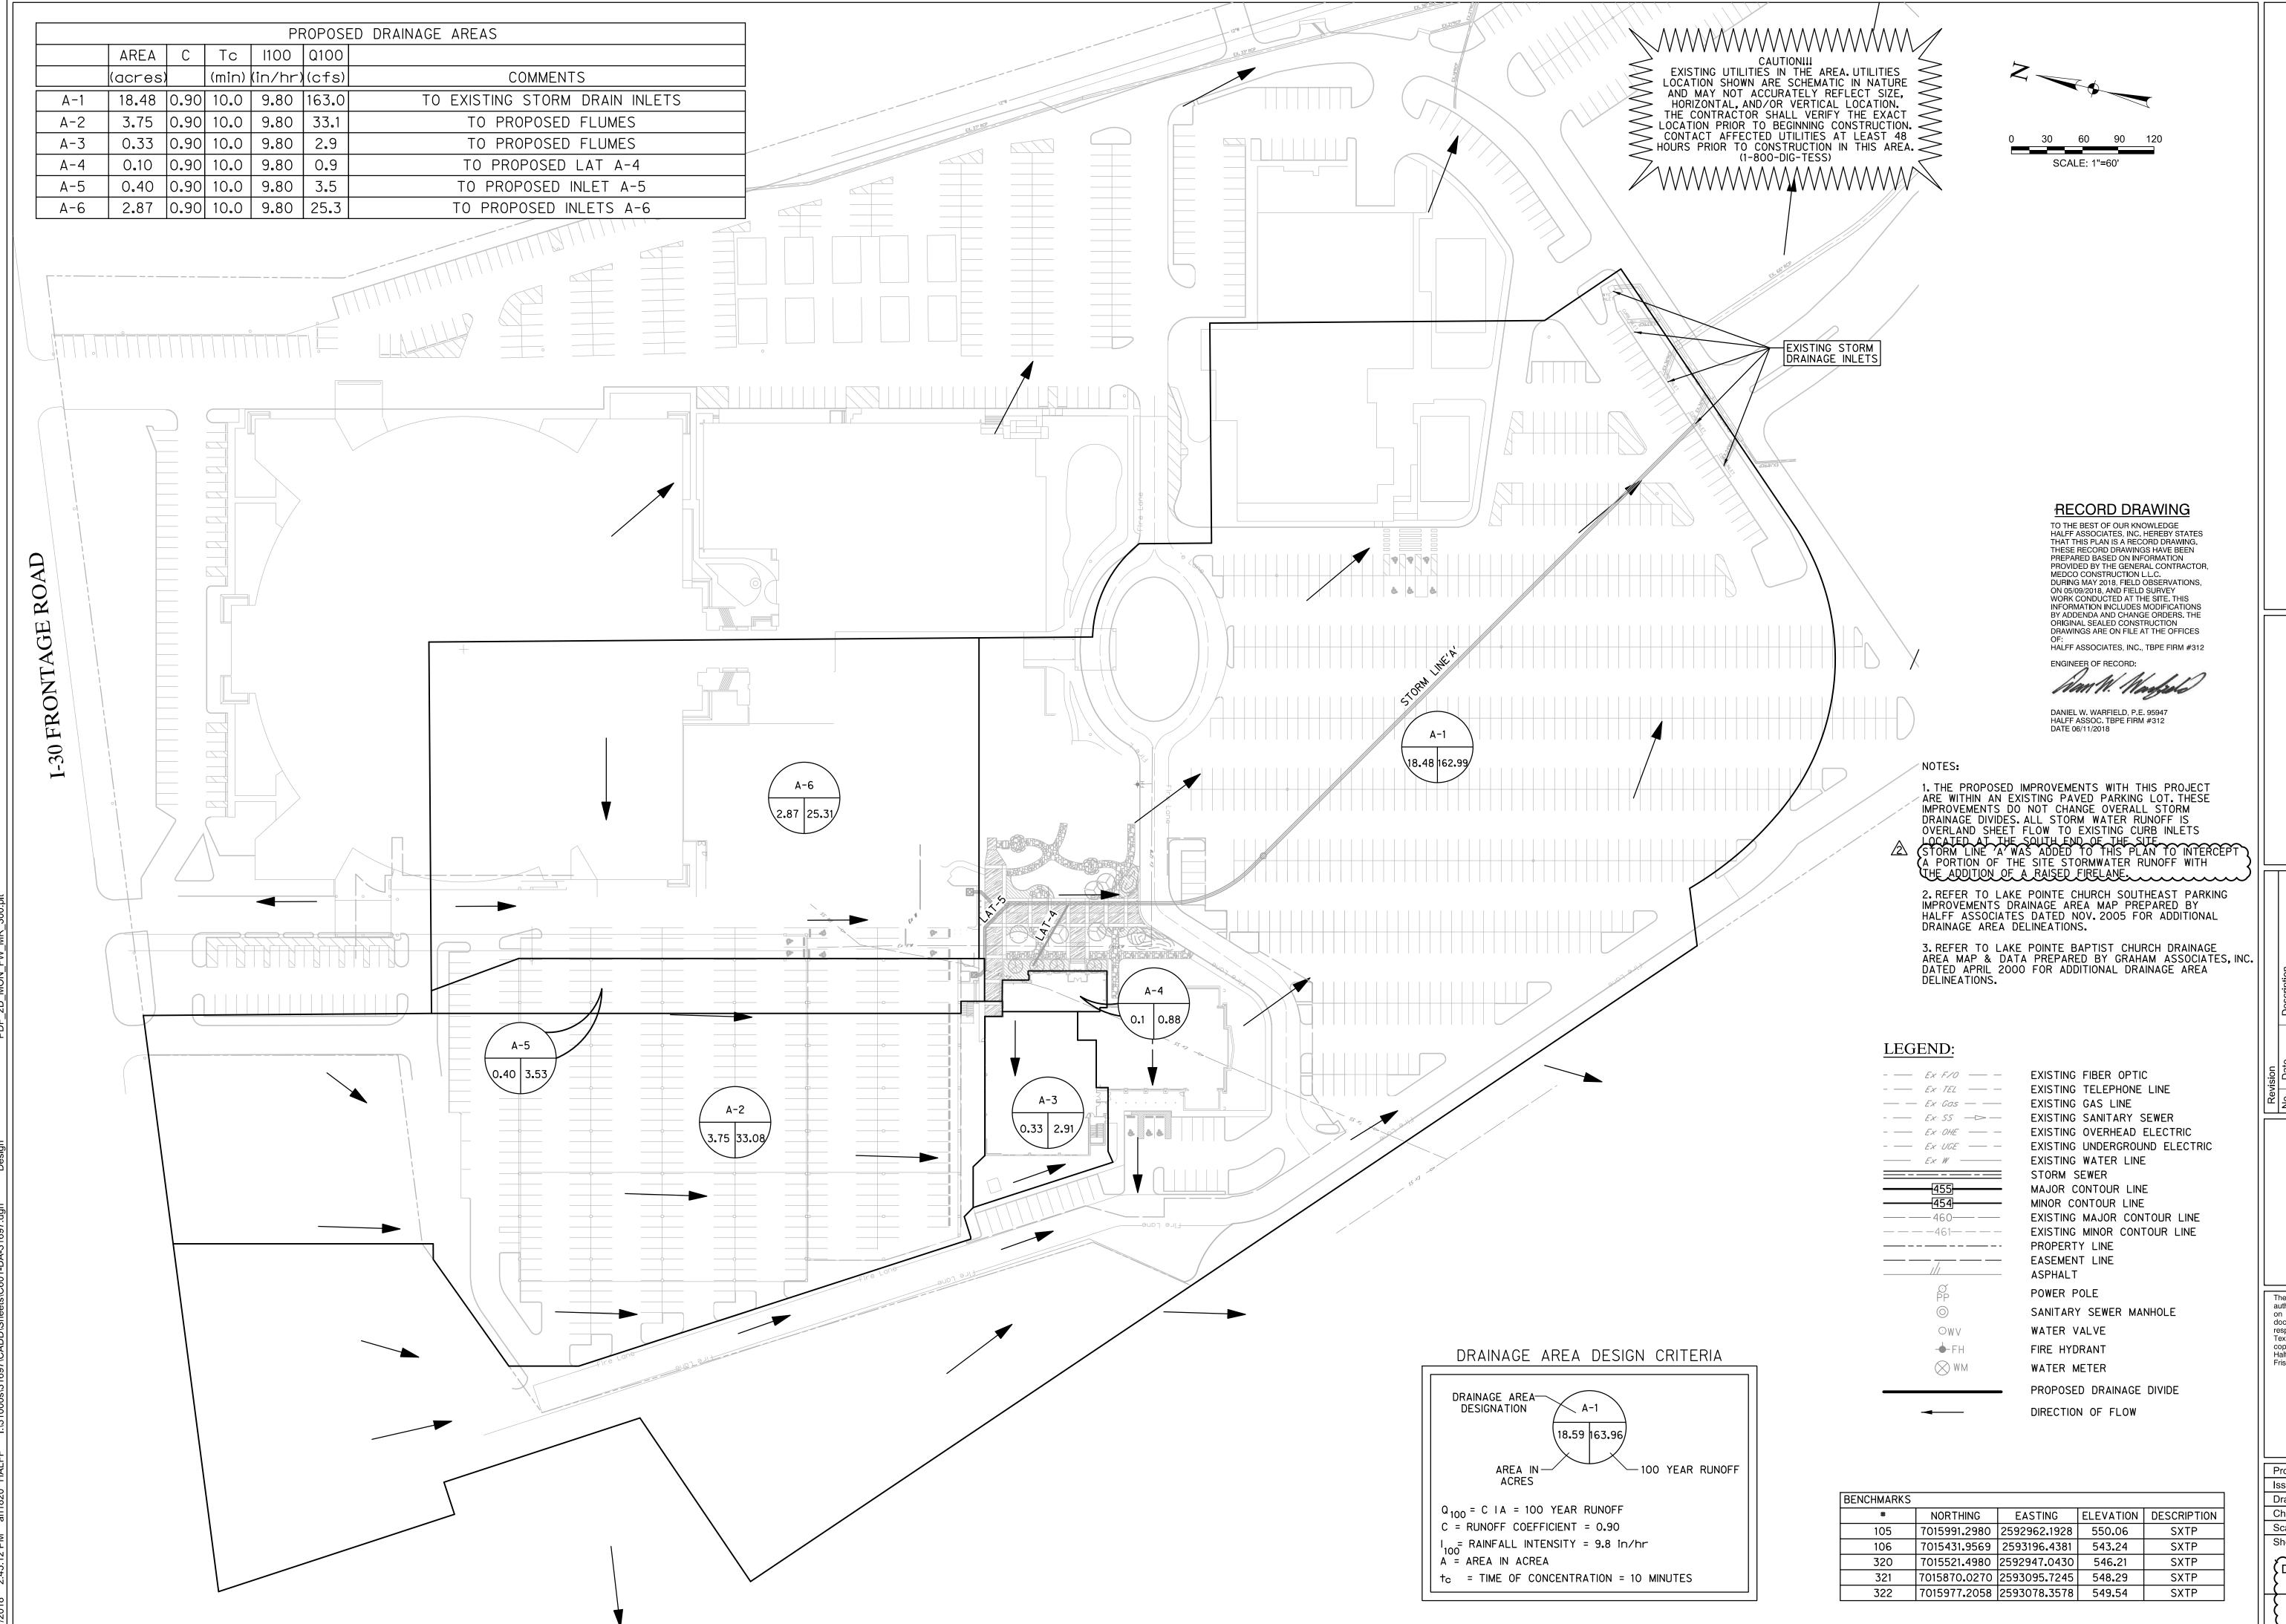LAKE POINTE CHURCH

NEW CHAPEL / EDUCATION BUILDING

701 linterstate 30 Rockwall, TX 75087

3803 PARKWOOD BLVD, SUITE 800 FRISCO, TEXAS 75034-8640 TEL (214) 618-4570 FAX (214) 618-4574 TBPE FIRM #F-312

2 10/03/2017 GRADING, ADDED F.H, RAISED F.I.
3 06/11/2018 RECORD DRAWII





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| Issued:      | 08/01/2017 |
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| Checked By:  | DWW        |
| Scale:       | AS NOTE    |
| Sheet Title  |            |
|              |            |

DRAINAGE AREA MAP

C6.01



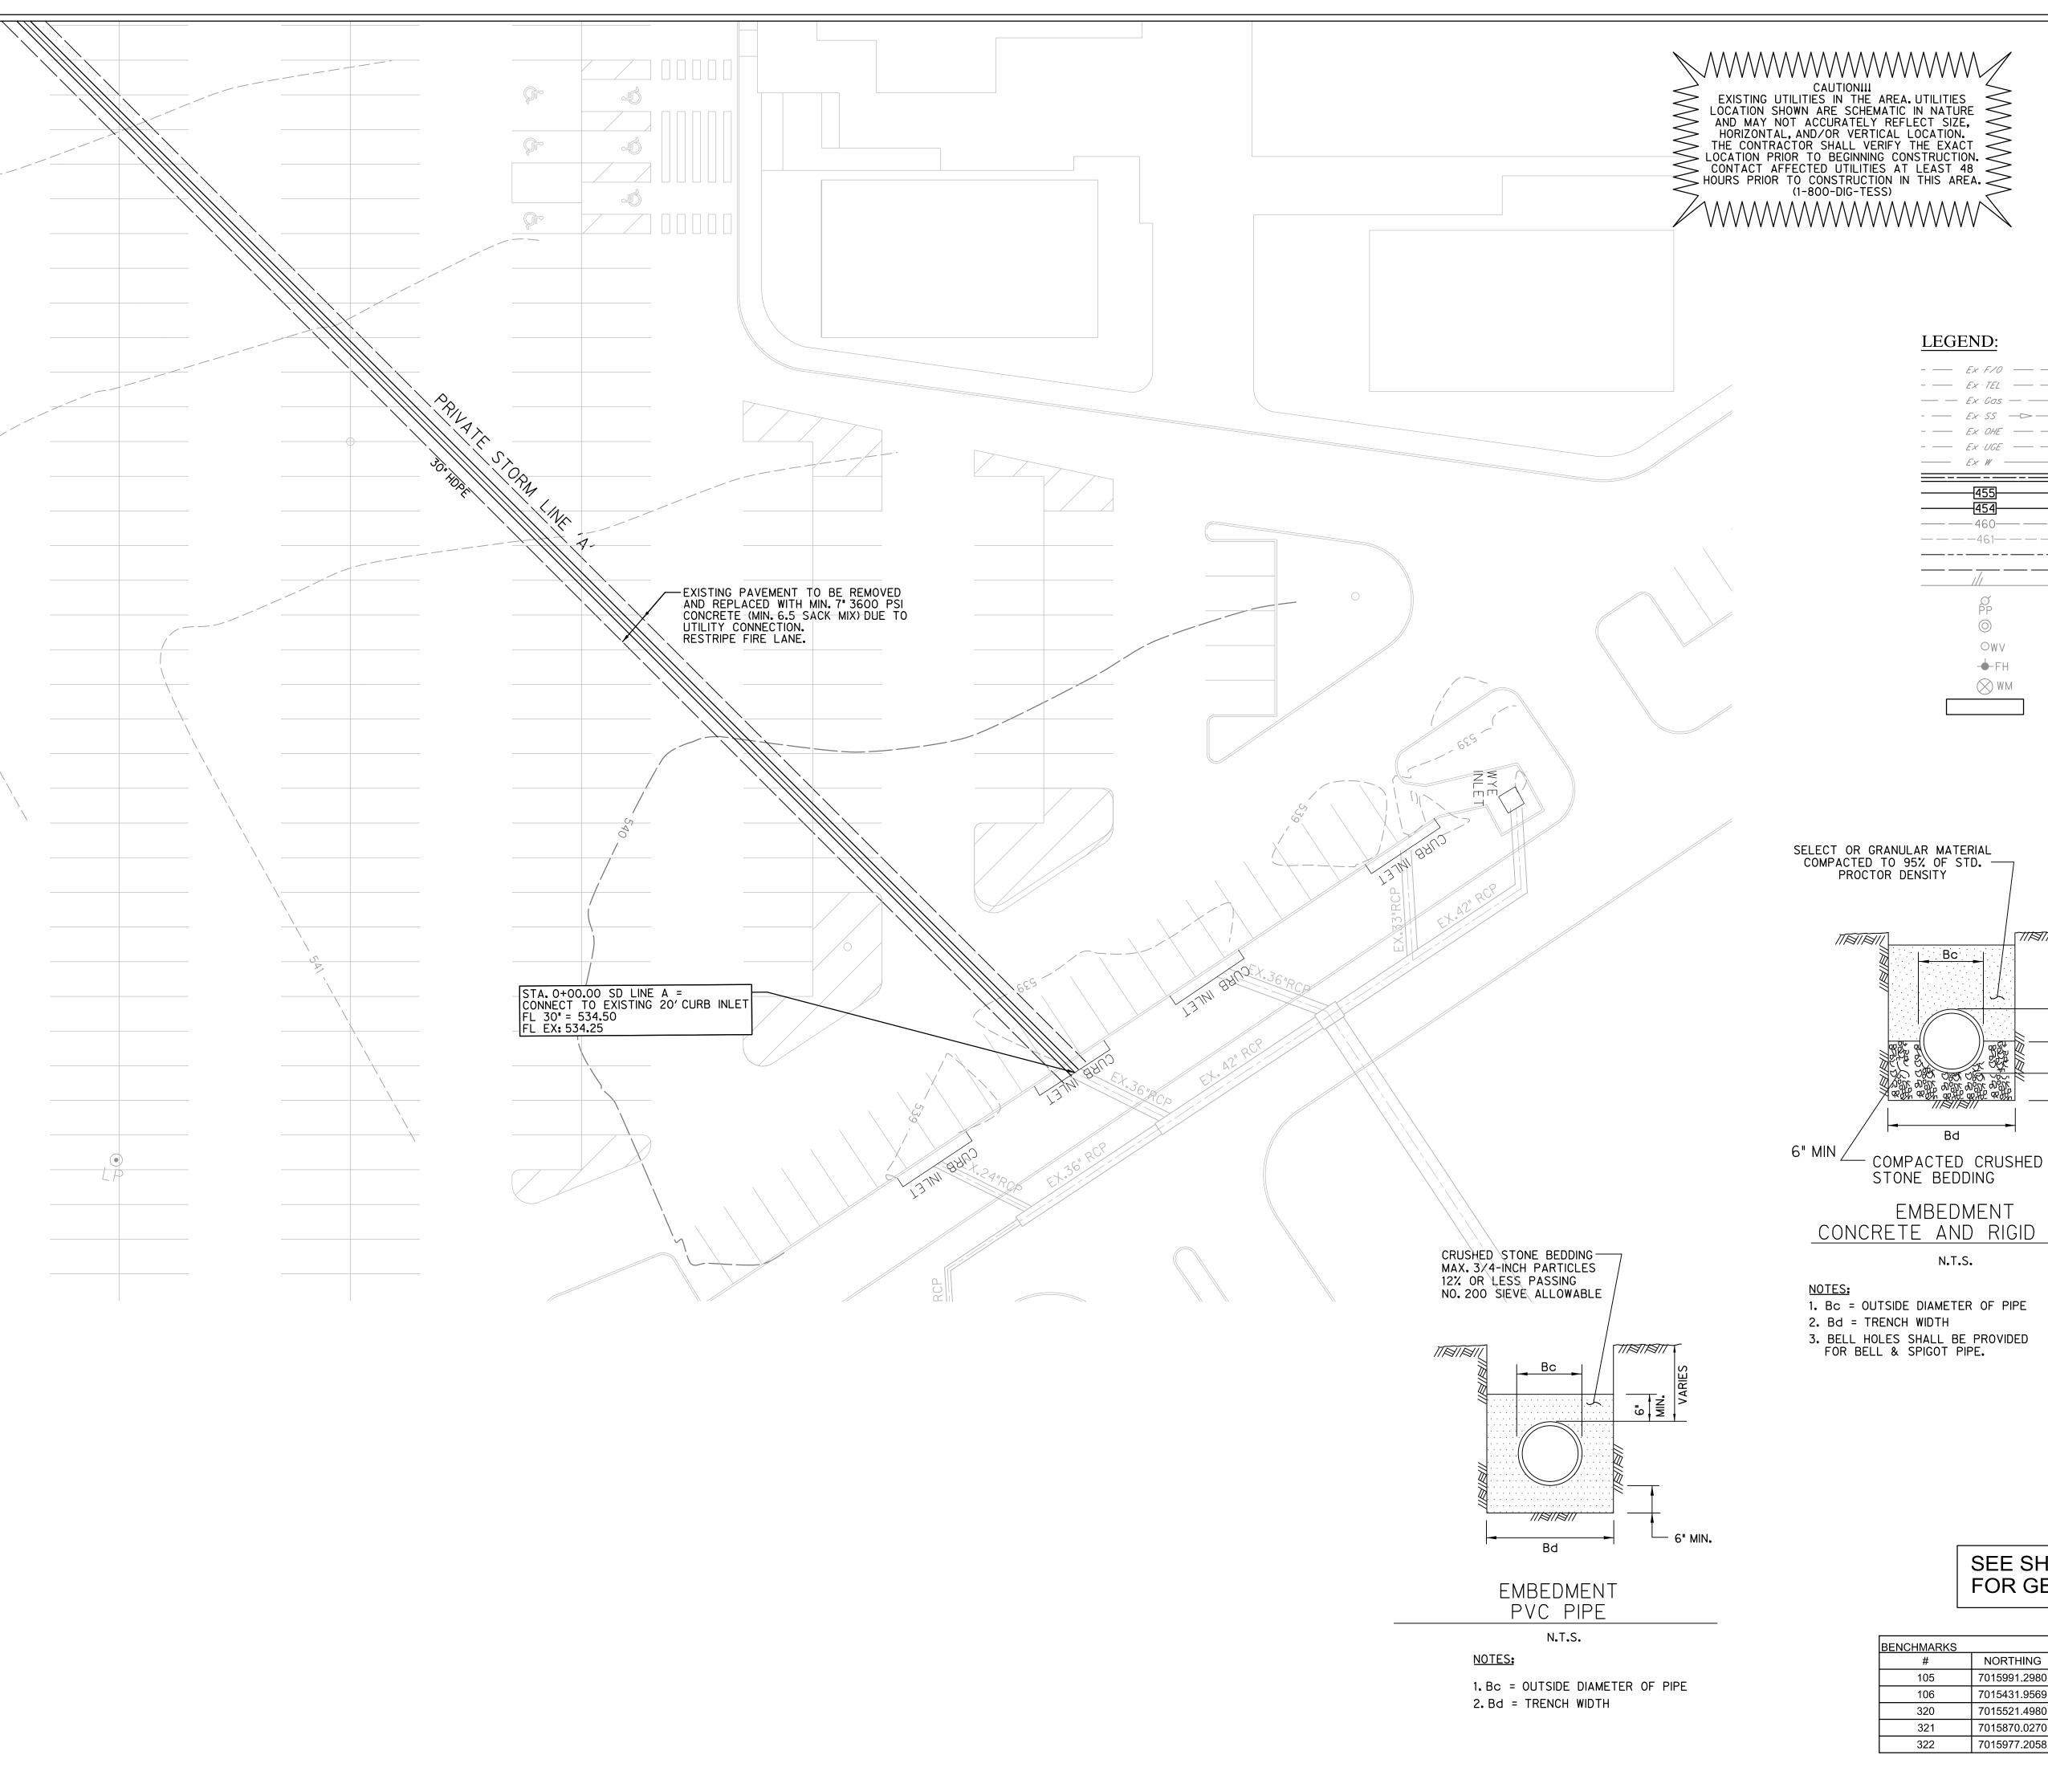
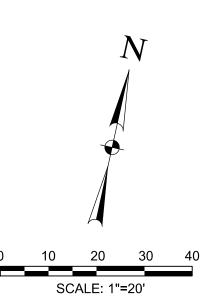
# LEGEND:

- — Ex ·F/0 — — EXISTING FIBER OPTIC - — Ex · TEL — — — — Ex Gas — — \_\_\_\_\_

EXISTING GAS LINE EXISTING SANITARY SEWER EXISTING OVERHEAD ELECTRIC EXISTING UNDERGROUND ELECTRIC EXISTING WATER LINE

STORM SEWER MAJOR CONTOUR LINE MINOR CONTOUR LINE EXISTING MAJOR CONTOUR LINE

EXISTING MINOR CONTOUR LINE PROPERTY LINE EASEMENT LINE ASPHALT POWER POLE

SANITARY SEWER MANHOLE WATER VALVE FIRE HYDRANT WATER METER

EXISTING TELEPHONE LINE

INLET PROTECTION

SELECT OR GRANULAR MATERIAL COMPACTED TO 95% OF STD. — PROCTOR DENSITY TIBIBIT TIBIBII

EMBEDMENT CONCRETE AND RIGID PIPE

N.T.S.

1. Bc = OUTSIDE DIAMETER OF PIPE 2. Bd = TRENCH WIDTH 3. BELL HOLES SHALL BE PROVIDED FOR BELL & SPIGOT PIPE.

RECORD DRAWING TO THE BEST OF OUR KNOWLEDGE TO THE BEST OF OUR KNOWLEDGE HALFF ASSOCIATES, INC. HEREBY STATES THAT THIS PLAN IS A RECORD DRAWING. THESE RECORD DRAWINGS HAVE BEEN PREPARED BASED ON INFORMATION PROVIDED BY THE GENERAL CONTRACTOR, MEDCO CONSTRUCTION L.L.C. DURING MAY 2018, FIELD OBSERVATIONS, ON 05/09/2018, AND FIELD SURVEY WORK CONDUCTED AT THE SITE. THIS INFORMATION INCLUDES MODIFICATIONS BY ADDENDA AND CHANGE ORDERS. THE ORIGINAL SEALED CONSTRUCTION DRAWINGS ARE ON FILE AT THE OFFICES OF: HALFF ASSOCIATES, INC., TBPE FIRM #312

DANIEL W. WARFIELD, P.E. 95947 HALFF ASSOC. TBPE FIRM #312 DATE 06/11/2018

ENGINEER OF RECORD:

| CHMARKS |              |              |           |             |
|---------|--------------|--------------|-----------|-------------|
| #       | NORTHING     | EASTING      | ELEVATION | DESCRIPTION |
| 105     | 7015991.2980 | 2592962.1928 | 550.06    | SXTP        |
| 106     | 7015431.9569 | 2593196.4381 | 543.24    | SXTP        |
| 320     | 7015521.4980 | 2592947.0430 | 546.21    | SXTP        |
| 321     | 7015870.0270 | 2593095.7245 | 548.29    | SXTP        |
| 322     | 7015977.2058 | 2593078.3578 | 549.54    | SXTP        |

# SEE SHEET C0.01 FOR GENERAL NOTES

CHURCH ATION BUILDING INTE EDUC

75087

701

Sheet Title STORM DRAIN PLAN C6.02 Sheet Number

08/01/2017

AS NOTED

TRS

DANIEL W. WARFIELD

95947

10-3-2017

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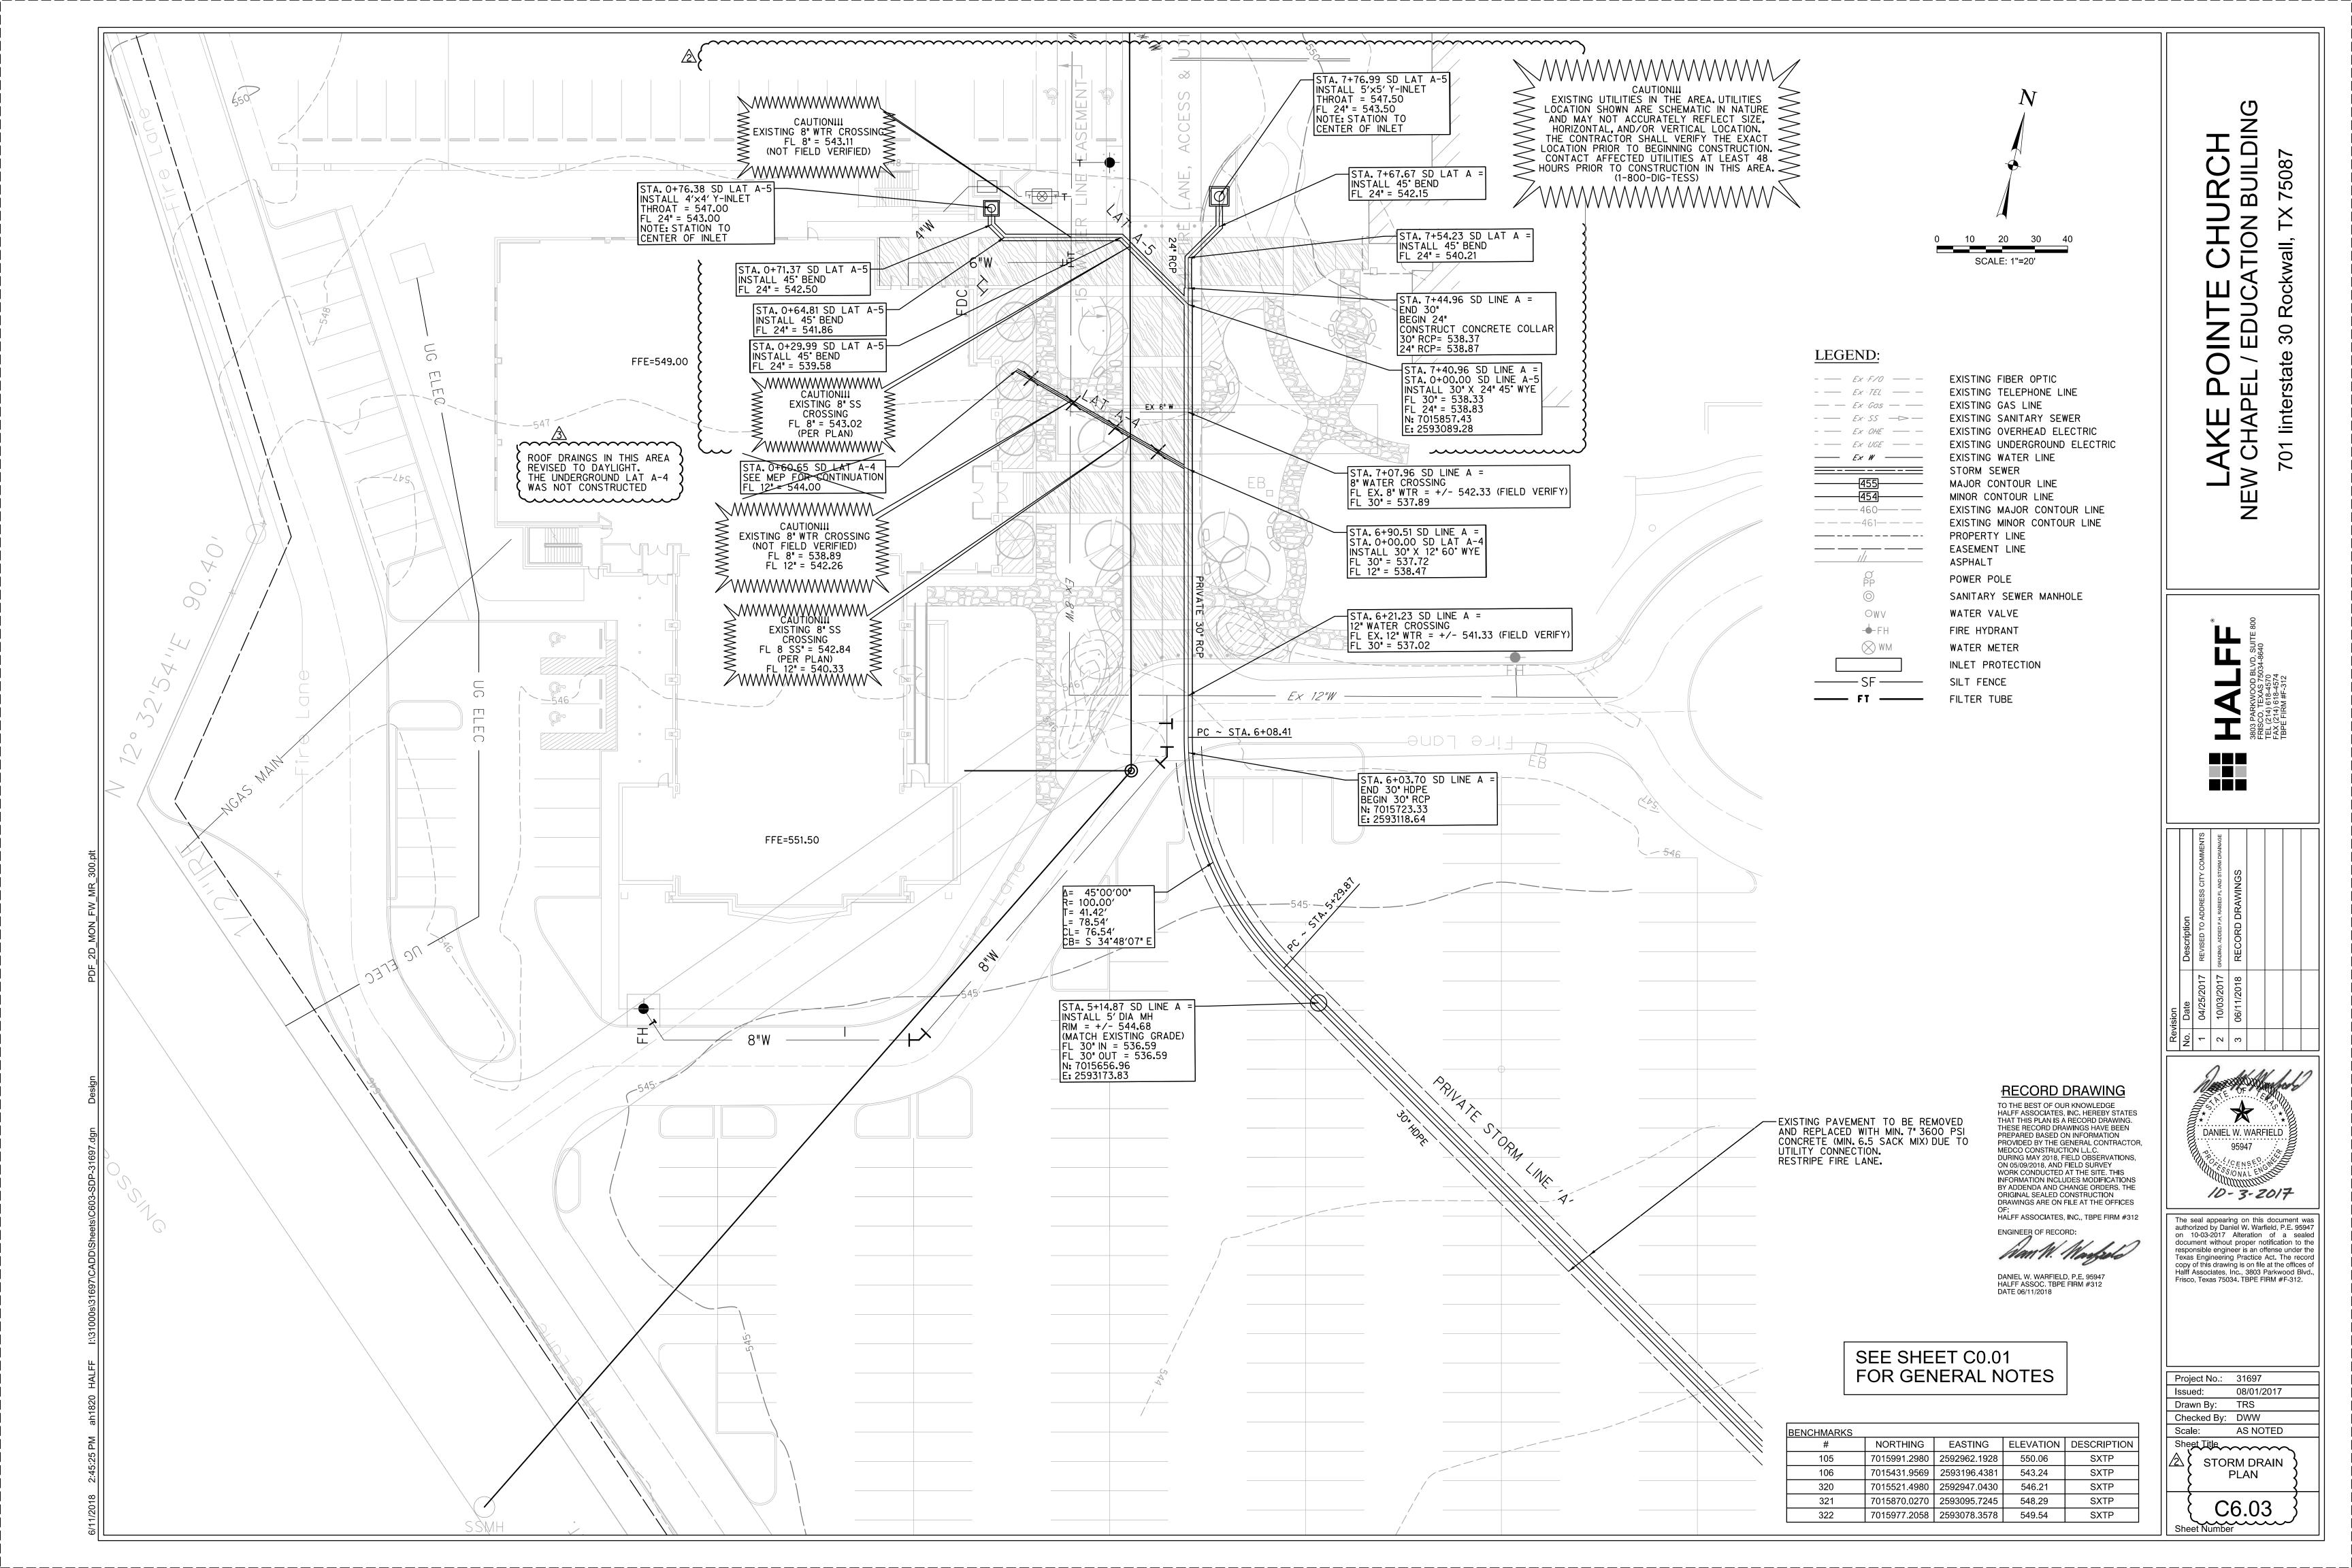
Project No.: 31697


Checked By: DWW

Issued:

Scale:


Drawn By:



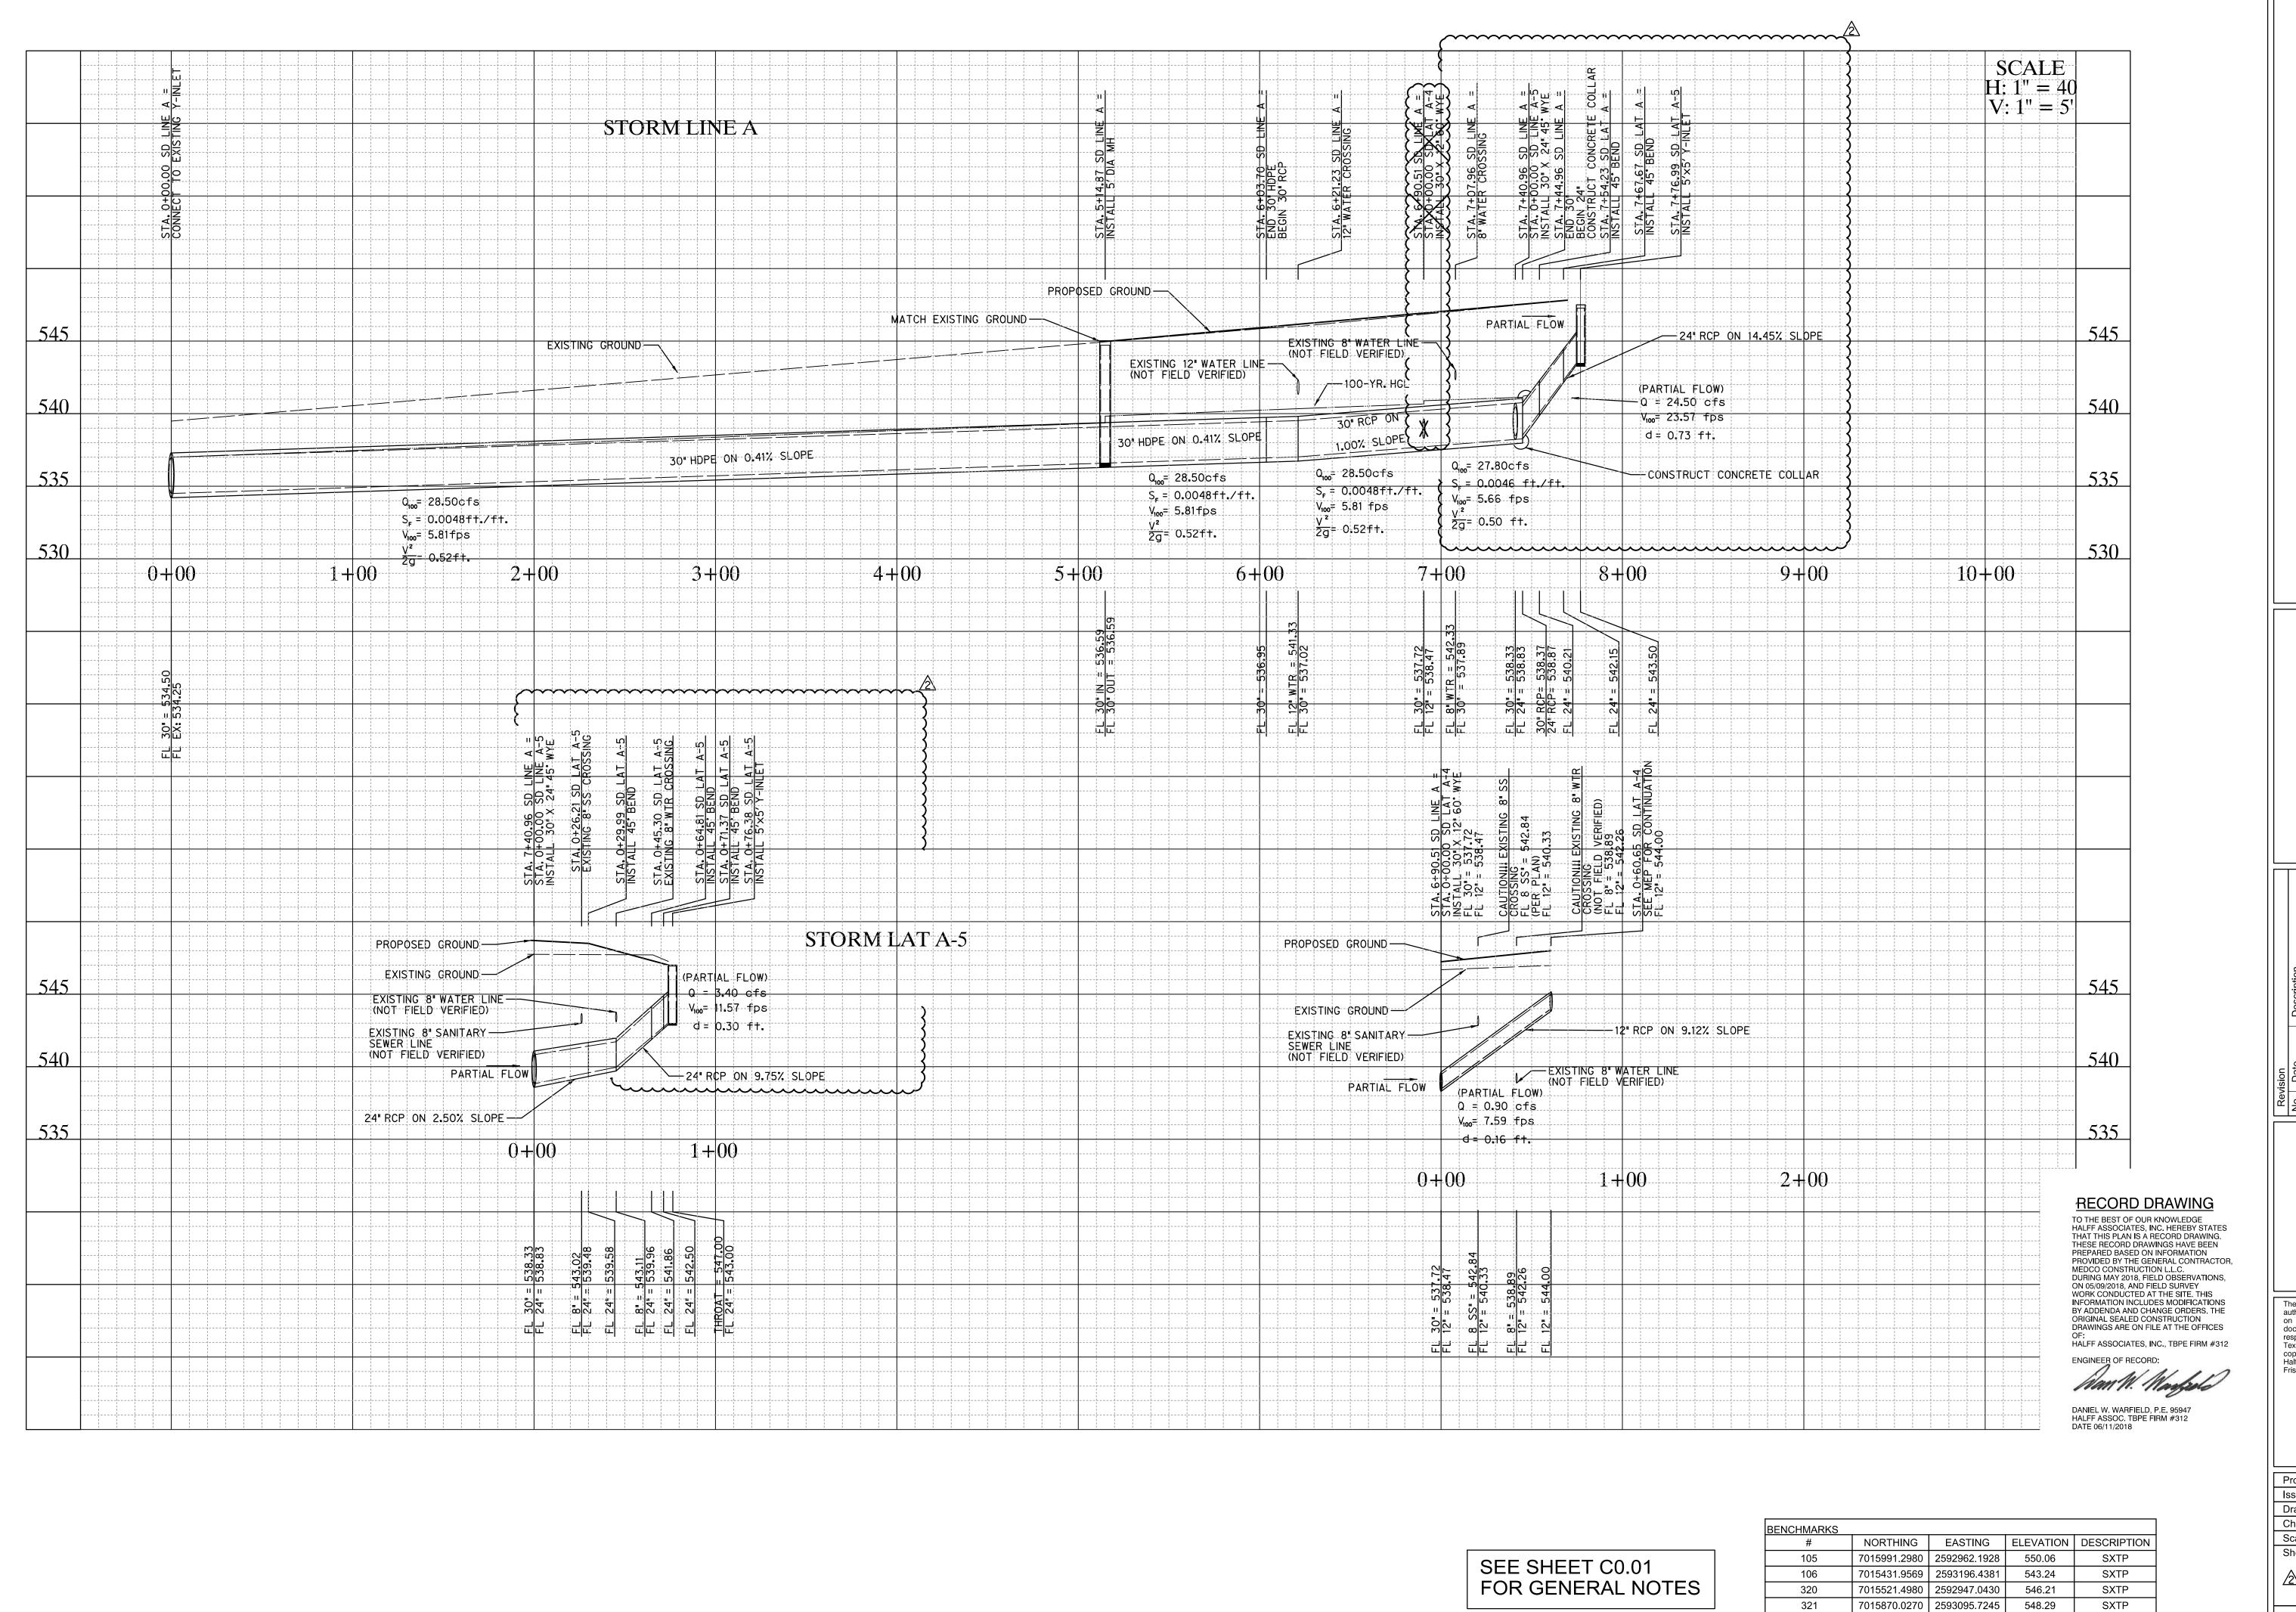

LAKE POINTE CHURCH
NEW CHAPEL / EDUCATION BUILDING
701 linterstate 30 Rockwall, TX 75087

No. Date Description
2 10/03/2017 GRADING, ADDED F.H. RAISED FL AND STORM DRAINAG
3 06/11/2018 RECORD DRAWINGS

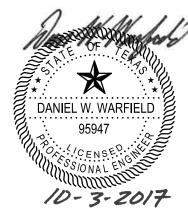

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|------------------------------|--------------------------|
| Issued:                      | 08/01/2017               |
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| Checked By:                  | DWW                      |
| Scale:                       | AS NOTED                 |
| Sheet Title                  |                          |
| Drawn By: Checked By: Scale: | 08/01/2017<br>TRS<br>DWW |

549.54

7015977.2058 | 2593078.3578 |

322

SXTP

Checked By: DWW
Scale: AS NOTED
Sheet Title

STORM DRAIN
PROFILE

C6.04
Sheet Number

| I:\31000s\31 |  |
|--------------|--|
| HALFF        |  |
| ah1820 l     |  |
| 2.45.35 PM   |  |
| 018          |  |

| -          |  |
|------------|--|
| HALFF      |  |
| ah1820     |  |
| 2:45:35 PM |  |

| TOJECT NO   | 31091      |
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| ssued:      | 08/01/2017 |
| Orawn By:   | TRS        |
| Checked By: | DWW        |
| Scale:      | AS NOTED   |
| Sheet Title |            |
| STOF        | RM DRAIN   |

C6.05

CALCS

POINTE CHURCH JEL / EDUCATION BUILDING 30 Rockwall, 701 linterstate LAKE PC NEW CHAPEL /

**Hydraulic Grade** 

Junction | Minor

Losses

1.42

0.00

0.00

0.00

0.00

0.00

0.00

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BY ADDENDA AND CHANGE ORDERS. THE ORIGINAL SEALED CONSTRUCTION DRAWINGS ARE ON FILE AT THE OFFICES

HALFF ASSOCIATES, INC., TBPE FIRM #312

ENGINEER OF RECORD:

DATE 06/11/2018

DANIEL W. WARFIELD, P.E. 95947 HALFF ASSOC. TBPE FIRM #312

Losses

Hyd. Grade

After Hyd.

542.79

541.99

541.77

541.26

541.25

Grade After

Friction

0.11 541.37 0.00

541.16

541.26

540.83

540.50

0.01 541.06 0.00

541.24

541.22

541.27 0.00

0.01

541.29

0.16 541.38

2.49 539.49

541.25 0.00 541.25 0.01

0.11

0.05

0.23

0.33

0.51

0.00

0.01

Friction

Losses

Flow Time

Distance

(minutes)

0.01

DS Hyd. Grade

541.26

541.22

541.05

541.22

537.00

541.22

75087

DANIEL W. WARFIELD 95947 10-3-2017

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| Drawn By:    | TRS        |
| Checked By:  | DWW        |
| Scale:       | AS NOTED   |
| Chaot Title  |            |

Sheet Number

 $Q = 3.087 Ly^3/2$ DROP INLET FLOW EQUATION:

 $L = Q/3.087y^3/2$ DROP INLET LENGTH EQUATION:

Selected Storm

Sewer Size

SPAN for RCB

DIA for pipe

(inches)

24

24

Slope of

Water

Runoff "Q"

(c.f.s.)

24.5

24.5

24.5

24.4

28.5

28.5

0.9

3.4 0.0002

Hydraulic Gradient "S"

(ft./ft.)

0.0117

0.0117

0.0117

0.0117

0.0046

0.0048

0.0048

0.0048

0.0002

RISE ONLY Velocity In Sewer

FOR RCB

(feet)

Between

Collection Points "V" (ft/sec)

7.80

7.80

7.79 7.78

5.66

5.80

5.81

5.81

1.12

1.07

1.07

Standard DS

Junction Loss

0.35

0.35

0.60

0.60

0.05

0.35

0.35

Minor | **Velocity** 

Loss Head
Coeff. (V2/2g)
Kj (feet)

1.50 **0.95** 

0.94

0.94

0.94

0.50

0.52

0.52

0.52

0.02

INLET CALCULATIONS:

STORM DRAIN CALCULATIONS:

DRAINAGE AREA

LINE A

45^ BEND

45^ BEND

5' DIA MH

INLET A-4

45^ BEND

45^ BEND

45^ BEND

LATERAL A-4

LATERAL A-5

Pipe slope change

Pipe Size Change

45^ WYE LAT A-5

60^ WYE LAT A-4

PIPE SLOPE CHANGE

RUNOFF COLLECTION POINT (Inlet or Manhole)

UPSTREAM DOWNSTREAM STATION STATION

7+76.99

7+67.67

7+54.23

7+44.96

7+40.96

6+90.51

6+21.23

5+14.87

0+09.53

0+71.37

0+45.30

0+29.99

7+67.67

7+54.23

7+44.96

7+40.96

6+90.51

6+21.23

5+14.87

0+00.00

0+00.00

0+71.37

0+64.81

0+45.30

0+29.99

0+00.00

| Inlet ID | Flow To<br>Inlet (Q) | Length of Inlet<br>Opening (L) | Depth of Water<br>(head at inlet) (y) | Q Allowable | Q Actual |
|----------|----------------------|--------------------------------|---------------------------------------|-------------|----------|
|          | (cfs)                | (ft)                           | (ft)                                  | (cfs)       | (cfs)    |
| A-6      | 25.31                | 5'X5', L=20                    | 0.6                                   | 28.69       | 25.31    |
| A-5      | 3.53                 | 4'X4', L=16                    | 0.5                                   | 17.46       | 3.53     |

INCREMENTAL DRAINAGE

Runoff Coeff.

C\*Cf

0.90

0.00

0.00

0.00

0.90

0.90

0.00

Incremental "CA"

2.50

0.00

0.00

Drainage Combined

Area "A"

(Acres)

2.78

Distance

Between Collection Points

9.32

13.44

9.27

4.00

50.45

69.28

106.36

514.87

9.53

5.01

<u> 19.51</u>

29.99

Incoming CA

(from wye

or manhole,

link to DS

lateral DS Accum.

0.00

0.00

0.00

0.00

0.34

0.09

0.00

0.00

CA)

Time at

Upstream

Station

(minutes)

10.00

10.02

10.05

10.07

10.73

10.00

Accum-

"CA"

2.50

2.50

2.50

2.84

2.93

2.93

Design Storm | Intensity | "I"

Frequency

100

100

100


9.79

9.77

9.76

9.47

9.80

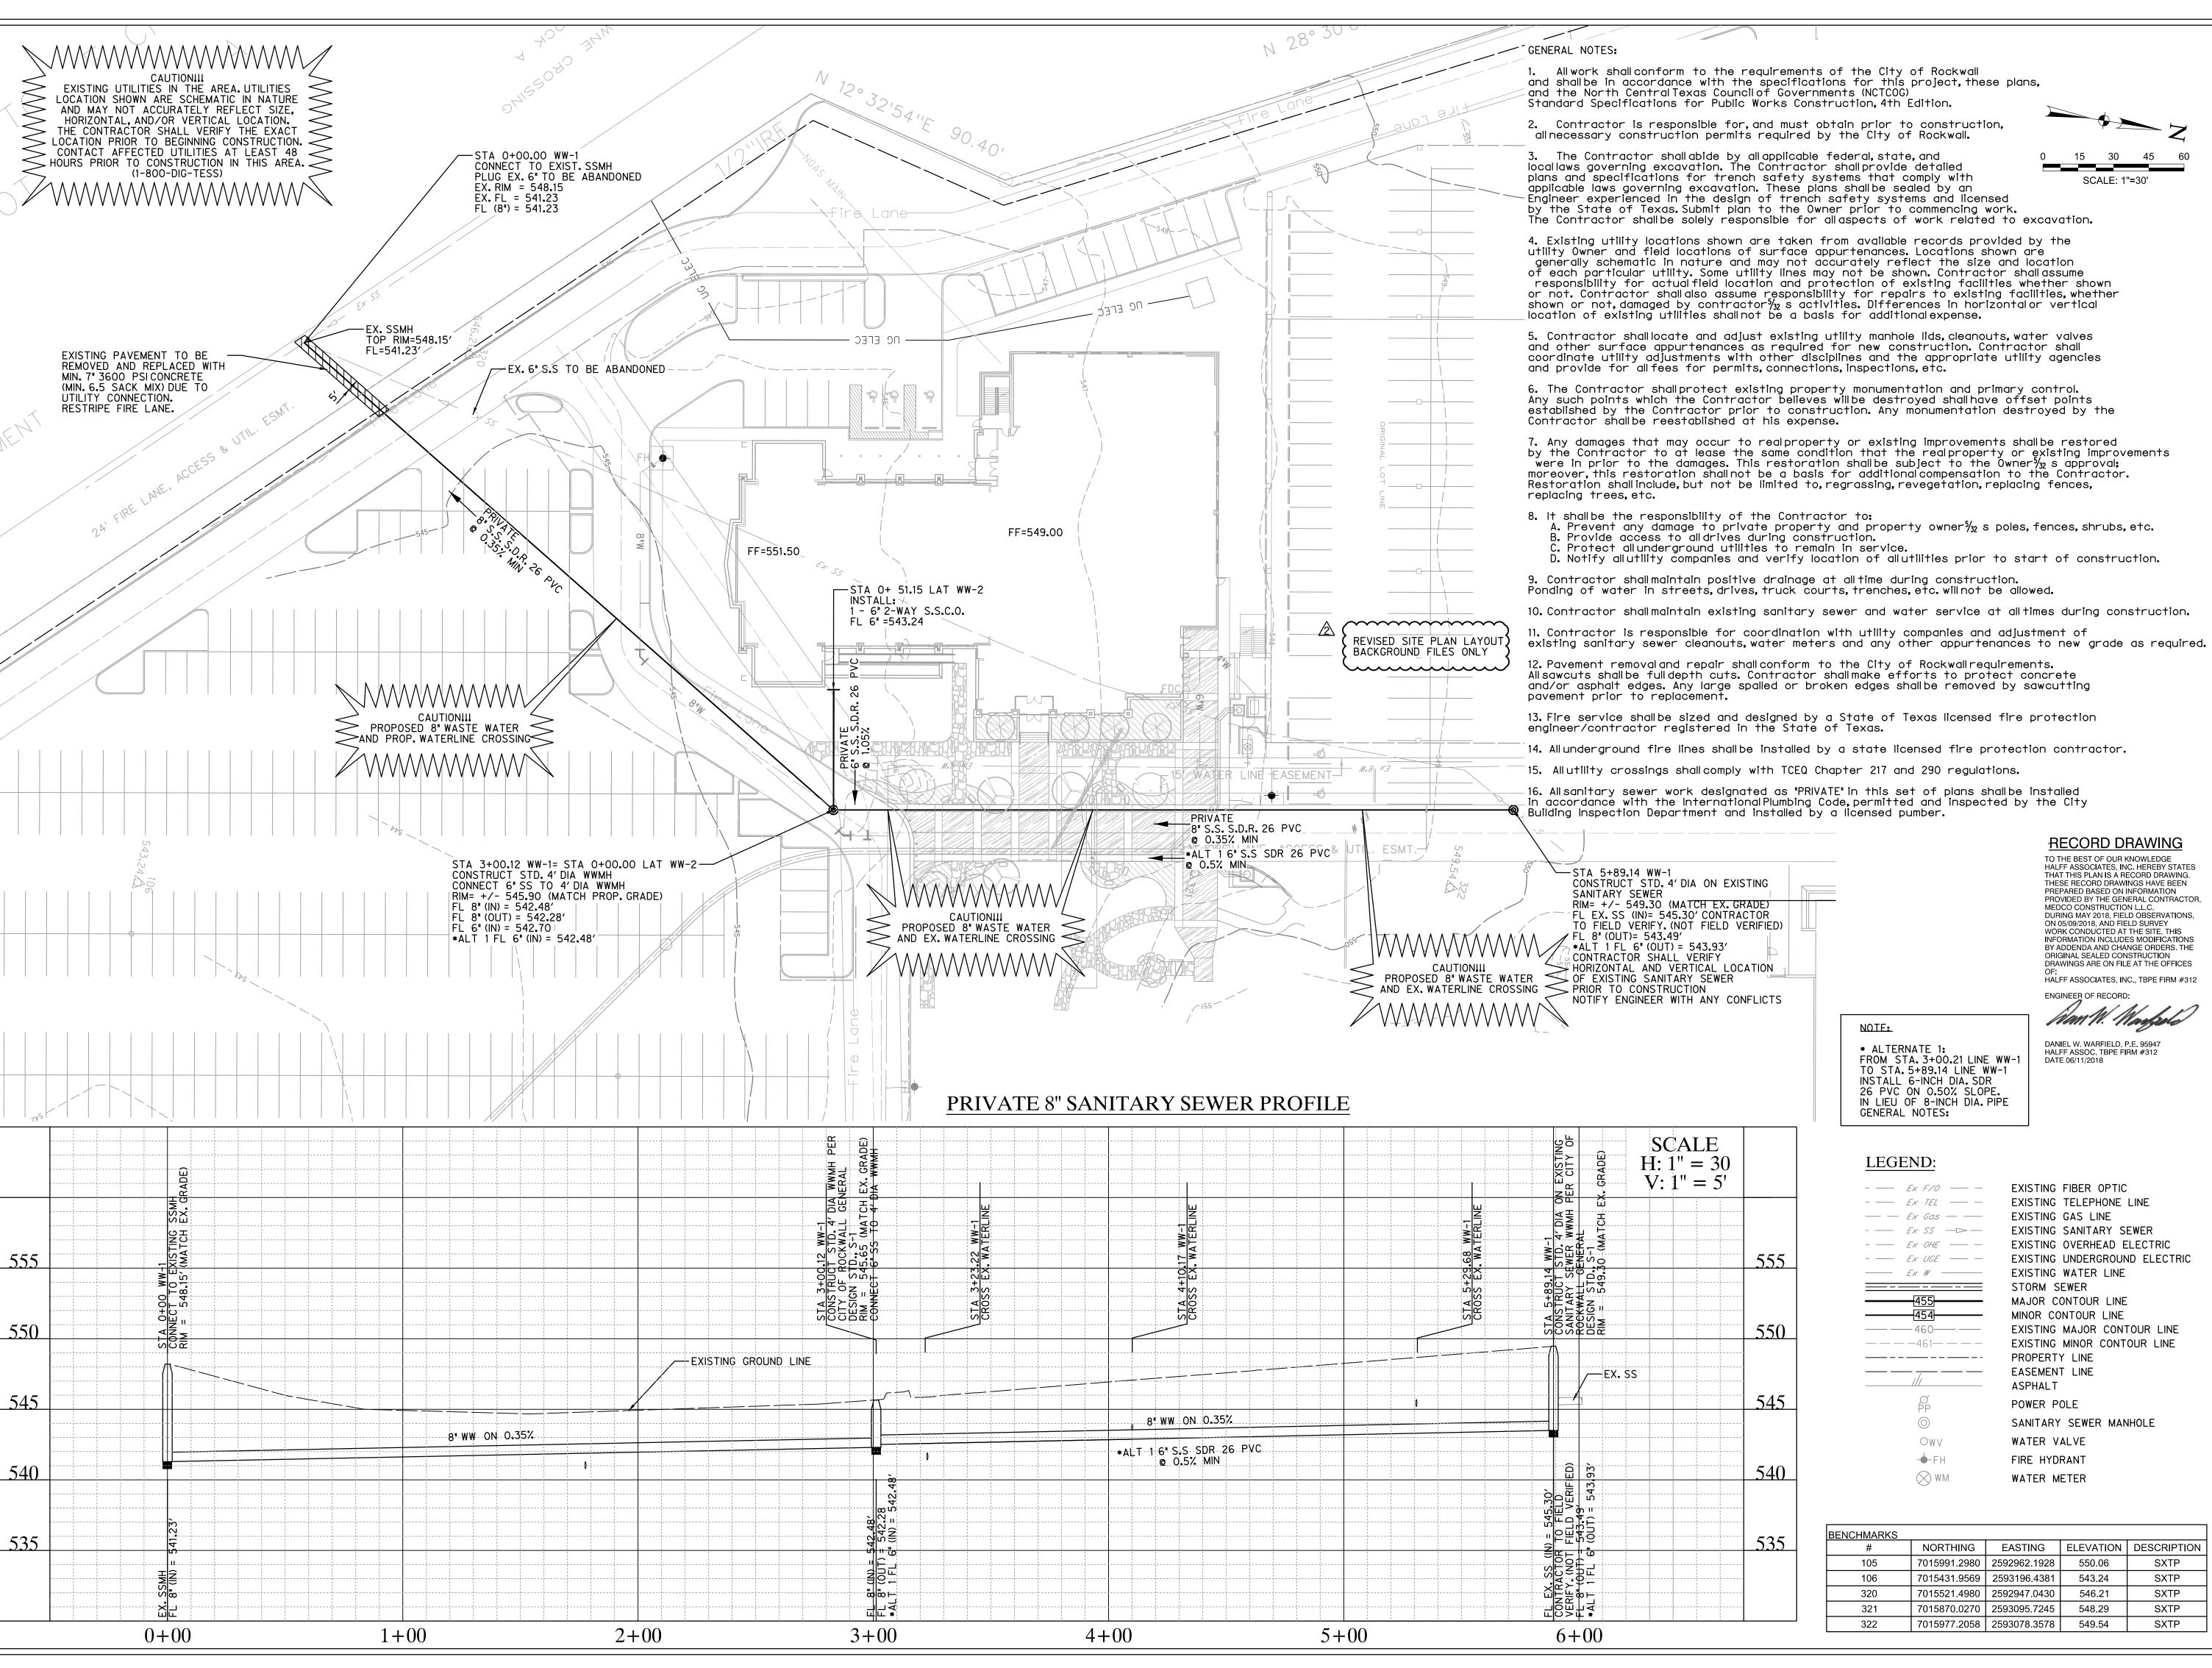

# BUILDIN NOL ED 01

HALFF ASSOCIATES, INC. HEREBY STATES PROVIDED BY THE GENERAL CONTRACTOR, INFORMATION INCLUDES MODIFICATIONS BY ADDENDA AND CHANGE ORDERS. THE ORIGINAL SEALED CONSTRUCTION DRAWINGS ARE ON FILE AT THE OFFICES

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DANIEL W. WARFIELD

95947

10-3-2017

The seal appearing on this document was authorized by Daniel W. Warfield, P.E. 95947

on 10-03-2017 Alteration of a sealed

document without proper notification to the responsible engineer is an offense under the

Texas Engineering Practice Act. The record copy of this drawing is on file at the offices of Halff Associates, Inc., 3803 Parkwood Blvd.,

Frisco, Texas 75034. TBPE FIRM #F-312.

HALFF ASSOCIATES, INC., TBPE FIRM #312 ENGINEER OF RECORD: Man M. Margali

RECORD DRAWING

THAT THIS PLAN IS A RECORD DRAWING

THESE RECORD DRAWINGS HAVE BEEN

**DURING MAY 2018. FIELD OBSERVATIONS** ON 05/09/2018, AND FIELD SURVEY

PREPARED BASED ON INFORMATION

MEDCO CONSTRUCTION L.L.C.

TO THE BEST OF OUR KNOWLEDGE

DANIEL W. WARFIELD, P.E. 95947 HALFF ASSOC. TBPE FIRM #312 DATE 06/11/2018

EXISTING FIBER OPTIC

EXISTING GAS LINE

EXISTING TELEPHONE LINE

EXISTING SANITARY SEWER

EXISTING OVERHEAD ELECTRIC

SCALE: 1"=30'

| <br>Ex · TEL             |
|--------------------------|
| <br>Ex ·Gos — —          |
| <br>Ex: 55 — →           |
| <br>EX OHE               |
| <br>Ex ·UGE              |
| <br>Ex W                 |
|                          |
|                          |
| 455                      |
| <br>455                  |
| 454                      |
|                          |
| <br>454                  |
| <br><b>454</b> — 460 — — |

EXISTING UNDERGROUND ELECTRIC EXISTING WATER LINE STORM SEWER MAJOR CONTOUR LINE MINOR CONTOUR LINE EXISTING MAJOR CONTOUR LINE EXISTING MINOR CONTOUR LINE PROPERTY LINE EASEMENT LINE

ASPHALT POWER POLE SANITARY SEWER MANHOLE WATER VALVE  $\bigcirc$ W $\vee$ FIRE HYDRANT ----FH  $\bigotimes$  WM WATER METER


| BENCHMARKS |              |              |           |             |
|------------|--------------|--------------|-----------|-------------|
| #          | NORTHING     | EASTING      | ELEVATION | DESCRIPTION |
| 105        | 7015991.2980 | 2592962.1928 | 550.06    | SXTP        |
| 106        | 7015431.9569 | 2593196.4381 | 543.24    | SXTP        |
| 320        | 7015521.4980 | 2592947.0430 | 546.21    | SXTP        |
| 321        | 7015870.0270 | 2593095.7245 | 548.29    | SXTP        |
| 322        | 7015977.2058 | 2593078.3578 | 549.54    | SXTP        |

| Project No.: | 31697      |
|--------------|------------|
| Issued:      | 04/25/2017 |
| Drawn By:    | TRS        |
| Checked By:  | DWW        |


AS NOTED Scale Sheet Title WASTE WATER

PLAN

Sheet Number

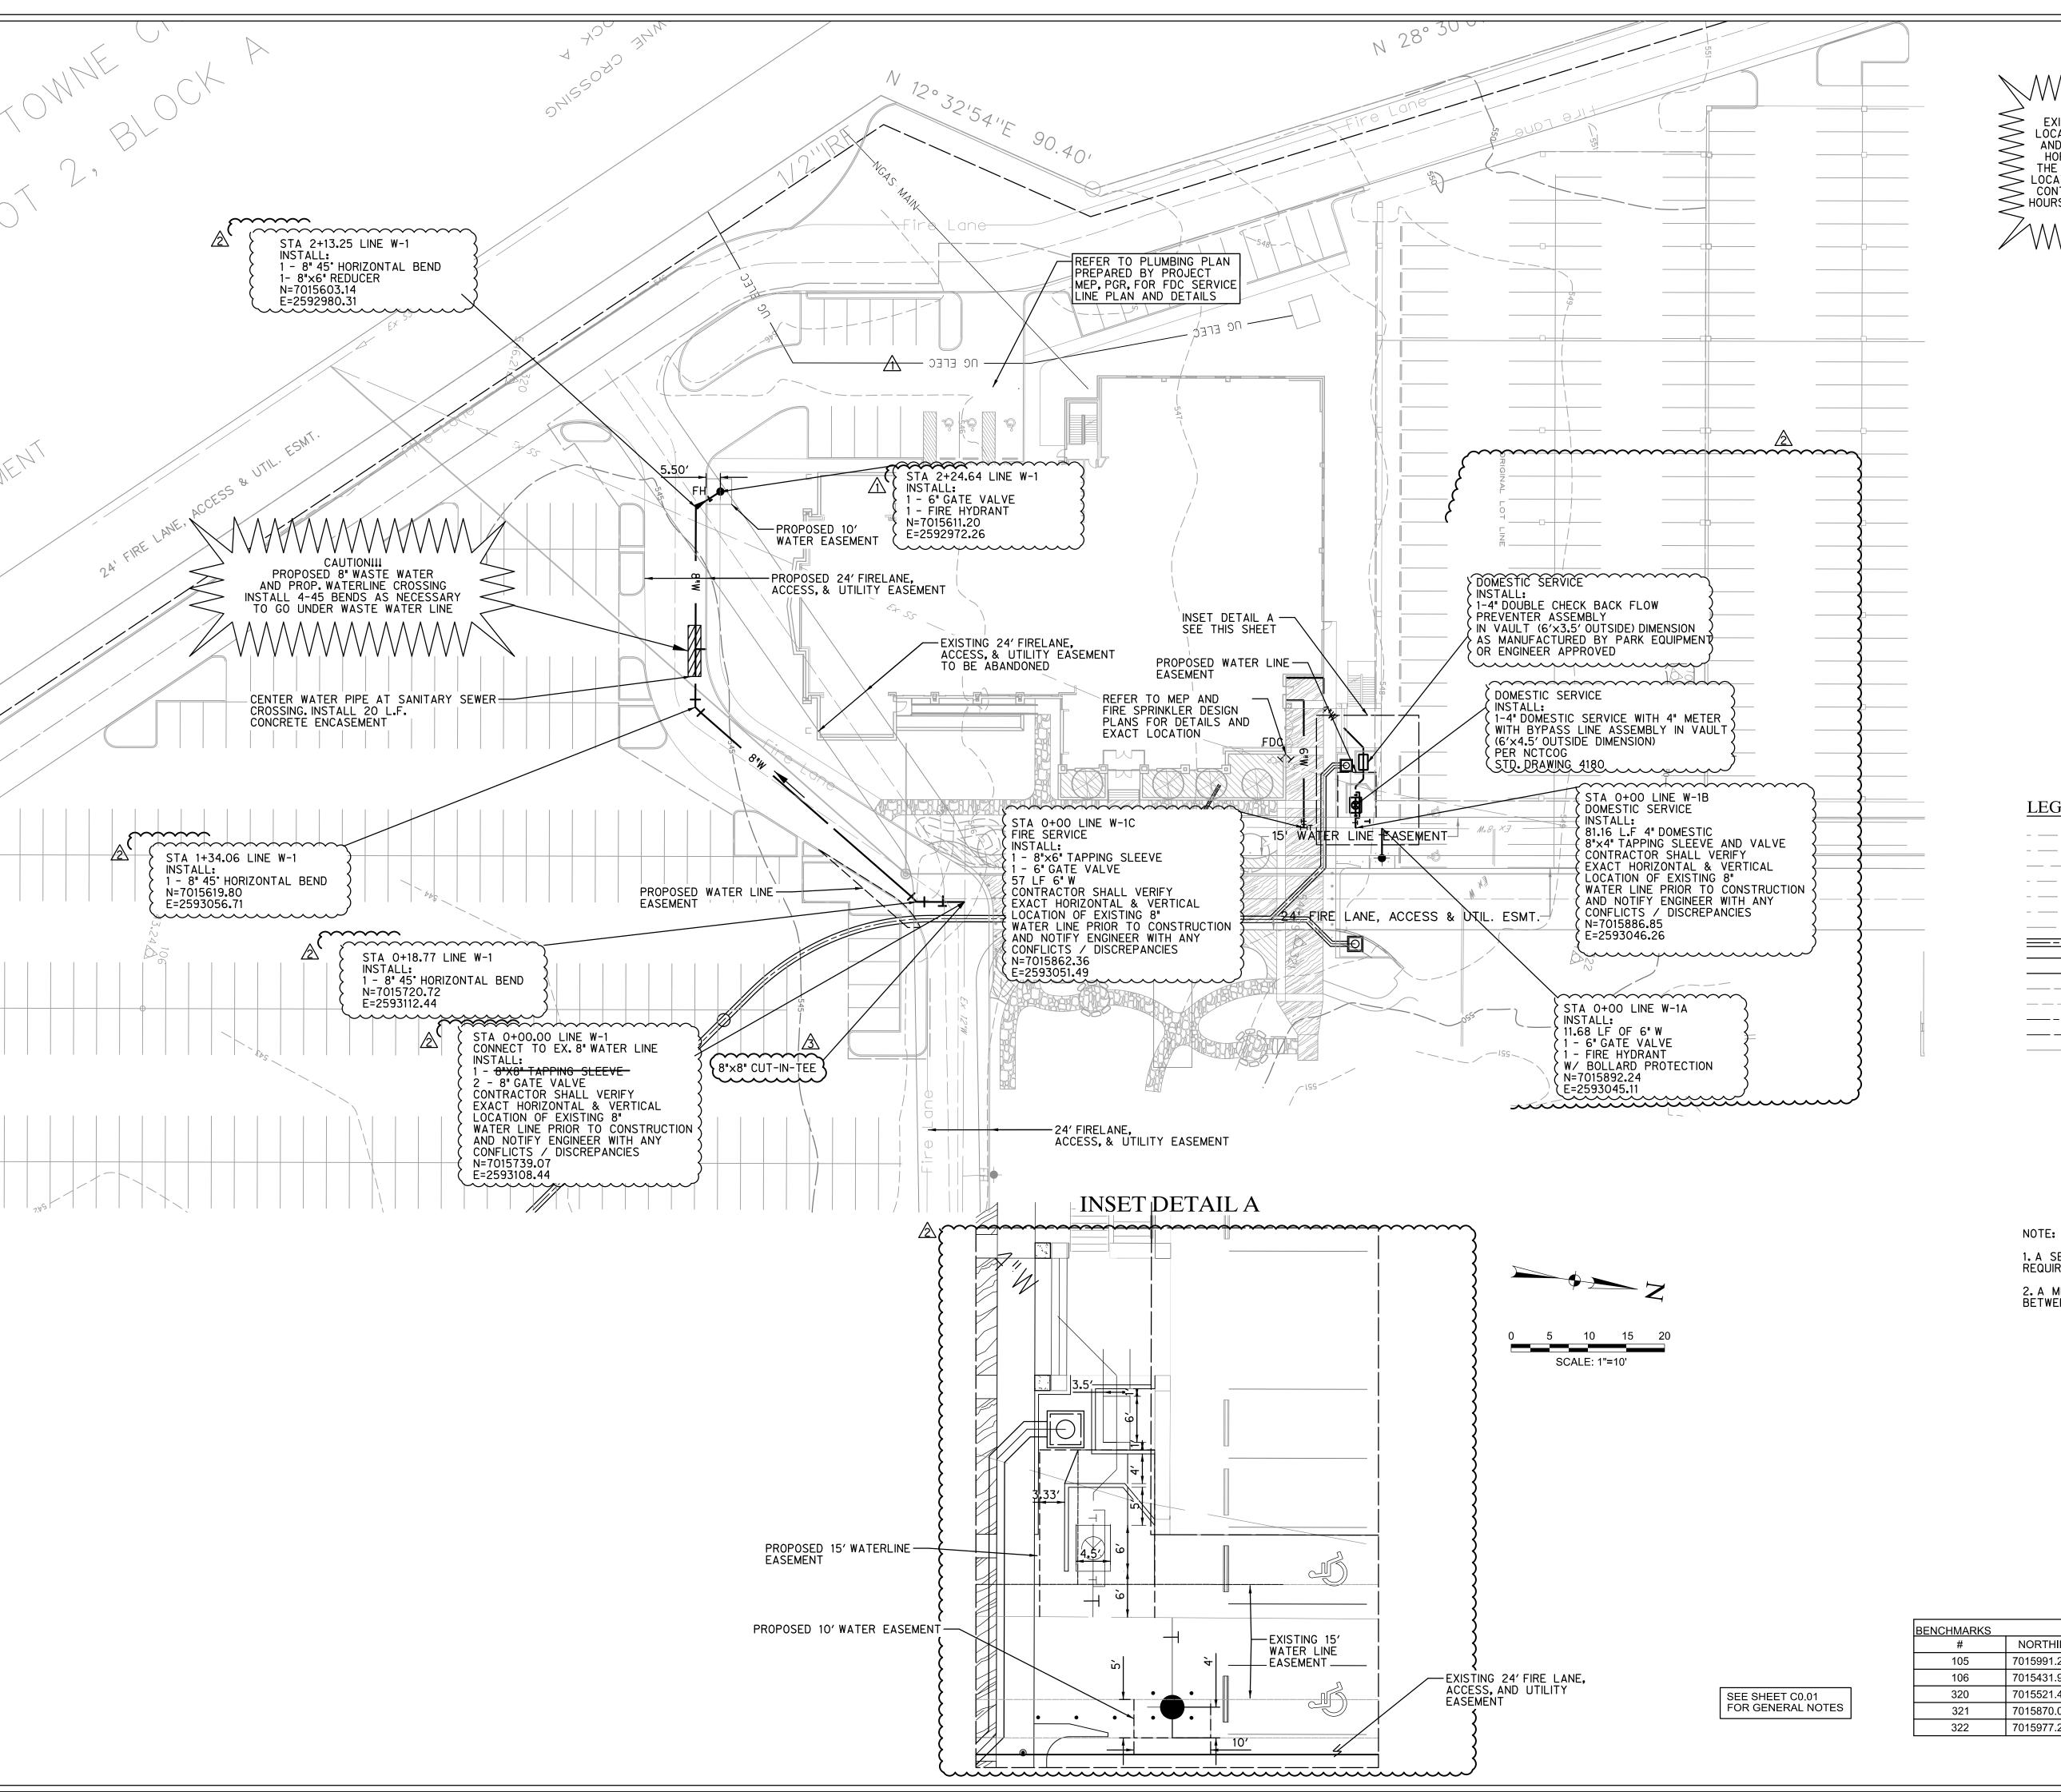

CAUTIONIII
EXISTING UTILITIES IN THE AREA. UTILITIES
LOCATION SHOWN ARE SCHEMATIC IN NATURE LOCATION SHOWN ARE SCHEMATIC IN NATURE
AND MAY NOT ACCURATELY REFLECT SIZE,
HORIZONTAL, AND/OR VERTICAL LOCATION.
THE CONTRACTOR SHALL VERIFY THE EXACT
LOCATION PRIOR TO BEGINNING CONSTRUCTION.
CONTACT AFFECTED UTILITIES AT LEAST 48
HOURS PRIOR TO CONSTRUCTION IN THIS AREA. (1-800-DIG-TESS)

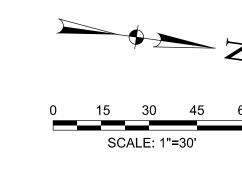

## LEGEND:

| <u></u>         |
|-----------------|
| <br>Ex W        |
| <br>Ex ·UGE — — |
| <br>Ex OHE      |
| <br>Ex. SS ->-  |
| <br>Ex ·Gas — — |
| <br>Ex · TEL    |
|                 |

MAJOR CONTOUR LINE MINOR CONTOUR LINE EXISTING MAJOR CONTOUR LINE EXISTING MINOR CONTOUR LINE PROPERTY LINE EASEMENT LINE ASPHALT

POWER POLE SANITARY SEWER MANHOLE WATER VALVE  $\bigcirc$  W  $\lor$ -**←**-FH FIRE HYDRANT ⊗ WM WATER METER

EXISTING FIBER OPTIC

EXISTING GAS LINE

EXISTING WATER LINE

STORM SEWER

EXISTING TELEPHONE LINE

EXISTING SANITARY SEWER

EXISTING OVERHEAD ELECTRIC

EXISTING UNDERGROUND ELECTRIC

1. A SEPARATE PERMIT FROM THE FIRE DEPARTMENT IS REQUIRED FOR FIRE SPRINKLER LINES.

2. A MINIMUM 10' SEPARATION DISTANCE IS REQUIRED BETWEEN FIRE SPRINKLER LINES AND ALL OTHER UTILITIES.

RECORD DRAWING TO THE BEST OF OUR KNOWLEDGE HALFF ASSOCIATES, INC. HEREBY STATES THAT THIS PLAN IS A RECORD DRAWING. THESE RECORD DRAWINGS HAVE BEEN PREPARED BASED ON INFORMATION PROVIDED BY THE GENERAL CONTRACTOR, MEDCO CONSTRUCTION L.L.C. DURING MAY 2018, FIELD OBSERVATIONS, ON 05/09/2018. AND FIELD SURVEY WORK CONDUCTED AT THE SITE. THIS INFORMATION INCLUDES MODIFICATIONS BY ADDENDA AND CHANGE ORDERS. THE ORIGINAL SEALED CONSTRUCTION DRAWINGS ARE ON FILE AT THE OFFICES HALFF ASSOCIATES, INC., TBPE FIRM #312

DANIEL W. WARFIELD, P.E. 95947 HALFF ASSOC. TBPE FIRM #312 DATE 06/11/2018

| NCHMARKS |              |              |           |             |
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| 321      | 7015870.0270 | 2593095.7245 | 548.29    | SXTP        |
| 322      | 7015977.2058 | 2593078.3578 | 549.54    | SXTP        |

# JKCH BUILDING NOL ED

| No. | S

DANIEL W. WARFIELD 95947

10-3-2017

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responsible engineer is an offense under the


Texas Engineering Practice Act. The record copy of this drawing is on file at the offices of Halff Associates, Inc., 3803 Parkwood Blvd., Frisco, Texas 75034. TBPE FIRM #F-312.

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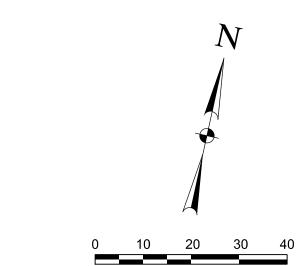
5087

Project No.: 31697 Issued: 08/01/2017 TRS Drawn By: Checked By: DWW Scale AS NOTED Sheet Title WATER PLAN

C8.01 Sheet Number

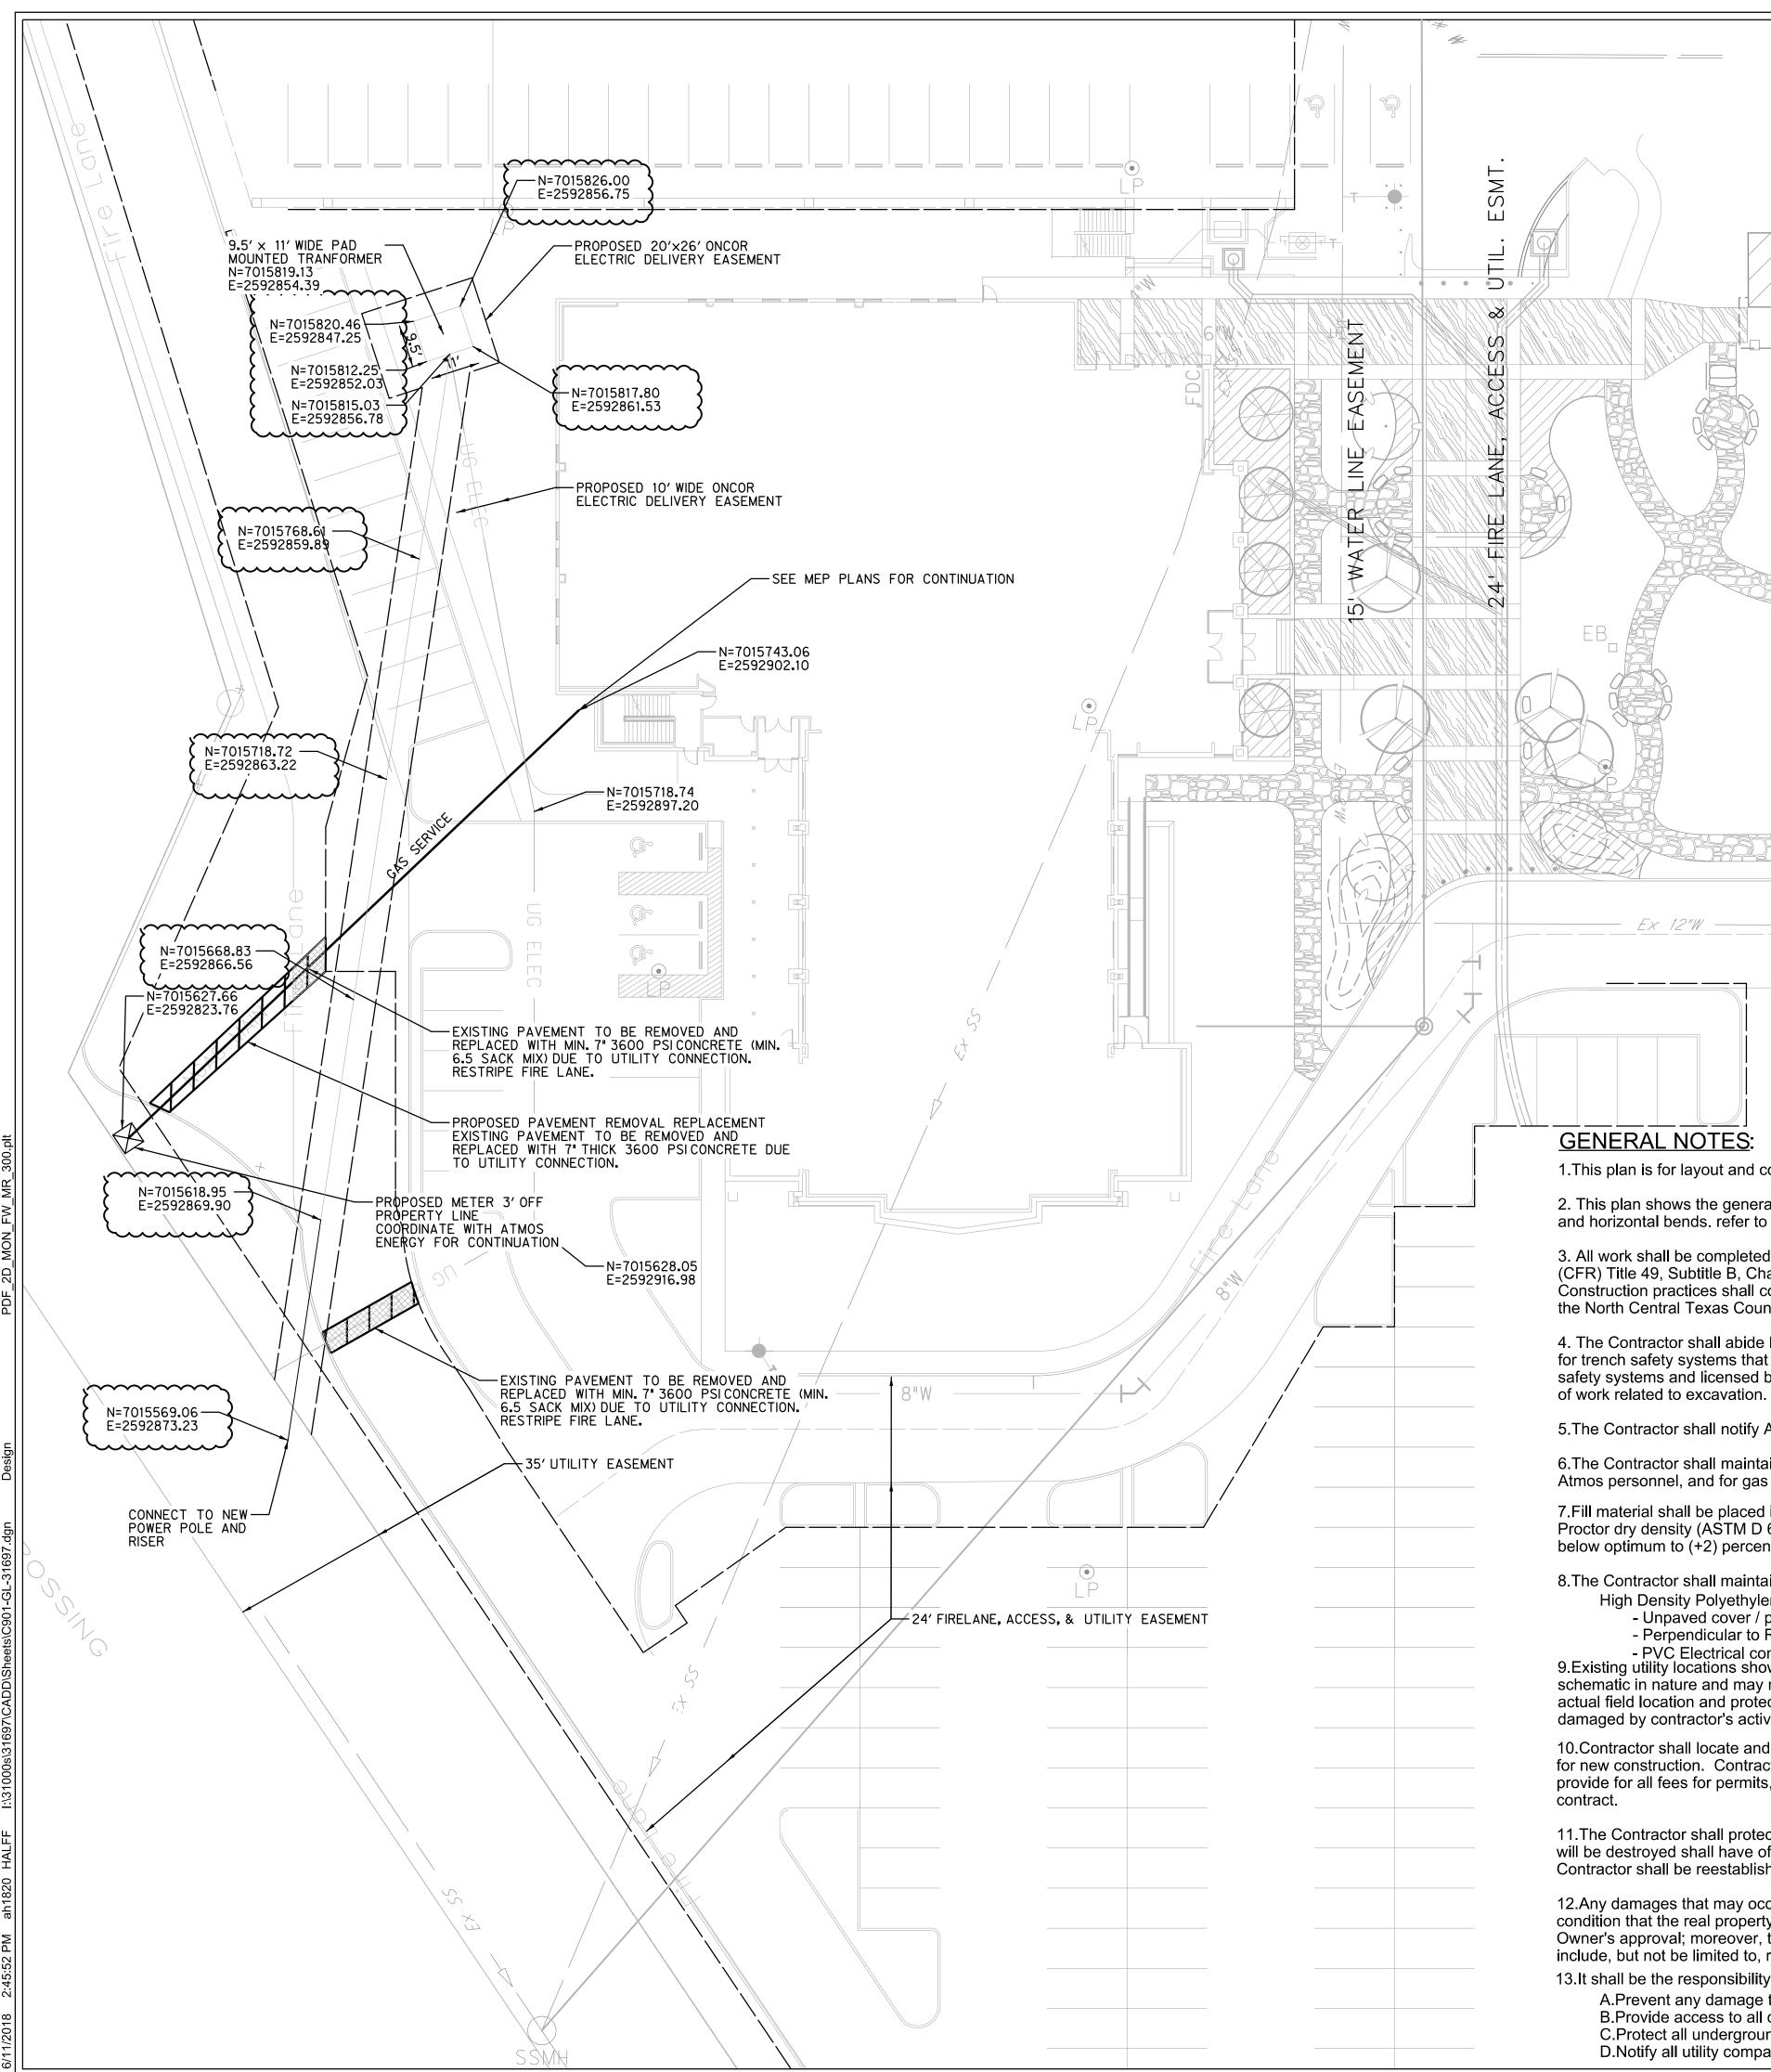

EXISTING UTILITIES IN THE AREA. UTILITIES LOCATION SHOWN ARE SCHEMATIC IN NATURE AND MAY NOT ACCURATELY REFLECT SIZE, HORIZONTAL, AND/OR VERTICAL LOCATION. THE CONTRACTOR SHALL VERIFY THE EXACT > LOCATION PRIOR TO BEGINNING CONSTRUCTION. > CONTACT AFFECTED UTILITIES AT LEAST 48 > HOURS PRIOR TO CONSTRUCTION IN THIS AREA. (1-800-DIG-TESS)



## LEGEND:

EXISTING FIBER OPTIC EXISTING TELEPHONE LINE EXISTING GAS LINE EXISTING SANITARY SEWER EXISTING OVERHEAD ELECTRIC EXISTING UNDERGROUND ELECTRIC EXISTING WATER LINE STORM SEWER

MAJOR CONTOUR LINE MINOR CONTOUR LINE EXISTING MAJOR CONTOUR LINE EXISTING MINOR CONTOUR LINE PROPERTY LINE EASEMENT LINE **ASPHALT** 

SCALE: 1"=20'

POWER POLE SANITARY SEWER MANHOLE WATER VALVE

FIRE HYDRANT WATER METER INLET PROTECTION

1. This plan is for layout and coordination purposes only. The sizing of the gas main and connection details shall be per Atmos specifications.

2. This plan shows the general horizontal and vertical locations of electrical conduits only. The contractor shall verify what radius to use at vertical and horizontal bends, refer to MEP plans for number of conduits, electrical design, conduit encasement and manhole details.

3. All work shall be completed in accordance with all applicable federal, state, and local regulations; including but not limited to the Code of Federal Regulations (CFR) Title 49, Subtitle B, Chapter I, Subchapter D, Part 192 (Transportation of Natural and Other Gas by Pipeline: Minimum Federal Safety Standards. Construction practices shall conform to the latest versions of Atmos Energy Construction Procedures Manual and Pipeline Services Engineering Standards, the North Central Texas Council of Governments (NCTCOG) Public Works Construction Standards latest version, and the City of Rockwall standards.

RECORD DRAWING

HALFF ASSOCIATES, INC. HEREBY STATES THAT THIS PLAN IS A RECORD DRAWING.

DURING MAY 2018, FIELD OBSERVATIONS ON 05/09/2018, AND FIELD SURVEY WORK CONDUCTED AT THE SITE, THIS

INFORMATION INCLUDES MODIFICATIONS

BY ADDENDA AND CHANGE ORDERS. THE ORIGINAL SEALED CONSTRUCTION DRAWINGS ARE ON FILE AT THE OFFICES

HALFF ASSOCIATES, INC., TBPE FIRM #312

TO THE BEST OF OUR KNOWLEDGE

PREPARED BASED ON INFORMATION PROVIDED BY THE GENERAL CONTRACTOR,

MEDGO CONSTRUCTION L.L.C

HALFF ASSOC. TBPE FIRM #312

DATE 06/11/2018

4. The Contractor shall abide by all applicable federal, state, and local laws governing excavation. The Contractor shall provide detailed plans and specifications for trench safety systems that comply with applicable laws governing excavation. These plans shall be sealed by an Engineer experienced in the design of trench safety systems and licensed by the State of Texas. Submit plan to the Owner prior to commencing work. The Contractor shall be solely responsible for all aspects

5. The Contractor shall notify Atmos Energy personnel at least 48 hours prior to the start of construction.

6. The Contractor shall maintain a minimum clearance of 24" from any underground obstruction, except upon approval of variance by Atmos personnel, and for gas lines and Oncor personel for electric lines.

7.Fill material shall be placed in lifts not exceeding nine (9) inches in loose thickness. Fill material shall be compacted at a minimum of 95 percent maximum standard Proctor dry density (ASTM D 698). In conjunction with the compacting operation, fill material shall be brought to a moisture content ranging from (-2) percentage points below optimum to (+2) percentage points above optimum (-2 to +2).

8. The Contractor shall maintain the minimum cover requirements to the top of pipe as specified below:

High Density Polyethylene gas pipe (i.e. HDPE or poly):

- Unpaved cover / parallel to Road Right-of-Way: 36 inches

- Perpendicular to Road Right-of-Way: 36 inches

- PVC Electrical conduit: 36 inches 9. Existing utility locations shown are taken from available records provided by the utility Owner and field locations of surface appurtenances. Locations shown are generally schematic in nature and may not accurately reflect the size and location of each particular utility. Some utility lines may not be shown. Contractor shall assume responsibility for actual field location and protection of existing facilities whether shown or not. Contractor shall also assume responsibility for repairs to existing facilities, whether shown or not, damaged by contractor's activities. Differences in horizontal or vertical location of existing utilities shall not be a basis for additional expense.

10. Contractor shall locate and adjust existing utility manhole lids, cleanouts, water valves, and other surface appurtenances as required for new construction. Contractor shall coordinate utility adjustments with other disciplines and the appropriate utility agencies and provide for all fees for permits, connections, inspections, etc. These adjustments shall be considered incidental to the construction

11. The Contractor shall protect existing property monumentation and primary control. Any such points which the Contractor believes will be destroyed shall have offset points established by the Contractor prior to construction. Any monumentation destroyed by the Contractor shall be reestablished at his expense.

12. Any damages that may occur to real property or existing improvements shall be restored by the Contractor to at least the same condition that the real property or existing improvements were in prior to the damages. This restoration shall be subject to the Owner's approval; moreover, this restoration shall not be a basis for additional compensation to the Contractor. Restoration shall include, but not be limited to, regrassing, revegetation, replacing fences, replacing trees, etc.

13.It shall be the responsibility of the Contractor to:

A.Prevent any damage to private property and property owner's poles, fences, shrubs, etc.

B. Provide access to all drives during construction. C.Protect all underground utilities to remain in service.

D.Notify all utility companies and verify location of all utilities prior to start of construction.

| CHIMARKS |              |              |           |             |
|----------|--------------|--------------|-----------|-------------|
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| 322      | 7015977.2058 | 2593078.3578 | 549.54    | SXTP        |

BUIL

 $\overline{\mathbb{Q}}$ 

ED

| 3 | 2 | 4 | No.



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Project No.: 31697 Drawn By: TRS Checked By: DWW

Scale AS NOTED Sheet Title

UTILITY PLAN

Sheet Number

C9.01

| Project: Lake Point Church Maintenance Bond Info |   |
|--------------------------------------------------|---|
| Location: Rockwall, Texas                        |   |
| Date: June 7, 2018                               |   |
| Addendum:                                        | 0 |

As Built contract quantity and unit price amounts.

We propose to provide equipment, labor and material to perform the following operations. This quote is void after thirty days from proposal date.

#### **Detail for Maintenance Bond**

|   | Item | Description             | Quantity       | Unit | Unit Cost   | Ext. Cost   |
|---|------|-------------------------|----------------|------|-------------|-------------|
| ı | 1    | 4" compound meter vault | 1              | EA   | \$17,500.00 | \$17,500.00 |
| I | 2    | 8" DR-14PVC Water Pipe  | 220            | LF   | \$28.46     | \$6,261.20  |
|   | 3    | 6" DR-14 PVC Water Pipe | 80             | LF   | \$23.33     | \$1,866.40  |
|   | 4    | 4" DR-14 PVC Water Pipe | 20             | LF   | \$19.74     | \$394.80    |
|   | 5    | fire hyd                | 2              | LF   | \$7,245.45  | \$14,490.90 |
|   | 6    | 8" valves with acc      | 1              | EA   | \$2,181.54  | \$2,181.54  |
|   | 9    | Miscellaneous           | 1              | EA   | ]           | \$0.00      |
|   |      | Subtotal Fo             | or Water Line: |      | =           | \$46 403 92 |

Approved By: Jacob Sheard

Jacob Sheard

Digitally signed by Jacob Sheard

Dis: C=US,
E=jacob.sheard@medcoconstruction.com,
O=MEDCO Construction, OU=Project
Administrator, CN=Jacob Sheard
Date: 2018.06.12 13:31:38-05'00'

Sincerely, Brenan Phelps 972-814-1428

As-Built Drawings