
ENGINEERING CONSTRUCTION PLANS FOR LAKE POINTE CHURCH

SOUTHEAST PARKING LOT EXPANSION LOT 3, BLOCK A CITY OF ROCKWALL, ROCKWALL COUNTY, TEXAS

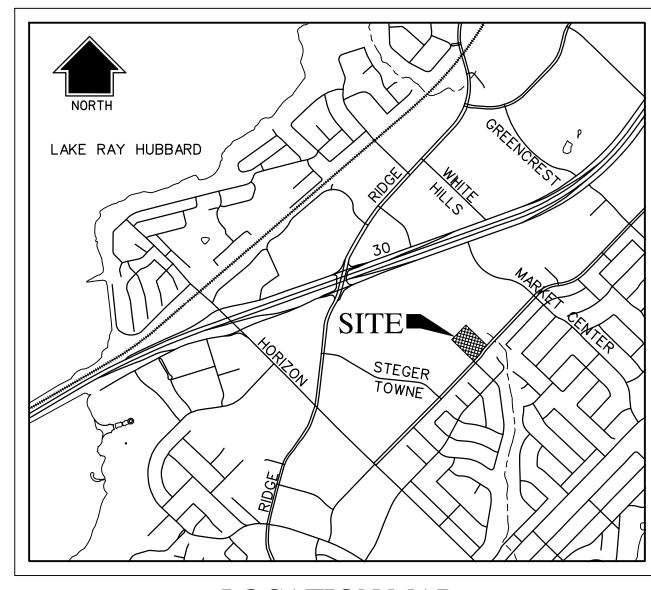

LOCATION MAP N.T.S. MAPSCO NO. 30C-G



3803 PARKWOOD BLVD., SUITE 800 FRISCO, TEXAS 75034-8640 TEL (214) 618-4570 FAX (214) 618-4574 TBPE FIRM #F-312

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	COVER SHEET
	FINAL PLAT
C0.02	GENERAL NOTES
C1.01	SITE LOCATION PLAN
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C2.02	EROSION CONTROL NOTES & DETAILS
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C3.02	PAVING DETAILS
L1.01	TREESCAPE PLAN
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L3.01	LANDSCAPE DETAILS
*C1.01	DRAINAGE AREA MAP

Revision

No. Date

NOTES:

*FOR REFERENCE ONLY FROM RECORD DRAWINGS

Description

09/30/2019 RECORD DRAWINGS

RECORD DRAWING

TO THE BEST OF OUR KNOWLEDGE
HALFF ASSOCIATES, INC. HEREBY STATES
THAT THIS PLAN IS A RECORD DRAWING.
THESE RECORD DRAWINGS HAVE BEEN
PREPARED BASED ON FIELD OBSERVATIONS
ON 09/10/2019, AND FIELD SURVEY
WORK CONDUCTED AT THE SITE. THE
ORIGINAL SEALED CONSTRUCTION
DRAWINGS ARE ON FILE AT THE OFFICES
OF:
HALFF ASSOCIATES, INC., TBPE FIRM #312
ENGINEER OF RECORD:

DANIEL W. WARFIELD P.E. 95947 HALFF ASSOC. TBPE FIRM #312 DATE 09/30/2019





The seal appearing on this document was authorized by Daniel W. Warfield, P.E. 95947 on (05/15/19). Alteration of a sealed document without proper notification to the responsible engineer is an offense under the Texas Engineering Practice Act. The record copy of this drawing is on file at the offices of Halff Associates, Inc., 3803 Parkwood Blvd., Frisco, Texas 75034. TBPE FIRM #F-312.

OWNER / DEVELOPER

LAKE POINTE CHURCH- ROCKWALL CAMPUS 701 INTERSTATE 30 ROCKWALL, TX 75087 CONTACT: JOHN WARDELL (PH) 469-698-2244 CIVIL ENGINEER

HALFF ASSOCIATES, INC. 3803 PARKWOOD BLVD., SUITE 800 FRISCO, TX 75034 TBPE FIRM #F-312 CONTACT: DAN WARFIELD, P.E. (PH) 214-618-4570

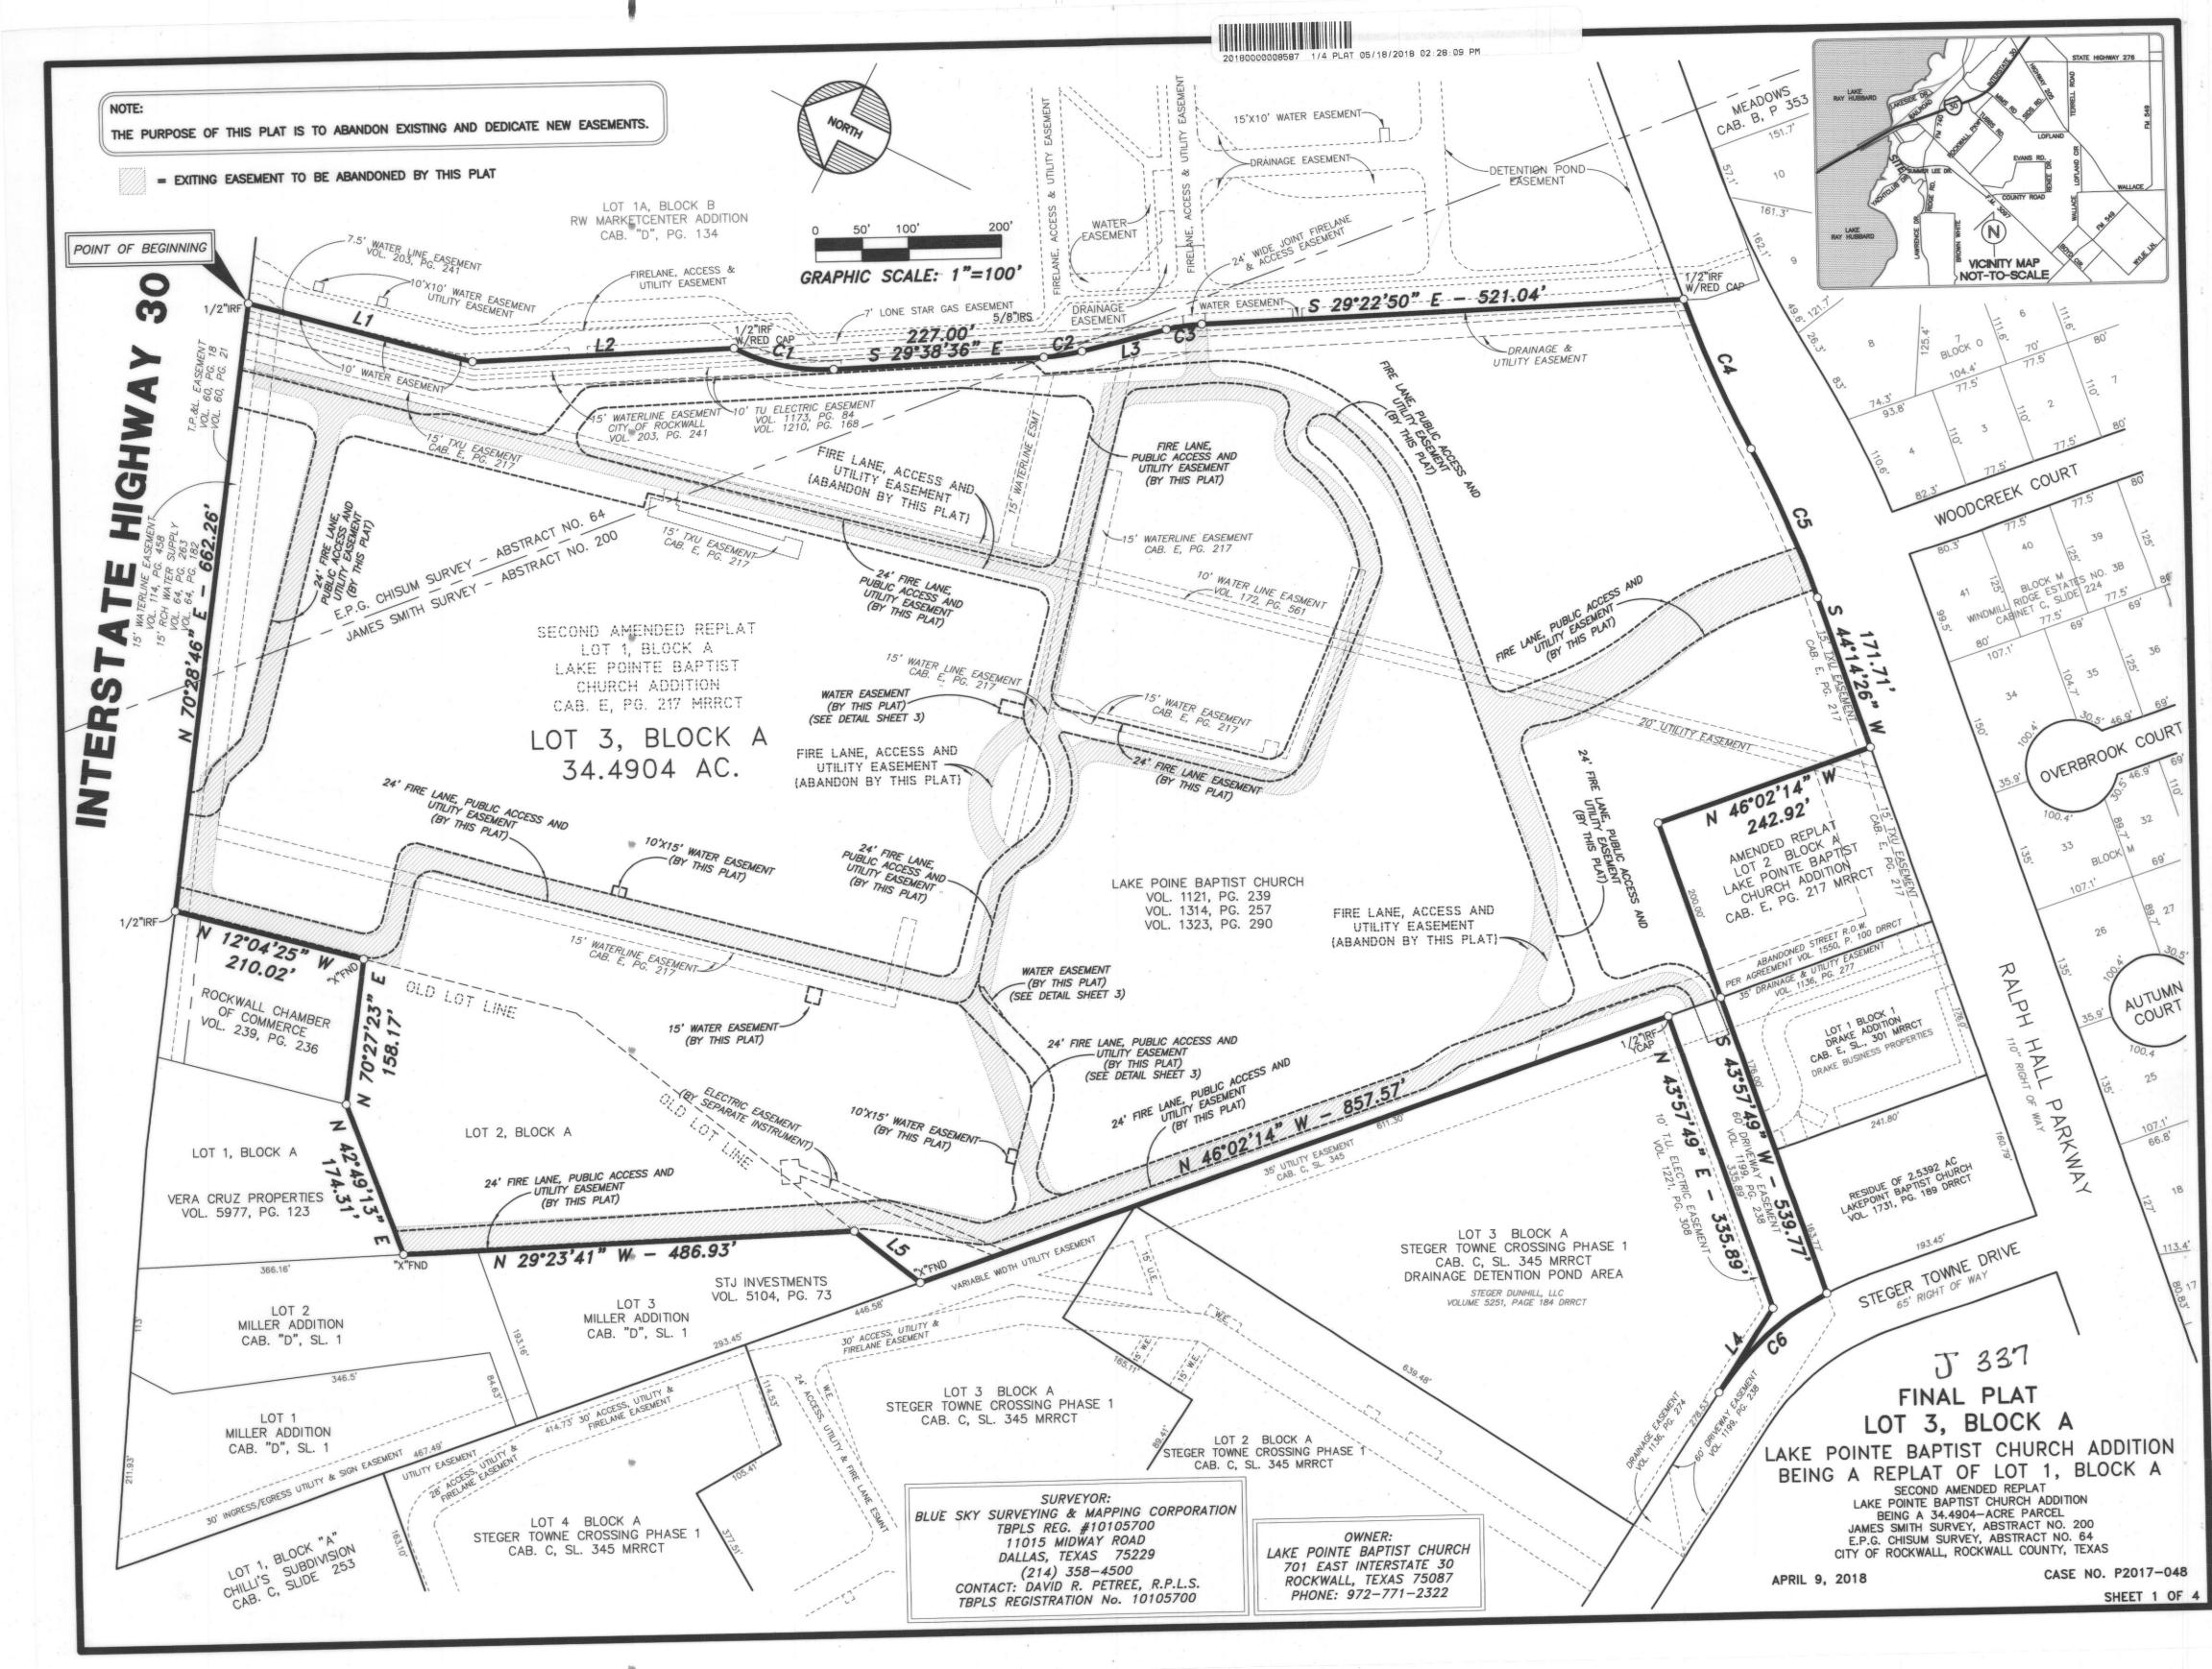

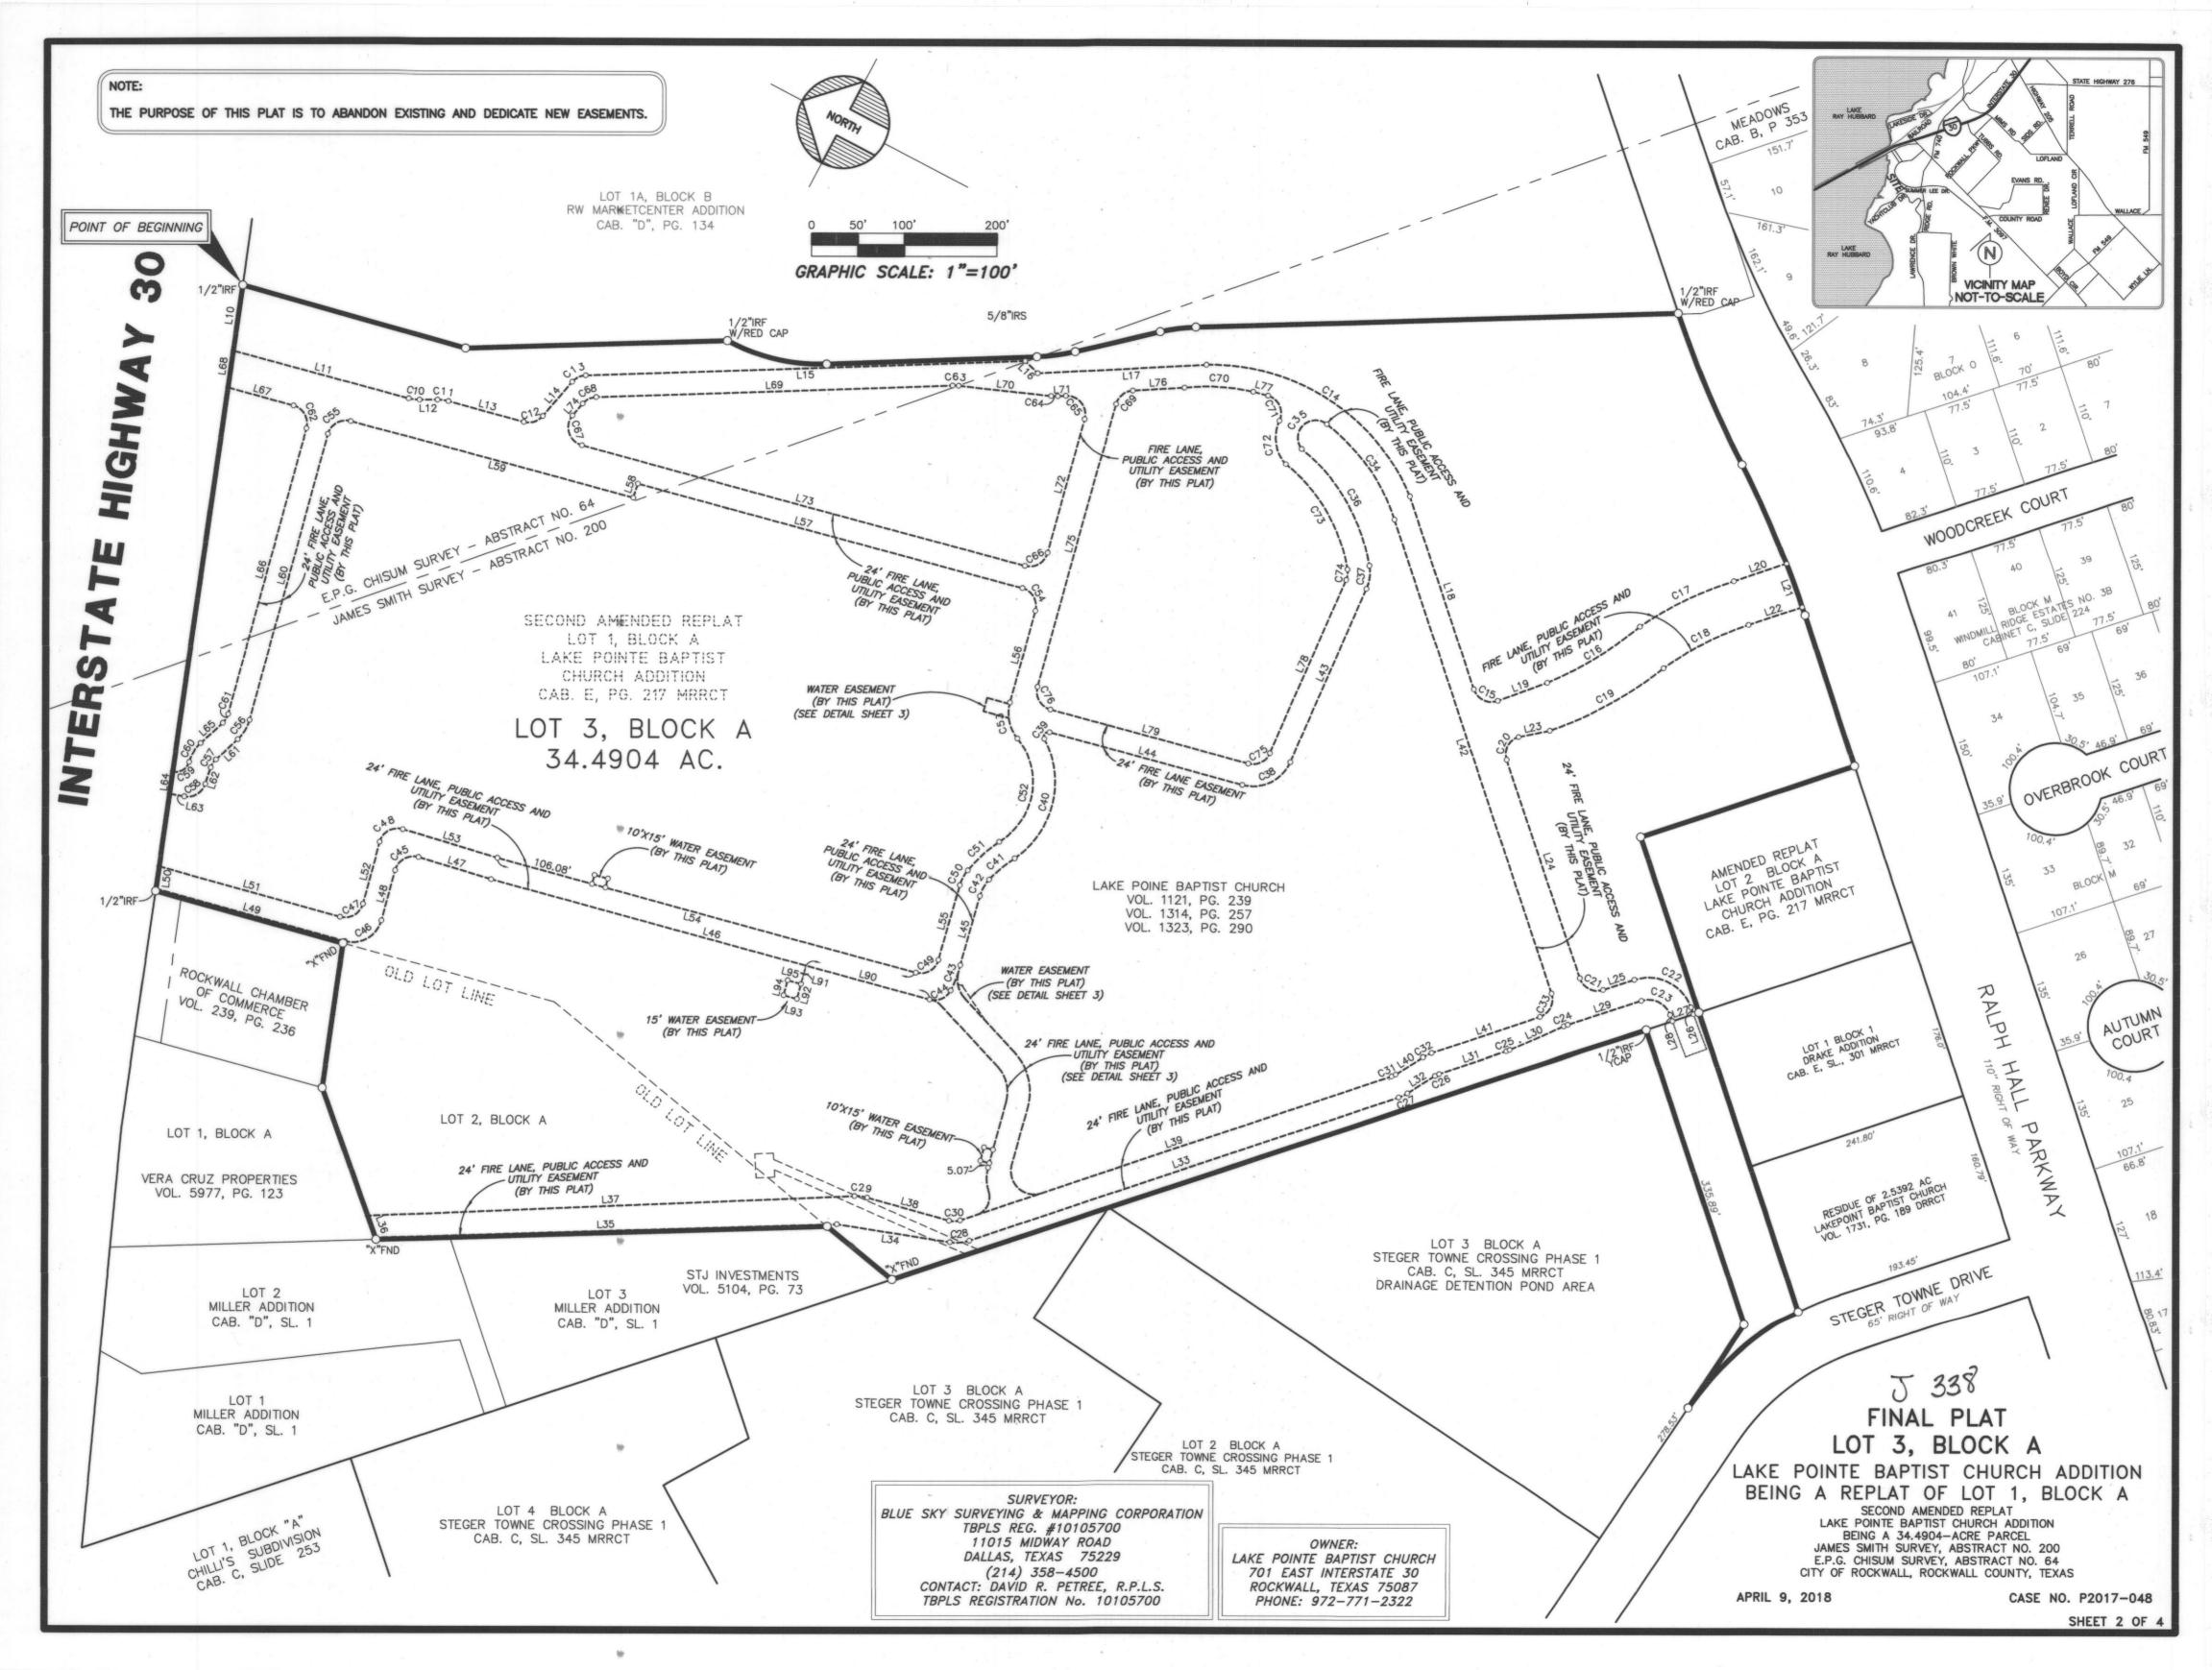

0	EASE	MENT	LINE	TABLE	~
		and the same of the same			

~ EASE	EMENT LINE	TABLE ~
NO.	BEARING	DISTANCE
L10	S70°28'46"W S12°27'15"E	72.02' 196.37'
L11	S27°42'55"E	196.37
L13	S12°16'56"E	84.59
L14	S77°24'22"E	48.77
L15	S29°36'18"E	474.52
L16	S17*01'31"W	19.00'
L17	S30°42'18"E S44°00'31"W	182.24' 219.95'
L19	S47*54'54"E	56.81
L20	S46°20'41"E	59.74
L21	S42°31'14"W	50.01
L22	N46°20'41"W	60.73
L23	N39°15'47"W S43°50'33"W	34.45° 249.48°
L24	S45°45'57"E	35.43
L26	S42°17'11"W	7.88'
L27	N46°02'14"W	24.01'
L28	N42°17'11"E	7.18'
L29	N45°45'57"W N51°42'01"W	83.33' 63.97'
L30	N46°23'26"W	76.78
L32	N59*53'58"W	35.10'
L33	N46°08'27"W	488.25'
L34	N18*33'21"W	123.63'
L35	N29°23'41"W	498.11'
L36	N42°49'13"E S30°02'27"E	25.11' 525.84'
L38	S11'51'30"E	91.71
L39	S46°08'27"E	490.80'
, L40	S59*53'58"E	35.10'
L41	S46°23'26"E	123.46'
L42 L43	N43'59'46"E S86'03'09"W	540.14' 204.57'
L43	N12°24'29"W	215.32'
L45	S78°15'32"W	77.91
L46	N12°20'35"W	490.68'
L47	N10'43'32"W	81.95'
L48 L49	S77'32'09"W N12'04'25"W	56.30° 211.77°
L50	N70°28'46"E	24.20'
L51	S12*04'25"E	202.82'
L52	N77*32'09"E	68.96'
L53	S10°43'32"E	106.35
L54	S12°20'35"E N78°15'32"E	468.27' 84.03'
L56	N77*43'40"E	102.79
L57	N12°27'15"W	429.99'
L58	S80°33'58"W	16.02'
L59	N12°27'15"W	316.11'
L60 L61	S77*34'02"W N70*08'34"W	320.98' 32.23'
L62	S80°01'01"W	18.65
L63	N16'57'12"W	16.29'
L64	N70°28'46"E	24.04
L65	S70°08'34"E	32.23'
L66	N77*34'02"E N12*27'15"W	320.96' 73.30'
L68	N70°28'46"E	40.31
L69	S29'36'18"E	384.75
L70	S21°19'01"E	100.63'
L71	S30°42'18"E	8.67'
L72	S77*43'40"W N12*27'15"W	150.28' 495.58'
L74	S77°24'22"E	16.96
L75	N77°43'40"E	317.99'
L76	S31°03'47"E	55.81'
L77	S12*58'57"E S86*03'09"W	16.54 ²
L78	N12°24'29"W	204.57
L80	S46'08'27"E	19.31
L81	N77°41'53"E	73.86
L82	N19*41'53"E	90.84
L83	S19°41'53"W	78.88'
L84 L85	S77*41'53"W N46*08'27"W	64.48' 73.37'
L86	N19*41'52"E	44.77
L87	N19'41'53"E	34.11'
L88	S12°16'27"E	4.88'
L89	S28'42'14"W	46.71'
L90	N12'20'35"W S77'33'50"W	138.26' 20.46'
L92	S77'33'50"W	16.74
L93	N12'26'10"W	15.00'
L94	N77°33'50"E	16.75
L95	S12'03'08"E	15.00'
L96	N12'16'20"W N77'43'40"E	28.44' 15.00'
198	N//43 40 E	15.00 25.18'

L98 S12'16'20"E 25.18'

~ EASEMENT CURVE TABLE ~ NO RADIUS DELTA ARC CH BEARING CHORD

					T
NO.	RADIUS	DELTA	ARC	CH. BEARING	CHORD
C10	44.00'	15°15'40"	11.72	S20°05'05"E	11.69
C11	44.00'	15*25'59"	11.85	S19'59'56"E	11.82'
C12	20.00'	65*07'25"	22.73'	S44'50'39"E	21.53
C13	20.00'	47°48'04"	16.69	S53'30'20"E	16.21
C14	230.52	69*20'46"	279.01	S05'23'15"W	262.29
	20.00'	91°55'24"	32.09	S01°57'11"E	28.76
C15					
C16	394.06	17'04'12"	117.40'	S58*59'07"E	116.97
C17	366.93	17'40'37"	113.20'	S53°34'10"E	112.76
C18	332.28'	17°53'01"	103.71	N54'41'18"W	103.29
C19	407.45	19'44'32"	140.39	N56°23'43"W	139.70
C20	19.69'	90°16'24"	31.02'	N89*38'56"W	27.91
C21	20.00'	89°36'30"	31.28	S00°57'42"E	28.19
C22	49.00'	88.03,08,	75.30'	S01'44'23"E	68.11
C23	25.00'	88.03,08,	38.42'	N01°44'23"W	34.75
C24	44.00'	5*56'03"	4.56'	N48'43'59"W	4.56
C25	44.00'	5'18'35"	4.08'	N49°02'43"W	4.08'
C26	20.00'	13'30'32"	4.72'	N53°08'42"W	4.70
C27	44.00'	13°45'30"	10.57	N53'01'12"W	10.54
C28	44.00'	27°35'06"	⇒ 21.18'	N32°20'54"W	20.98
					+
C29	44.00'	18*10'57"	13.96'	S20'56'58"E	13.90'
C30	20.00'	34'16'57"	11.97	S28'59'59"E	11.79
C31	20.00'	13'45'30"	4.80'	S53°01'12"E	4.79
C32	44.00'	13°30'32"	10.37'	S53'08'42"E	10.35
C33	20.00'	89'46'01"	31.33'	N88°43'34"E	28.23
C34	211.45	34'55'02"	128.86'	N27°12'04"E	126.88
C35	19.14	166°46'26"	55.72	N71°48'46"W	38.03
C36	210.95	40°45'42"	150.07	S32*22'05"W	146.93
C37	44.00'	33'18'13"	25.58	S69°24'02"W	25.22
C38	44.00'	81'32'22"	62.62'	N53*10'40"W	57.47
C39	5.00'	133°21'55"	11.64'	N79°05'26"W	9.18'
C40	99.55'	83'56'49"	145.86	S76°12'01"W	133.16
C41	133.94'	15*23'00"	35.96	N67°18'07"W	35.85
C42	44.00'	26'44'51"	20.54	N88*22'03"W	20.35
C43	96.69	17'18'49"	29.22'	N82°33'30"E	29.11
C44	20.00'	76°26'31"	26.68	N50°33'50"W	24.75
C45	20.00'	91'44'19"	32.02	N56°35'41"W	28.71
C46	32.00'	90°23'25"	50.48'	N57*16'08"W	45.41
C47	20.00'	90'23'25"	31.55	S57°16'08"E	28.38
C48	20.00'	91'44'19"	32.02'	S56°35'41"E	28.71
	20.00'	89°23'53"	31.21'	S57°02'32"E	28.14
C49					
C50	44.00'	23°43'04"	18.21'	S89*52'56"E	18.08
C51	157.94	16'42'37"	46.06	S69°40'06"E	45.90'
C52	75.55	97*24'28"	128.45	N72'19'32"E	113.53
C53	44.00'	54'06'21"	41.55	N50°40'29"E	40.02
C54	20.00'	90°10'55"	31.48'	N32°38'12"E	28.33
C55	20.00'	89*58'42"	31.41	N57°26'36"W	28.28
		32°17'23"		N86°17'16"W	24.47
C56	44.00'		24.80'		
C57	20.00'	29°50'25"	10.42'	N85°03'47"W	10.30
C58	20.00'	83*01'47"	28.98'	N58'28'06"W	26.51
C59	15.00'	87*00'08"	22.78	S58°15'27"E	20.65
C60	44.00'	31°36'57"	24.28'	S85*57'03"E	23.97
C61	20.00'	32°17'23"	11.27'	S86°17'16"E	11.12'
C62	20.00'	90°01'18"	31.42'	N32*33'24"E	28.29
		8'17'16"	6.36'	S25°27'40"E	
C63	44.00'				6.36'
C64	44.00'	9°23'16"	7.21'	S26°00'40"E	7.20'
C65	20.00'	108*25'58"	37.85	S23°30'41"W	32.45
C66	20.00'	89°49'05"	31.35'	N57°21'48"W	28.24
C67	20.00'	115'02'53"	40.16'	N45'04'12"E	33.74
C68	20.00'	47°48'04"	16.69'	S53*30'20"E	16.21
C69	20.00	71°12'33"	24.86'	S66'40'03"E	23.29
					_
C70	228.59'	18'44'25"	74.77'	S24°25'35"E	74.43
C71	20.01	97'03'32"	33.90'	S37'38'09"W	29.99
C72	43.14	67°44'04"	51.00'	S54°16'34"W	48.09
C73	186.95	41°23'50"	135.07	S32°03'01"W	132.16
C74	20.00'	33'18'13"	11.63'	S69°24'03"W	11.46
C75	20.00'	81'32'22"	28.46'	N53*10'40"W	26.12
C76	20.00'	90.08,09,	31.46'	N32*39'36"E	28.32
	20.00	90.00,00,	31.42	N88*51'33"E	28.28
C77					
C78	44.00'	33'50'20"	25.99'	N60°46'43"E	25.61
C79	40.00'	58°00'00"	40.49	N48'41'53"E	38.78
C80	20.00'	31'40'23"	11.06	N03°51'41"E	10.92
C81	20.00'	68'19'08"	23.85	S54°37'31"E	22.46
C82	96.69'	12°14'10"	20.65	N85°05'49"E	20.61
		56°22'12"	29.52	S47°52'58"W	28.34
C83	30.00'				
C84	64.00'	58'00'00"	64.79	S48*41'53"W	62.06
C85	25.00'	123°50'20"	54.03'	S15°46'43"W	44.11
C86	30.00'	32°36'26"	17.07	N36°00'06"E	16.84
C87	44.00'	31'47'26"	24.41'	S39°31'02"W	24.10
C88	44.00'	20°05'31"	15.43'	S65°27'30"W	15.35
			15.43		
C89	44.00'	2'13'24"	I⊕ 1./1	S76°36'58"W	1.71


C89 44.00' 2'13'24" 1.71' S76'36'58"W 1.71'


~ BOUNDARY LINE TABLE ~


	NO.	BEARING	DISTANCE
	L1	S 11°47'11" E	249.84'
	L2	S 29°22'50" E	282.69'
	L3	S 41°04'08" E	94.02'
	L4	S 83'42'50" E	108.03
1	L5	N 11'47'11" E	90.49'
·		-	

~ BOUNDARY CURVE TABLE ~

NO.	RADIUS	DELTA	ARC	CH. BEARING	CHORD
C1	210.00	30°23'51"	111.41	S 14°26'40" E	110.11
C2	210.00'	11°25'32"	41.88	S 35°21'22" E	41.81'
СЗ	190.00'	11'41'18"	38.76	S 35°13'29" E	38.69'
C4	1250.00'	08*10'23"	178.31	S 39°29'51" W	178.16
C5	1150.00'	08*49'46"	177.22	S 39°49'33" W	177.04
C6	315.00'	29*05'23"	159.93'	N 69'09'56" W	158.22'

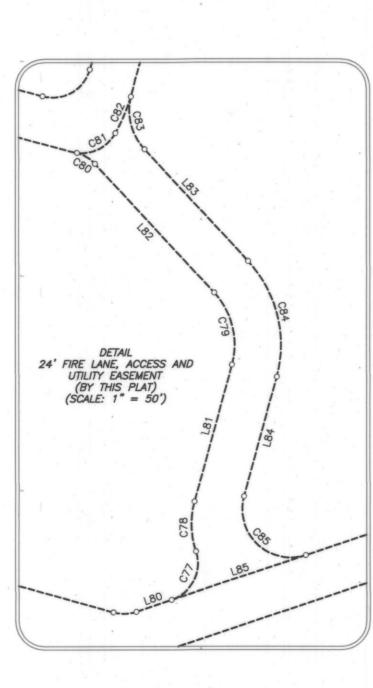

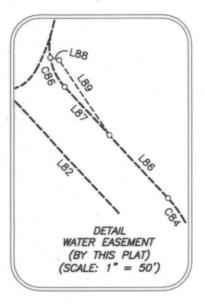

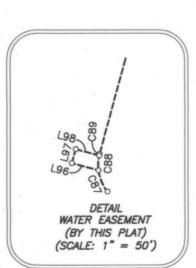

SURVEYOR:
BLUE SKY SURVEYING & MAPPING CORPORATION
TBPLS REG. #10105700
11015 MIDWAY ROAD DALLAS, TEXAS 75229 (214) 358-4500 CONTACT: DAVID R. PETREE, R.P.L.S. TBPLS REGISTRATION No. 10105700

OWNER: LAKE POINTE BAPTIST CHURCH 701 EAST INTERSTATE 30 ROCKWALL, TEXAS 75087 PHONE: 972-771-2322

THE PURPOSE OF THIS PLAT IS TO ABANDON EXISTING AND DEDICATE NEW EASEMENTS.

J 339 FINAL PLAT LOT 3, BLOCK A

LAKE POINTE BAPTIST CHURCH ADDITION

BEING A REPLAT OF LOT 1, BLOCK A

SECOND AMENDED REPLAT

LAKE POINTE BAPTIST CHURCH ADDITION

BEING A 34.4904—ACRE PARCEL

JAMES SMITH SURVEY, ABSTRACT NO. 200

E.P.G. CHISUM SURVEY, ABSTRACT NO. 64

CITY OF ROCKWALL, ROCKWALL COUNTY, TEXAS

APRIL 9, 2018

CASE NO. P2017-048

SHEET 3 OF 4

OWNER'S CERTIFICATE

STATE OF TEXAS
COUNTY OF ROCKWALL

WHEREAS, LAKEPOINTE BAPTIST CHURCH IS THE OWNER OF ALL THAT CERTAIN LOT, TRACT OR PARCEL OF LAND SITUATED IN THE E.P. GAINES CHISUM SURVEY, ABSTRACT NO. 64 AND THE JAMES SMITH SURVEY, ABSTRACT NO. 200 IN THE CITY OF ROCKWALL, ROCKWALL COUNTY, TEXAS, AND BEING ALL OF LOT 1 IN BLOCK A OF SECOND AMENDED REPLAT OF LOT 1 IN BLOCK A OF LAKE POINT BAPTIST CHURCH ADDITION, AN ADDITION TO THE CITY OF ROCKWALL, TEXAS ACCORDING TO THE PLAT THEREOF RECORDED IN CABINET E, SLIDE 217 OF THE PLAT RECORDS OF ROCKWALL COUNTY, TEXAS, AND BEING ALL OF THOSE TRACTS OF LAND AS DESCRIBED IN WARRANTY DEED TO THE CHURCH ON THE ROCK AS RECORDED IN VOLUME 286, PAGE 11 AND VOLUME 248, PAGE 323 OF THE DEED RECORDS OF ROCKWALL COUNTY, TEXAS, AND BEING MORE PARTICULARLY DESCRIBED BY METES AND BOUNDS AS FOLLOWS:

BEGINNING AT A 1/2" IRON ROD FOUND FOR CORNER IN THE SOUTH RIGHT-OF-WAY LINE OF INTERSTATE HIGHWAY 30, SAID POINT BEING THE NORTHEAST CORNER OF SAID LOT 1 IN BLOCK A;

THENCE FOLLOWING ALONG THE EAST LINE OF SAID LOT IN BLOCK A OF LAKE POINT BAPTIST CHURCH ADDITION AND THE WEST LINE OF SAID LOT 1A IN BLOCK B OF RW MARKETCENTER ADDITION THE FOLLOWING COURSES AND DISTANCES NUMBERED (1) THROUGH (8);

1. SOUTH 11' 47' 11" EAST FOR A DISTANCE OF 249.84 FEET TO A POINT FOR CORNER;

2. SOUTH 29° 22' 50" EAST FOR A DISTANCE OF 282.69 FEET TO A 1/2" IRON ROD WITH RED CAP FOUND FOR CORNER, SAID POINT BEING THE BEGINNING OF A CURVE TO THE LEFT HAVING A RADIUS OF 210.00 FEET WITH A CENTRAL ANGLE OF 30° 23' 51" AND A CHORD BEARING SOUTH 14° 26' 40" EAST AT A DISTANCE OF 110.11 FEET;

3. SOUTHEASTERLY AND FOLLOWING ALONG SAID CURVE TO THE LEFT FOR AN ARC DISTANCE OF 111.41 FEET TO A POINT FOR CORNER.

4. SOUTH 29° 38' 36" EAST FOR A DISTANCE OF 227.00 FEET TO A POINT FOR CORNER, SAID POINT BEING THE BEGINNING OF A CURVE TO THE LEFT HAVING A RADIUS OF 210.00 FEET WITH A CENTRAL ANGLE OF 11° 25' 32" AND A CHORD BEARING SOUTH 35° 21' 22" EAST AT A DISTANCE OF 41.81 FEET;

5. SOUTHEASTERLY AND FOLLOWING ALONG SAID CURVE TO THE LEFT FOR AN ARC DISTANCE OF 41.88 FEET TO A POINT FOR CORNER:

6. SOUTH 41° 04' 08" EAST FOR A DISTANCE OF 94.02 FEET TO A POINT FOR CORNER, SAID POINT BEING THE BEGINNING OF A CURVE TO THE RIGHT HAVING A RADIUS OF 190.00 FEET WITH A CENTRAL ANGLE OF 11° 41' 18" AND A CHORD BEARING SOUTH 35° 13' 29" EAST AT A DISTANCE OF 38.69 FEET;

7. SOUTHEASTERLY AND FOLLOWING ALONG SAID CURVE TO THE RIGHT FOR AN ARC DISTANCE OF 38.76 FEET TO A POINT FOR CORNER:

8. SOUTH 29° 22' 50" EAST FOR A DISTANCE OF 521.04 FEET TO A 1/2" IRON ROD WITH RED CAP FOUND FOR CORNER, SAID POINT BEING THE SOUTHEASTERLY CORNER OF AFORESAID LOT 1 IN BLOCK A OF LAKEPOINTE BAPTIST CHURCH ADDITION AND BEING IN THE NORTHWEST RIGHT-OF-WAY LINE OF RALPH HALL PARKWAY (110' RIGHT-OF-WAY), SAID POINT ALSO BEING THE SOUTHWEST CORNER OF AFORESAID LOT 1A IN BLOCK B OF RW MARKETCENTER ADDITION, SAID POINT BEING THE BEGINNING OF A CURVE TO THE LEFT HAVING A RADIUS OF 1250.00 FEET WITH A CENTRAL ANGLE OF 08' 10' 23" AND A CHORD BEARING SOUTH 39° 29' 51" WEST AT A DISTANCE OF 178.16 FEET;

THENCE SOUTHWESTERLY AND FOLLOWING ALONG SAID CURVE TO THE LEFT AND ALONG THE NORTHWEST RIGHT-OF-WAY LINE OF SAID RALPH HALL PARKWAY FOR AN ARC DISTANCE OF 178.31 FEET TO A POINT FOR CORNER, SAID POINT BEING THE BEGINNING OF A CURVE TO THE RIGHT HAVING A RADIUS OF 1150.00 FEET WITH A CENTRAL ANGLE OF 08' 49' 46" AND A CHORD BEARING SOUTH 39' 49' 33" WEST AT A DISTANCE OF 177.04 FEET;

THENCE SOUTHWESTERLY AND FOLLOWING ALONG SAID CURVE TO THE RIGHT AND ALONG THE NORTHWEST RIGHT-OF-WAY LINE OF SAID RALPH HALL PARKWAY FOR AN ARC DISTANCE OF 177.22 FEET TO A POINT FOR CORNER;

THENCE SOUTH 44° 14' 26" WEST AND CONTINUING ALONG THE NORTHWEST RIGHT-OF-WAY LINE OF SAID RALPH HALL PARKWAY FOR A DISTANCE OF 171.71 FEET TO A POINT FOR CORNER, SAID POINT BEING THE EASTERLY CORNER OF LOT 2 IN BLOCK A OF AMENDED REPLAT OF LAKE POINTE BAPTIST CHURCH ADDITION, AN ADDITION TO THE CITY OF ROCKWALL, TEXAS ACCORDING TO THE PLAT THEREOF RECORDED IN CABINET E, SLIDE 217 OF THE PLAT RECORDS OF ROCKWALL COUNTY, TEXAS;

THENCE NORTH 46' 02' 14" WEST AND DEPARTING THE NORTHWEST RIGHT-OF-WAY LINE OF SAID RALPH HALL PARKWAY AND ALONG THE COMMON LINE OF AFORESAID LOTS 1 AND 2 IN BLOCK A OF LAKEPOINTE BAPTIST CHURCH ADDITION FOR A DISTANCE OF 242.92 FEET TO A POINT FOR CORNER;

THENCE SOUTH 43° 57' 49" WEST ALONG THE COMMON LINE OF AFORESAID LOTS 1 AND 2 IN BLOCK A OF LAKEPOINTE BAPTIST CHURCH ADDITION AND PASSING THE WESTERLY CORNER OF SAID LOT 2 AND THE NORTHERLY CORNER OF LOT 1 IN BLOCK 1 OF DRAKE ADDITION, AN ADDITION TO THE CITY OF ROCKWALL, ROCKWALL COUNTY, TEXAS ACCORDING TO THE PLAT THEREOF RECORDED IN CABINET E, SLIDE 301 OF THE MAP RECORDS OF ROCKWALL COUNTY, TEXAS AND ALONG THE SOUTHEASTERLY LINE OF A 60' DRIVEWAY EASEMENT FOR A DISTANCE OF 539.77 FEET TO A POINT FOR CORNER IN THE NORTHEAST RIGHT—OF—WAY LINE OF STEGER TOWNE DRIVE (65' RIGHT—OF—WAY), SAID POINT BEING THE BEGINNING OF A CURVE TO THE RIGHT HAVING A RADIUS OF 315.00 FEET WITH A CENTRAL ANGLE OF 29' 05' 23" AND A CHORD BEARING NORTH 69' 09' 56" WEST AT A DISTANCE OF 158.22 FEET;

THENCE NORTHWESTERLY ALONG THE NORTHEAST RIGHT-OF-WAY LINE OF SAID STEGER TOWNE DRIVE FOR AN ARC DISTANCE OF 159.93 FEET TO A POINT FOR CORNER, SAID POINT BEING IN THE SOUTH LINE OF LOT 3 IN BLOCK A OF STEGER TOWNE CROSSING PHASE 1, AN ADDITION TO THE CITY OF ROCKWALL, ROCKWALL COUNTY, TEXAS ACCORDING THE THE PLAT THEREOF RECORDED IN CABINET "C", SLIDE 345 OF THE MAP RECORDS OF ROCKWALL COUNTY, TEXAS, SAID POINT ALSO BEING IN THE SOUTH LINE OF A TRACT OF LAND DESCRIBED IN DEED TO STEGER DUNHILL, LLC AS RECORDED IN VOLUME 5251, PAGE 184 OF THE DEED RECORDS OF ROCKWALL COUNTY, TEXAS;

THENCE SOUTH 83' 42' 50" EAST ALONG THE SOUTH LINE OF SAID LOT 3 IN BLOCK A OF STEGER TOWNE CROSSING PHASE I AND THE COMMON NORTH LINE OF SAID 60' DRIVEWAY EASEMENT FOR A DISTANCE OF 108.03 FEET TO A POINT FOR CORNER;

THENCE NORTH 43° 57' 49" EAST ALONG THE EASTERLY LINE OF SAID LOT 3 IN BLOCK A OF STEGER TOWNE CROSSING PHASE I AND THE COMMON NORTH LINE OF SAID 60' DRIVEWAY EASEMENT FOR A DISTANCE OF 335.89 FEET TO A 1/2" IRON ROD FOUND FOR CORNER, SAID POINT BEING THE EASTERLY CORNER OF SAID LOT 3 IN BLOCK A OF STEGER TOWNE CROSSING PHASE I ADDITION AND BEING IN THE WESTERLY LINE OF LOT 1 IN BLOCK A OF LAKE POINTE BAPTIST ADDITION;

THENCE NORTH 46° 02' 14" WEST ALONG THE WESTERLY LINE OF SAID LOT 1 IN BLOCK A OF LAKE POINTE BAPTIST ADDITION AND THE NORTHEASTERLY LINE OF SAID LOT 3 IN BLOCK A OF STEGER TOWNE CROSSING PHASE 1 FOR A DISTANCE OF 857.57 FEET TO AN "X" CUT IN CONCRETE FOUND FOR CORNER, SAID POINT BEING THE MOST SOUTHERLY SOUTHEAST CORNER OF LOT 3 OF MILLER ADDITION, AN ADDITION TO THE CITY OF ROCKWALL, ROCKWALL COUNTY, TEXAS ACCORDING TO THE PLAT THEREOF RECORDED IN CABINET D, SLIDE 1 OF THE PLAT RECORDS OF ROCKWALL COUNTY, TEXAS;

THENCE NORTH 11' 47' 11" EAST ALONG THE COMMON LINE OF SAID LOT 3 OF MILLER ADDITION AND SAID LOT 1 IN BLOCK A OF LAKE POINTE BAPTIST ADDITION FOR A DISTANCE OF 90.49 FEET TO A POINT FOR CORNER;

THENCE NORTH 29° 23' 41" WEST ALONG THE EASTERLY LINE OF SAID MILLER ADDITION AND THE WEST LINE OF SAID LOT 1 IN BLOCK A OF LAKE POINTE BAPTIST ADDITION FOR A DISTANCE OF 486.93 FEET TO AN "X" CUT IN CONCRETE FOUND FOR CORNER, SAID POINT BEING IN THE EAST LINE OF LOT 2 OF SAID MILLER ADDITION, SAID POINT ALSO BEING THE SOUTHERLY CORNER OF A TRACT OF LAND DESCRIBED IN DEED TO VERA CRUZ PROPERTIES AS RECORDED IN VOLUME 5977, PAGE 123 OF THE DEED RECORDS OF ROCKWALL COUNTY. TEXAS:

THENCE NORTH 42° 49' 13" EAST ALONG THE SOUTH LINE OF SAID VERA CRUZ TRACT FOR A DISTANCE OF 174.31 FEET TO A POINT FOR CORNER, SAID POINT BEING THE SOUTHEAST CORNER OF SAID VERA CRUZ TRACT AND THE SOUTHWEST CORNER OF A TRACT OF LAND DESCRIBED IN DEED TO ROCKWALL CHAMBER OF COMMERCE AS RECORDED IN VOLUME 239, PAGE 236 OF THE DEED RECORDS OF ROCKWALL COUNTY, TEXAS;

THENCE NORTH 70° 27' 23" EAST ALONG THE SOUTH LINE OF SAID ROCKWALL CHAMBER OF COMMERCE FOR A DISTANCE OF 158.17 FEET TO AN "X" CUT IN CONCRETE FOUND FOR CORNER;

THENCE NORTH 12" 04' 25" WEST ALONG THE EAST LINE OF SAID ROCKWALL CHAMBER OF COMMERCE FOR A DISTANCE OF 210.02 FEET TO A 1/2" IRON ROD FOUND FOR CORNER IN THE SOUTH RIGHT-OF-WAY LINE OF INTERSTATE HIGHWAY 30;

THENCE NORTH 70° 28' 46" EAST FOLLOWING ALONG THE SOUTH RIGHT-OF-WAY LINE OF INTERSTATE HIGHWAY 30 FOR A DISTANCE OF 662.26 FEET TO THE POINT OF BEGINNING AND CONTAINING 34.4904 ACRES OF LAND, MORE OR LESS.

NOW, THEREFORE, KNOW ALL MEN BY THESE PRESENTS:

STATE OF TEXAS
COUNTY OF ROCKWALL

WE, THE UNDERSIGNED OWNERS OF THE LAND SHOWN ON THIS PLAT, AND DESIGNATED HEREIN AS LOT 3, BLOCK A, LAKE POINTE BAPTIST CHURCH ADDITION, A SUBDIVISION TO THE CITY OF ROCKWALL, TEXAS, AND WHOSE NAME IS SUBSCRIBED HERETO, HEREBY DEDICATE TO THE USE OF THE PUBLIC FOREVER ALL STREETS, ALLEYS, PARKS, WATER COURSES, DRAINS, EASEMENTS AND PUBLIC PLACES THEREON SHOWN ON THE PURPOSE AND CONSIDERATION THEREIN EXPRESSED. WE FURTHER CERTIFY THAT ALL OTHER PARTIES WHO HAVE A MORTGAGE OR LIEN INTEREST IN LAKE POINTE BAPTIST CHURCH ADDITION HAVE BEEN NOTIFIED AND SIGNED THIS PLAT.

WE UNDERSTAND AND DO HEREBY RESERVE THE EASEMENT STRIPS SHOWN ON THIS PLAT FOR THE PURPOSES STATED AND FOR THE MUTUAL USE AND ACCOMMODATION OF ALL UTILITIES DESIRING TO USE OR USING SAME. WE ALSO UNDERSTAND THE FOLLOWING:

(1) NO BUILDINGS SHALL BE CONSTRUCTED OR PLACED UPON, OVER, OR ACROSS THE UTILITY EASEMENTS AS DESCRIBED

(2) ANY PUBLIC UTILITY SHALL HAVE THE RIGHT TO REMOVE AND KEEP REMOVED ALL OR PART OF ANY BUILDINGS, FENCES, TREES, SHRUBS, OR OTHER GROWTHS OR IMPROVEMENTS WHICH IN ANY WAY ENDANGER OR INTERFERE WITH CONSTRUCTION, MAINTENANCE OR EFFICIENCY OF THEIR RESPECTIVE SYSTEM ON ANY OF THESE EASEMENT STRIPS; AND ANY PUBLIC UTILITY SHALL AT ALL TIMES HAVE THE RIGHT OF INGRESS OR EGRESS TO, FROM AND UPON THE SAID EASEMENT STRIPS FOR PURPOSE OF CONSTRUCTION, RECONSTRUCTION, INSPECTING, PATROLLING, MAINTAINING, AND EITHER ADDING TO OR REMOVING ALL OR PART OF THEIR RESPECTIVE SYSTEM WITHOUT THE NECESSITY OF, AT ANY TIME, PROCURING THE PERMISSION OF ANYONE

(3) THE CITY OF ROCKWALL WILL NOT BE RESPONSIBLE FOR ANY CLAIMS OF ANY NATURE RESULTING FROM OR OCCASIONED BY THE ESTABLISHMENT OF GRADE OF STREETS IN THE SUBDIVISION.

(4) THE DEVELOPER AND SUBDIVISION ENGINEER SHALL BEAR TOTAL RESPONSIBILITY FOR STORM DRAIN IMPROVEMENTS.

(5) THE DEVELOPER SHALL BE RESPONSIBLE FOR THE NECESSARY FACILITIES TO PROVIDE DRAINAGE PATTERNS AND DRAINAGE CONTROLS SUCH THAT PROPERTIES WITHIN THE DRAINAGE AREA ARE NOT ADVERSELY AFFECTED BY STORM DRAINAGE FROM THE DEVELOPMENT.

(6) NO HOUSE DWELLING UNIT, OR OTHER STRUCTURE SHALL BE CONSTRUCTED ON ANY LOT IN THIS ADDITION BY THE OWNER OR ANY OTHER PERSON UNTIL THE DEVELOPER AND/OR OWNER HAS COMPLIED WITH ALL REQUIREMENTS OF THE SUBDIVISION REGULATIONS OF THE CITY OF ROCKWALL REGARDING IMPROVEMENTS WITH RESPECT TO THE ENTIRE BLOCK ON THE STREET OR STREETS ON WHICH PROPERTY ABUTS, INCLUDING THE ACTUAL INSTALLATION OF STREETS WITH THE REQUIRED BASE AND PAVING, CURB AND GUTTER, WATER AND SEWER, DRAINAGE STRUCTURES, STORM STRUCTURES, STORM SEWERS, AND ALLEYS, ALL ACCORDING TO THE SPECIFICATIONS OF THE CITY OF ROCKWALL; OR

UNTIL AN ESCROW DEPOSIT, SUFFICIENT TO PAY FOR THE COST OF SUCH IMPROVEMENTS, AS DETERMINED BY THE CITY'S ENGINEER AND/OR CITY ADMINISTRATOR, COMPUTED ON A PRIVATE COMMERCIAL RATE BASIS, HAS BEEN MADE WITH THE CITY SECRETARY, ACCOMPANIED BY AN AGREEMENT SIGNED BY THE DEVELOPER AND/OR OWNER, AUTHORIZING THE CITY TO MAKE SUCH IMPROVEMENTS AT PREVAILING PRIVATE COMMERCIAL RATES, OR HAVE THE SAME MADE BY A CONTRACTOR AND PAY FOR THE SAME OUT OF THE ESCROW DEPOSIT, SHOULD THE DEVELOPER AND/OR OWNER FAIL OR REFUSE TO INSTALL THE REQUIRED IMPROVEMENTS WITHIN THE TIME STATED IN SUCH WRITTEN AGREEMENT, BUT IN NO CASE SHALL THE CITY BE OBLIGATED TO MAKE SUCH IMPROVEMENTS ITSELF. SUCH DEPOSIT MAY BE USED BY THE OWNER AND/OR DEVELOPER AS PROGRESS PAYMENTS AS THE WORK PROGRESSES IN MAKING SUCH IMPROVEMENTS BY MAKING CERTIFIED REQUISITIONS TO THE CITY SECRETARY, SUPPORTED BY EVIDENCE OF WORK DONE; OR

UNTIL THE DEVELOPER AND/OR OWNER FILES A CORPORATE SURETY BOND WITH THE CITY SECRETARY IN A SUM EQUAL TO THE COST OF SUCH IMPROVEMENTS FOR THE DESIGNATED AREA, GUARANTEEING THE INSTALLATION THEREOF WITHIN THE TIME STATED IN THE BOND, WHICH TIME SHALL BE FIXED BY THE CITY COUNCIL OF THE CITY OF ROCKWALL.

WE FURTHER ACKNOWLEDGE THAT THE DEDICATIONS AND/OR EXACTION'S MADE HEREIN ARE PROPORTIONAL TO THE IMPACT OF THE SUBDIVISION UPON THE PUBLIC SERVICES REQUIRED IN ORDER THAT THE DEVELOPMENT WILL COMPORT WITH THE PRESENT AND FUTURE GROWTH NEEDS OF THE CITY; WE, OUR SUCCESSORS AND ASSIGNS HEREBY WAIVE ANY CLAIM, DAMAGE, OR CAUSE OF ACTION THAT WE MAY HAVE AS A RESULT OF THE DEDICATION OF EXACTIONS MADE HEREIN.

NOTE: IT SHALL BE THE POLICY OF THE CITY OF ROCKWALL TO WITHHOLD ISSUING BUILDING PERMITS UNTIL ALL STREETS, WATER, SEWER AND STORM DRAINAGE SYSTEMS HAVE BEEN ACCEPTED BY THE CITY. THE APPROVAL OF A PLAT BY THE CITY DOES NOT CONSTITUTE ANY REPRESENTATION, ASSURANCE OR GUARANTEE THAT ANY BUILDING WITHIN SUCH PLAT SHALL BE APPROVED, AUTHORIZED OR PERMIT THEREFORE ISSUED, NOR SHALL SUCH APPROVAL CONSTITUTE ANY REPRESENTATION, ASSURANCE OR GUARANTEE BY THE CITY OF THE ADEQUACY AND AVAILABILITY FOR WATER FOR PERSONAL USE AND FIRE PROTECTION WITHIN SUCH PLAT, AS REQUIRED UNDER ORDINANCE 83-54.

THIS PLAT APPROVED SUBJECT TO ALL PLATTING ORDINANCES, RULES, REGULATIONS, AND RESOLUTIONS OF THE CITY OF

WITNESS, MY HAND AT DALLAS, TEXAS, THIS THE 10th DAY OF HOLD , 2018

LAKE POINTE CHURCH

JOHN WARDELL, TRUSTEE

STATE OF TEXAS COUNTY OF ROCKWALL

BEFORE ME, THE UNDERSIGNED AUTHORITY, ON THIS DAY PERSONALLY APPEARED **JOHN WARDELL**, KNOWN TO ME TO BE THE PERSON WHOSE NAME IS SUBSCRIBED TO THE FOREGOING INSTRUMENT, AND ACKNOWLEDGED TO ME THAT HE EXECUTED THE SAME FOR THE PURPOSE AND CONSIDERATION THEREIN STATED.

GIVEN UPON MY HAND AND SEAL OF OFFICE THIS LOTH DAY OF HOLD, 2018

SURVEYOR:

BLUE SKY SURVEYING & MAPPING CORPORATION

TBPLS REG. #10105700

11015 MIDWAY ROAD

DALLAS, TEXAS 75229

(214) 358-4500

CONTACT: DAVID R. PETREE, R.P.L.S.

TBPLS REGISTRATION No. 10105700

NOTARY PUBLIC IN AND FOR THE STATE OF TEXAS MY COMMISSION EXPIRES:

BRAD BASSETT
Commission @ 11771880
My Commission Expires
October 20, 2019

Filed and Recorded
Official Public Records
Shelli Miller, County Clerk
Rockwall County, Texas
05/18/2018 02:28:09 PM
\$200.00
20180000008587

LE COUNTY DE LE CO

OWNER:
LAKE POINTE BAPTIST CHURCH
701 EAST INTERSTATE 30
ROCKWALL, TEXAS 75087
PHONE: 972-771-2322

SURVEYOR'S CERTIFICATE

NOW, THEREFORE KNOW ALL MEN BY THESE PRESENTS:
THAT I, DAVID PETREE, DO HEREBY CERTIFY THAT I PREPARED THIS PLAT FROM AN ACTUAL AND ACCURATE SURVEY OF THE LAND, AND THAT THE CORNER MONUMENTS SHOWN THEREON WERE PROPERLY PLACED UNDER MY PERSONAL SURVEY.

DAVID PETREE

STATE OF TEXAS

MY COMMISSION EXPIRES:

COUNTY OF DALLAS }

REGISTERED PROFESSIONAL

LAND SURVEYOR NO. 1890

BEFORE ME, THE UNDERSIGNED AUTHORITY, ON THIS DAY PERSONALLY APPEARED DAVID PETREE, KNOWN TO ME TO BE THE PERSON WHOSE NAME IS SUBSCRIBED TO THE FOREGOING INSTRUMENT, AND ACKNOWLEDGED TO ME THAT HE EXECUTED THE SAME FOR THE PURPOSE AND CONSIDERATION THEREIN STATED.

GIVEN UPON MY HAND AND SEAL OF OFFICE THIS 10 DAY OF HON

NOTARY PUBLIC IN AND FOR THE STATE OF TEXAS

KIMBERLI DONASCIMENTO
Notary Public, State of Texas
Comm. Expires 11-18-2020
Notary ID 130906475

RECOMMENDED FOR FINAL APPROVAL

PLANNING AND ZONING COMMISSION

PLANNING & ZONING

THIS APPROVAL SHALL BE INVALID UNLESS THE APPROVED PLAT FOR SUCH ADDITION IS RECORDED IN THE OFFICE OF THE COUNTY CLERK OF ROCKWALL, COUNTY, TEXAS, WITHIN ONE HUNDRED EIGHTY (180) DAYS FROM SAID DATE OF FINAL APPROVAL.

WITNESS OUR HANDS, THIS 1591 DAY OF May , 2018

SEAL SINGINEER

FINAL PLAT LOT 3, BLOCK A

LAKE POINTE BAPTIST CHURCH ADDITION BEING A REPLAT OF LOT 1, BLOCK A

SECOND AMENDED REPLAT
LAKE POINTE BAPTIST CHURCH ADDITION
BEING A 34.4904—ACRE PARCEL
JAMES SMITH SURVEY, ABSTRACT NO. 200
E.P.G. CHISUM SURVEY, ABSTRACT NO. 64
CITY OF ROCKWALL, ROCKWALL COUNTY, TEXAS

APRIL 9, 2018

CASE NO. P2017-048

SHEET 4 OF 4

- Contractor is responsible for, and must obtain prior to construction, all necessary construction permits required by
- 3. The Contractor shall abide by all applicable federal, state, and local laws governing excavation. The Contractor shall provide detailed plans and specifications for trench safety systems that comply with applicable laws governing excavation. These plans shall be sealed by an Engineer experienced in the design of trench safety systems and licensed by the State of Texas. Submit plan to the Owner prior to commencing work. The Contractor shall be solely responsible for all aspects of work related to excavation.
- 4. Existing utility locations shown are taken from available records provided by the utility Owner and field locations of surface appurtenances. Locations shown are generally schematic in nature and may not accurately reflect the size and location of each particular utility. Some utility lines may not be shown. Contractor shall assume responsibility for actual field location and protection of existing facilities whether shown or not. Contractor shall also assume responsibility for repairs to existing facilities, whether shown or not, damaged by contractor's activities. Differences in horizontal or vertical location of existing utilities shall not be a basis for additional expense.
- 5. Contractor shall locate and adjust existing utility manhole lids, cleanouts, water valves and other surface appurtenances as required for new construction. Contractor shall coordinate utility adjustments with other disciplines and the appropriate utility agencies and provide for all fees for permits, connections, inspections, etc.
- 6. The Contractor shall protect existing property monumentation and primary control. Any such points which the Contractor believes will be destroyed shall have offset points established by the Contractor prior to construction. Any monumentation destroyed by the Contractor shall be reestablished at his expense.
- 7. Any damages that may occur to real property or existing improvements shall be restored by the Contractor to at lease the same condition that the real property or existing improvements were in prior to the damages. This restoration shall be subject to the Owner's approval; moreover, this restoration shall not be a basis for additional compensation to the Contractor. Restoration shall include, but not be limited to, regrassing, revegetation, replacing fences, replacing trees, etc.
- 8. It shall be the responsibility of the Contractor to:
 - A. Prevent any damage to private property and property owner's poles, fences, shrubs, etc.
 - B. Provide access to all drives during construction.C. Protect all underground utilities to remain in service.
- D. Notify all utility companies and verify location of all utilities prior to start of construction.
- 9. Contractor shall maintain positive drainage at all time during construction. Ponding of water in streets, drives, truck courts, trenches, etc. will not be allowed.
- 10. Contractor shall maintain existing sanitary sewer and water service at all times during construction.
- 11. Contractor is responsible for coordination with utility companies and adjustment of existing sanitary sewer cleanouts, water meters and any other appurtenances to new grade as required.
- 12. Pavement removal and repair shall conform to the City of Rockwall requirements. All sawcuts shall be full depth cuts. Contractor shall make efforts to protect concrete and/or asphalt edges. Any large spalled or broken edges shall be removed by sawcutting pavement prior to replacement.
- 13. Fire service shall be sized and designed by a State of Texas licensed fire protection engineer/contractor registered in the State of Texas
- 14. All underground fire lines shall be installed by a state licensed fire protection contractor.
- 15. All utility crossings shall comply with TCEQ Chapter 217 and 290 regulations and city requirements.

EROSION CONTROL NOTES

1. Refer to the Erosion Control Sheets, sheets C3.01 and C3.02, for Erosion Control notes.

DEMOLITION NOTES:

- 1. For additional extents for demolition, refer to grading, storm drainage, paving, and dimension control, water and
- sanitary sewer plans.

 2. Information provided on this plan does not delineate any underground foundation or objects that currently may be
- The contract shall be responsible for proper removal and disposal of materials as required by the Owner or Owner's representative.

GRADING NOTES:

- 1. No grading or earthwork shall commence until filing of a Notice of Intent to the Texas Commission of Environmental Quality (TCEQ) if applicable and Implementation of the Storm water Pollution Prevention Plan by the Contractor. A site erosion control plan and stormwater pollution prevention plan shall be prepared and provided to the City of Rockwallby others prior to start of construction.
- 2. The existing ground surface shall be stripped of vegetation, roots, old construction debris, and other organic materials. Material unsuitable for fill shall be removed from the site and properly disposed of.
- 3. The subgrade should be firm and able to support the construction equipment without displacement. Soft or yielding subgrade should be corrected and made stable before construction proceeds. The subgrade shall be proof rolled using a heavy pneumatic tire roller, loaded dump truck or similar piece of heavy equipment.
- 4. All areas to receive fill shall be stripped of vegetation and the top six (6) inches scarified prior to receiving any fill. Fill material shall be placed in loose lifts not exceeding 8-inches in uncompacted thickness. The fill material shall be uniform with respect to material type and moisture content. Clods and chunks of material shall be broken down and the fill material mixed by disking, blading, or plowing, as necessary, so that a material of uniform moisture and density is obtained for each lift. Water required to bring the fill material to the proper moisture content should be sprinkled evenly through each layer.
- 5. The on-site soils are suitable for use in site grading. Imported fill material shall be clean soil with a Liquid Limit less than 40 and no rock greater than 4 inches in maximum dimension. The fill material shall be free of vegetation and
- 6. The fill material shall be compacted between 95 and 98 percent of the maximum dry density as determined by the Standard Proctor test, ASTM D 698. In conjunction with the compacting operation, the fill material shall be brought to the proper moisture content. The moisture content of the compacted soils should be maintained between -2 and +2 percent of the optimum value (determined from ASTM D 698). All fill to be compacted using a sheep's foot roller.
- The Contractor shall administer sprinklers for dust control, earthwork or base construction as required or as directed by the Engineer in accordance with the TXDOT Standard Specification for Construction, Item 204-Sprinklering.
- 8. Contractor's work shall include pavement removal and disposal required for new walk, drive, curb, gutter and other grading features. Contractor shall be responsible for all coordination, inspection and testing required by the Owner and/or the City of Rockwall.
- 9. All sidewalks shall maintain 2% cross slope maximum. Longitudinal slopes along sidewalks and accessible routes shall not exceed 5% in the direction of travel. Slopes within designated handicap parking or loading areas shall not exceed 2% in any direction.
- 10. 4:1 Horizontal: Vertical is the maximum allowable slope within the earthen areas.
- 11. Site grading and pavement subgrade shall be prepared in accordance with the Geotechnical Report No. G161157 prepared by ALPHA TESTING dated 06/10/2016.
- 12. Proposed spot elevations represent gutter elevation unless noted otherwise.

PAVING NOTES:

- Pavement removal and repair shall conform to City of Rockwall requirements. All sawcuts shall be full depth cuts.
 Contractor shall make efforts to protect concrete. Any large spalled or broken edges shall
 be removed by sawcutting pavement prior to replacement.
- Contractor's work shall include pavement removal and disposal required for new walk, drive, curb, gutter and
 other paving features. Contractor shall be responsible for all coordination, inspection and testing required by the
 Owner and/or the City of Rockwall.
- 3. Concrete paving joints shall be constructed as recommended in the geotechnical report noted below. Expansion joints shall be placed at changes in direction of paving, at driveways and/or as shown on the drawings. Seal all joints as shown on the drawings.
- 4. Paving sections shall be sawcut in 15' x15' squares.
- 5. Site grading and pavement subgrade shall be prepared in accordance with the Geotechnical Report No. G161157 prepared by ALPHA TESTING dated 06/10/2016.
- 6. Unless otherwise indicated on plans, all dimensions are to face of curb or face of building and are perpendicular to property line. These dimensions are provided to tie the Architect's Site Plan to the property lines.
- 7. All sidewalks and handicap parking areas shall meet current ADA standards for minimum and maximum slopes.

3803 PARKWOOD BLVD, SUITE 800 FRISCO, TEXAS 75034-8640 TEL (214) 618-4574 TBPE FIRM #F-312

ECORD DRAWINGS

1 09/30/2019 RE

DANIEL W: WARFIELD

95947

CENSE

SOLUTION

5-15-2019

The seal appearing on this document was authorized by Daniel W. Warfield, P.E. 95947 on (05/15/19). Alteration of a sealed document without proper notification to the responsible engineer is an offense under the Texas Engineering Practice Act. The record copy of this drawing is on file at the offices of Halff Associates, Inc., 3803 Parkwood Blvd., Frisco, Texas 75034. TBPE FIRM #F-312.

Project No.:	35866
Issued:	9/30/2019
Drawn By:	CAD
Checked By:	DWW
Scale:	AS NOTED
Ol 4 T:41-	

neet Title GENERAL NOTES

C0.02
Sheet Number

| ELEVATION | DESCRIPTION NORTHING EASTING 550.06 SXTP 7015991.2980 2592962.1928 2593196.4381 543.24 SXTP 7015431**.**9569 SXTP 7015521.4980 2592947.0430 546.21 7015870.0270 548.29 2593095.7245 SXTP

322 | 7015977.2058 | 2593078.3578 |

BENCHMARKS

RECORD DRAWING

HALFF ASSOCIATES, INC. HEREBY STATES

PREPARED BASED ON FIELD OBSERVATIONS,

THAT THIS PLAN IS A RECORD DRAWING

WORK CONDUCTED AT THE SITE. THE

DRAWINGS ARE ON FILE AT THE OFFICES

HALFF ASSOCIATES, INC., TBPE FIRM #312

TO THE BEST OF OUR KNOWLEDGE

ON 09/10/2019, AND FIFLD SURVEY


DANIEL W. WARFIELD P.E. 95947 HALFF ASSOC. TBPE FIRM #312


549.54

SXTP

ENGINEER OF RECORD:

DATE 09/30/2019

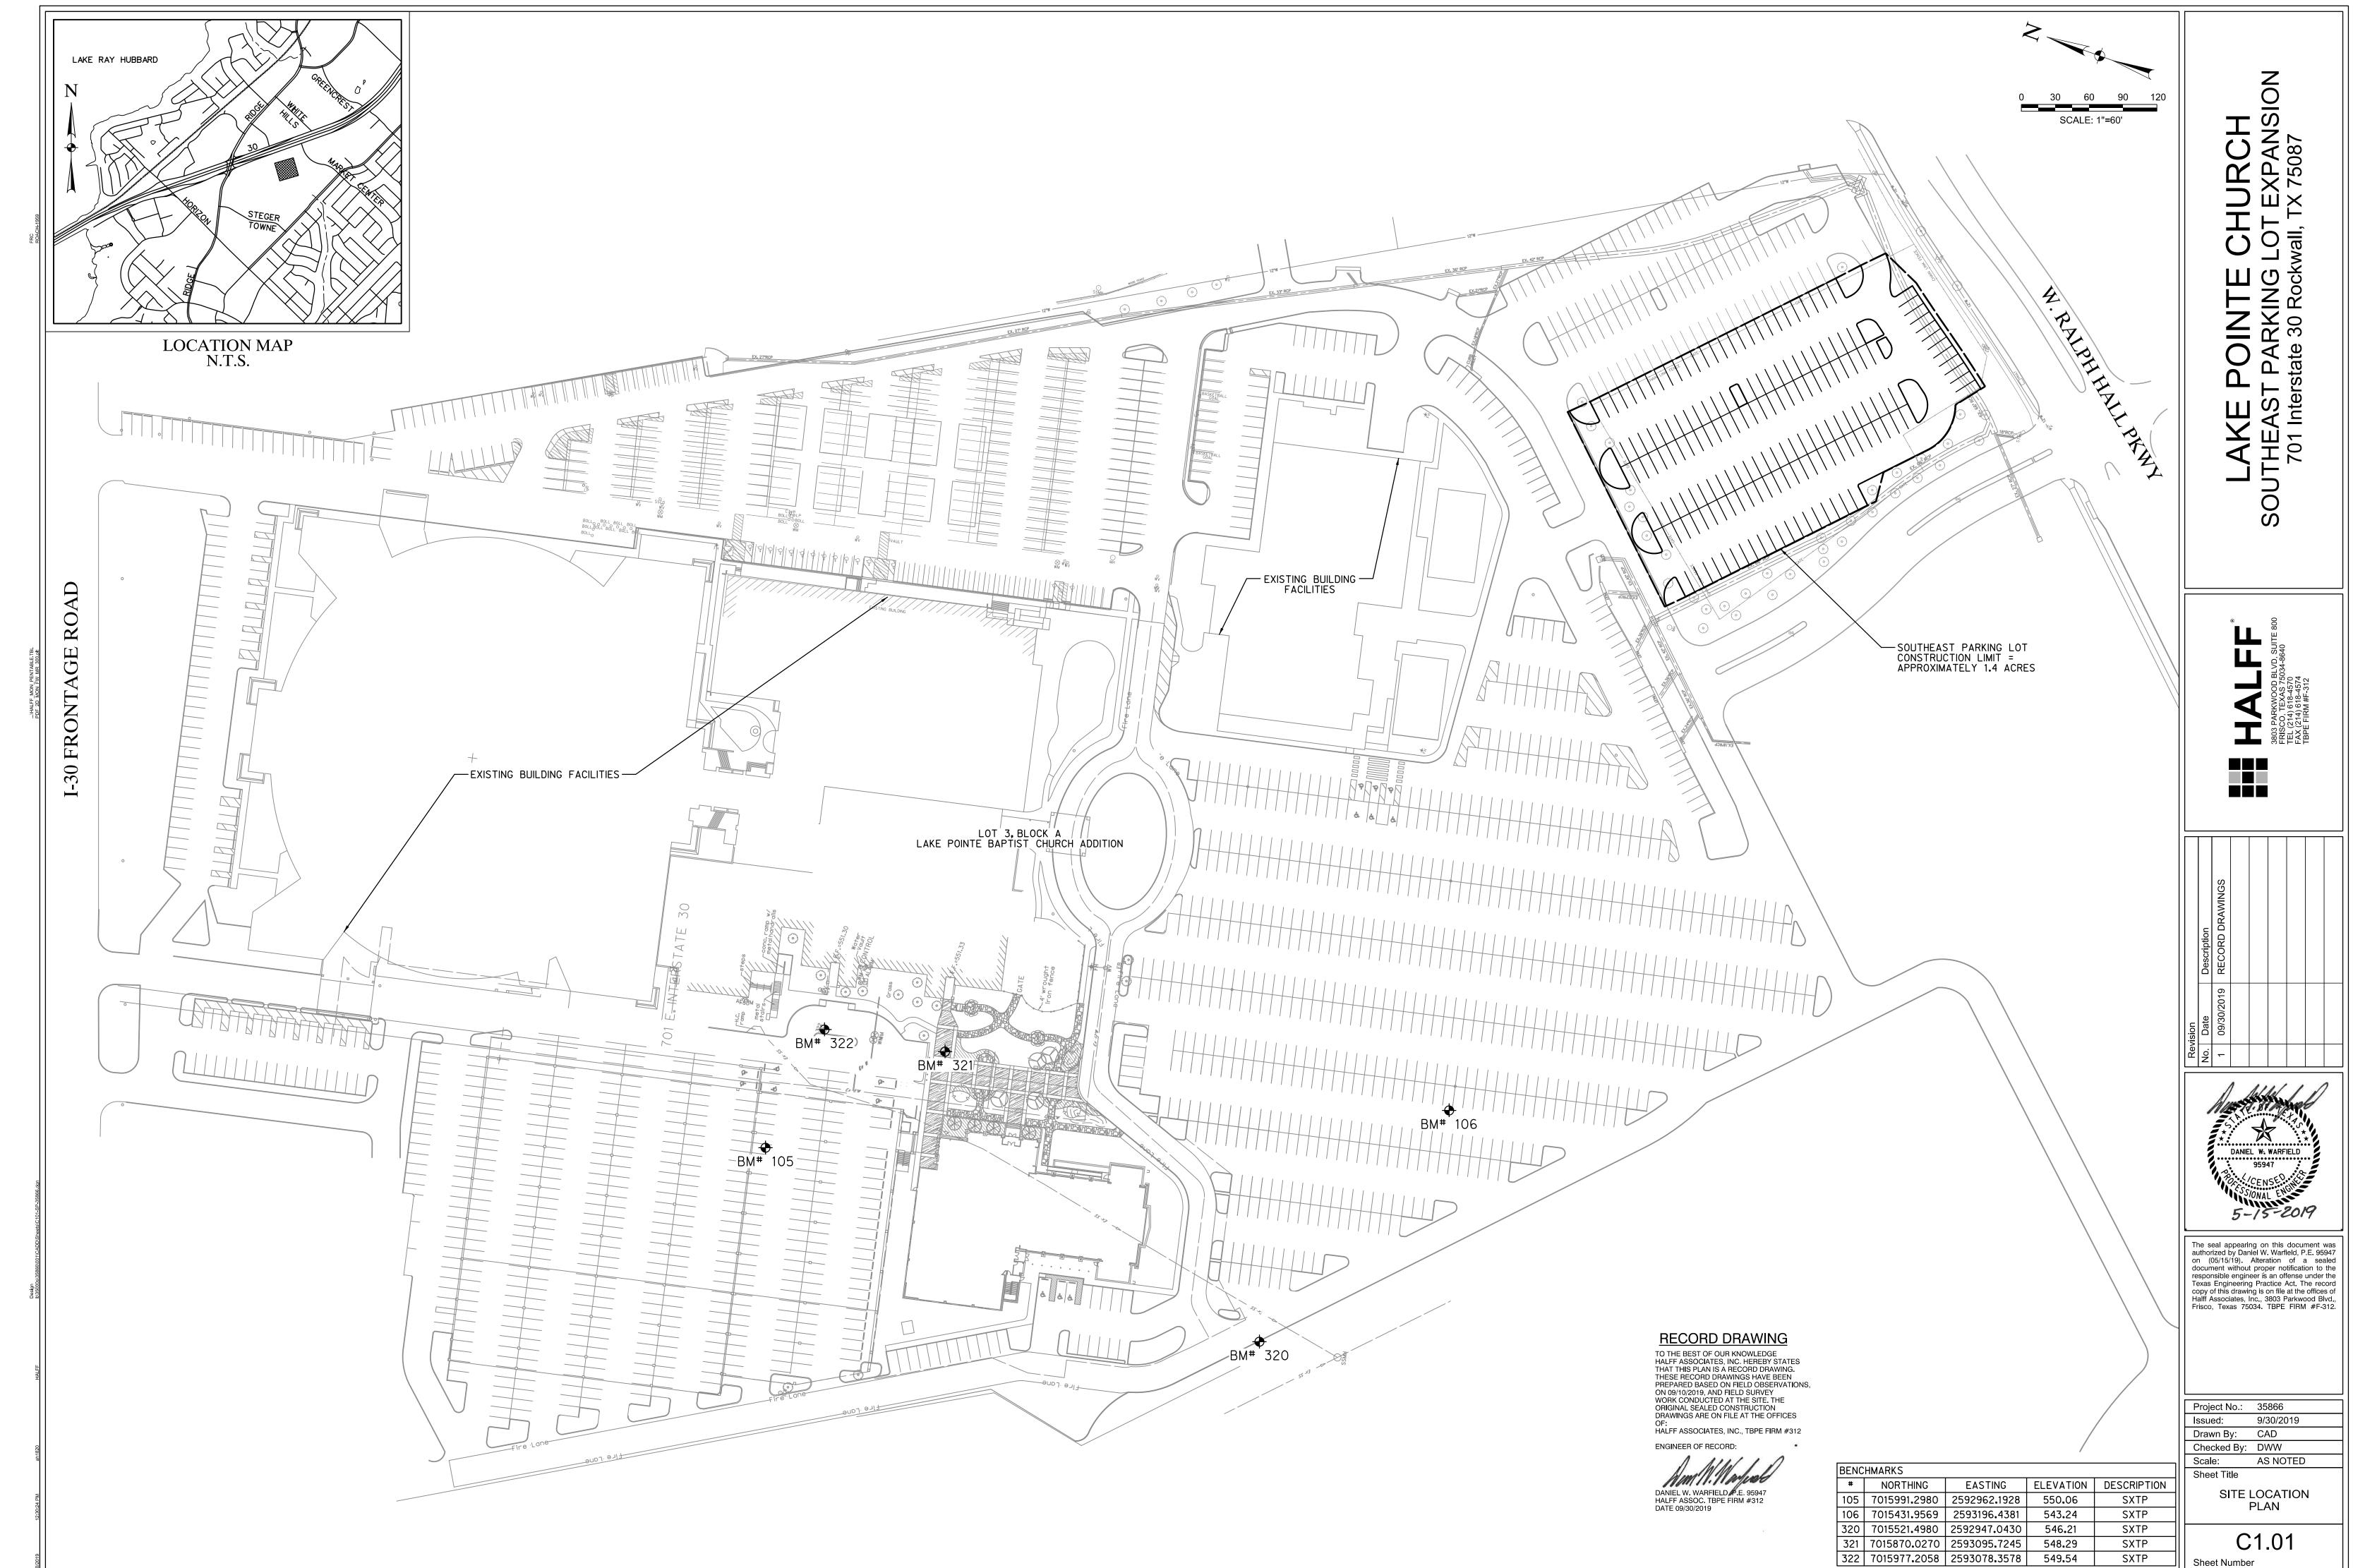


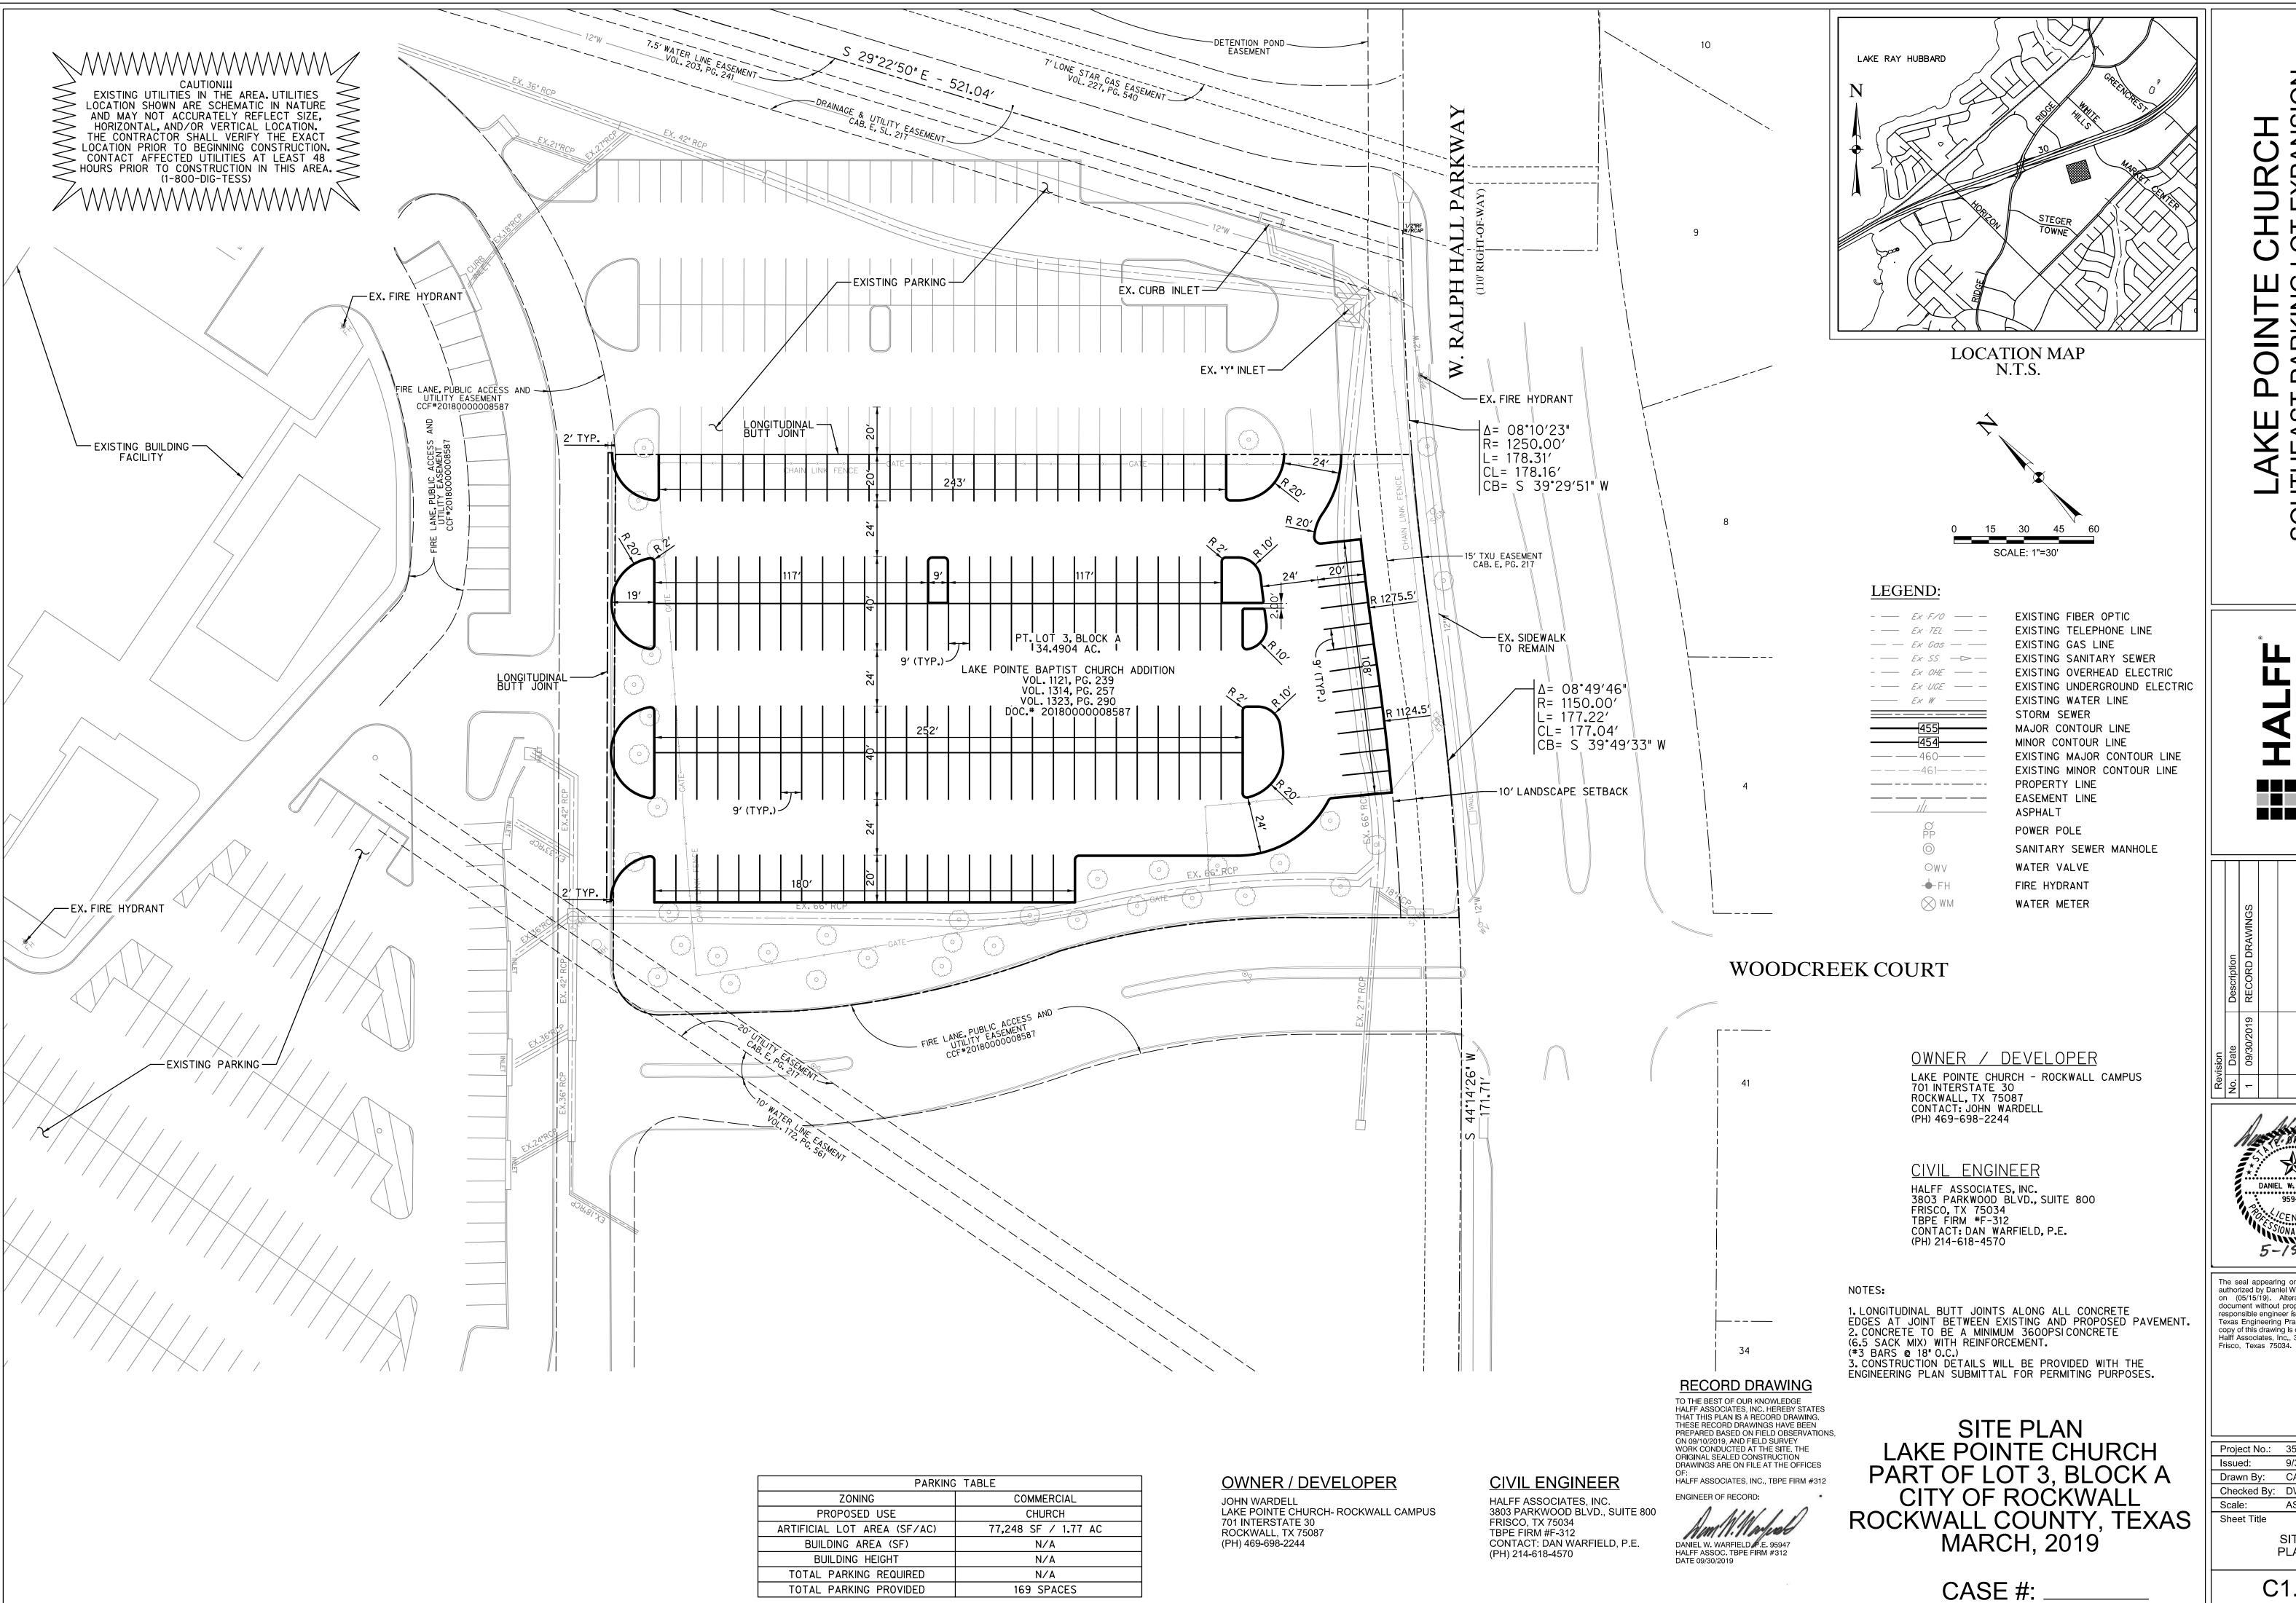

TOTAL PARKING PROVIDED

169 SPACES

HURCH OT EXPANSION II, TX 75087

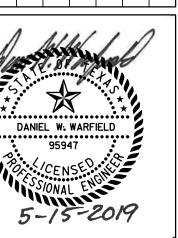


The seal appearing on this document was authorized by Daniel W. Warfield, P.E. 95947 on (05/15/19). Alteration of a sealed document without proper notification to the responsible engineer is an offense under the Texas Engineering Practice Act. The record copy of this drawing is on file at the offices of Halff Associates, Inc., 3803 Parkwood Blvd., Frisco, Texas 75034. TBPE FIRM #F-312.

Project No.: 35866 9/30/2019 Issued: Drawn By: CAD Checked By: DWW AS NOTED

> SITE PLAN

C1.02 Sheet Number

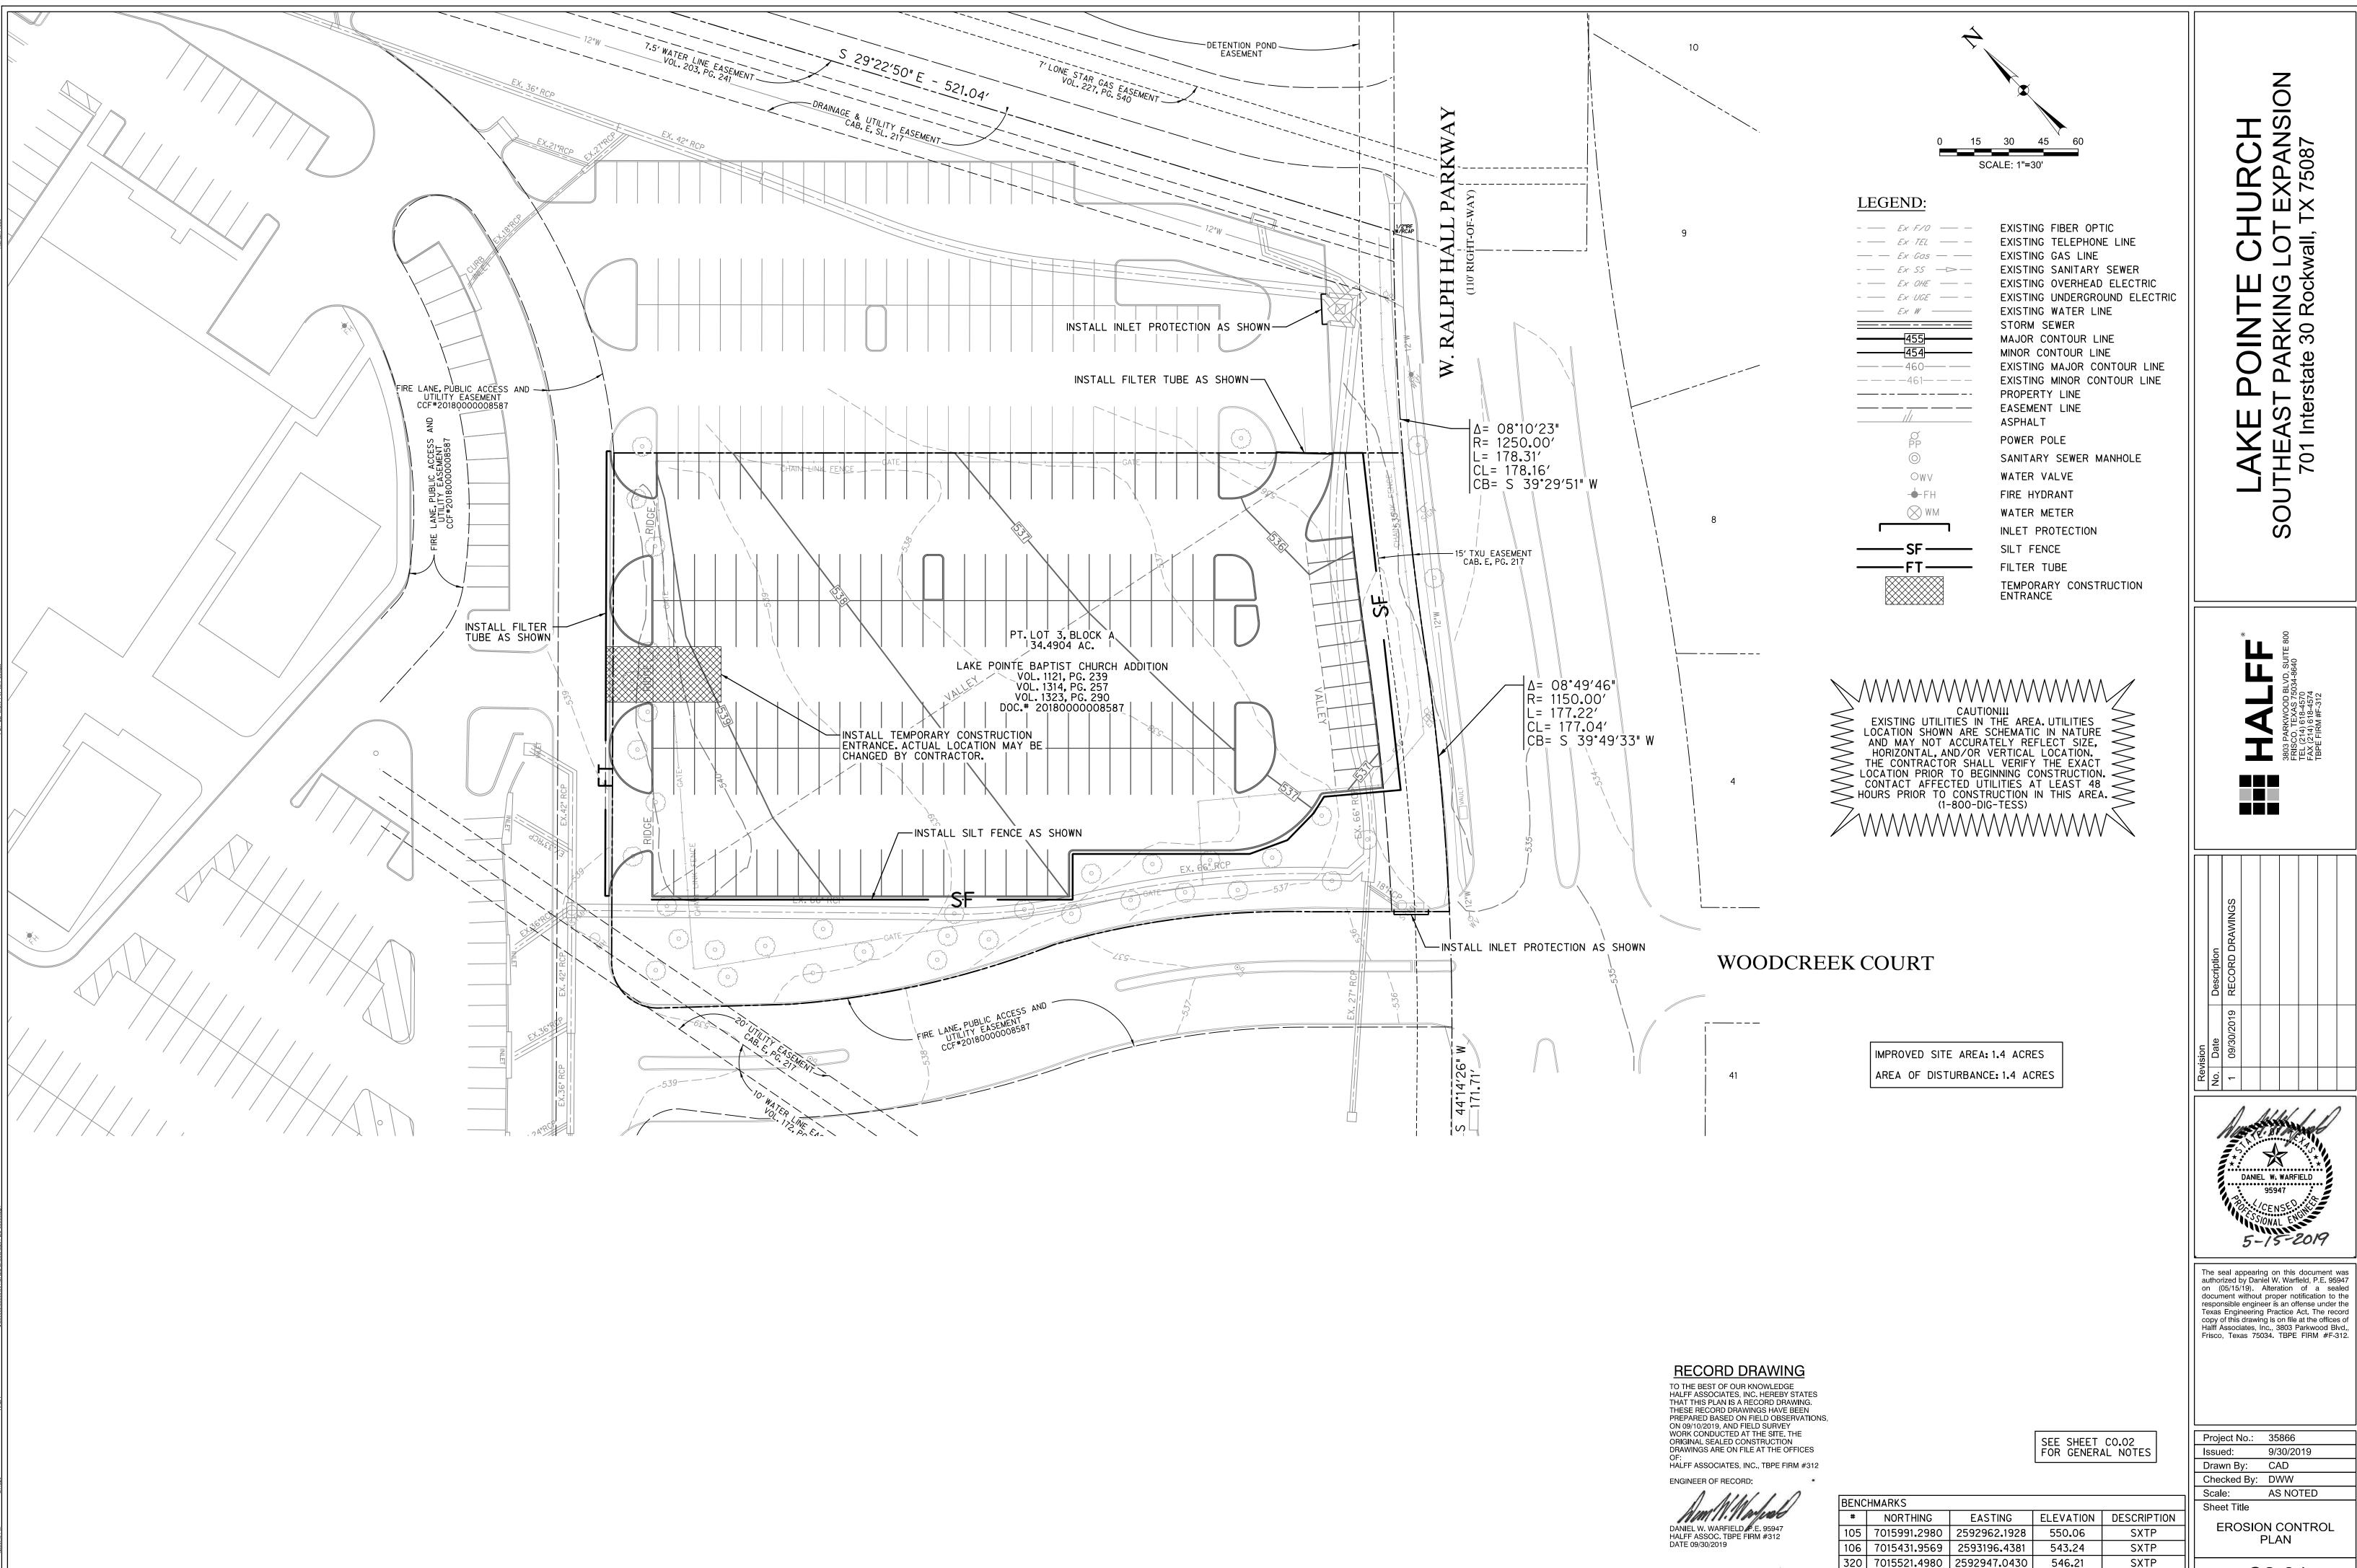

IURCH EXPANSION TX 75087 80

Project No. 35866 9/30/2019 Checked By: DWW AS NOTED **EROSION CONTROL** PLAN

Sheet Number

7015870.0270

548.29

SXTP

SXTP

2593095.7245

322 7015977.2058 2593078.3578 549.54

2. It is the intent of the information provided on these documents to be used as a general guideline for the Contractor. The SWP3 to be prepared shall meet the current requirements set forth in the TCEQ's TPDES generalpermit for storm water discharges from construction sites as well as any local requirements.

3. The Contractor shall be responsible for maintaining erosion controlduring construction and for obtaining any required construction related drainage permits, or making any construction related notifications. An inspection report that summarizes inspection activities and implementation of the SWP3 shall be performed as required by the PERMIT and retained by the Contractor and made a part of the construction documents. The Contractor shall provide copies of all SWP3 documents including, but not limited to, inspection records, original plans, and modified plans to the Owner at contract close-out. During construction the contractor shall provide copies of the inspection reports to the Owner on a monthly basis.

4. Temporary storm drainage and/or erosion controlmaterial shall be suitable for this application and shall be installed with the proper techniques by the Contractor as required by NCTCOG Standard Specifications for Public Works Construction. Temporary storm drainage and/or erosion controlmaterialshall be removed by the Contractor, in addition to any excavations backfilled by the Contractor, in accordance with NCTCOG Standard Specifications for Public Works Construction when temporary erosion controldevices are no longer needed as specified in the PERMIT. Maintenance of the permanent erosion controlmeasures at the site will be assumed by the

Owner at contract close out and acceptance of the work. 5. The Contractor shall maintain the SWP3 in accordance with the TCEQ Permit and make the SWP3 available, upon request, to the TCEQ and/or Owner.

6. The Contractor must amend the SWP3 whenever there is a change in design, construction, operation, or maintenance of the SWP3, or when the existing SWP3 proves ineffective. Modifications shall not compromise the intent of the requirements of the PERMIT. Modifications including design and alladditionalmaterials and work shallbe accomplished by the Contractor at no additional expense to the Owner.

7. The Contractor shallinspect his stabilization and erosion controlmeasures at a minimum of once every 14 days, and within 24 hours after any storm event greater than 0.5 inches, or once every 7 days. The Contractor shallrepair inadequacies revealed by the inspection before the next storm event and he shall modify his SWP3 within 7 days of the inspection.

8. The Contractor shall adopt and implement appropriate construction site management practices to prevent the discharge of oils, grease, paints, gasoline, and other pollutants to storm water. Appropriate practices shall include, but not be limited to: designating areas for equipment maintenance and repair; collecting wastes periodically; maintaining conveniently located waste receptacles, and designating and controlling equipment

9. Borrow areas, if excavated, shall be protected and stabilized by the Contractor in a manner acceptable to the Owner and in accordance with PERMIT requirements.

10. All non-paved areas shall be seeded and mulched with erosion protection grass by the Contractor immediately upon completion of final grading. This includes all ditches and embankments. The Contractor shall maintain final grading, and keep seeded areas watered until fully established and accepted by Owner.

11. The Contractor shall construct a silt fence at locations suggested on plans as appropriate or as modified in his SWP3 to fit site conditions at the time of placement, and allborrow and stock pile areas. The silt fence shall be constructed as detailed on this plan. The Contractor shallremove accumulated silt when it reaches a depth of 1/3 the height of the silt fence. The Contractor shall dispose of the removed silt in a location approved by the Owner and in such a manner as to not contribute to erosion and sedimentation. The Contractor shall remove the silt fence when the site is completely stabilized in accordance with the PERMIT.

12. The Contractor shall designate material and equipment storage areas mutually agreed to by the Owner. The storage areas shall be graded for positive drainage, and the surface stabilized with a minimum of 2 inches of compacted flex base on 6 inches of scarified and recompacted subgrade by the Contractor. A silt fence shall be installed by the Contractor around the storage areas to prevent eroded material from leaving the site.

13. Allinlets (onsite and offsite) receiving drainage water from disturbed areas shall be protected by the Contractor as per details shown or other Owner approved methods to prevent eroded material from being transported into inlets. The inlet protection shall be constructed as shown on these plans.

14. The notes and details contained herin do not relieve the Contractor and Owner of meeting and implementing the requirements of the PERMIT.

STEEL FENCE POST MAX. 6' SPACING, EMBEDMENT = 2' MIN. OR AS REQUIRED TO SUPPORT FENCE SILT FENCE WITH WIRE BACK (MIN. HEIGHT 24" ABOVE EXIST. GROUND) COMPACTED EARTH OR ROCK BACKFILL \6" MIN. - FABRIC TOE-IN 6" MIN. (BACKFILLED & COMPACTED)

SILT FENCE

SILT FENCE GENERAL NOTES:

- 1. STEEL POSTS WHICH SUPPORT THE SILT FENCE SHALL BE INSTALLED WITH A SLIGHT ANGLE TOWARD THE ANTICIPATED RUNOFF SOURCE, POST MUST BE EMBEDDED A MINIMUM OF TWO FEET.
- 2. THE TOE OF THE SILT FENCE SHALL BE TRENCHED IN WITH A SPADE OR MECHANICAL TRENCHER, SO THAT THE DOWNSLOPE FACE OF THE TRENCH IS FLAT AND PERPENDICULAR TO THE LINE OF FLOW. WHERE FENCE CANNOT BE TRENCHED IN (e.g. PAVEMENT), WEIGHT FABRIC FLAP WITH WASHED GRAVEL ON UPHILL SIDE TO PREVENT FLOW UNDER FENCE.
- 3. THE TRENCH MUST BE A MINIMUM OF 6 INCHES DEEP AND 6 INCHES WIDE TO ALLOW FOR THE SILT FENCE FABRIC TO BE LAID IN THE GROUND AND BACKFILLED WITH COMPACTED MATERIAL.
- 4. SILT FENCE SHOULD BE SECURELY FASTENED TO EACH STEEL SUPPORT POST OR TO WOVEN WIRE, WHICH IS IN TURN ATTACHED TO THE STEEL FENCE POST. THERE SHALL BE A 6" DOUBLE OVERLAP, SECURELY FASTENED WHERE ENDS OF FABRIC MEET.
- 5. INSPECTION SHALL BE MADE WEEKLY OR AFTER EACH RAINFALL. REPAIR OR REPLACEMENT SHALL BE MADE PROMPTLY AS NEEDED.
- 6. SILT FENCE SHALL BE REMOVED WHEN THE SITE IS COMPLETELY STABILIZED SO AS NOT TO BLOCK OR IMPEDE STORM FLOW OR DRAINAGE.
- 7. ACCUMULATED SILT SHALL BE REMOVED WHEN IT REACHES A DEPTH OF 6 INCHES. THE SILT SHALL BE DISPOSED OF IN AN APPROVED SITE AND IN SUCH A MANNER AS TO NOT CONTRIBUTE TO ADDITIONAL SILTATION.

CROWN TO MINIMIZE RUNOFF GETTING INTO THE STREET. GRADE TO PREVENT RUNOFF SITE DEPTH < FROM LEAVING SITE FILTER FABRIC 4"-6" ROCK 150 FT FROM NO CRUSHED -ENTRANCE CONCRETE ALLOWED - EXISTING GRADE L=50 FT FOR ROADWAY-SITE DEPTH > PROFILE 150 FT FROM ENTRANCE RADIUS = 5' MIN. W=WIDTH AT POINT OF EGRESS OR INGRESS TO SITE TRANSITION TO ROADWAY GRADE TO DRAIN AWAY FROM R.O.W. STABILIZATION AND PAVED ENTRANCE PLAN VIEW

TEMPORARY CONSTRUCTION ENTRANCE DETAIL

N.T.S.

GRAVEL FILTER CONCRETE BLOCK WIRE SCREEN ISOMETRIC VIEW N.T.S.

SILT FENCE DROP INLET OR 2" X 2" STEEL-STAKE — GRATE INLET OR STEEL T-POST EMBEDDED 2' MIN. BOTTOM OF SILT FENCE TO BE ANCHORED AS SHOWN IN SILT FENCE DETAIL ON THIS SHEET.

> SILT FENCE DROP INLET PROTECTION

> > N.T.S.

GRAVEL FILTER (APPROXIMATELY 3/4" DIAMETER) PLACED TO

100% PASSING 1" SIEVE, 95% RETAINED ON 1/2"

TOP OF CONCRETE BLOCKS

-AREA INLET WITH GRATE

CONCENTRATED DITCH FLOW COMING FROM ONE OR MORE SIDES TO THE DROP INLET MAY REQUIRE A STONE CHECK STRUCTURE TO BE CONSTRUCTED ON ONE SIDE OF THE DROP INLET.

CONCRETE BLOCKS STACKED 2 HIGH WIRE SCREEN TO PREVENT MOVEMENT **OVERFLOW** OF GRAVEL

SECTION AA

CONCRETE BLOCK FILTER NOTE: GRAVEL FILTERS MAY BE USED ON PAVEMENT OR BARE GROUND

GRATE INLET FILTER PROTECTION N.T.S.


PERIMETER	FILTER BARRIE	:R
DRAINAGE AREA (MAX.)	AVG. WIDTH OF AREA TO TUBE	TUBE DIA. (MIN.)
ACRE PER 100 ft.	110 ft.	12"
ACRE PER 100 ft.	55 ft.	10"
ACRE PER 100 ft.	25 ft.	8"

NOTE: STAKE FILTER TUBE ON DOWNHILL SIDE AS ILLUSTRATED.


SAND BAGS AT 6 TO 8 FOOT

DIA. AS SPECIFIED

INTERVALS

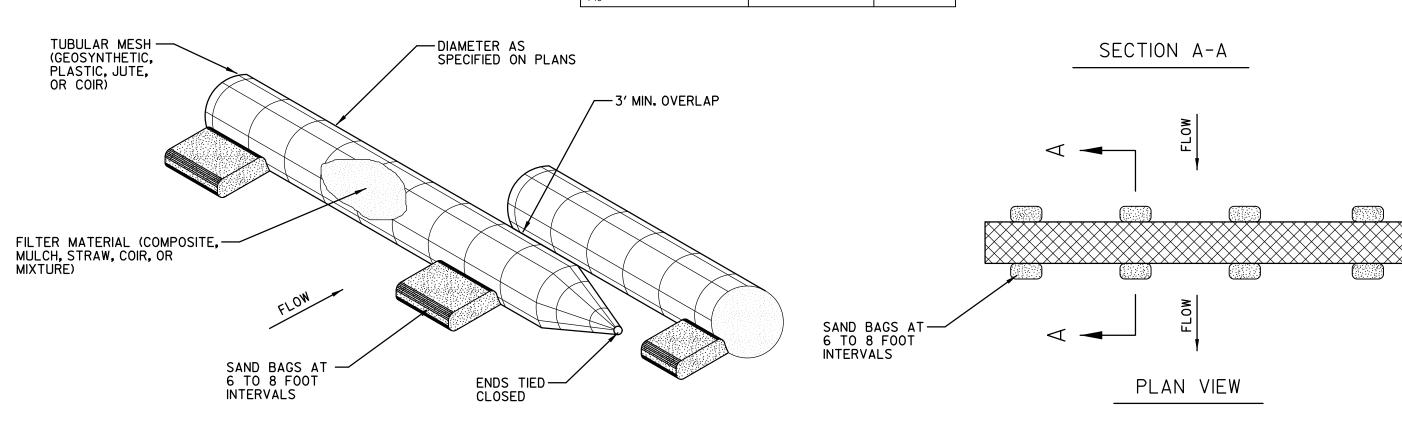

ORGANIC FILTER TUBE DETAIL

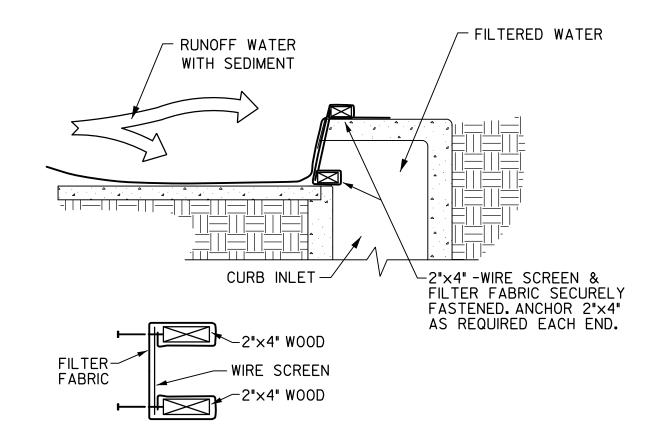

FILTER FABRIC CURB INLET PROTECTION


N.T.S.

RECORD DRAWING TO THE BEST OF OUR KNOWLEDGE HALFF ASSOCIATES, INC. HEREBY STATES THAT THIS PLAN IS A RECORD DRAWING. THESE RECORD DRAWINGS HAVE BEEN PREPARED BASED ON FIELD OBSERVATIONS ON 09/10/2019, AND FIELD SURVEY WORK CONDUCTED AT THE SITE. THE ORIGINAL SEALED CONSTRUCTION DRAWINGS ARE ON FILE AT THE OFFICES HALFF ASSOCIATES, INC., TBPE FIRM #312 **ENGINEER OF RECORD:**

DANIEL W. WARFIELD, P.E. 95947 HALFF ASSOC, TBPE FIRM #312 DATE 09/30/2019

BENC	BENCHMARKS					
#	NORTHING	EASTING	ELEVATION	DESCRIPTION		
105	7015991.2980	2592962.1928	550.06	SXTP		
106	7015431.9569	2593196.4381	543.24	SXTP		
320	7015521.4980	2592947.0430	546.21	SXTP		
321	7015870.0270	2593095.7245	548.29	SXTP		
322	7015977.2058	2593078.3578	549.54	SXTP		

S SO

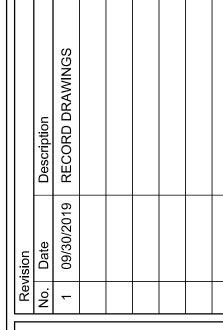




authorized by Daniel W. Warfield, P.E. 95947 n (05/15/19). Alteration of a sealed document without proper notification to the esponsible engineer is an offense under the Texas Engineering Practice Act. The record copy of this drawing is on file at the offices of Halff Associates, Inc., 3803 Parkwood Blvd., Frisco, Texas 75034. TBPE FIRM #F-312.

Project No.:	35866			
Issued:	9/30/2019			
Drawn By:	CAD			
Checked By:	DWW			
Scale:	AS NOTED			
Sheet Title				
EROSION CONTROL				

NOTES AND DETAILS C2.02

Sheet Number

THIS IS NOT A STORM WATER POLLUTION PREVENTION PLAN. THE CONTRACTOR MUST PREPARE ALL RELEVANT DOCUMENTS INCLUDING HIS OPERATION SPECIFIC INFORMATION PER THE TCEQ TPDES PERMIT NO. TXR150000, INCLUDING ALL DOCUMENTATION & CERTIFICATIONS AS REQUIRED BY THE PERMIT.

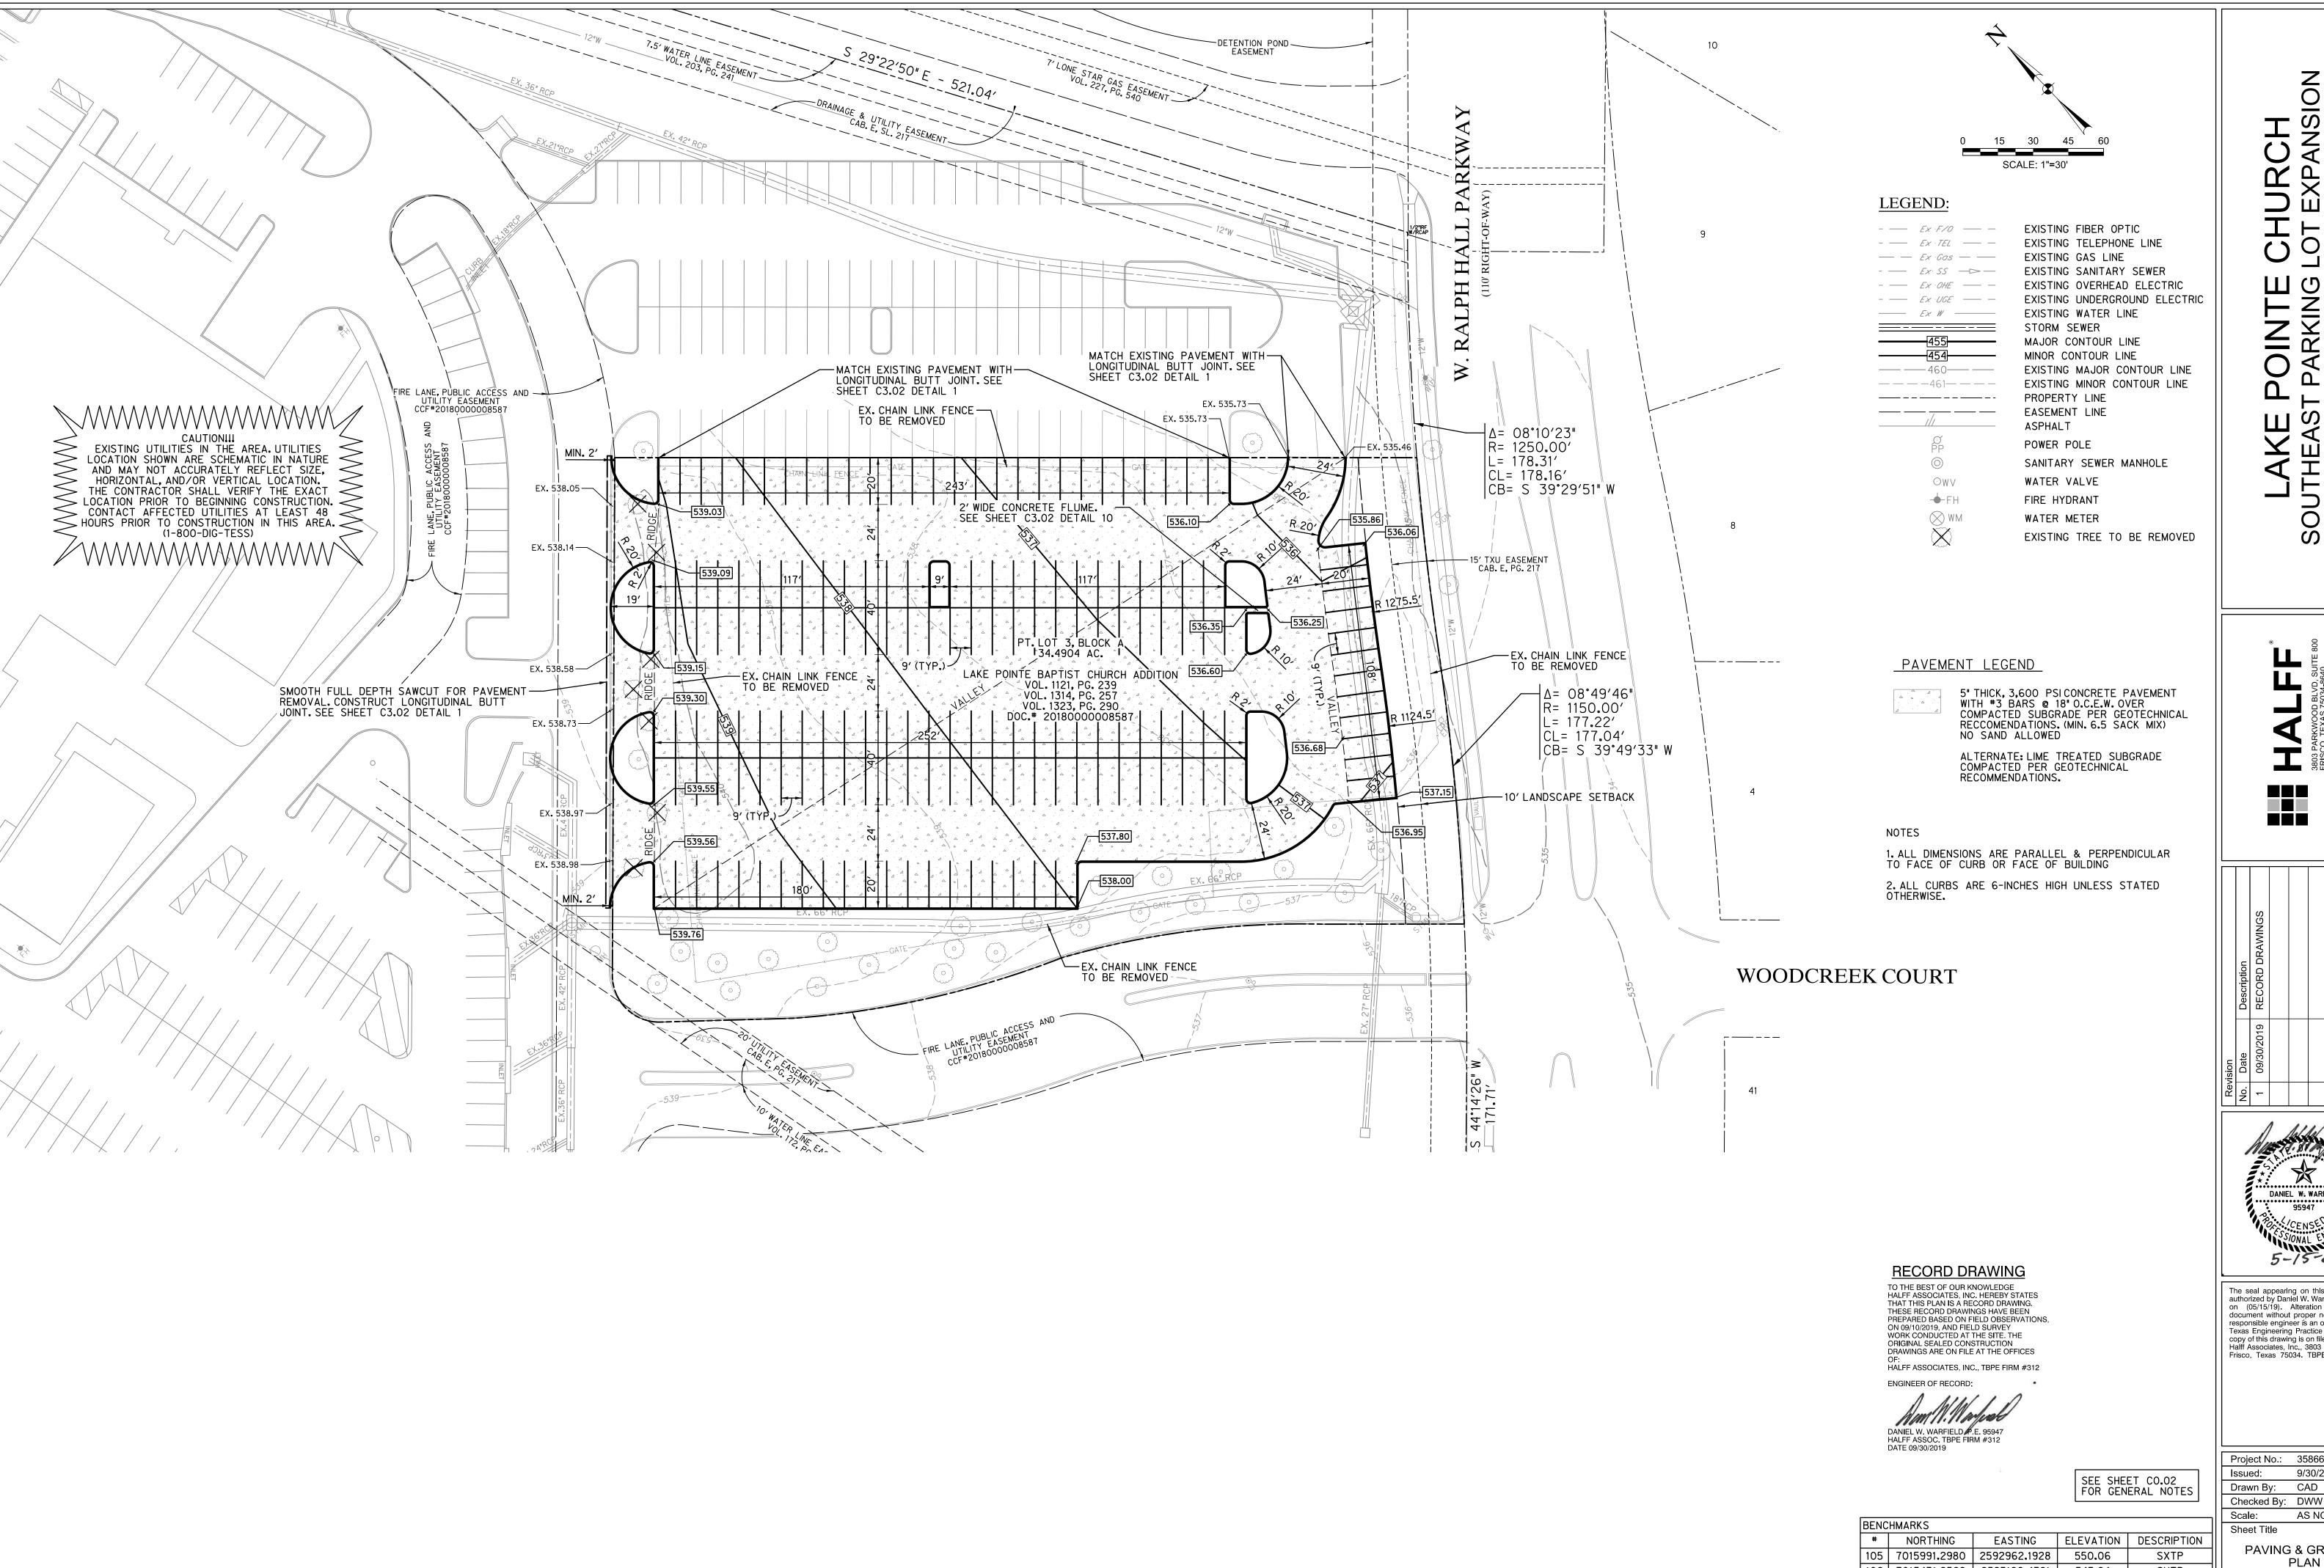

80

The seal appearing on this document was authorized by Daniel W. Warfield, P.E. 95947 on (05/15/19). Alteration of a sealed document without proper notification to the responsible engineer is an offense under the Texas Engineering Practice Act. The record copy of this drawing is on file at the offices of Halff Associates, Inc., 3803 Parkwood Blvd., Frisco, Texas 75034. TBPE FIRM #F-312.

Project No.: 35866 9/30/2019 CAD Checked By: DWW AS NOTED

PAVING & GRADING

C3.01

Sheet Number

106 7015431.9569 2593196.4381

2592947.0430

2593095.7245

322 7015977.2058 2593078.3578 549.54

320 7015521.4980

7015870.0270

543.24

546.21


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SXTP

SXTP

SXTP


SXTP

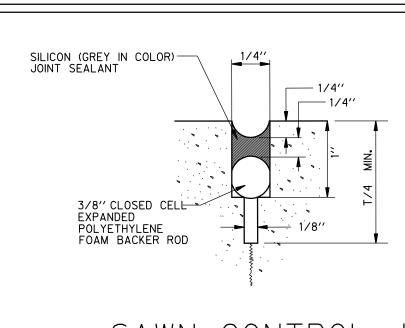

SAWN CONTROL JOINT (LONGITUDINAL & TRANSVERSE)

SEE SHEET C3.01 FOR PAVEMENT THICKNESS, CONCRETE COMPRESSIVE STRENGTH, AND REINFORCEMENT


- COMPACTED SUBGRADE PER GEOTECHNICAL RECOMMENDATIONS
ALTERNATE: LIME TREATED SUBGRADE COMPACTED PER GEOTECHNICAL RECOMMENDATIONS, NO SAND ALLOWED.

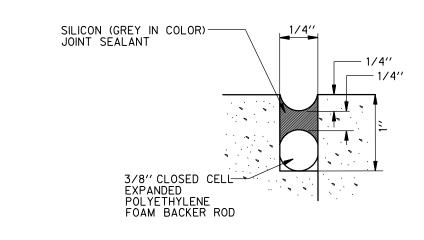



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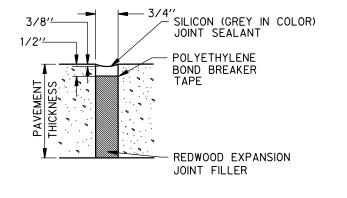
11'' ± 1/2''──

4" CLR MIN.




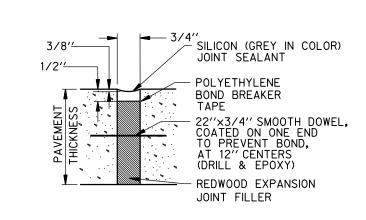


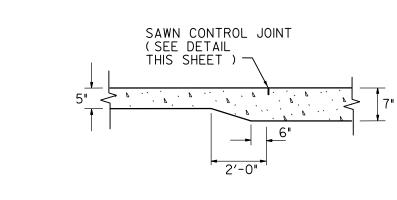

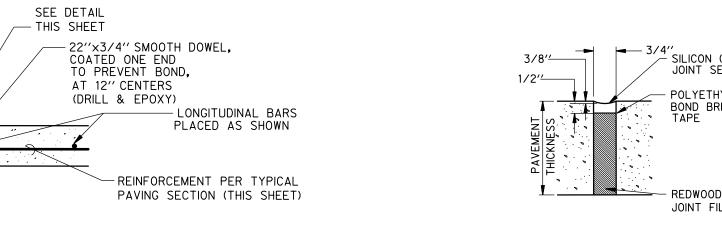



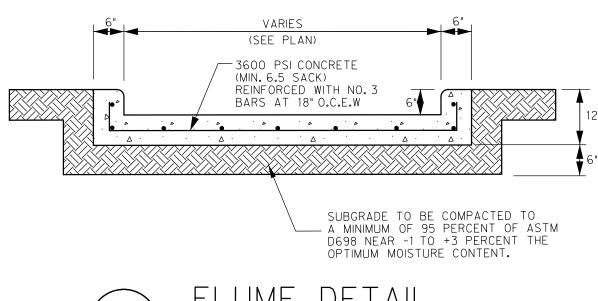


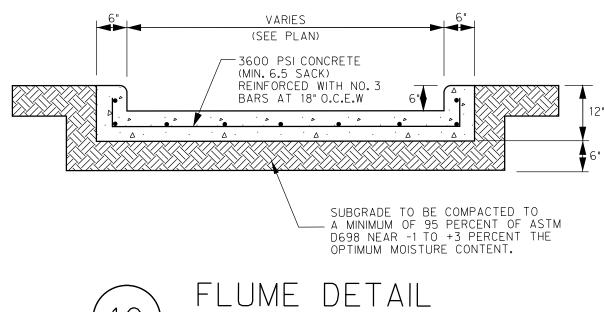





SOU

CHURCH OT EXPANSION III, TX 75087

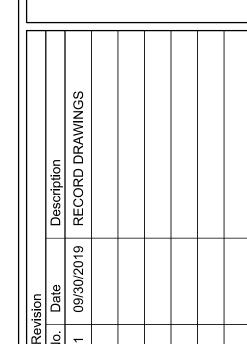

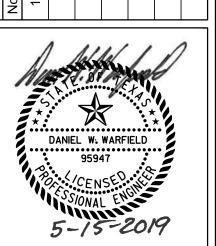

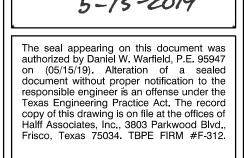

TO THE BEST OF OUR KNOWLEDGE HALFF ASSOCIATES, INC. HEREBY STATES THAT THIS PLAN IS A RECORD DRAWING. THESE RECORD DRAWINGS HAVE BEEN PREPARED BASED ON FIELD OBSERVATIONS ON 09/10/2019, AND FIELD SURVEY WORK CONDUCTED AT THE SITE. THE ORIGINAL SEALED CONSTRUCTION DRAWINGS ARE ON FILE AT THE OFFICES OF: HALFF ASSOCIATES, INC., TBPE FIRM #312	١,
ENGINEER OF RECORD:	
DANIEL W. WARFIELD P.E. 95947 HALFF ASSOC. TBPE FIRM #312 DATE 09/30/2019	

RECORD DRAWING

Project No.: 35866 Issued: 9/30/2019 Drawn By: CAD Checked By: DWW Scale: AS NOTED Sheet Title PAVING **DETAILS**

C3.02

Sheet Number


HAPTER 3 JANDSCAPE ARCHITECTS. THE RECORD COPY OF THIS RAWING IS ON FILE AT THE OFFICES OF HALFF ASSOCIATES, INC., 4000 FOSSIL CREEK BLUD. FORT WORTH, TX 76137-2720.

TBPE FIRM #F-312 Project No.: 35866 05.15.19 Issued: Drawn By: MAW Checked By: KMW Scale: Sheet Title

Sheet Number

TREESCAPE PLAN L1.01

Case No. SP2019-007

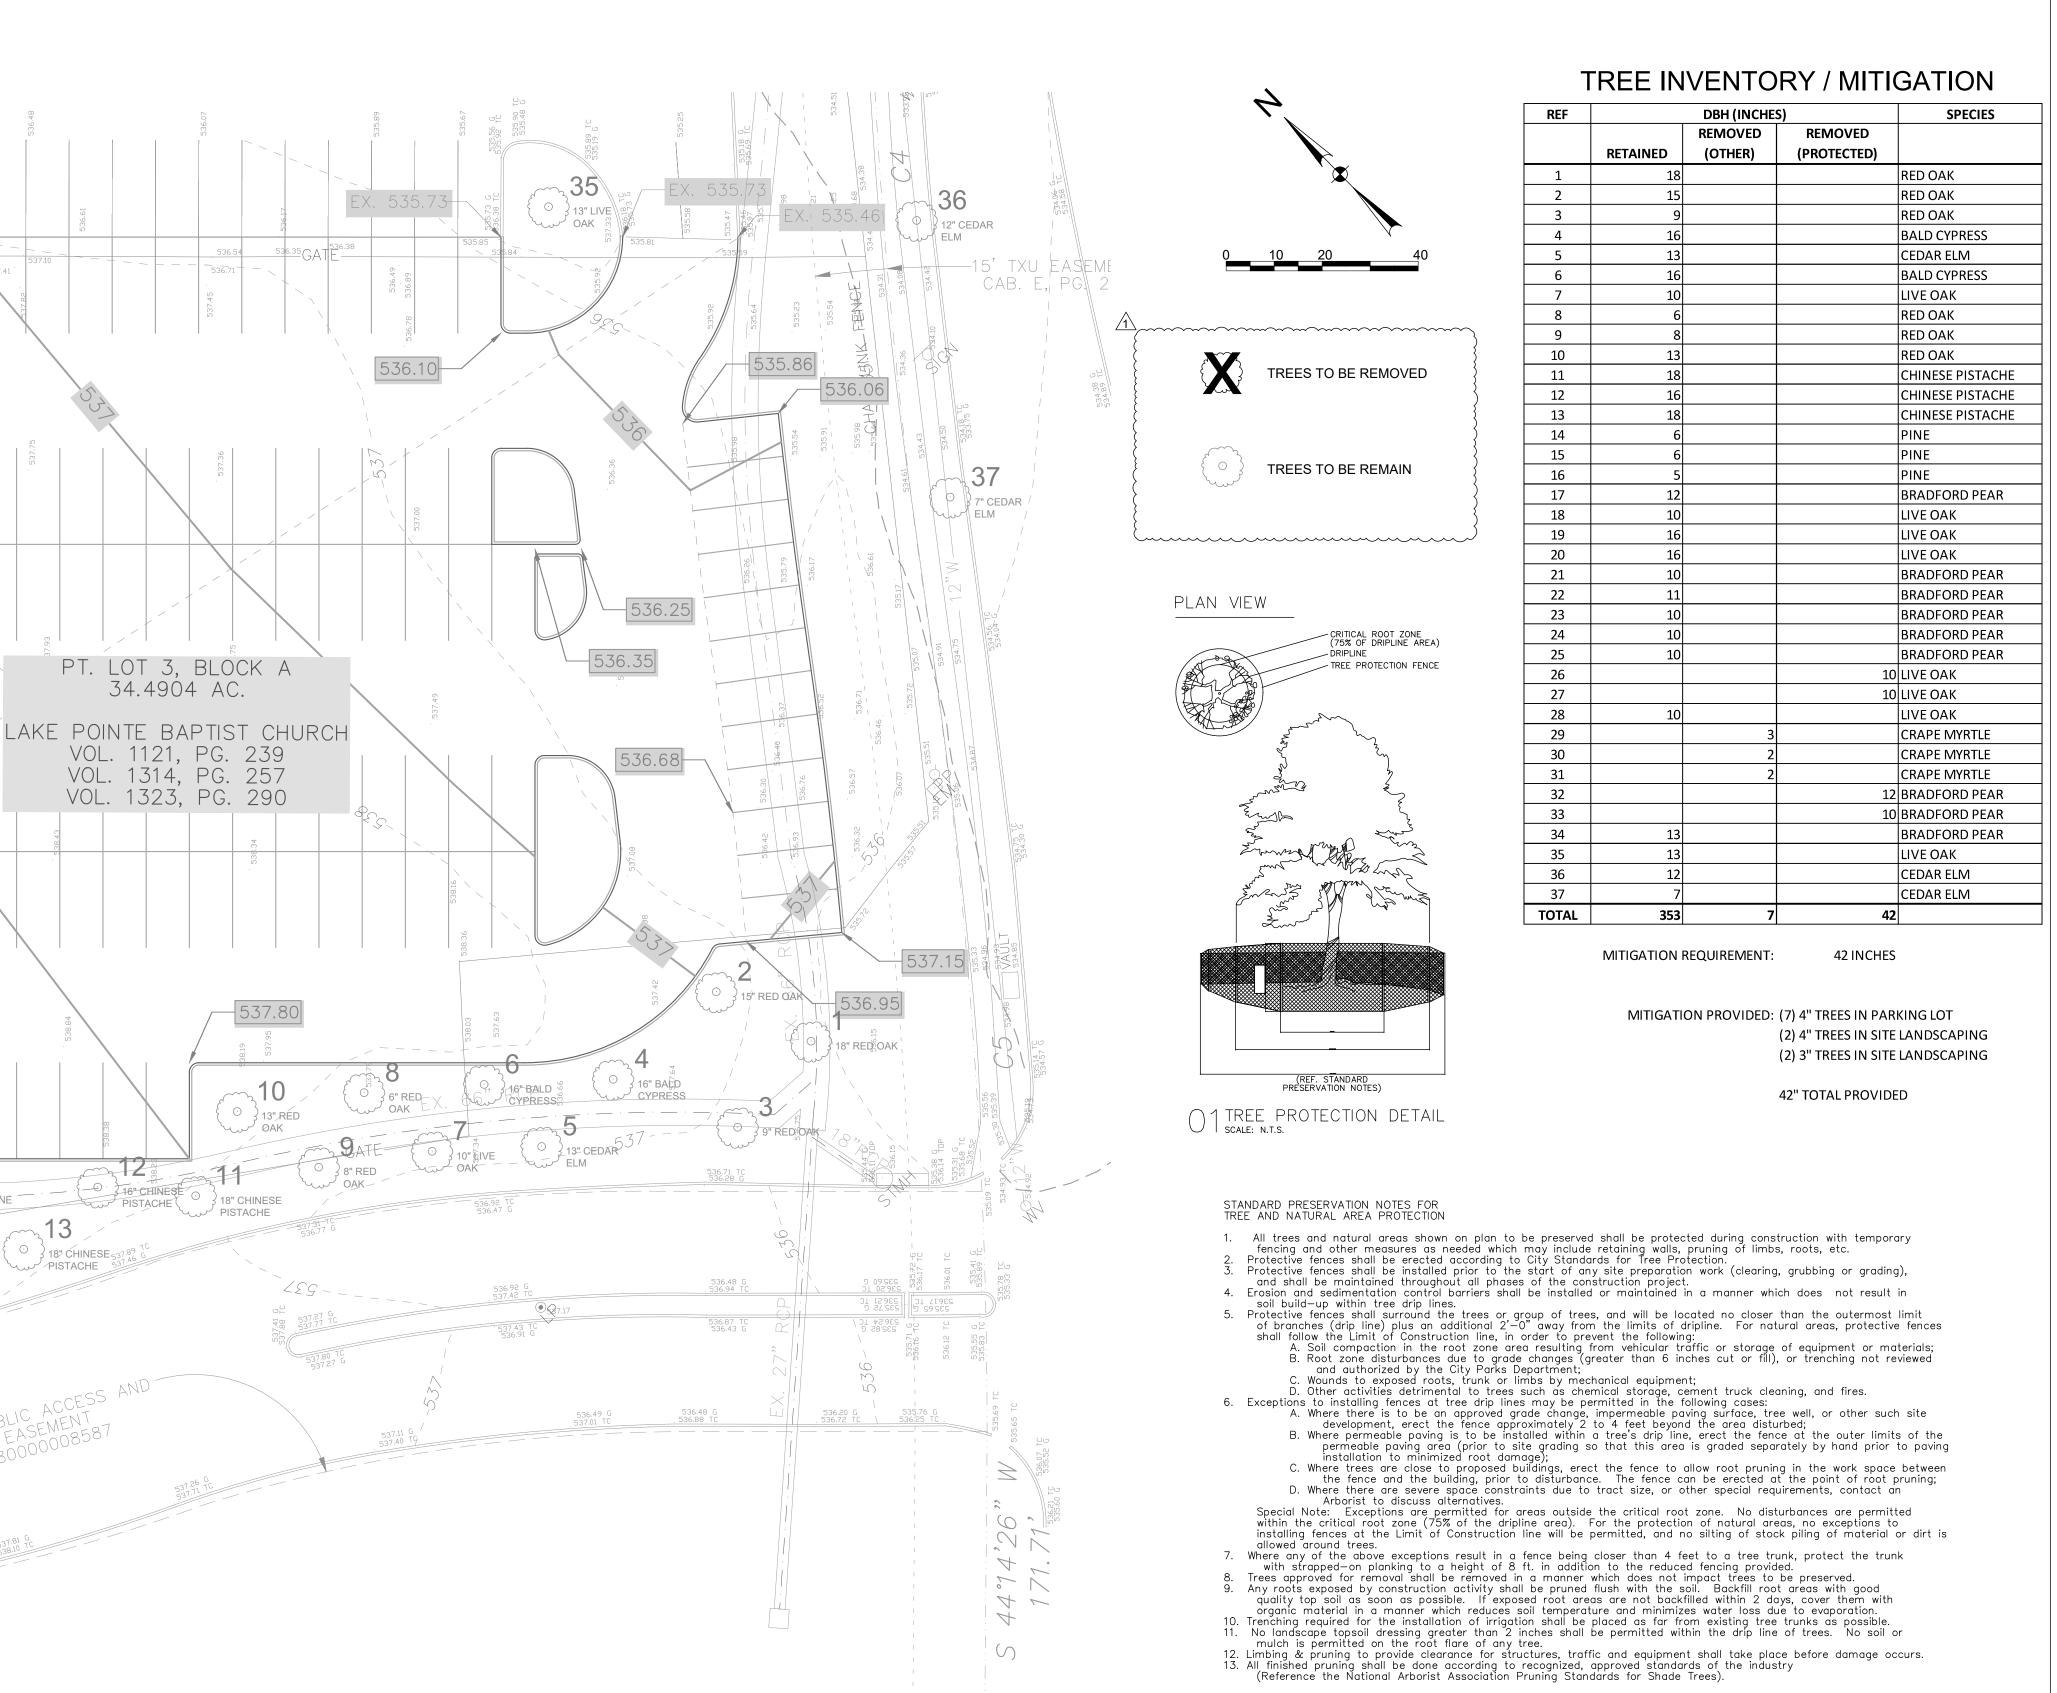

NOTE: NO TREES WITHIN 5' OF EXISTING UTILITES


TREE TO REMAIN, TYP.

10" BRADFORD PEAR

TREE TO BE REMOVED, TYP.


CHAIN LINK FENCE

18" CHINESE 537 PISTACHE 531

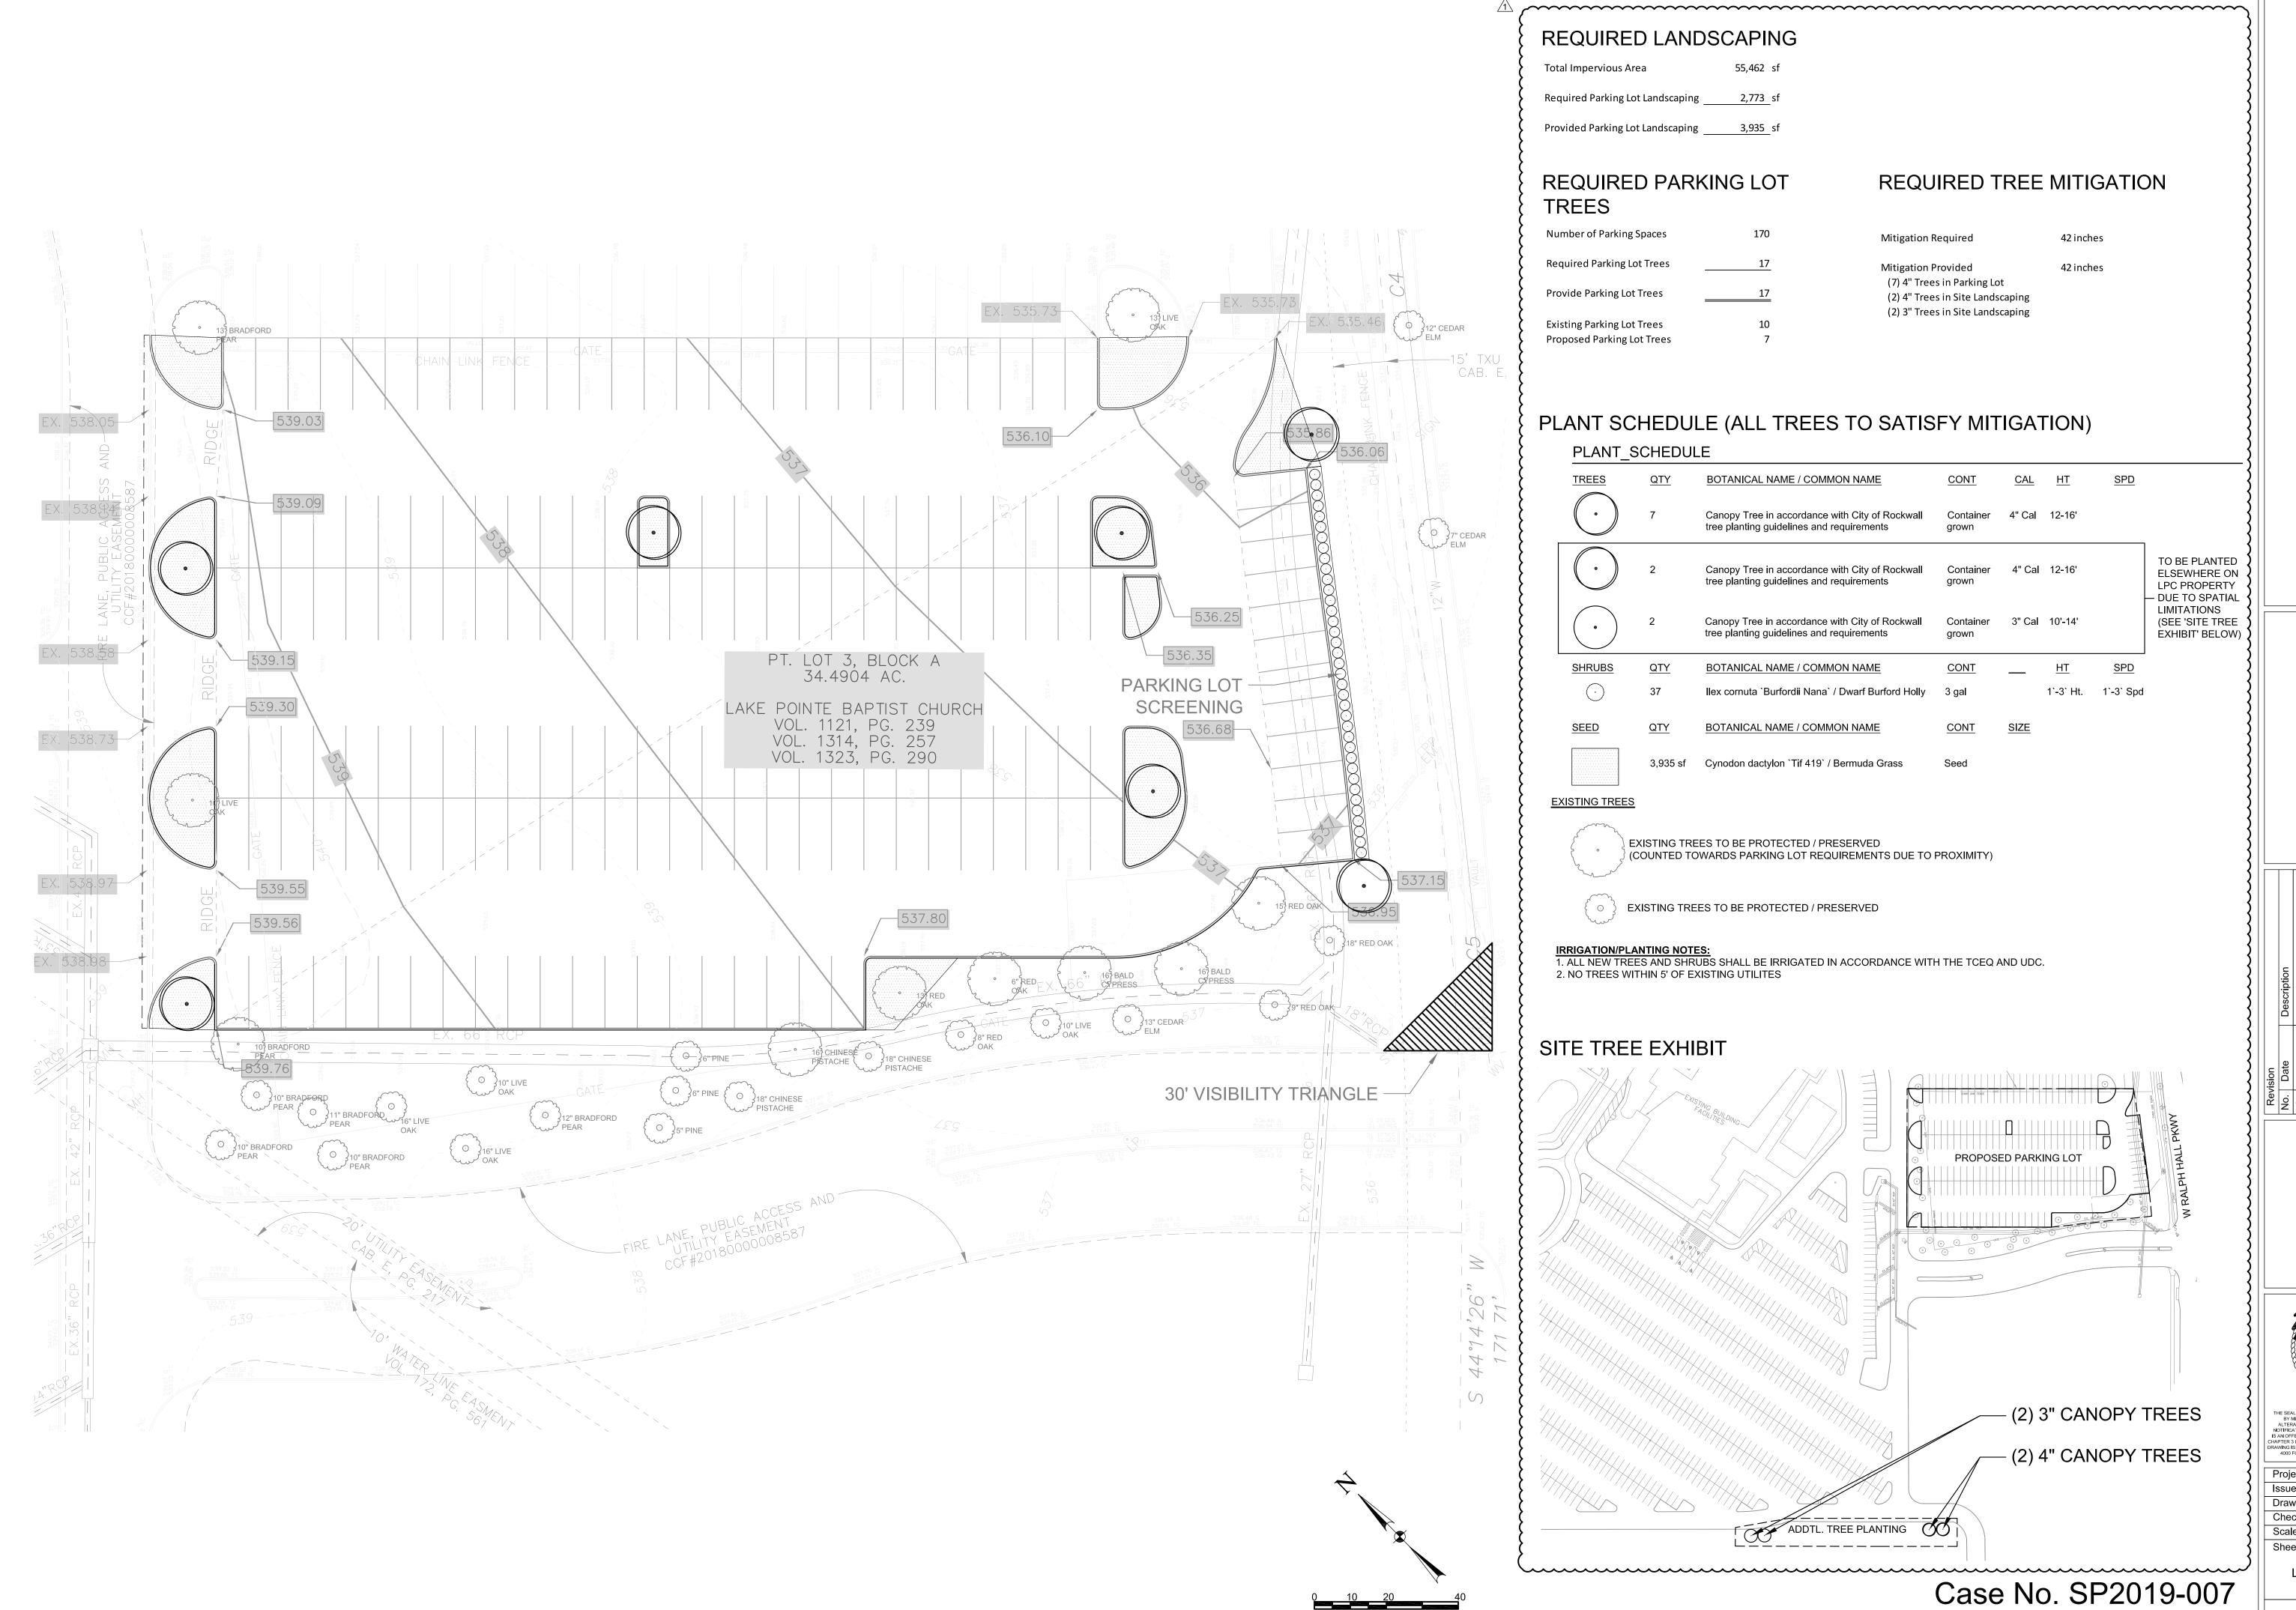

AKE POINTE CHURCH
PARKING LOT EXPANSION
701 Interstate 30 Rockwall, TX 75087

3803 PARKWOOD BLVD, SUITE 800 FRISCO, TEXAS 75034-8640 FAX (214) 618-4574 TBPE FIRM #F-312

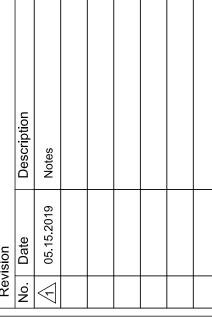



5-15-19

BE SEAL APPEARING ON THIS DOCUMENT WAS AUTHORIZED BY MICHAEL A. WILSON, R.L.A. #3088 ON 15 MAY 2019.
ALTERATION OF A SEALED DOCUMENT WITHOUT PROPER THE CALL OF THE C

Project No.: 35866
Issued: 05.15.19
Drawn By: MAW
Checked By: KMW


Sheet Title


LANDSCAPE PLAN

L2.01

VTE CHURCH OT EXPANSION OR Rockwall, TX 75087 **Z** 900 PARKING I



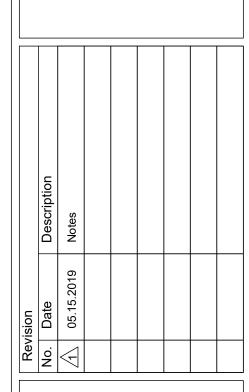

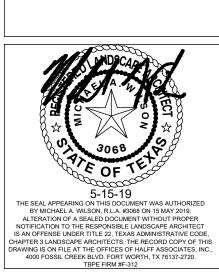


Project No.: 35866 05.15.19 Issued: Drawn By: MAW Checked By: KMW Scale: AS NOTED Sheet Title LANDSCAPE DETAILS

L3.01

Sheet Number

DO NOT HEAVILY PRUNE THE TREE AT PLANTING. PRUNE ONLY CROSSOVER LIMBS, CO-DOMINANT LEADERS, AND BROKEN AND DEAD BRANCHES. SOME INTERIOR TWIGS AND LATERAL BRANCHES MAY BE PRUNED; HOWEVER DO NOT MARK THE NORTH SIDE OF -THE TREE IN THE NURSERY AND ROTATE TREE TO FACE REMOVE THE TERMINAL BUDS OF BRANCHES THAT EXTEND TO THE EDGE OF THE CROWN. NORTH AT THE SITE "ARBOR TIE" GUYING MATERIAL. ATTACH 3'-0" (TYP.) TO EARTH ANCHOR. TIGHTEN ARBOR TIE ENOUGH TO KEEP FROM SLIPPING. ALLOW FOR TRUNK MOVEMENT. REMOVE ALL TWINE, ROPE AND WIRE, -AND BURLAP FROM TOP OF ROOT BALL. IF TREE IS SHIPPED WITH A WIRE BASKET AROUND THE ROOT BALL, CUT THE BASKET IN FOUR PLACES AND FOLD DOWN INTO PLANTING HOLE TO EXPOSE 90% OF ROOT BALL -EXPOSE ROOT FLARE. PLANT TREE SO THAT ROOT FLARE IS 3" ABOVE FINISHED PLACE ROOT BALL ON — UNEXCAVATED SOIL BACKFILL WITH PLANTING SOIL -— 6' HARDWOOD STAKE OR APPROVED MIX AND LIGHTLY COMPACT EQUAL. 3 PER TREE, EQUALLY SPACED AROUND TREE. TO BE SET IN EXISTING TO PREVENT ROOT BALL FROM — UNDISTURBED SOIL. SHIFTING, BACKFILL WITH — 3" MULCH LAYER. MULCH TO COVER PLANTING SOIL MIX. PLACE SOIL ROOT BALL AND TAPER IN DEPTH SO IN 6" LIFTS AND COMPACT ROOT FLARE REMAINS EXPOSED. DO NOT FIRMLY WITH FOOT PRESSURE. COVER ROOT FLARE. LAYER AND COMPACT SOIL UP TO THE MIDDLE OF THE ROOT — 4" HIGH MULCH SAUCER FINISH GRADE LIMITS OF DIGGING WITH BACKHOE OR OTHER HEAVY EQUIPMENT HAND DIG JUNDISTURBED SOIL X = ROOT BALL HEIGHT 1'-0" Y = ROOT BALL WIDTH

SINGLE TREE TRUNK WITH STAKES

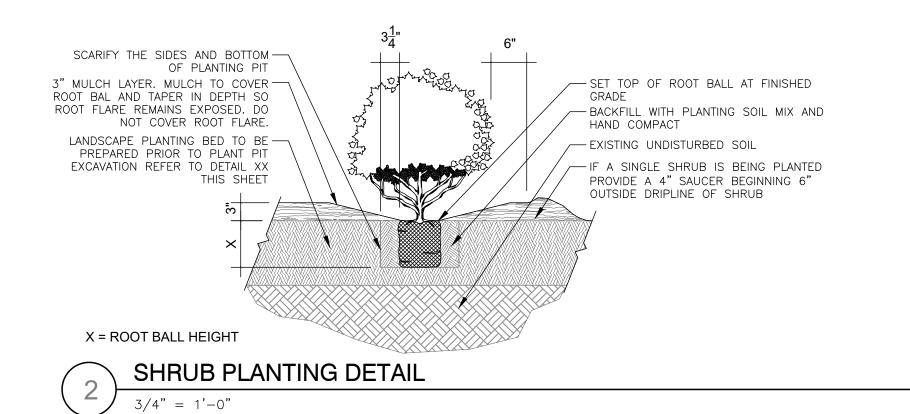

······ NOTE: NO TREES WITHIN 5' OF EXISTING UTILITES