# CORNERSTONE COMMUNITY CHURCH - LOT 1, BLOCK A

1565 AIRPORT ROAD ROCKWALL, TEXAS 75087


# CONSTRUCTION PLANS FEBRUARY 2018

# SHEET INDEX


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- 1B PLAT (BY OTHERS)
- C SITE PLAN (BY OTHERS)
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NOTE:
CITY OF ROCKWALL ENGINEERING DEPARTMENT LATEST STANDARD DETAILS AND NCTCOG 4TH EDITION SHALL BE USED FOR CONSTRUCTION OF THIS PROJECT UNLESS OTHERWISE NOTED WITHIN THESE PLANS. THE CONTRACTOR SHALL OBTAIN THE STANDARD DETAIL BOOK FROM THE CITY'S ENGINEERING DEPARTMENT.

CORNERSTONE COMMUNITY CHURCH
1950 ALPHA DRIVE
ROCKWALL, TEXAS 75087
(214) 771-4140

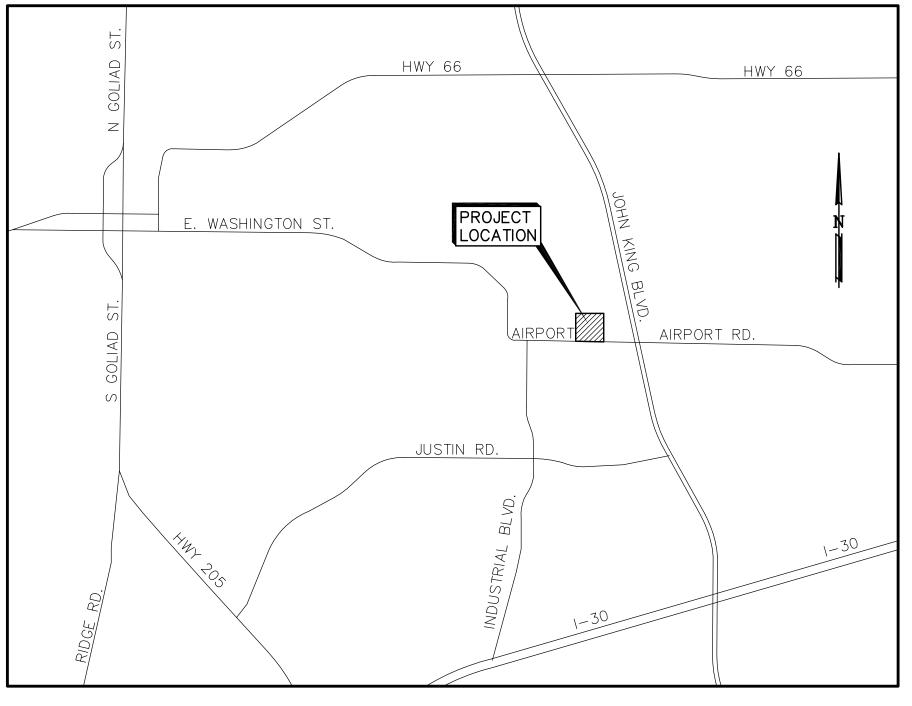

VICINITY MAP

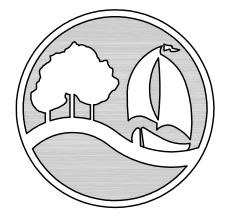

City of Rockwall
The New Horizon

PREPARED BY:

LAM CONSULTING ENGINEERING

6804 WILHELMINA DRIVE
SACHSE, TEXAS 75048
(214) 766-1011
www.lamcivil.com
Firm# F-9763

USE DETAILS AS OUTLINED IN THE STANDARD SPECIFICATIONS FOR PUBLIC WORKS CONSTRION, NORTH CENTRAL TEXAS, FOURTH EDITION AND CITY OF ROCKWALL STANDARDS OF DESIGN AND CONSTRUCTION.

ALL RESPONSIBILITY FOR ADEQUACY OF DESIGN REMAINS WITH THE DESIGN ENGINEER. THE CITY OF ROCKWALL, IN REVIEWING AND RELEASING PLANS FOR CONSTRUCTION, ASSUMES NO RESPONSIBILITY FOR ADEQUACY OR ACCURACY OF DESIGN.

## AS-BUILT PLANS

TO THE BEST OF OUR KNOWLEDGE LAM CONSULTING ENGINEERING, HEREBY STATES THAT THIS PLAN IS AS-BUILT. THIS INFORMATION PROVIDED IS BASED ON THE OWNER SURVEYOR SURVEYING AT THE SITE AND INFORMATION PROVIDED BY THE CONTRACTOR.

4/3/2020



THE SEAL APPEARING ON THIS DOCUMENT WAS AUTHORIZED BY TUAN P. LAM, P.E. 86968 ON 2/5/18. ALTERATION OF A SEALED DOCUMENT WITHOUT THE PROPER NOTIFICATION TO THE RESPONSIBLE ENGINEER IS AN OFFENSE UNDER THE TEXAS ENGINEERING PRACTICE ACT.

SURVEY INFORMATION ON THIS DRAWING WAS PROVIDED BY OTHERS. LAM CONSULTING ENGINEERING IS NOT RESPONSIBLE FOR THE ACCURACY OF THE TOPOGRAPHIC MAPPING NOR BENCHMARK DATUM.

THE INFORMATION SHOWN ON THIS PLAN IS FROM RECORD DRAWINGS. THE ENGINEER IS NOT RESPONSIBLE FOR THE ACCURACY OF THE INFORMATION SHOWN ON THIS DRAWING. CONTRACTOR SHALL FIELD VERIFY ALL UTILITIES AND CONTACT ALL UTILITY COMPANIES 48 HRS PRIOR TO ANY EXCAVATION. 1—800—DIG TESS

NYALL FILES/CROSS-439/ROCKWALL\CORNERSTONE CHURCH\2017 platting\CHURCH PLAT 2018-07-12.dwg. CHURCH FP. 7/12/2018 3:34:27

#### NOW, THEREFORE, KNOW ALL MEN BY THESE PRESENTS: STATE OF TEXAS **COUNTY OF ROCKWALL**

We, **CORNERSTONE COMMUNITY CHURCH of ROCKWALL, Inc** . the undersigned owner of the land shown on this plat, and designated herein as the CORNERSTONE COMMUNITY CHURCH ADDITION an Addition to the City of Rockwall, Texas, and whose name is subscribed hereto, hereby dedicate to the use of the public forever all streets, alleys, parks, water courses, drains, easements and public places thereon shown on the purpose and consideration therein expressed. We further certify that all other parties who have a mortgage or lien interest in **CORNERSTONE COMMUNITY CHURCH ADDITION** have been notified and signed this plat. We understand and do hereby reserve the easement strips shown on this plat for the purposes stated and for the mutual use and accommodation of all utilities desiring to use or using same. We also understand the following;

- 1. No buildings shall be constructed or placed upon, over, or across the utility easements as described
- 2. Any public utility shall have the right to remove and keep removed all or part of any buildings, fences, trees, shrubs, or other growths or improvements which in any way endanger or interfere with construction, maintenance or efficiency of their respective system on any of these easement strips; and any public utility shall at all times have the right of ingress or egress to, from and upon the said easement strips for purpose of construction, reconstruction, inspecting, patrolling, maintaining, and either adding to or removing all or part of their respective system without the necessity of, at any time, procuring the permission of anyone.
- 3. The City of Rockwall will not be responsible for any claims of any nature resulting from or occasioned by the establishment of grade of streets in the subdivision.
- 4. The developer and subdivision engineer shall bear total responsibility for storm drain improvements.
- 5. The developer shall be responsible for the necessary facilities to provide drainage patterns and drainage controls such that properties within the drainage area are not adversely affected by storm drainage from the development.
- 6. No house dwelling unit, or other structure shall be constructed on any lot in this addition by the owner or any other person until the developer and/or owner has complied with all requirements of the Subdivision Regulations of the City of Rockwall regarding improvements with respect to the entire block on the street or streets on which property abuts, including the actual installation of streets with the required base and paving, curb and gutter, water and sewer, drainage structures, storm structures, storm sewers, and alleys, all according to the specifications of the City of Rockwall;
- 7. Property owner is responsible for maintenance, repair, and replacement of all detention and drainage facilities in easements;

Until an escrow deposit, sufficient to pay for the cost of such improvements, as determined by the city's engineer and/or city administrator, computed on a private commercial rate basis, has been made with the city secretary, accompanied by an agreement signed by the developer and/or owner, authorizing the city to make such improvements at prevailing private commercial rates, or have the same made by a contractor and pay for the same out of the escrow deposit, should the developer and/or owner fail or refuse to install the required improvements within the time stated in such written agreement, but in no case shall the City be obligated to make such improvements itself. Such deposit may be used by the owner and/or developer as progress payments as the work progresses in making such improvements by making certified requisitions to the city secretary, supported by evidence of work done; or

Until the developer and/or owner files a corporate surety bond with the city secretary in a sum equal to the cost of such improvements for the designated area, guaranteeing the installation thereof within the time stated in the bond, which time shall be fixed by the city council of the City of Rockwall.

We further acknowledge that the dedications and/or exaction's made herein are proportional to the impact of the Subdivision upon the public services required in order that the development will comport with the present and future growth needs of the City; We, my (our) successors and assigns hereby waive any claim, damage, or cause of action that We may have as a result of the dedication of exactions made herein.

CORNERSTONE COMMUNITY CHURCH of ROCKWALL, INC.

Name:	DOUG FOX		
Title:			
STATE OF	TEXAS	§	
COUNTY	OF ROCKWALL	§	
	e, the undersigned a	• •	

y appeared Doug Fox, known to me to be the person whose name is subscribed to the foregoing instrument, and acknowledged to me that he executed the same for the purpose and consideration therein stated.

Given upon my hand and seal of office this \_\_\_\_\_ day of \_

#### **OWNER'S CERTIFICATE**

#### **STATE OF TEXAS** COUNTY OF ROCKWALL §

WHEREAS, CORNERSTONE COMMUNITY CHURCH of ROCKWALL, INC. are the owners of a 6.000 acre tract of land situated in the N. Butler Survey, Abstract No. 20, City of Rockwall, Rockwall County, Texas and being all of a called 6.000 acre tract of land described in a deed to K. R. Smith Holdings, LLC recorded in cc# 2017000001154, Official Pubic Records Rockwall County, Texas (OPRRCT) and being more particularly described as follows:

**BEGINNING** at a capped iron rod found for corner in the north line of Airport Road a variable width right of way and being the southwest corner of said 6 acre tract and the southeast corner of Lot 4, Block A of Columbia Park Addition an addition to the City of Rockwall according to the plat recorded in Envelope H, Slide 329, Plat Records Rockwall County, Texas (PRRCT);

THENCE along the common line of said 6 acre tract and Lot 4, NORTH 00°22'33" EAST a distance of 588.04 feet to a capped iron rod found for corner;

THENCE SOUTH 62°32'11" EAST a distance of 654.99 feet to a 3/8 inch iron rod found for corner;

THENCE SOUTH 69°44'24" EAST a distance of 14.21 feet to a capped iron rod found for corner;

THENCE SOUTH 00°22'33" WEST a distance of 290.21 feet to a capped iron rod found for corner in the north line of said Airport Road;

THENCE along the north line of said Airport Road, NORTH 89°07'10" WEST a distance of **596.53** feet to the **POINT OF BEGINNING**;


CONTAINING 6.000 acres or 261,357 square feet of land more or less.

#### SURVEYOR'S CERTIFICATE

NOW. THEREFORE KNOW ALL MEN BY THESE PRESENTS:

THAT I, Austin J. Bedford, do hereby certify that I prepared this plat from an actual and accurate survey of the land, and that the corner monuments shown thereon were properly placed under my personal supervision.

Austin J. Bedford Registered Professional Land Surveyor No. 4132 A.J. Bedford Group, Inc. 301 North Alamo Road Rockwall, Texas 75087

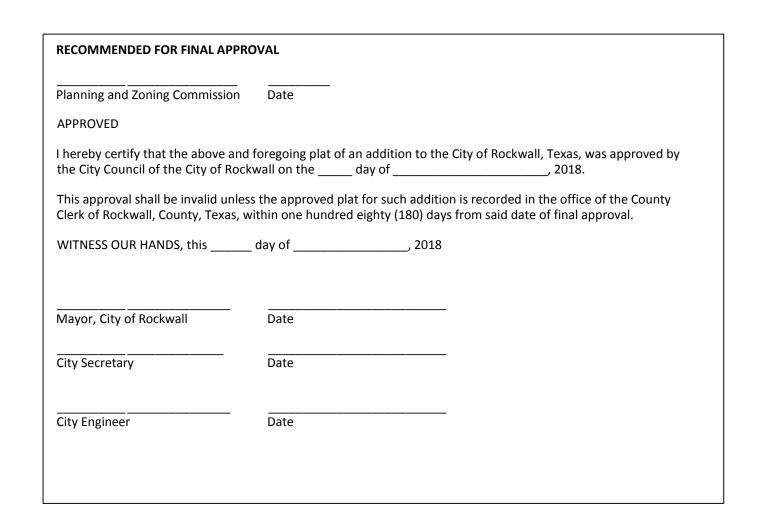

FINAL PLAT CORNERSTONE COMMUNITY CHURCH ADDITION LOT 1, BLOCK A

BEING A 6.00-ACRE PARCEL OF LAND IDENTIFIED AS TRACT 4-07 OF THE N. BUTLER SURVEY, ABSTRACT NO. 20 CITY OF ROCKWALL, ROCKWALL COUNTY, TEXAS

Cornerstone Community Church


of Rockwall Inc.

1565 Airport Road Rockwall, Texas 75087 1

er: Lam Consulting Engineering

Sachse, Texas 75048


214-766-1011

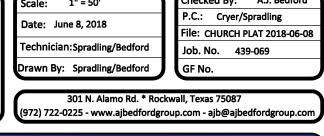

CASE NO. P2018-017



TBPLS REG#10118200

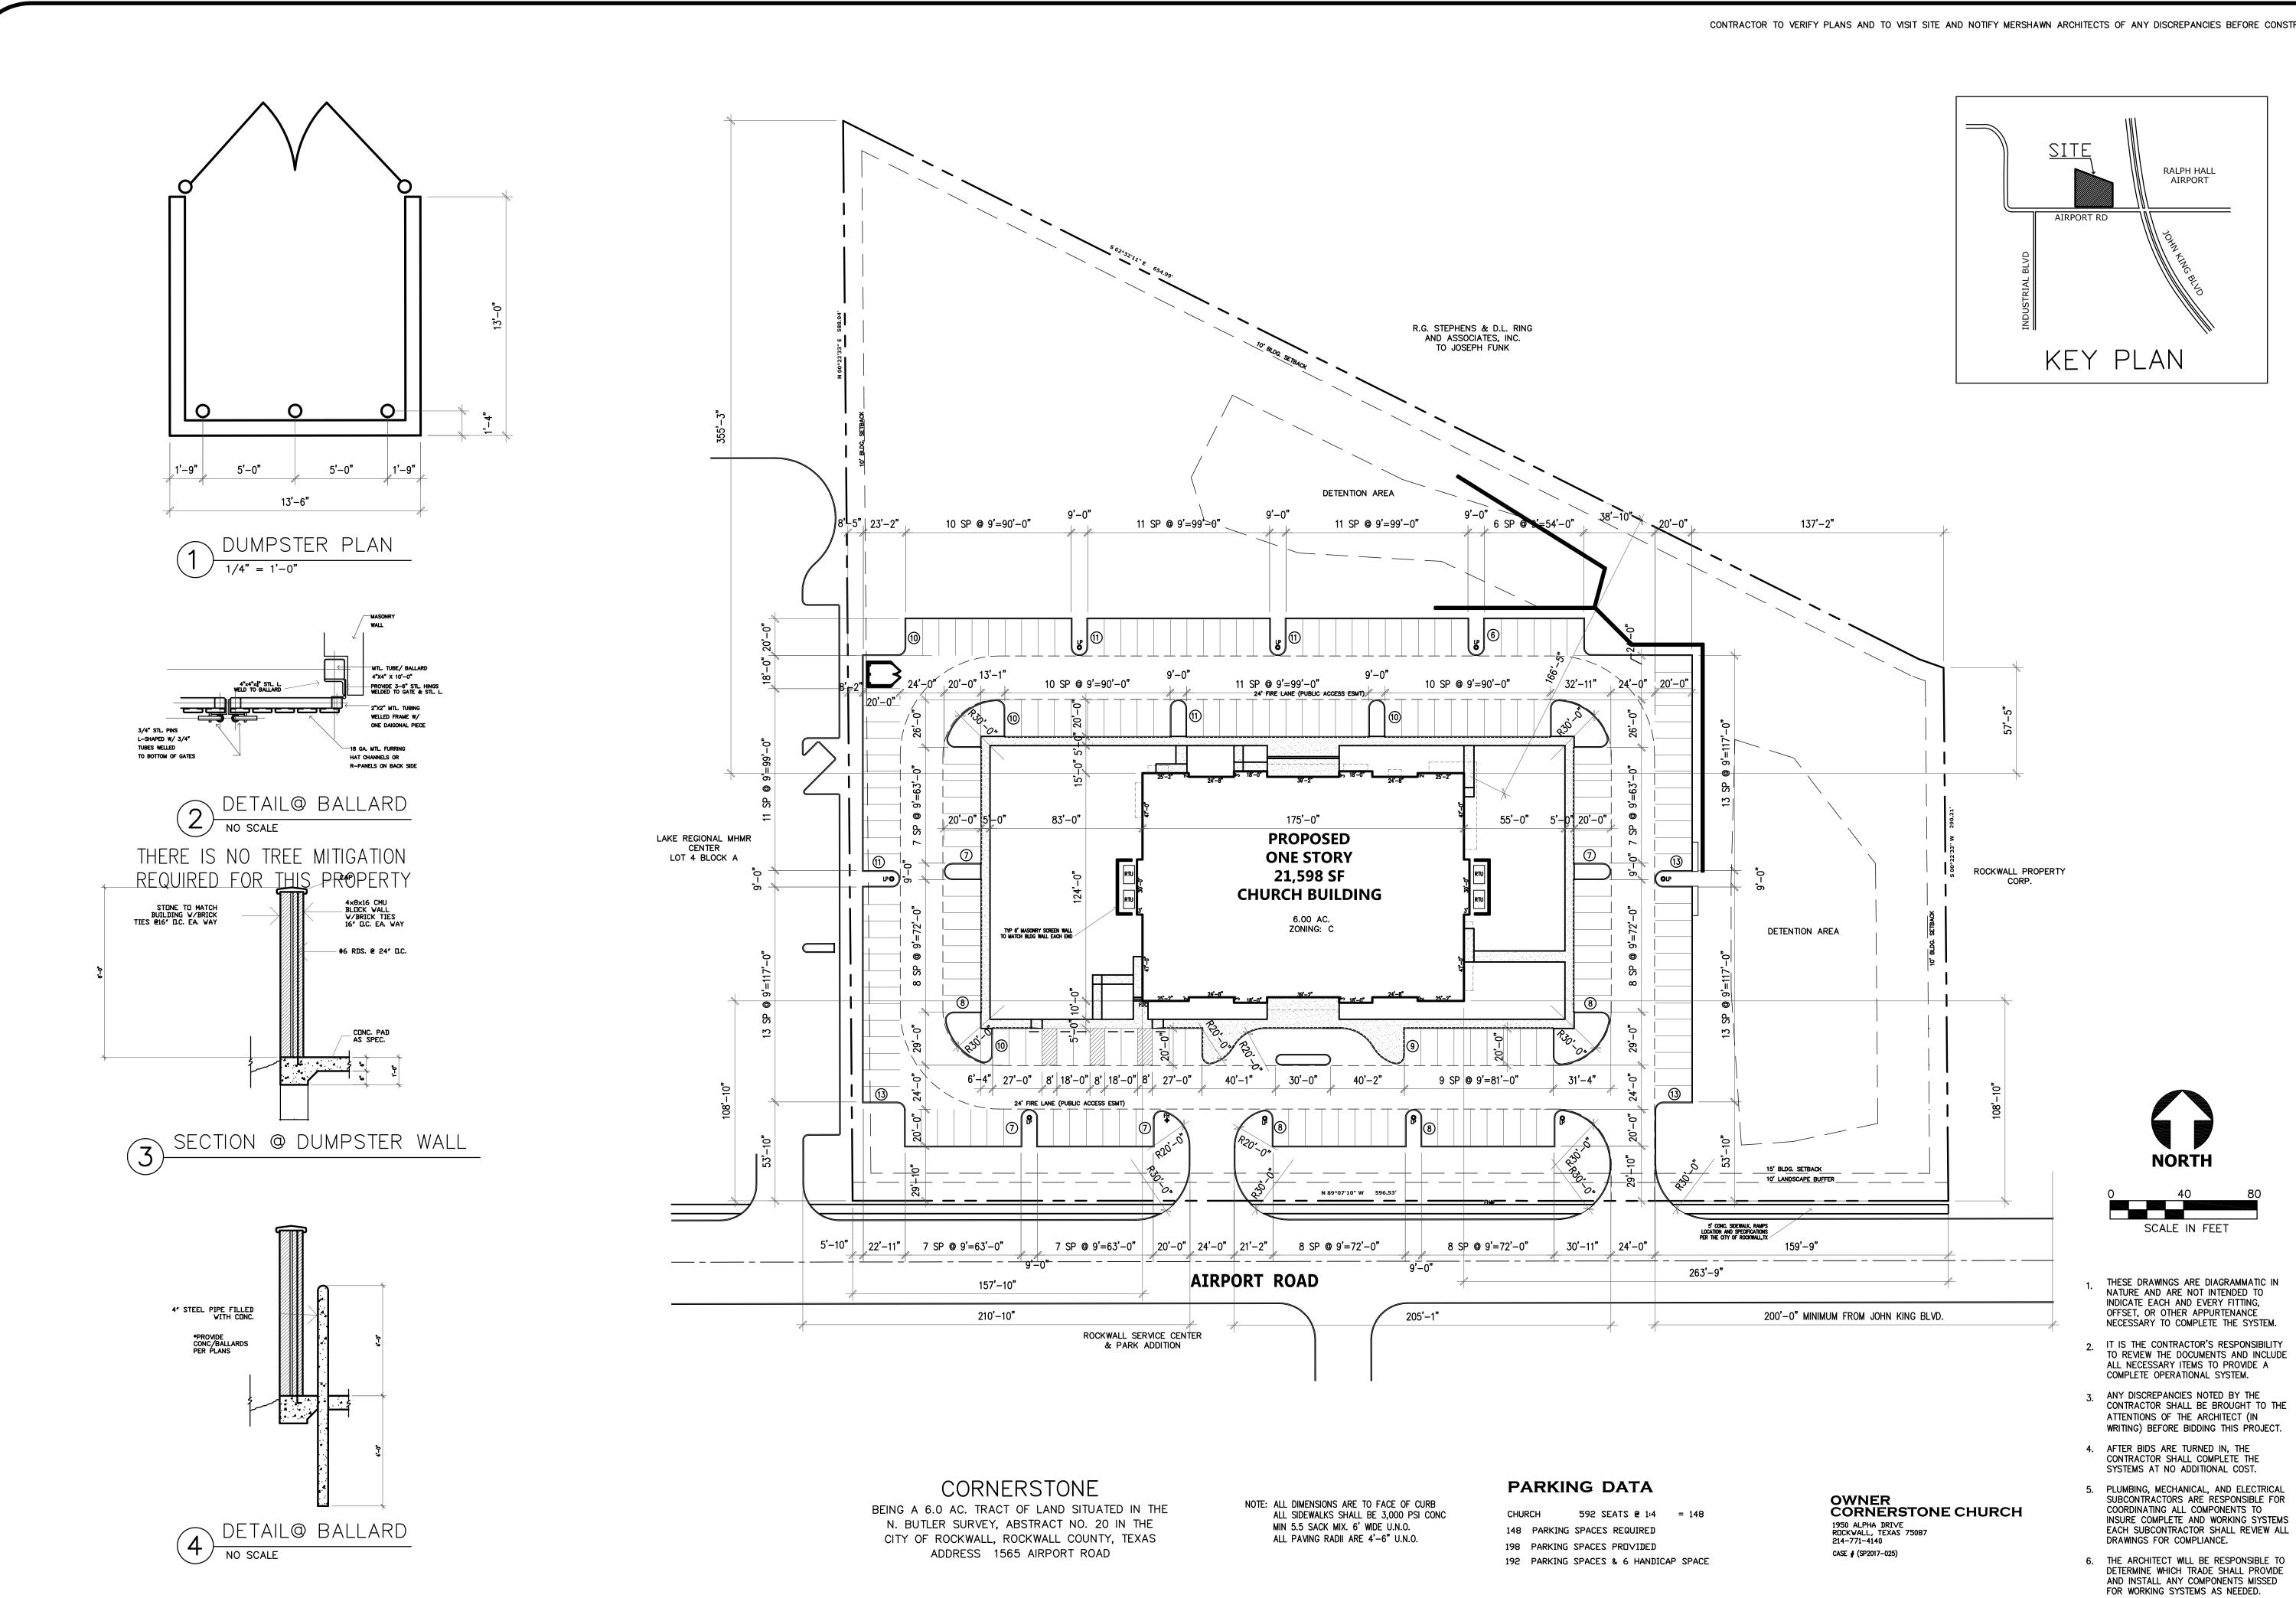

Scale: 1" = 40'-0"

Date: 08/24/17

Project No.: 170201

Designed: GW

Drawn: GW

Checked: WM

SHEET

CORNERSTONE COMMUNITY ROCKWALL, TEXAS

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DATE: 8/24/17

EXISTING CEDAR AND HACKBERRY



LIVE OAKS (61) INSTALLED WITH A MIN. 4" CALIPER

RED BUD (2) 4' HIGH @ INSTALLATION

INDIAN HAWTHORNE (23) PARKING SCREEN PLANTS SHALL BE A MINIMUM OF 5-GALLONS W/A MINIMUM HEIGHT @ PLANTING OF 15" & SHALL CREATE A MINIMUM 2' TALL SCREEN WITHIN TWO YEARS OF PLANTING. SHALL BE PLANTED @ 36" O.C.

BOXWOOD BUSH (58) PLANTS SHALL BE A MINIMUM OF 5-GALLONS W/A MINIMUM HEIGHT @ PLANTING OF 15" & SHALL CREATE A MINIMUM 2' TALL SCREEN WITHIN TWO YEARS OF PLANTING. SHALL BE PLANTED @ 36" O.C.

ALL AREAS NOT SHOWN AS SPECIFIC PLANT MATERIAL SHALL BE HYDROMULCHED, BERMUDA.

IN ORDER TO MEET BUDGET TREES SPECIFIED MAY NOT BE USED OTHER TREES FROM THE APPROVED CITY OF ROCKWALL PLANT LIST MAY BE SUITABLE FOR SUBSTITUTION.

REQUIRED LANDSCAPE AREAS SHALL BE IRRIGATED BY AN AUTOMATIC UNDERGROUND IRRIGATION SYSTEM. SYSTEM SHALL HAVE FREEZE GUARD AND RAINSTAT.

CONTRACTOR SHALL SUPPLY SLEEVES AS NEEDED FOR IRRIGATION.


TREES AND PLANTS SHALL BE PLANTED NO CLOSER THAN WITHIN 4' OF CURB AT PARKING SPACES AND NO CLOSER THAN 5' FROM ANY WATER, SEWER, OR STORM SEWER LINES.

THERE IS NO TREE MITIGATION REQUIRED FOR THIS PROPERTY

#### ABSTRACT NO. 20 -N. BUTLER SURVEY

- 1. ZONING: C COMERCIAL 2. PROPOSED USE: CHURCH
- 3. PROPERTY AREA (GROSS): 261,357.0 SF 6.0 AC
- 4. BUILDING AREA: 21,598 SF
- 5. BUILDING HEIGHT: SINGLE STORY 37'-0" 6. LOT COVERAGE: 8.3% F.A.R. = 0.008:1
- 7. PARKING REQUIRED: 3 SPACE/SEAT 592/3 = 197 SPACES REQUIRED
- 8. HANDICAP REQUIRED 6 ACCESSIBLE IN 150-200 SPACES 6 ACCESSIBLE PROVIDED
- 9. TOTAL PARKING PROVIDED: 198 SPACES
- 10. TOTAL SQUARE FOOTAGE OF IMPERVIOUS SURFACE: 100,300 SF


		REQUIRED	PR□VIDED
1.	STREET TREES 1 CANDPY PER 50'	12	12
2.	SITE TREES - DNE TREE W/ A CALIPER DF AT LEAST 2" FDR EACH 20,000 SF DF PARKING, 1 PER EVERY TEN REQ. PARKING SPACES	20	20
3.	LANDSCAPE BUFFER	10′	10′
4.	SCREENING OF OFF STREET PARKING	YES	YES
5.	DETENTION AREA 25,742 SF / 750 SF	34	34
6.	TOTAL LANDSCAPE AREA 10% REQUIRED	39,204 SF	161,057 SF

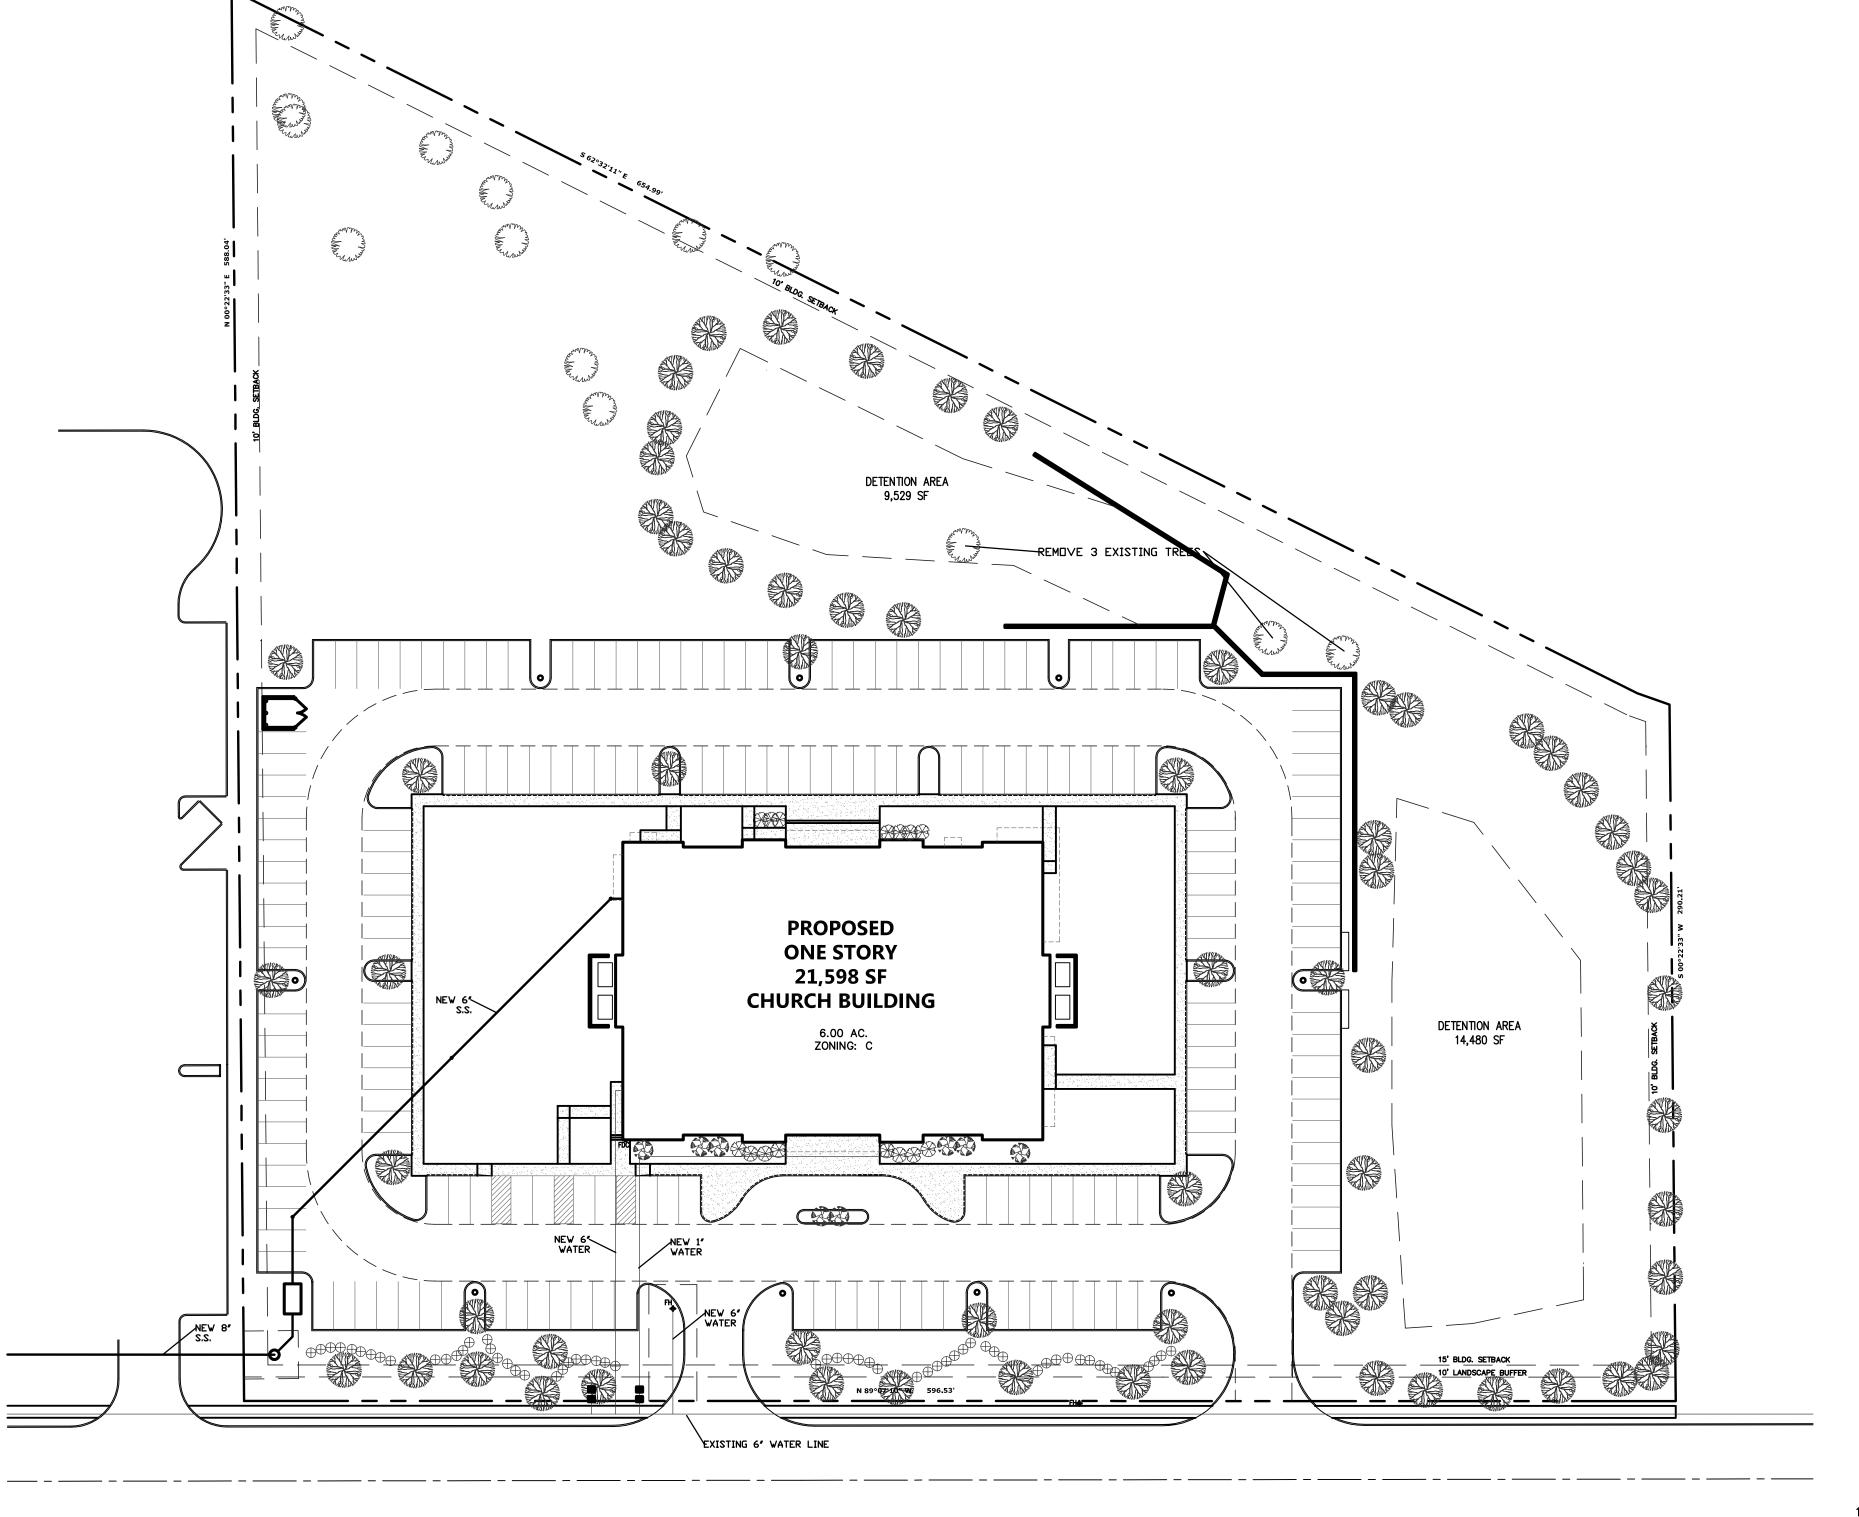


CORNERSTONE

BEING A 6.0 AC. TRACT OF LAND SITUATED IN THE N. BUTLER SURVEY, ABSTRACT NO. 20 IN THE CITY OF ROCKWALL, ROCKWALL COUNTY, TEXAS ADDRESS 1565 AIRPORT ROAD

OWNER CORNERSTONE CHURCH 1950 ALPHA DRIVE ROCKWALL, TEXAS 75087 214-771-4140 CASE # (SP2017-025)

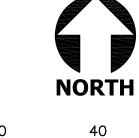

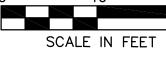

THESE DRAWINGS ARE DIAGRAMMATIC IN NATURE AND ARE NOT INTENDED TO INDICATE EACH AND EVERY FITTING, OFFSET, OR OTHER APPURTENANCE NECESSARY TO COMPLETE THE SYSTEM.

2 IT IS THE CONTRACTOR'S RESPONSIBILITY TO REVIEW THE DOCUMENTS AND INCLUDE ALL NECESSARY ITEMS TO PROVIDE A COMPLETE OPERATIONAL SYSTEM.

3. ANY DISCREPANCIES NOTED BY THE CONTRACTOR SHALL BE BROUGHT TO THE ATTENTIONS OF THE ARCHITECT (IN WRITING) BEFORE BIDDING THIS PROJECT.

4. AFTER BIDS ARE TURNED IN, THE CONTRACTOR SHALL COMPLETE THE SYSTEMS AT NO ADDITIONAL COST.

5. PLUMBING, MECHANICAL, AND ELECTRICAL SUBCONTRACTORS ARE RESPONSIBLE FOR COORDINATING ALL COMPONENTS TO INSURE COMPLETE AND WORKING SYSTEMS EACH SUBCONTRACTOR SHALL REVIEW ALL DRAWINGS FOR COMPLIANCE.

6. THE ARCHITECT WILL BE RESPONSIBLE TO DETERMINE WHICH TRADE SHALL PROVIDE AND INSTALL ANY COMPONENTS MISSED FOR WORKING SYSTEMS AS NEEDED.

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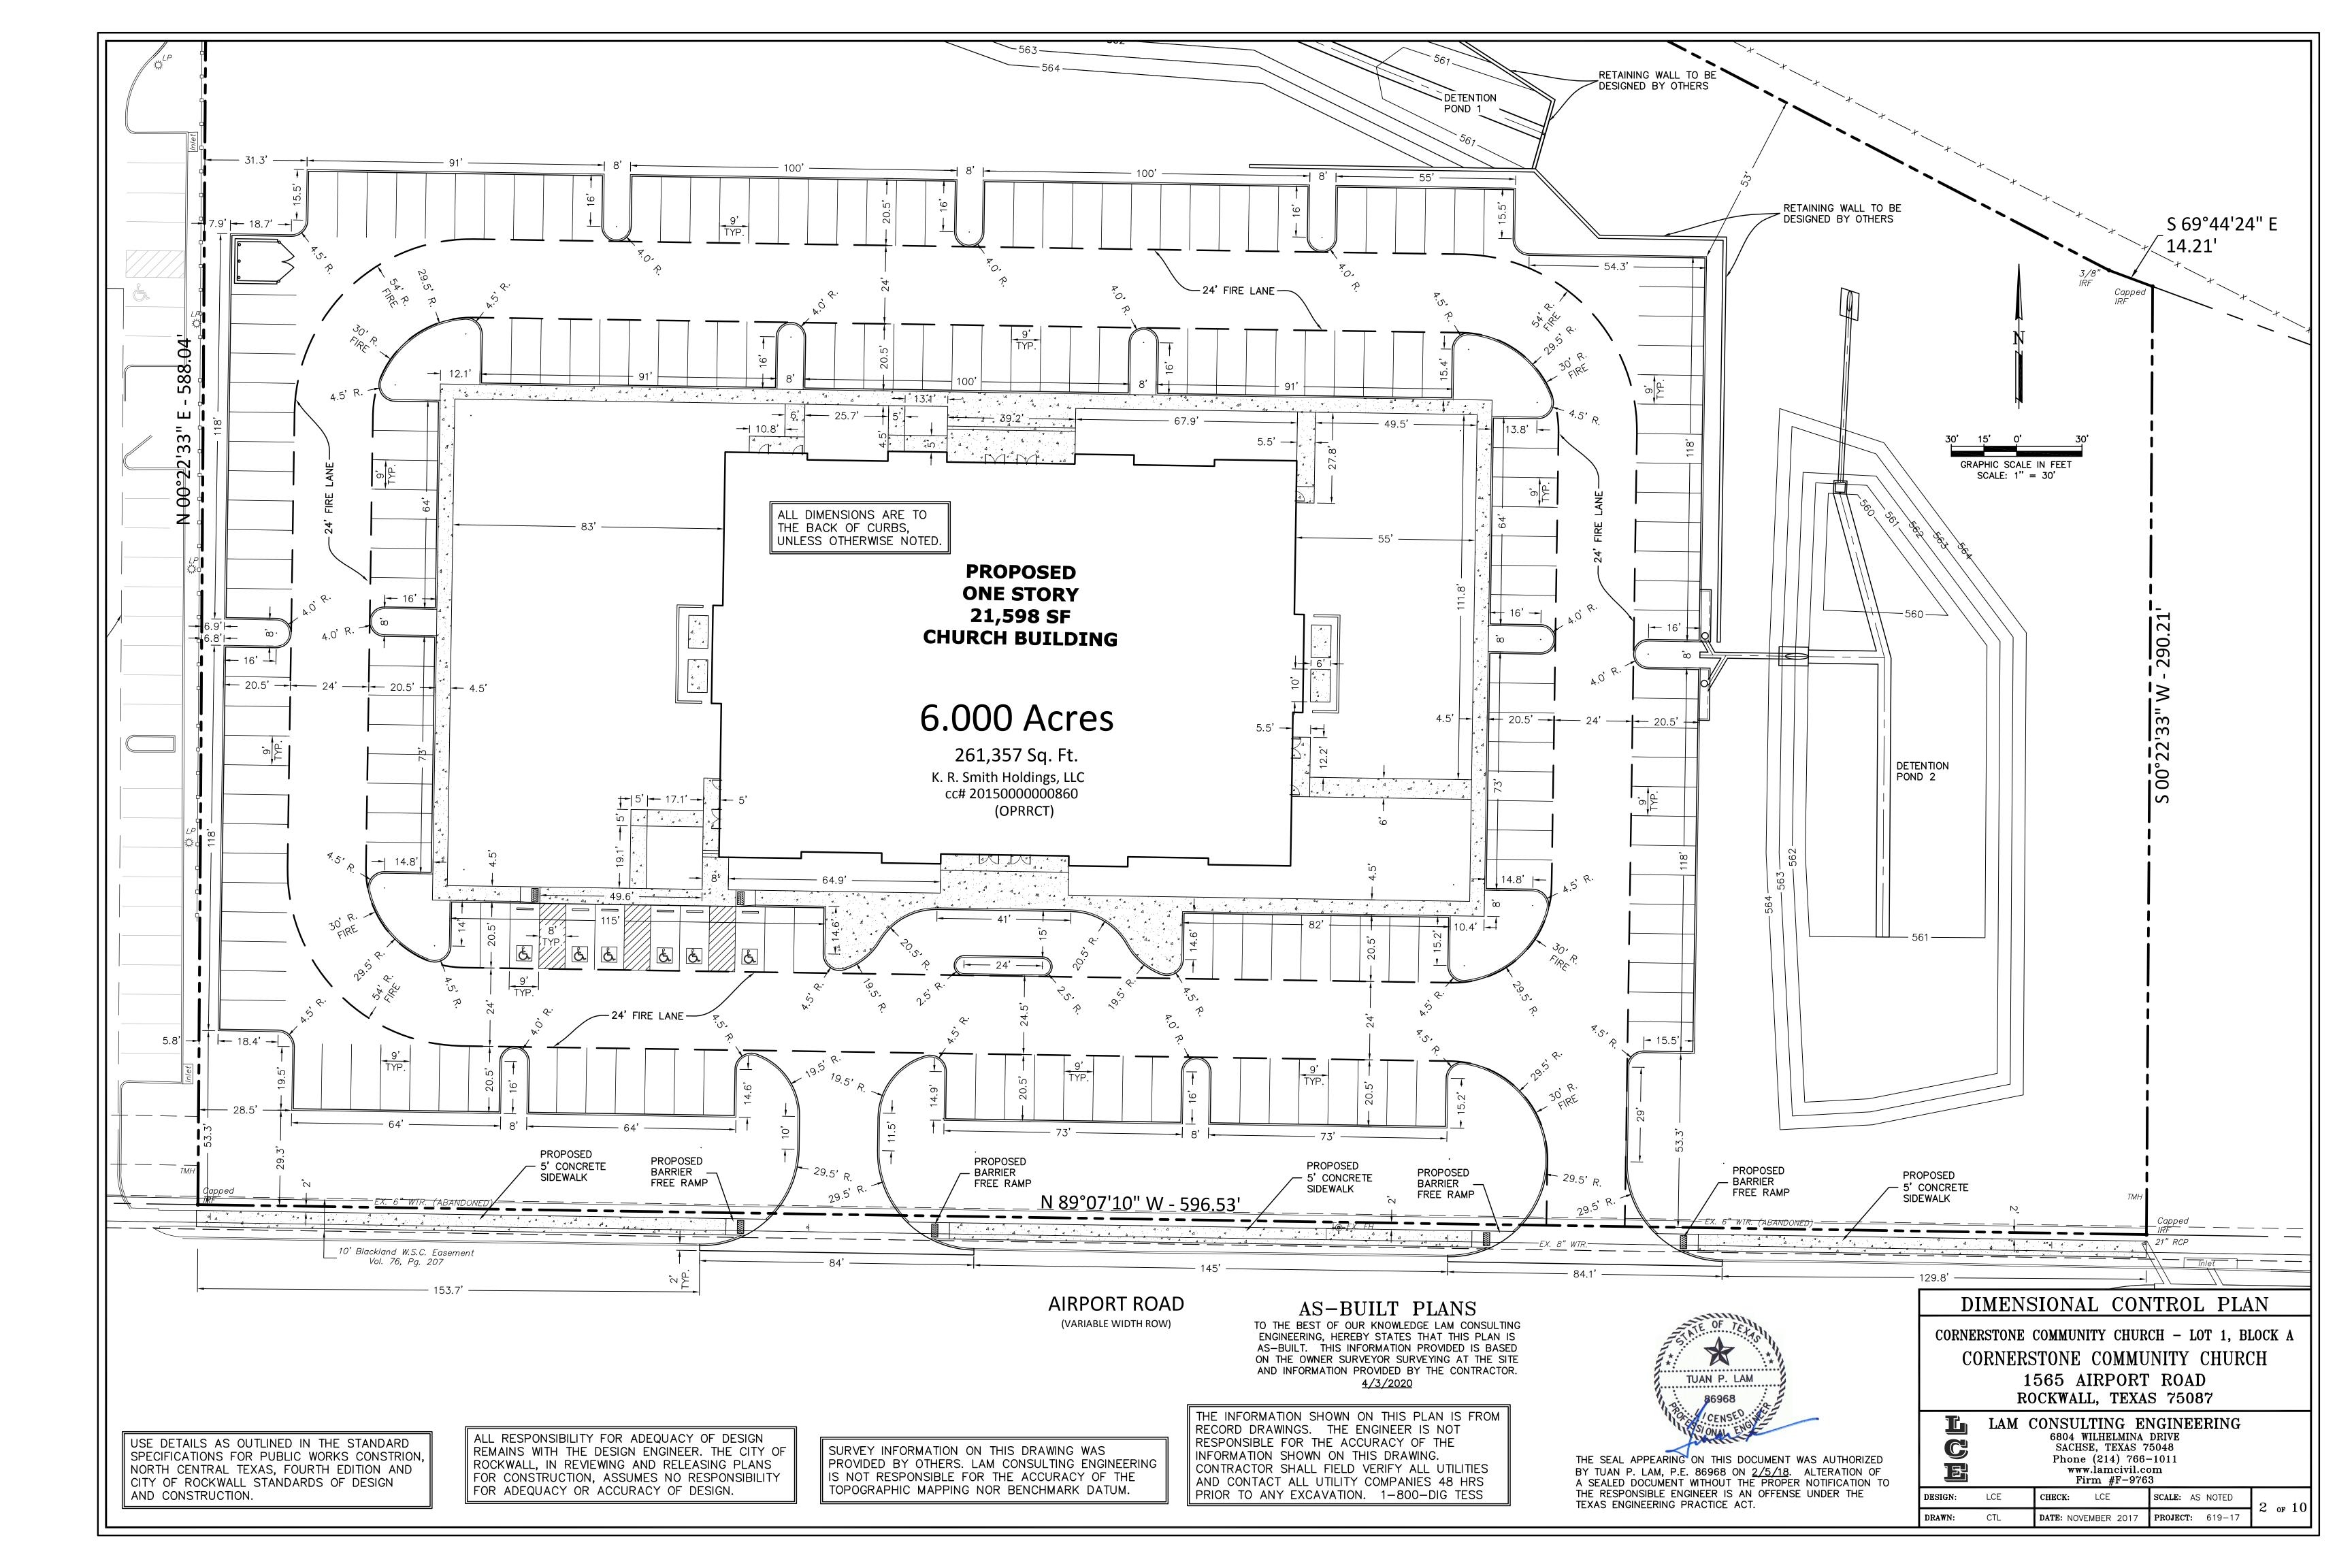
NERSTONE COMMUNI ROCKWALL, TEXA


Scale: 1'' = 40'-0''


Date: 08/24/17 Project No.: 170201


Designed: GW Drawn: GW Checked: WM

SHEET



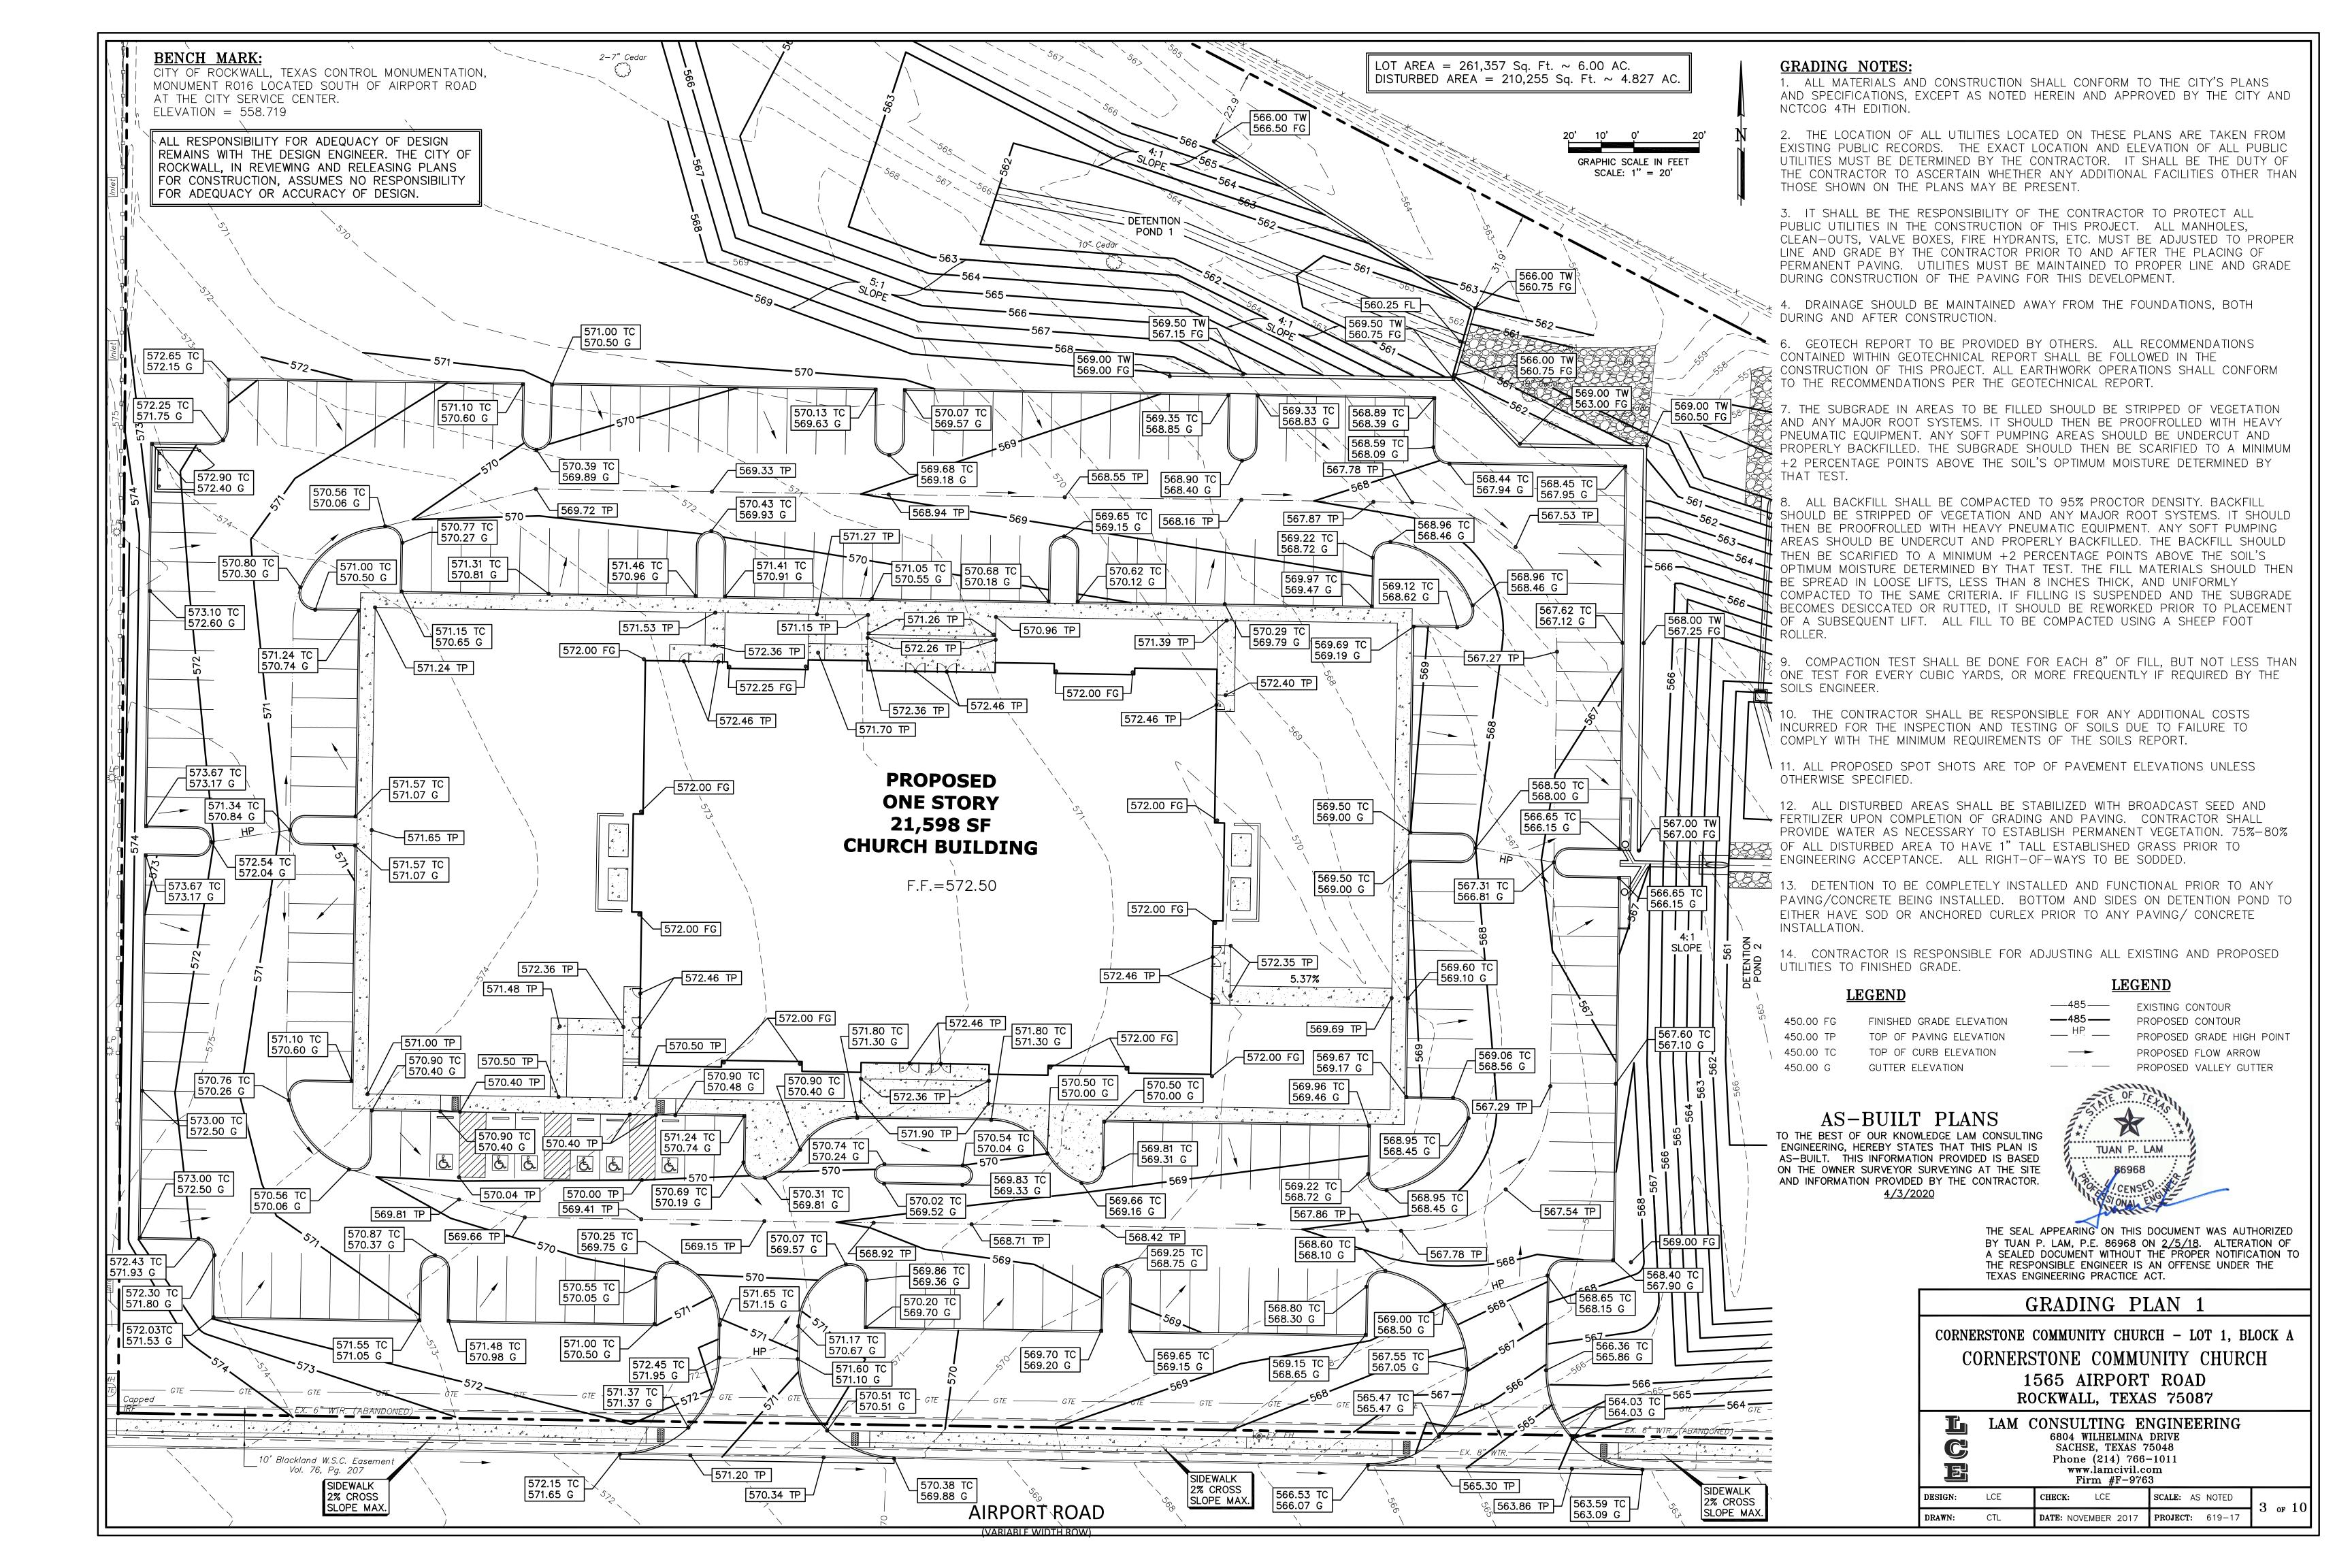

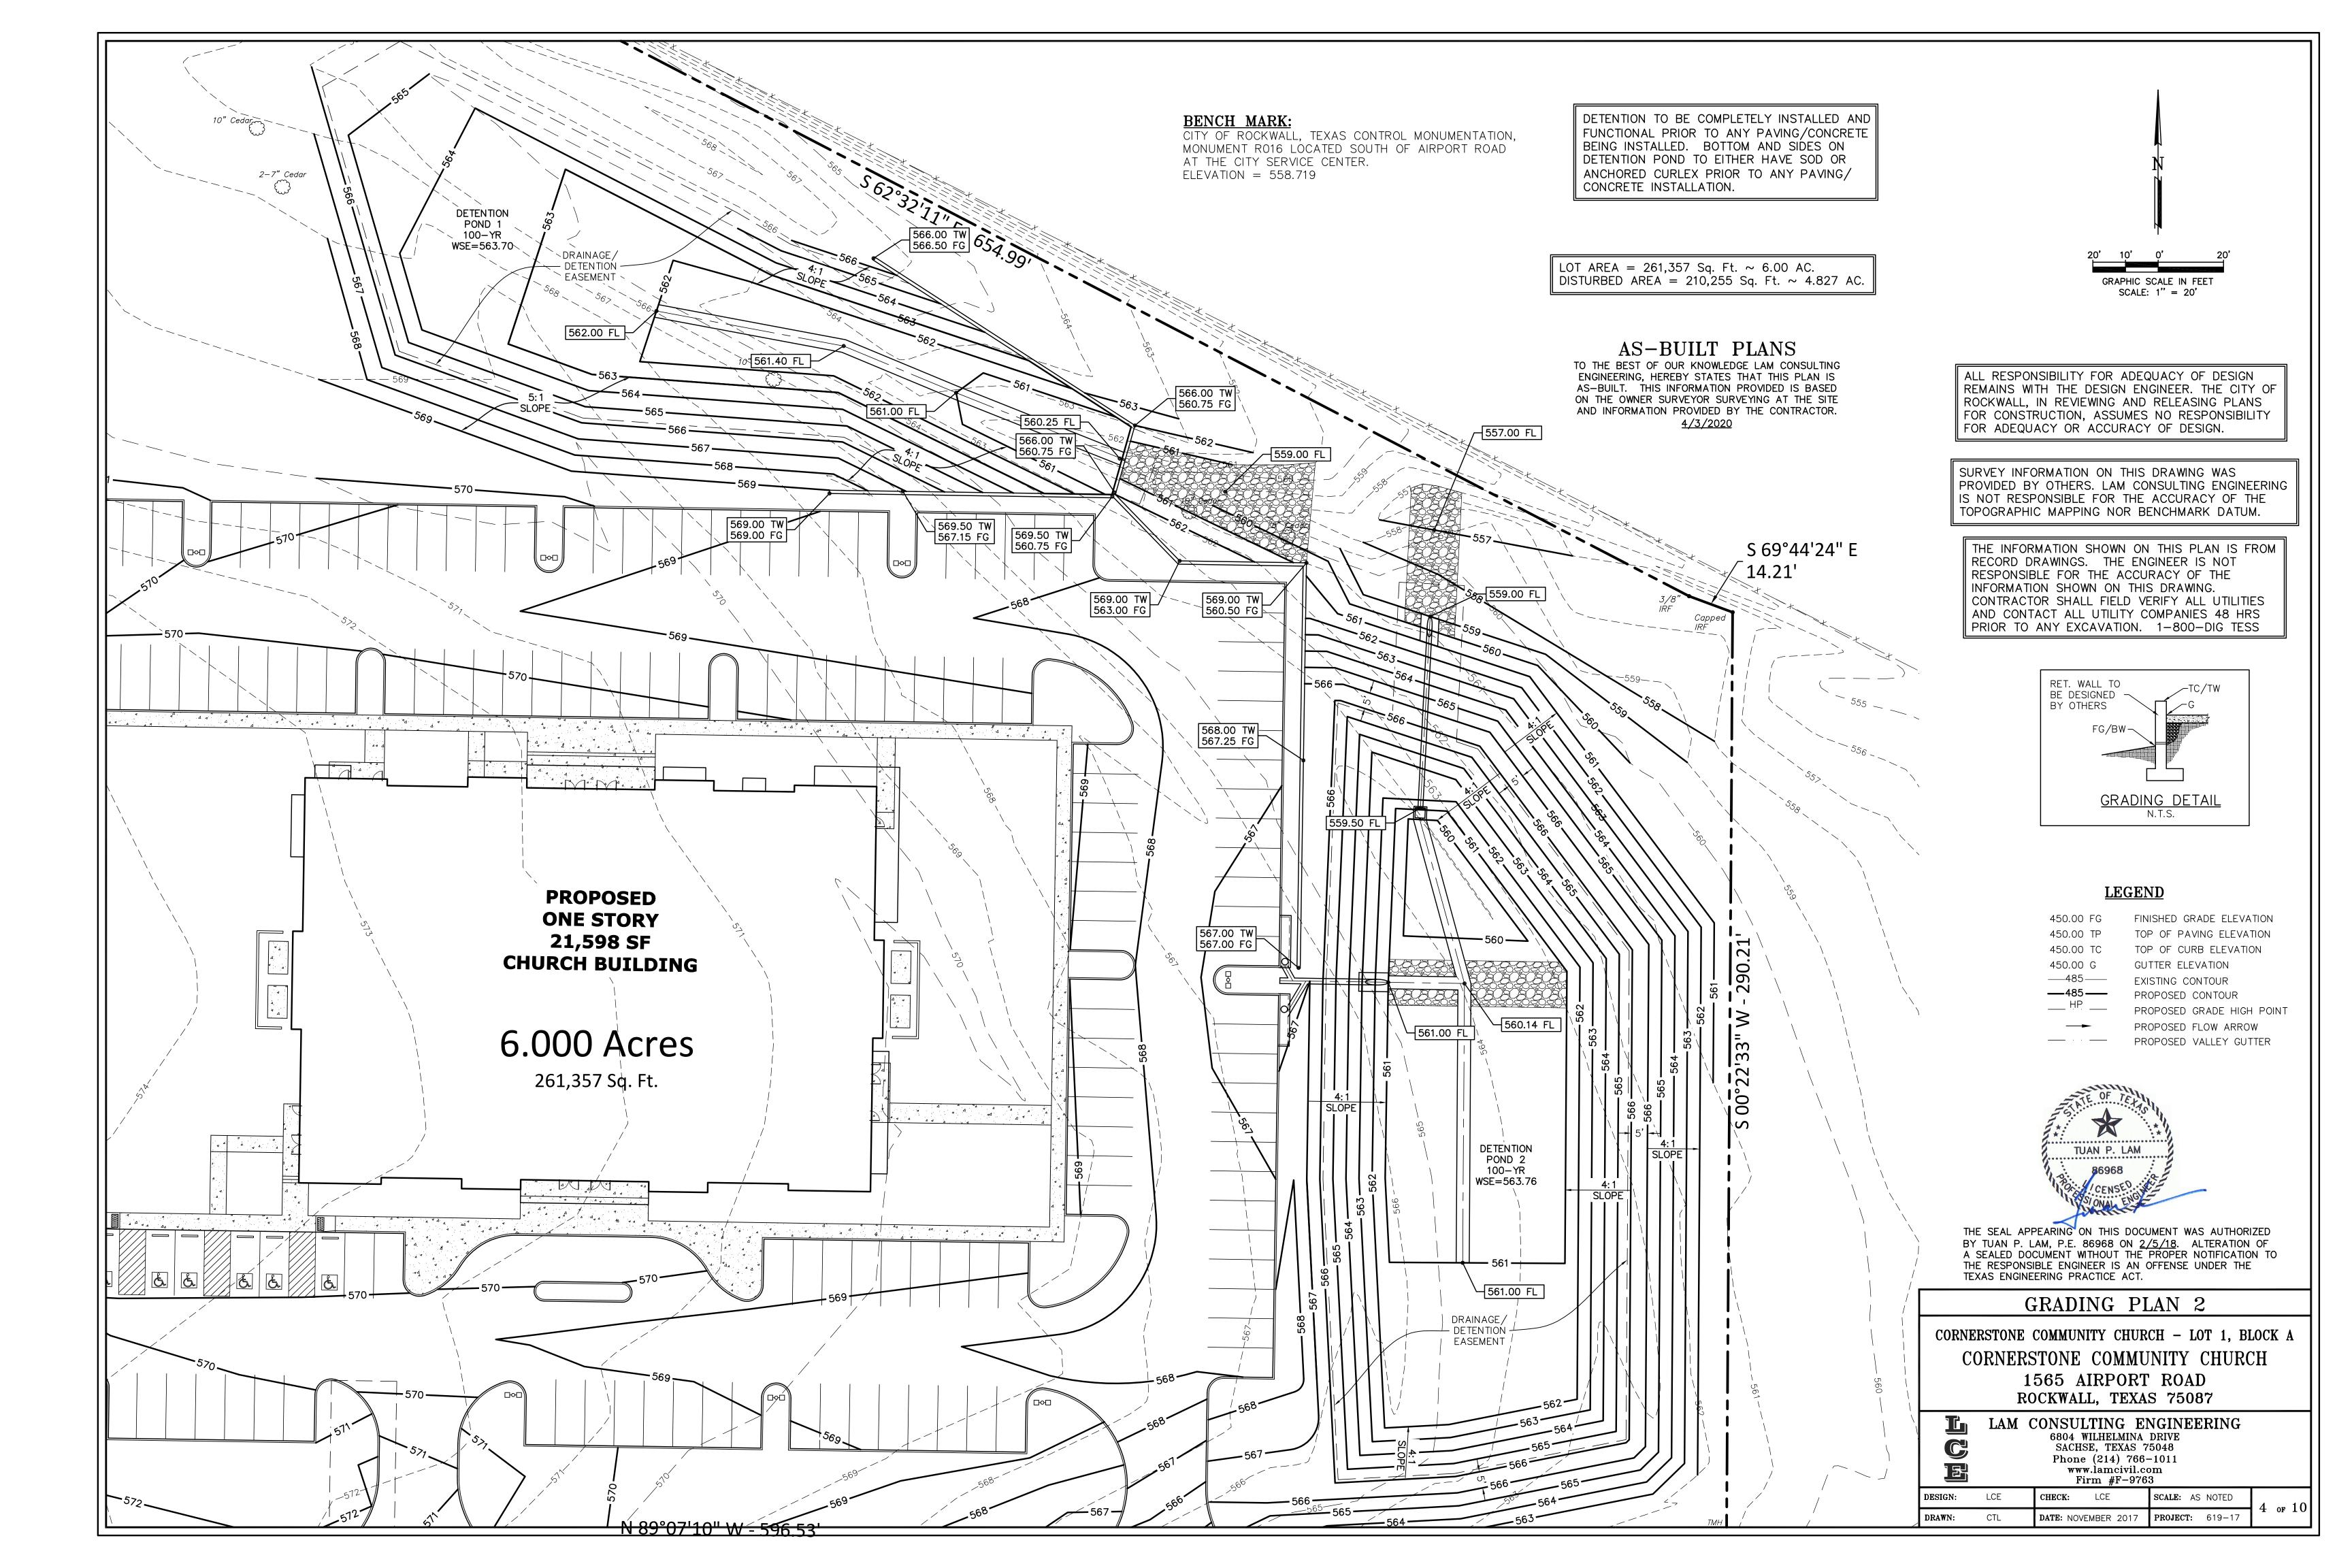

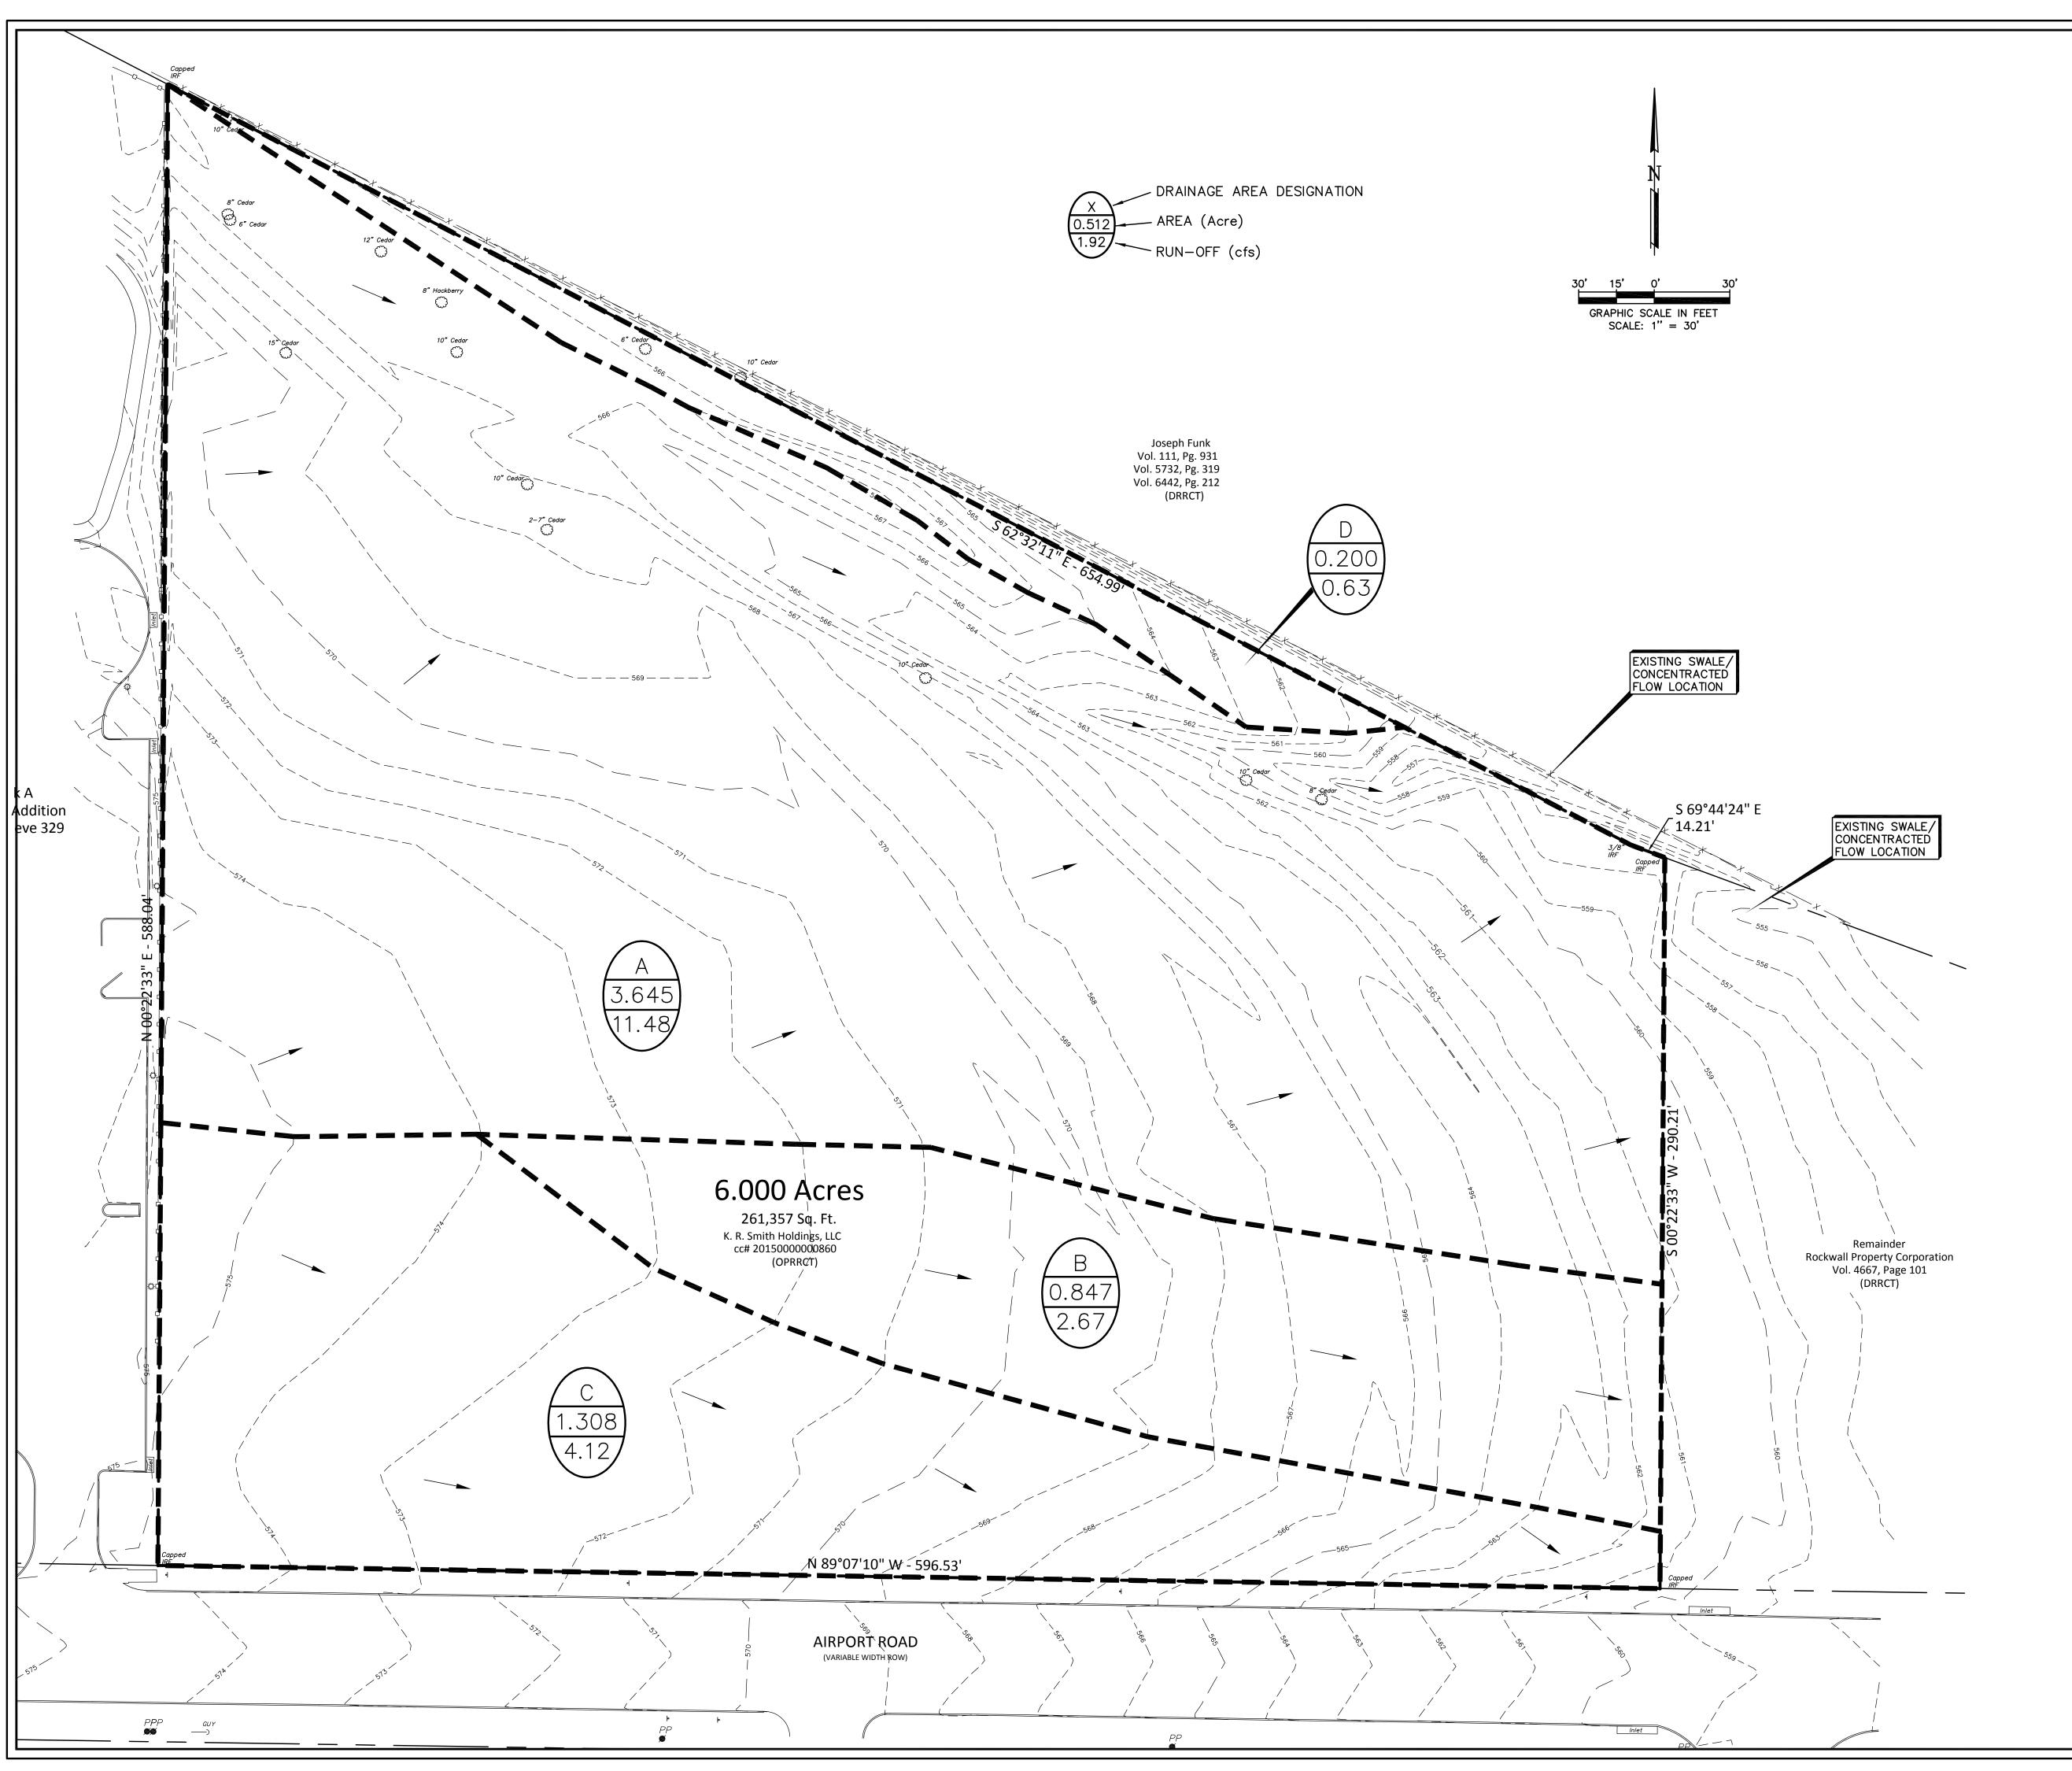

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DRAINAGE CALCULATION - EXISTING CONDITIONS								
AREA	ACRES	TIME	С		Q			
Α	3.645	15	0.35	9.00	11.48			
В	0.847	15	0.35	9.00	2.67			
С	1 308	15	0.35	9.00	4 12			

D 0.201 15 0.35 9.00 0.63

#### CITY OF ROCKWALL "C"

PARK/ OPEN AREA

RESIDENTAL

APARTMENT

TOWNHOUSE

CHURCHES

INDUSTRAIL

COMMERCIAL

MERCANTILE

RETAIL

STREET

.90

.90

.90

DUPLEX

SCHOOL

CITY OF RO	CKWALL "I"
10 MIN.	9.8
15 MIN.	9.0
20 MIN.	8.3
30 MIN.	6.9
40 MIN.	5.8
50 MIN.	5.0
60 MIN.	4.5
70 MIN.	4.0
80 MIN.	3.7
90 MIN.	3.5

۸C'_	-BUILT	DIANG
AS-	-DOILI	PLANS

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DRAINAGE AREA MAP - EXISTING

CORNERSTONE COMMUNITY CHURCH - LOT 1, BLOCK A CORNERSTONE COMMUNITY CHURCH 1565 AIRPORT ROAD


ROCKWALL, TEXAS 75087



LAM CONSULTING ENGINEERING 6804 WILHELMINA DRIVE

SACHSE, TEXAS 75048 Phone (214) 766-1011 www.lamcivil.com Firm #F-9763

DESIGN: LCE CHECK: LCE SCALE: AS NOTED DRAWN: CTL **DATE:** NOVEMBER 2017 **PROJECT:** 619-17

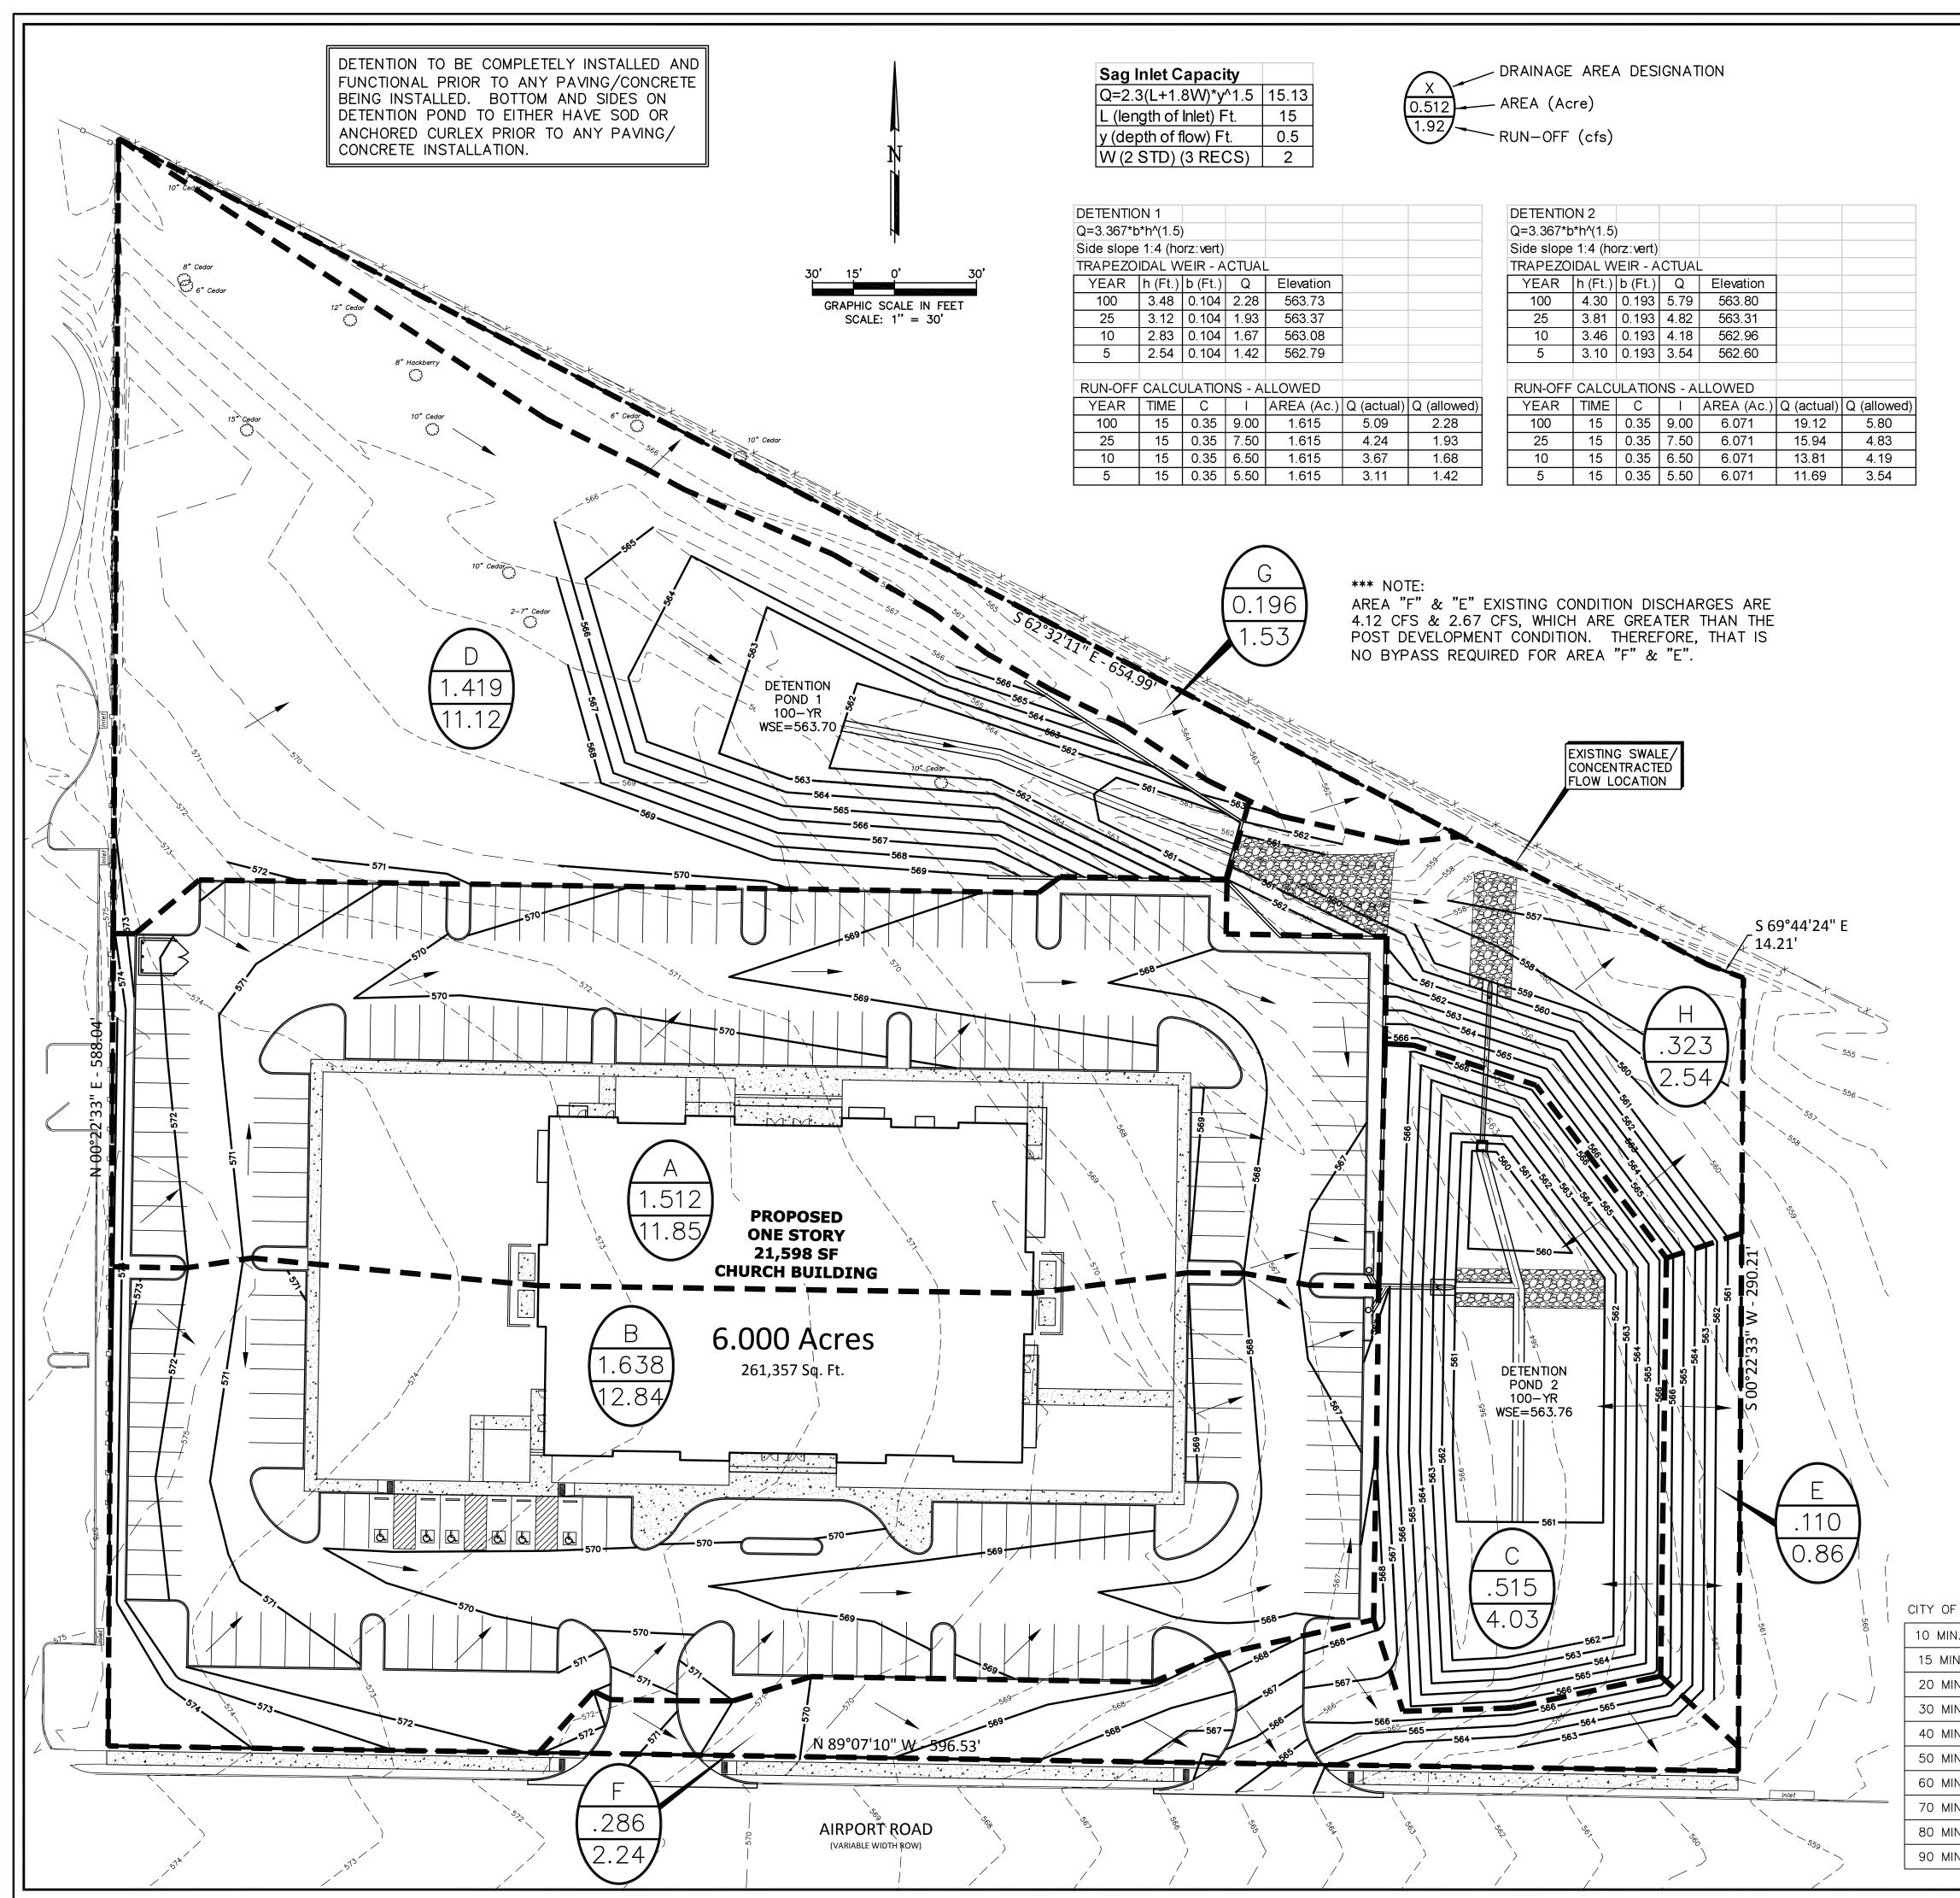

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ALL RESPONSIBILITY FOR ADEQUACY OF DESIGN REMAINS WITH THE DESIGN ENGINEER. THE CITY OF TOTAL ALLOWABLE DISCHARGE (Area A & D) 12.11 ROCKWALL, IN REVIEWING AND RELEASING PLANS Bypass (Area G, H) -4.07 FOR CONSTRUCTION, ASSUMES NO RESPONSIBILITY Detention Pond 1 FOR ADEQUACY OR ACCURACY OF DESIGN. Detention Pond 2

DETENTIO	N 1 CALCULATION:								
Based on 1	100-yr storm requirements	Q (All	owed Dis	charge)	2.28				
Present Co	onditions (Open land)	Area (	Ac.)		1.419		DETENTIO	N POND V	OLUME
Q (cfs)	4.47	Time	-	Q(cfs)	Vol (cf) Req.		ELEV	AREA	VOL. (CF)
С	0.35	15	9.00	10.22	7485		561.00	1042.08	
1	9.00	20	8.30	9.42	9255		562.00	3776.34	2409.21
Α	1.419	30	6.90	7.83	11363		563.00	7078.59	5427.47
Tc	15	40	5.80	6.58	12382		563.70	9529.27	5812.75
		50	5.00	5.68	12924			TOTAL	13649.43
Future Con	nditions (Church)	60	4.50	5.11	13602				
Q (cfs)	11.12	70	4.00	4.54	13599	V	OLUME PR	OVIDED =	13649
С	0.80	80	3.70	4.20	14005	V	OLUME RE	QUIRED =	13602
	9.80	90	3.50	3.97	14615				
Α	1.419	100	3.40	3.86	15634				
Tc	10	110	3.20	3.63	15767				
DETENTIO	N 2 CALCULATION:								
Based on 1	100-yr storm requirements	Q (All	owed Dis	charge)	5.80				
Present Conditions (Open land)		Area (	Ac.)		3.611	DETENTION POND VC		OLUME	
Q (cfs)	11.37	Time	I	Q(cfs)	Vol (cf) Req.		ELEV	AREA	VOL. (CF)
С	0.35	15	9.00	26.00	19049		560.00	866.59	
ı	9.00	20	8.30	23.98	23552		561.00	6680.49	3773.54
Α	3.611	30	6.90	19.93	28919		562.00	10810.28	8745.39
Tc	15	40	5.80	16.76	31512		563.00	12798.87	11804.57
		50	5.00	14.44	32892		563.76	14479.79	10365.89
Future Con	nditions (Church)	60	4.50	13.00	34619			TOTAL	34689.39
Q (cfs)	28.31	70	4.00	11.56	34612				
С	0.80	80	3.70	10.69	35645	٧	OLUME PR	OVIDED =	34689
I	9.80	90	3.50	10.11	37198	٧	OLUME RE	QUIRED =	34619
Α	3.611	100	3.40	9.82	39792				
Tc	10	110	3.20	9.24	40131				

D 1 0 111 17 1	02 07 12 0	02, (110)		<i></i>		
AREA	ACRES	TIME	С	I	Q	
Α	1.512	15	0.35	9.00	4.76	
В	1.638	15	0.35	9.00	5.16	
С	0.515	15	0.35	9.00	1.62	
D	1.419	15	0.35	9.00	4.47	
Е	0.110	15	0.35	9.00	0.35	
F	0.286	15	0.35	9.00	0.90	
G	0.196	15	0.35	9.00	0.62	
Η	0.323	15	0.35	9.00	1.02	
DRAINA	GE CALC	ULATIO	N - POST	-DEVELO	OPMENT	
AREA	ACRES	TIME	С	I	Q	COMMENT
Α	1.512	10	0.80	9.80	11.85	DRAIN TO DETENTION POND
В	1.638	10	0.80	9.80	12.84	DRAIN TO DETENTION POND
С	0.515	10	0.80	9.80	4.03	DETENTION POND
D	1.419	10	0.80	9.80	11.12	DETENTION POND
Е	0.110	10	0.80	9.80	0.86	DRAIN TO EAST PROPERTY LINE
F	0.286	10	0.80	9.80	2.24	DRAIN TO AIRPORT ROAD
G	0.196	10	0.80	9.80	1.53	DRAIN TO NORTH PROPERTY LINE
Н	0.323	10	0.80	9.80	2.54	DRAIN TO NORTH PROPERTY LINE

## AS-BUILT PLANS

DRAINAGE CALCULATION - PRE-DEVELOPMENT

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Sum should equal to zero

			CITY OF ROCKWALL "(	<b>C"</b>
			PARK/ OPEN AREA	.35
TY OF ROCKWALL "I"			RESIDENTAL	.50
O MIN.	9.8		DUPLEX	
5 MIN.	9.0		SCHOOL	.70
20 MIN.	8.3		APARTMENT	.75
30 MIN.	6.9		TOWNHOUSE	.80
10 MIN.	5.8		CHURCHES	.80
50 MIN.	5.0		INDUSTRAIL	.90
50 MIN.	4.5		COMMERCIAL	.90
70 MIN.	4.0		MERCANTILE	.90
30 MIN.	3.7		RETAIL	.90
90 MIN.	3.5		STREET	.90



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# DRAINAGE AREA MAP


CORNERSTONE COMMUNITY CHURCH - LOT 1, BLOCK A CORNERSTONE COMMUNITY CHURCH 1565 AIRPORT ROAD ROCKWALL, TEXAS 75087



LAM CONSULTING ENGINEERING 6804 WILHELMINA DRIVE SACHSE, TEXAS 75048 Phone (214) 766-1011 www.lamcivil.com

<b>4</b>	Firm #F-976	3	
: LCE	CHECK: LCE	SCALE: AS NOTED	6
: CTL	DATE: NOVEMBER 2017	<b>PROJECT:</b> 619-17	

DRAWN:

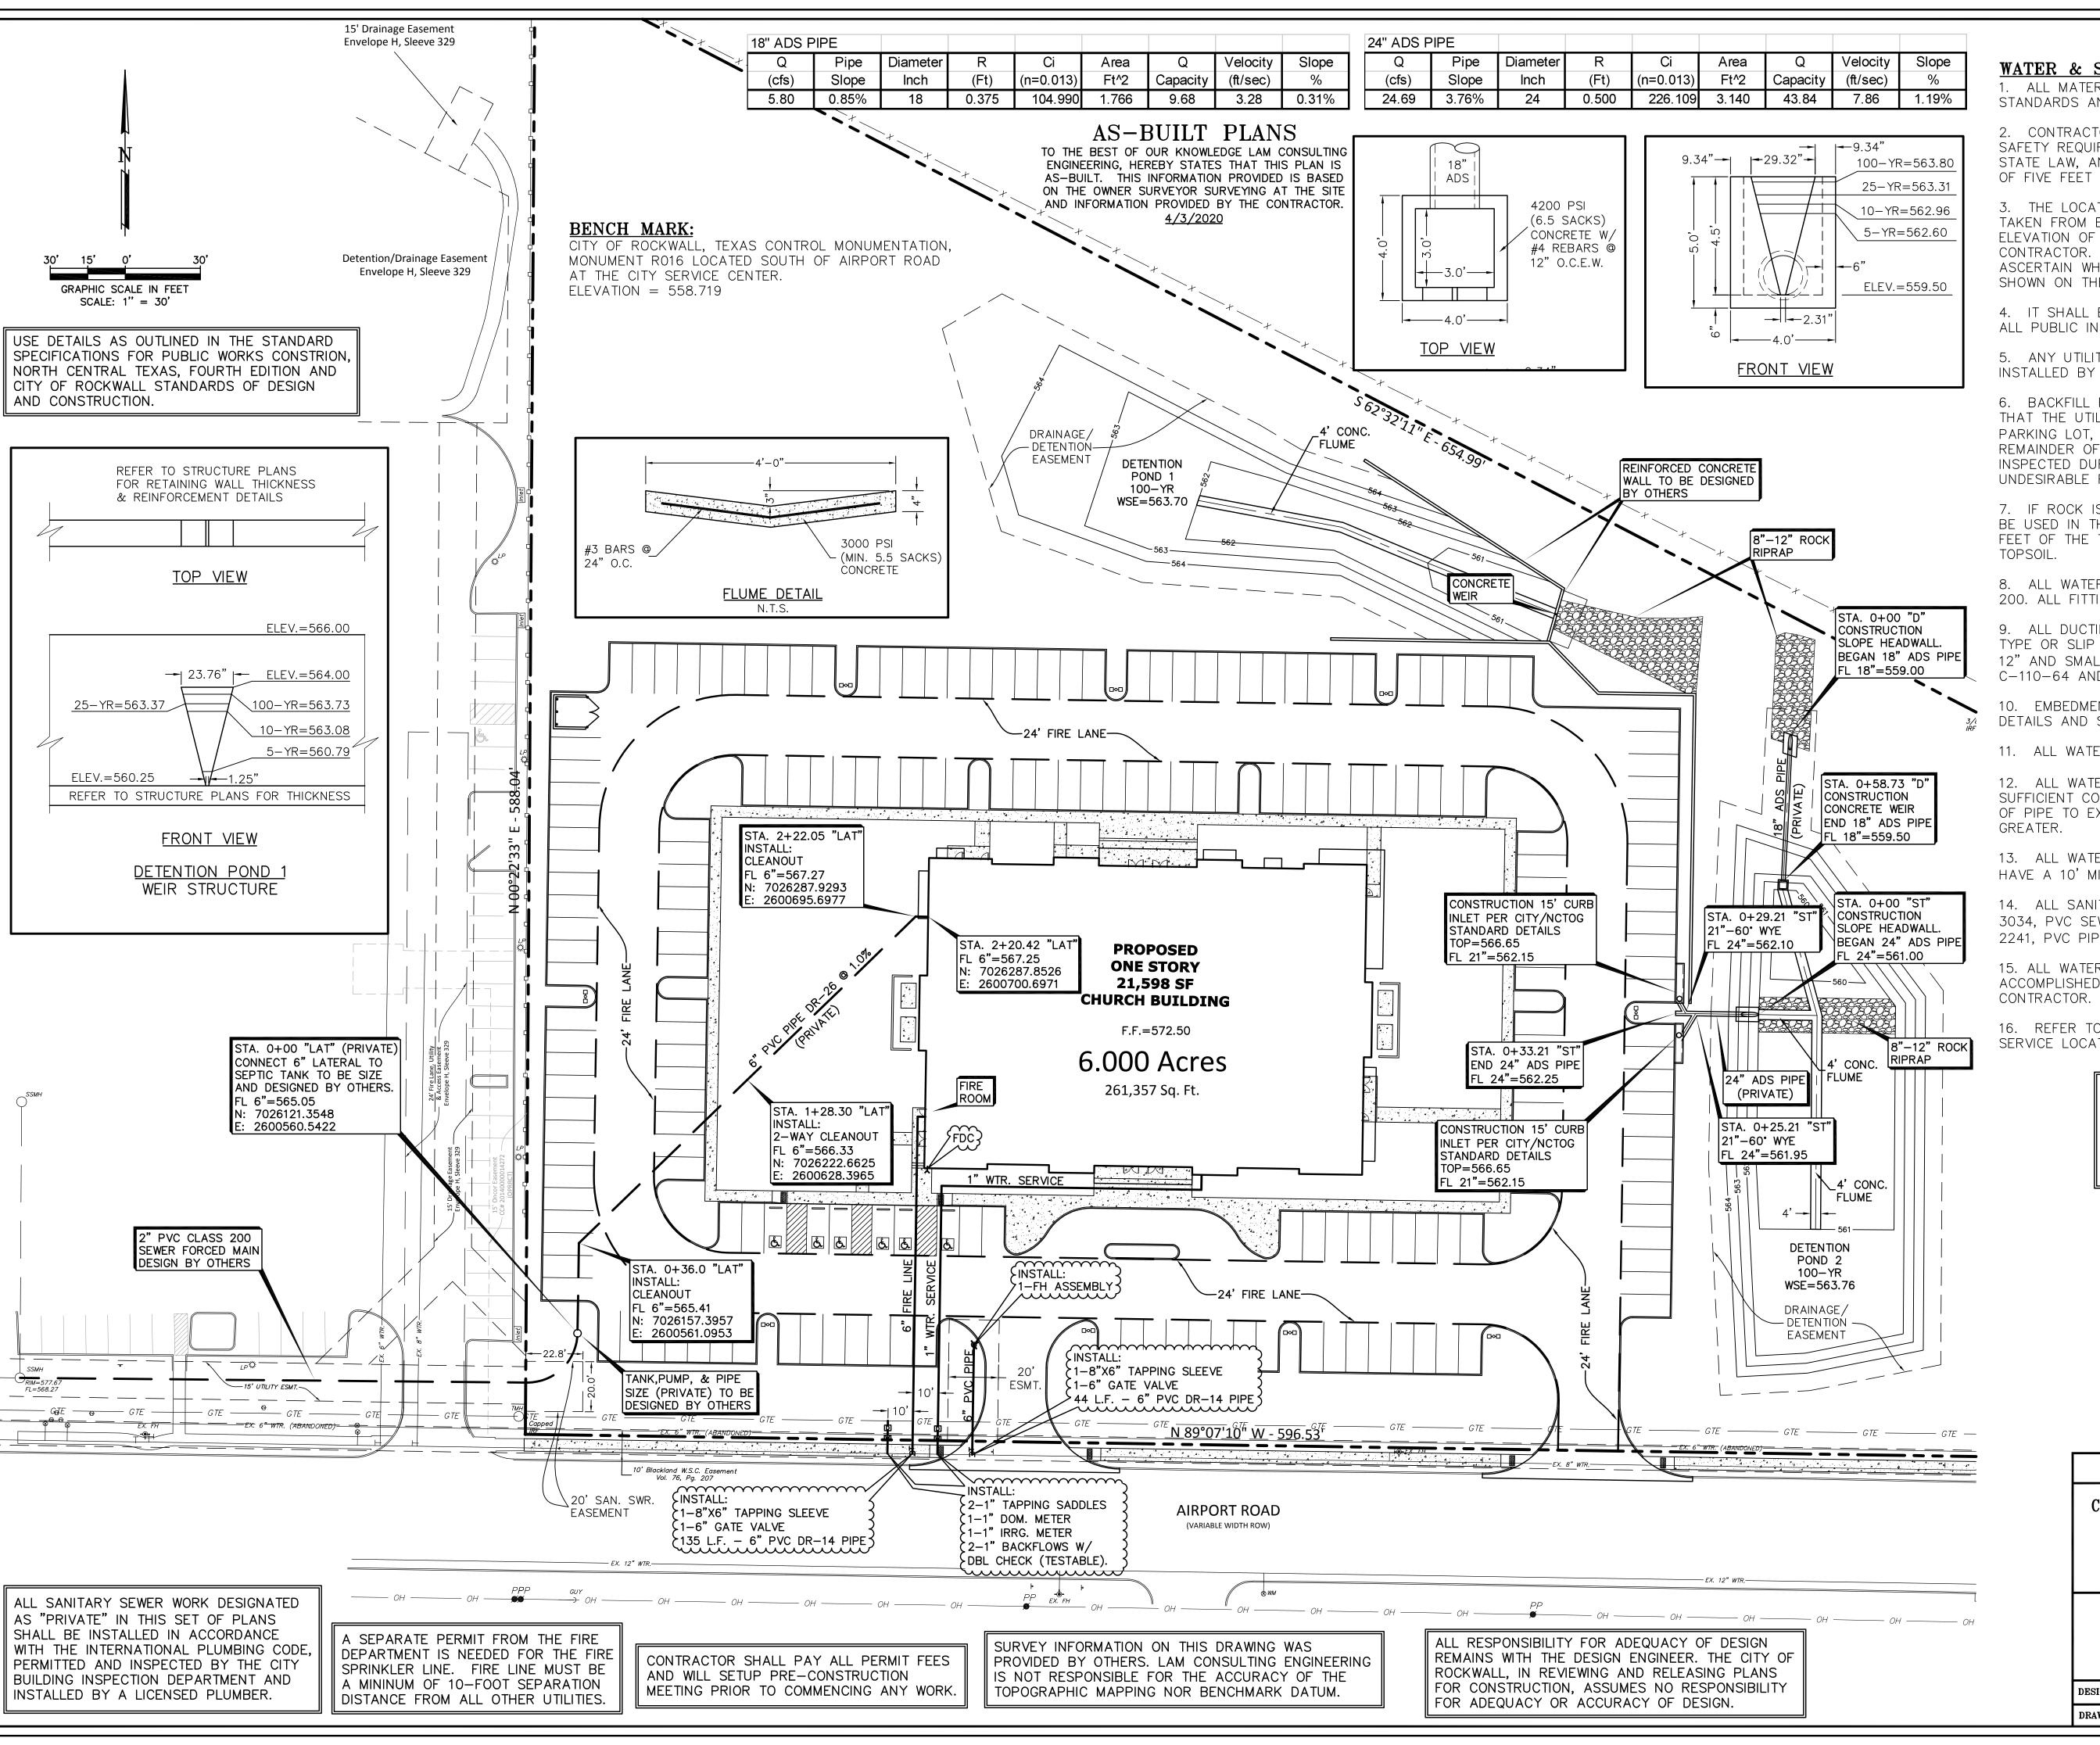

#### WATER & SANITARY SEWER NOTES:

1. ALL MATERIALS AND CONSTRUCTION SHALL CONFORM TO THE CITY'S STANDARDS AND SPECIFICATIONS.

- 2. CONTRACTOR SHALL BE RESPONSIBLE FOR MAINTAINING TRENCH SAFETY REQUIREMENTS IN ACCORDANCE WITH CITY STANDARDS, TEXAS STATE LAW, AND O.S.H.A. STANDARDS FOR ALL EXCAVATION IN EXCESS OF FIVE FEET IN DEPTH.
- 3. THE LOCATION OF ALL UTILITIES LOCATED ON THESE PLANS ARE TAKEN FROM EXISTING PUBLIC RECORDS. THE EXACT LOCATION AND ELEVATION OF ALL PUBLIC UTILITIES MUST BE DETERMINED BY THE CONTRACTOR. IT SHALL BE THE DUTY OF THE CONTRACTOR TO ASCERTAIN WHETHER ANY ADDITIONAL FACILITIES OTHER THAN THOSE SHOWN ON THE PLANS MAY BE PRESENT.
- 4. IT SHALL BE THE RESPONSIBILITY OF THE CONTRACTOR TO PROTECT ALL PUBLIC INFRASTRUCTURE IN THE CONSTRUCTION OF THIS PROJECT.
- 5. ANY UTILITY INSTALLED OUTSIDE OF AN EASEMENT SHALL BE INSTALLED BY A PLUMBER AND INSPECTED BY BUILDING DEPT.
- 6. BACKFILL FOR UTILITY LINES SHOULD BE CAREFULLY PLACED SO THAT THE UTILITY WILL BE STABLE. WHERE UTILITY LINES CROSS THE PARKING LOT, THE TOP 6" SHOULD BE COMPACTED SIMILARLY TO THE REMAINDER OF THE LOT. UTILITY DITCHES SHOULD BE VISUALLY INSPECTED DURING THE EXCAVATION PROCESS TO ENSURE THAT UNDESIRABLE FILL IS NOT USED.
- 7. IF ROCK IS ENCOUNTERED IN THE TRENCH, ROCK SPOIL SHALL NOT BE USED IN THE UPPER 1.5 FEET OF THE TRENCH. THE UPPER 1.5 FEET OF THE TRENCH IS TO BE BACKFILLED ONLY WITH QUALITY
- 8. ALL WATER MAINS SHALL MEET AWWA C-900, PVC DR-14 CLASS 200. ALL FITTINGS SHALL MEET ASTM F477 SPECIFICATIONS.
- 9. ALL DUCTILE IRON FITTINGS SHALL BE OF THE MECHANICAL JOINT TYPE OR SLIP JOINT AND SHALL BE CLASS D, OR CLASS 250 ON SIZES 12" AND SMALLER IN ACCORDANCE WITH A.W.W.A. SPECIFICATION C-110-64 AND C-111-64.
- 10. EMBEDMENT FOR PVC WATER MAIN SHALL COMPLY WITH THE CITY DETAILS AND SPECIFICATIONS.
- 11. ALL WATER METERS TO BE PLACED IN A NON-TRAFFIC AREA.
- 12. ALL WATER MAINS SHALL HAVE A MINIMUM COVER OF 42", OR SUFFICIENT COVER TO CLEAR OTHER UTILITIES AS MEASURED FROM TOP OF PIPE TO EXISTING GROUND LEVEL OR FINISHED GRADE. WHICHEVER IS
- 13. ALL WATER AND SANITARY SEWER MAINS AND SERVICES SHALL HAVE A 10' MIN. LATERAL SEPARATION DISTANCE.
- 14. ALL SANITARY SEWER PIPES AND FITTINGS SHALL MEET ASTM D 3034, PVC SEWER PIPE SDR35. PIPE OVER 10' IN DEPTH, USE ASTM D 2241. PVC PIPE. SDR 26 (160).
- 15. ALL WATER AND SANITARY SEWER TESTINGS SHALL BE ACCOMPLISHED BY A TESTING LAB APPROVED BY THE CITY AND PAID BY
- 16. REFER TO MECHANICAL PLANS FOR EXACT WATER AND SEWER SERVICE LOCATIONS.

THE INFORMATION SHOWN ON THIS PLAN IS FROM RECORD DRAWINGS. THE ENGINEER IS NOT RESPONSIBLE FOR THE ACCURACY OF THE INFORMATION SHOWN ON THIS DRAWING. CONTRACTOR SHALL FIELD VERIFY ALL UTILITIES AND CONTACT ALL UTILITY COMPANIES 48 HRS PRIOR TO ANY EXCAVATION. 1-800-DIG TESS



THE SEAL APPEARING ON THIS DOCUMENT WAS AUTHORIZED BY TUAN P. LAM, P.E. 86968 ON 2/5/18. ALTERATION OF A SEALED DOCUMENT WITHOUT THE PROPER NOTIFICATION TO THE RESPONSIBLE ENGINEER IS AN OFFENSE UNDER THE TEXAS ENGINEERING PRACTICE ACT.

# UTILITY PLAN


CORNERSTONE COMMUNITY CHURCH - LOT 1, BLOCK A CORNERSTONE COMMUNITY CHURCH 1565 AIRPORT ROAD ROCKWALL, TEXAS 75087



LAM CONSULTING ENGINEERING 6804 WILHELMINA DRIVE SACHSE, TEXAS 75048 Phone (214) 766-1011 www.lamcivil.com

DESIGN: LCE CHECK: SCALE: AS NOTED DRAWN: DATE: NOVEMBER 2017 **PROJECT:** 619-17 CTL

Firm #F-9763

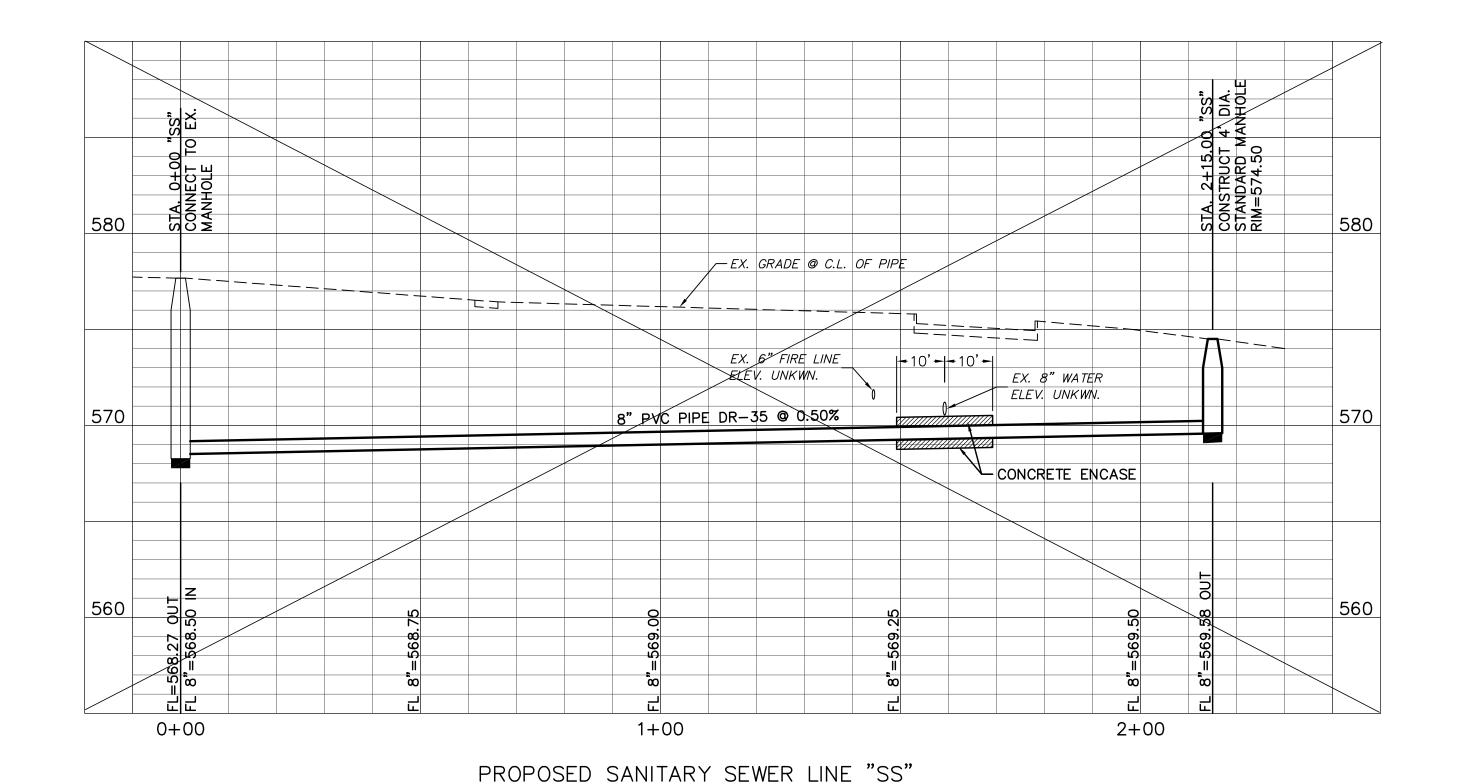

- PROP. GRADE @ C.L. OF PIPE WSE=563.76 18" ADS PIPE @ 0.85% Q<sub>100</sub>=5.80 cfs V<sub>100</sub>=3.28 Ft./Sec. Sf=0.0031 Ft./Ft. Qc=9.68 cfs 0+00 0+50 1+00 PROPOSED STORM LINE D"

H=20' V=5'

570 PROP. GRADE @ C.L. OF PIPE ∠24" ADS PIPE @ 3.76% WSE=563.76 / ① Q<sub>100</sub>=24.69 cfs V<sub>100</sub>=7.86 Ft./Sec. Sf=0.0119 Ft./Ft. Qc=43.84 cfs Q<sub>100</sub>=11.85 cfs V<sub>100</sub>=3.77 Ft./Sec. Sf=0.0027 Ft./Ft. Qc=43.84 cfs 0+000 + 501+00

PROPOSED STORM LINE "ST" H=20' V=5'

OWNER DECIDED TO INSTALL A LIFT STATION (DESIGNED BY OTHERS)

H=20' V=5'

AS-BUILT PLANS

TO THE BEST OF OUR KNOWLEDGE LAM CONSULTING ENGINEERING, HEREBY STATES THAT THIS PLAN IS AS-BUILT. THIS INFORMATION PROVIDED IS BASED ON THE OWNER SURVEYOR SURVEYING AT THE SITE AND INFORMATION PROVIDED BY THE CONTRACTOR. 4/3/2020

ALL RESPONSIBILITY FOR ADEQUACY OF DESIGN REMAINS WITH THE DESIGN ENGINEER. THE CITY OF ROCKWALL, IN REVIEWING AND RELEASING PLANS FOR CONSTRUCTION, ASSUMES NO RESPONSIBILITY FOR ADEQUACY OR ACCURACY OF DESIGN.



THE SEAL APPEARING ON THIS DOCUMENT WAS AUTHORIZED BY TUAN P. LAM, P.E. 86968 ON 2/5/18. ALTERATION OF A SEALED DOCUMENT WITHOUT THE PROPER NOTIFICATION TO THE RESPONSIBLE ENGINEER IS AN OFFENSE UNDER THE TEXAS ENGINEERING PRACTICE ACT.

# UTILITY PROFILES

CORNERSTONE COMMUNITY CHURCH - LOT 1, BLOCK A CORNERSTONE COMMUNITY CHURCH 1565 AIRPORT ROAD



ROCKWALL, TEXAS 75087 LAM CONSULTING ENGINEERING 6804 WILHELMINA DRIVE SACHSE, TEXAS 75048

Phone (214) 766-1011 www.lamcivil.com Firm #F-9763

DESIGN: LCE CHECK: LCE SCALE: AS NOTED DRAWN: CTL DATE: NOVEMBER 2017 PROJECT: 619-17

USE DETAILS AS OUTLINED IN THE STANDARD SPECIFICATIONS FOR PUBLIC WORKS CONSTRION, NORTH CENTRAL TEXAS, FOURTH EDITION AND CITY OF ROCKWALL STANDARDS OF DESIGN AND CONSTRUCTION.

CONTRACTOR SHALL PAY ALL PERMIT FEES AND WILL SETUP PRE-CONSTRUCTION MEETING PRIOR TO COMMENCING ANY WORK. ALL UTILITY TAPS AND CONNECTIONS IN PUBLIC ROW AND EASEMENTS WILL BE DONE IN ACCORDANCE TO THE CITY'S GENERAL DESIGN STANDARDS AND STANDARD DETAILS AND INSPECTED BY CITY.


RECORD DRAWINGS. THE ENGINEER IS NOT RESPONSIBLE FOR THE ACCURACY OF THE INFORMATION SHOWN ON THIS DRAWING. CONTRACTOR SHALL FIELD VERIFY ALL UTILITIES AND CONTACT ALL UTILITY COMPANIES 48 HRS PRIOR TO ANY EXCAVATION. 1-800-DIG TESS


SURVEY INFORMATION ON THIS DRAWING WAS

PROVIDED BY OTHERS. LAM CONSULTING ENGINEERING IS NOT RESPONSIBLE FOR THE ACCURACY OF THE

THE INFORMATION SHOWN ON THIS PLAN IS FROM


TOPOGRAPHIC MAPPING NOR BENCHMARK DATUM.

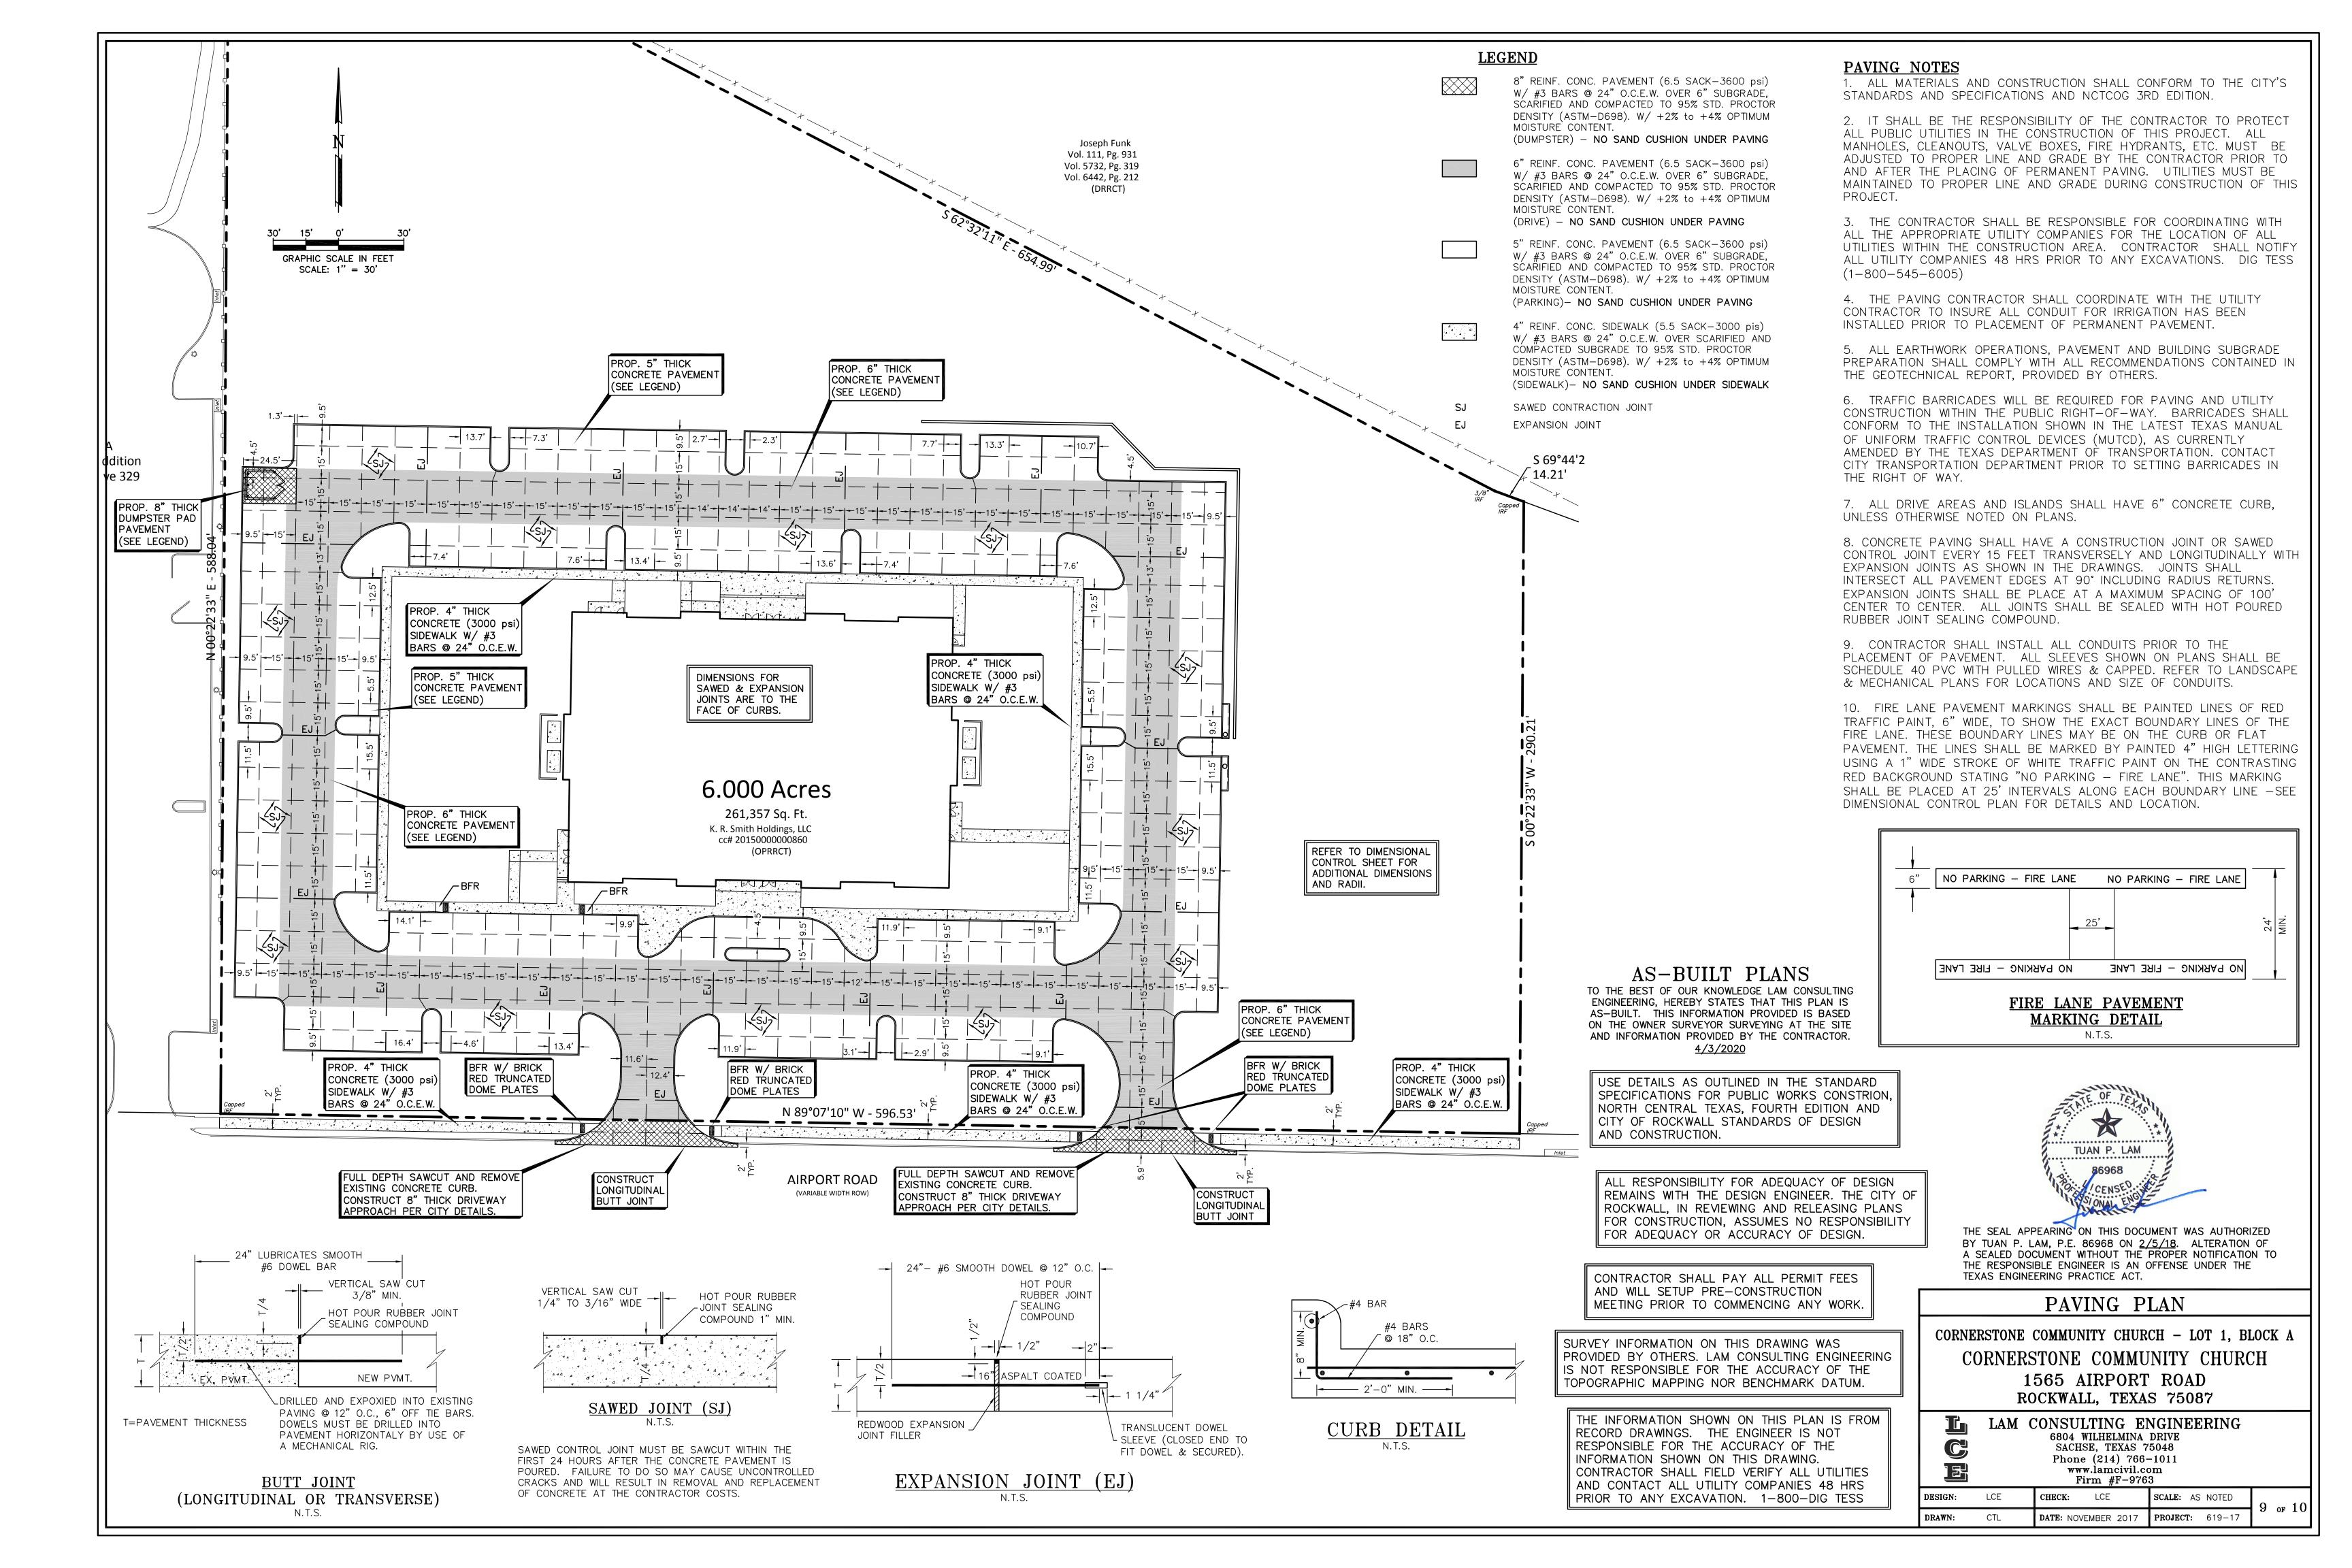

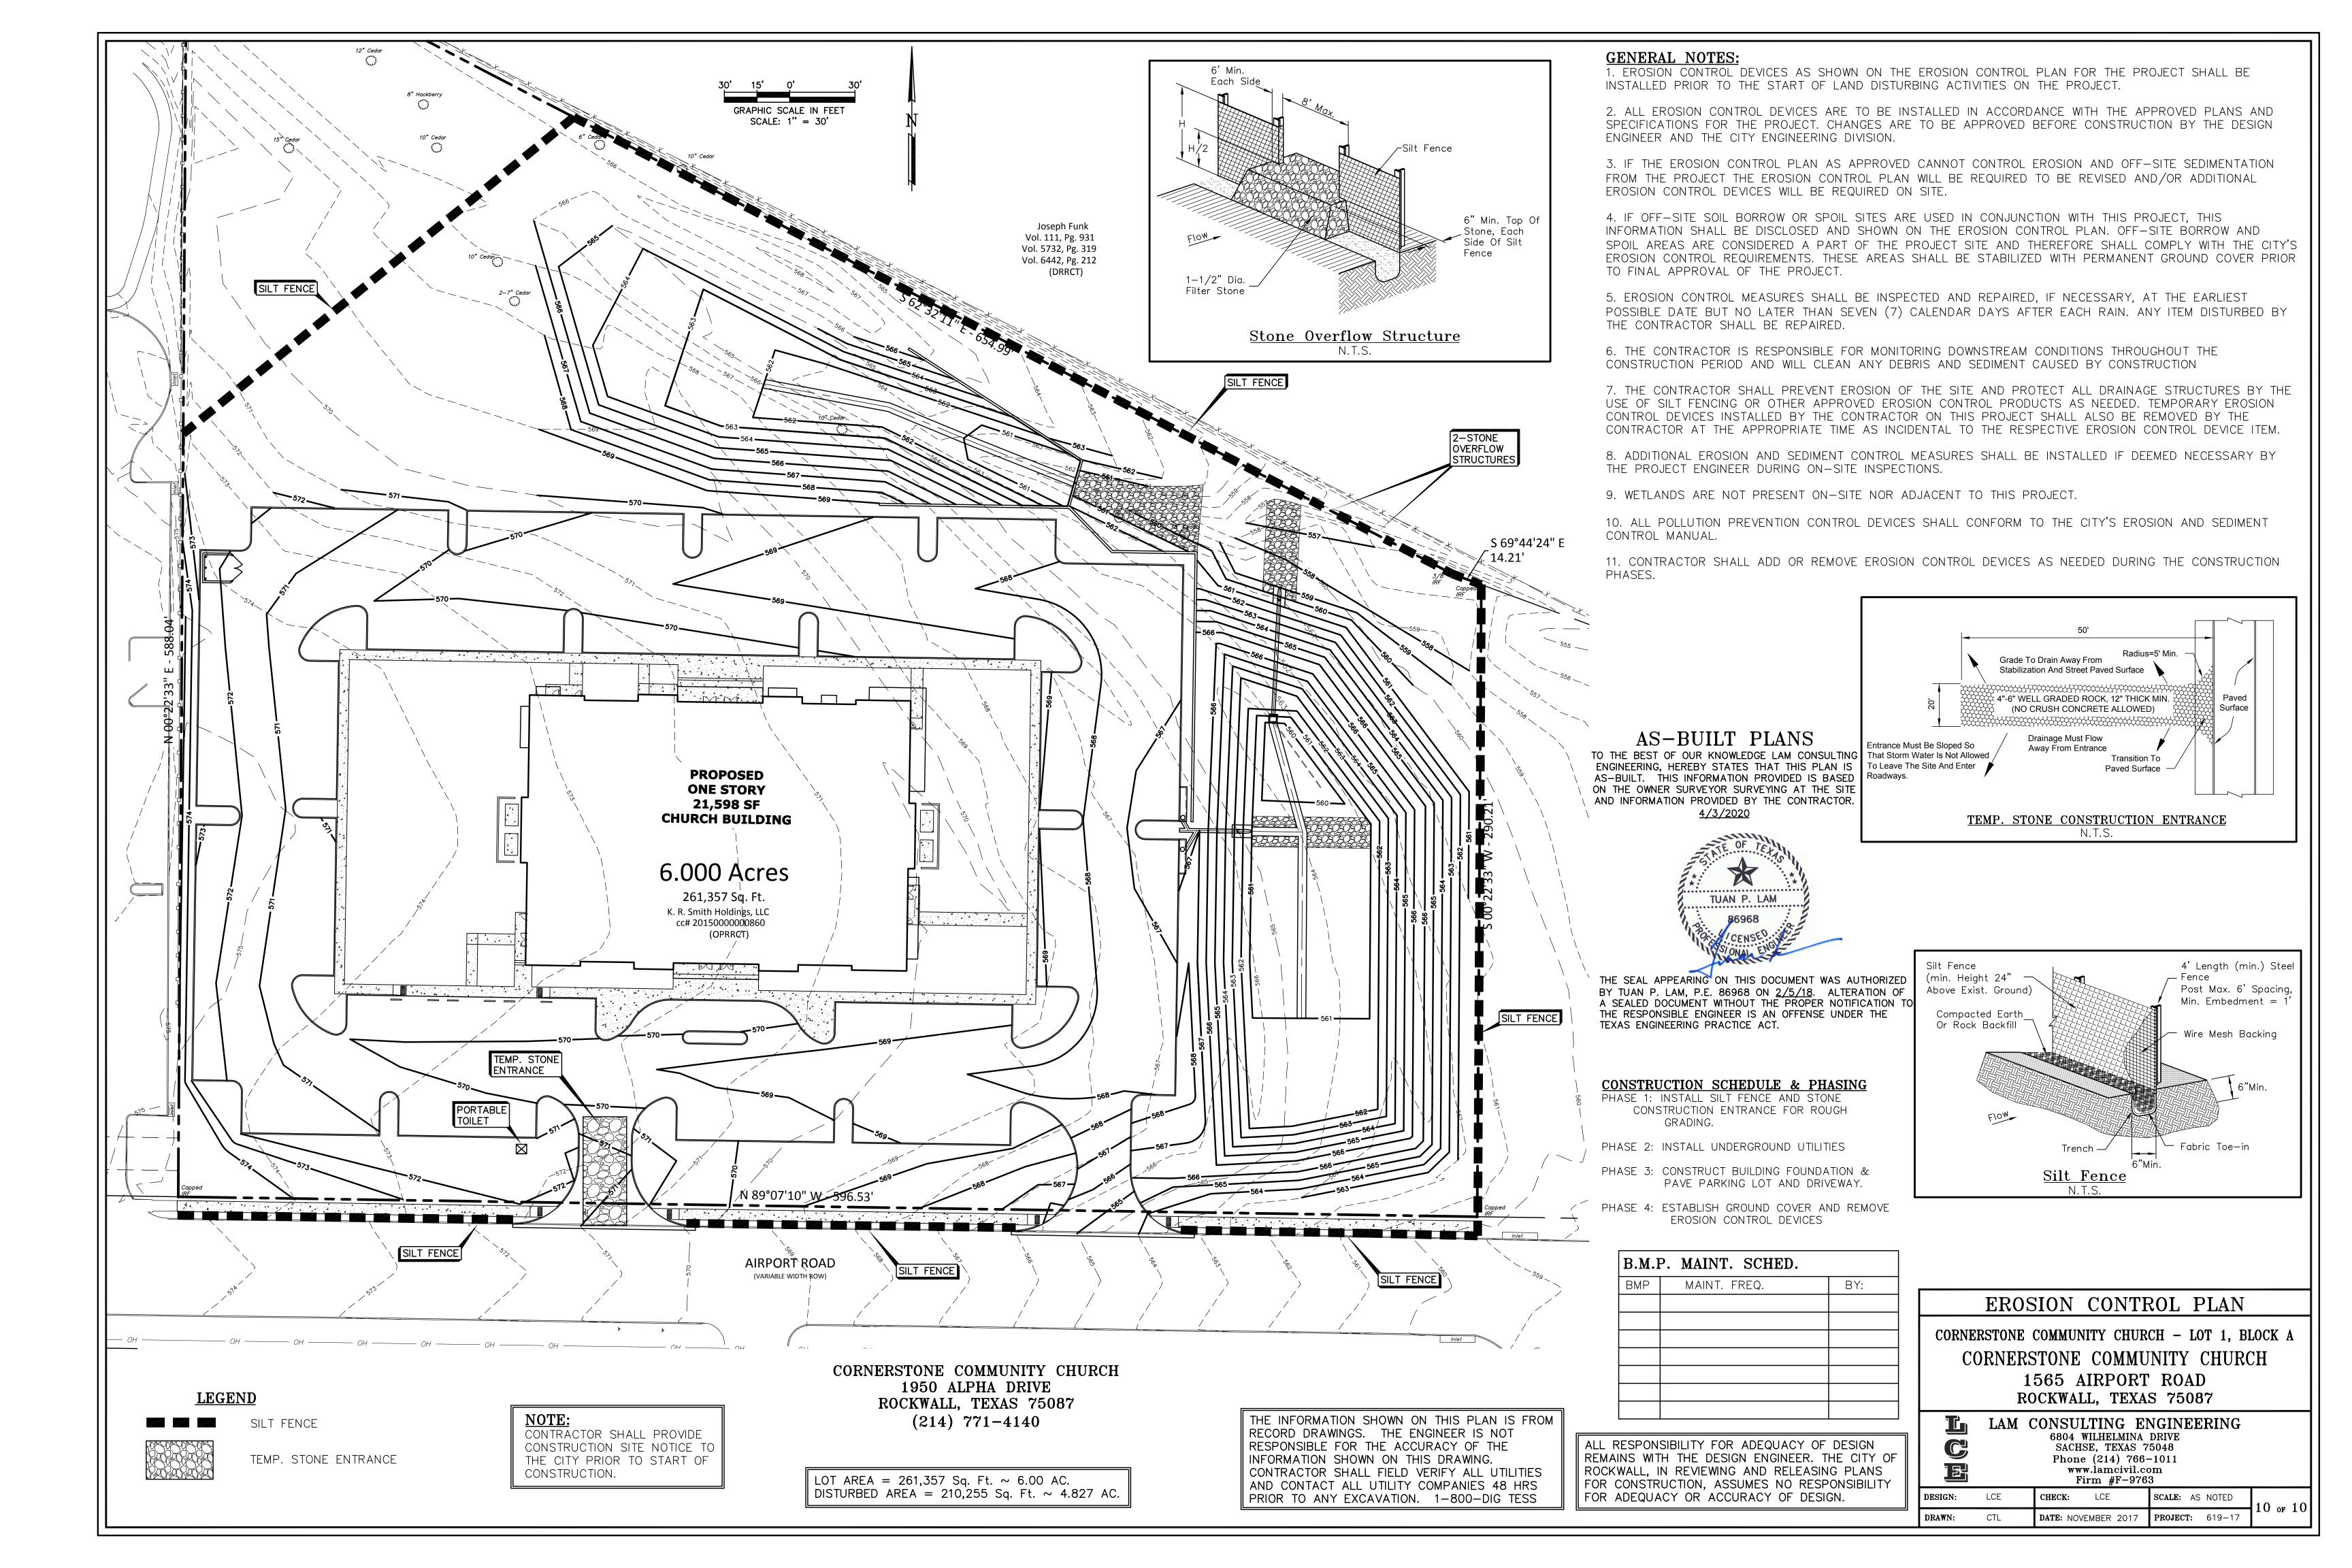

PAVING AND OTHER SITE IMPROVEMENTS, REFER TO CIVIL AND ARCH. DWGS.

2. FOR SECTIONS AND DETAILS AND GENERAL NOTES, SEE DWG. S201.

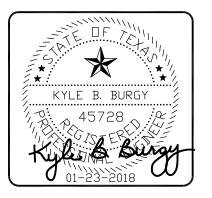

CORNERSTONE CHURCH 1565 AIRPORT ROAD ROCKWALL, TEXAS 75087


DATE: JAN. 23, 2018


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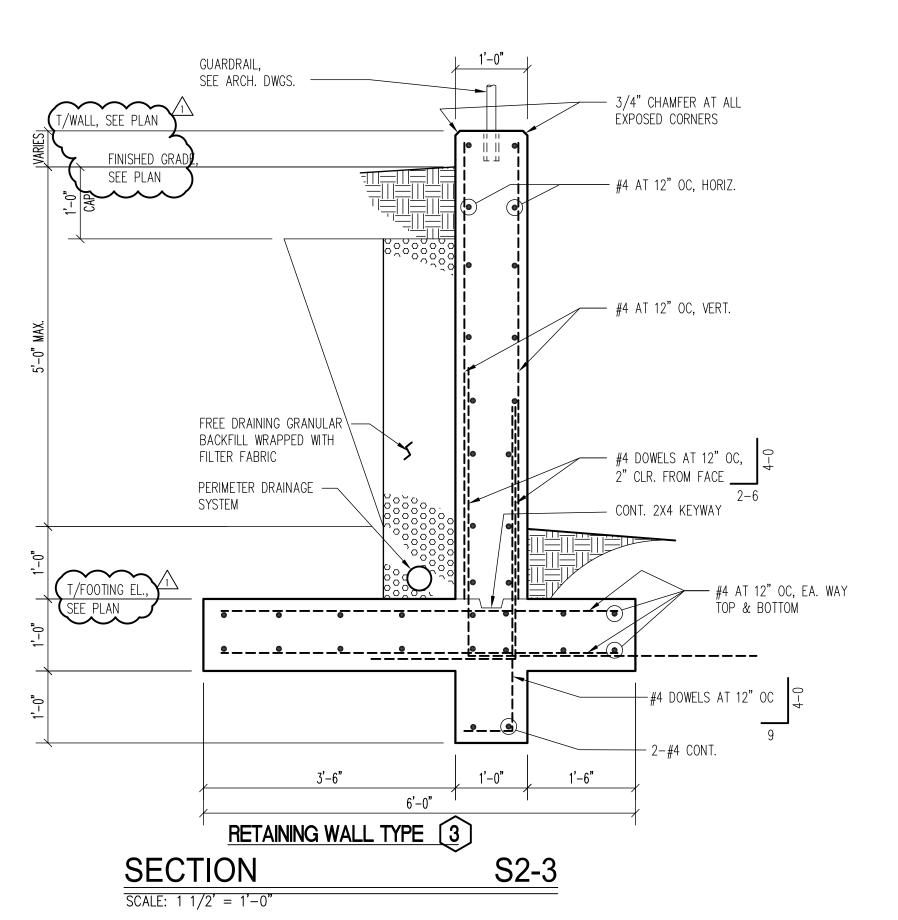
RETAINING WALL


SCALE: AS NOTED

**S101** 



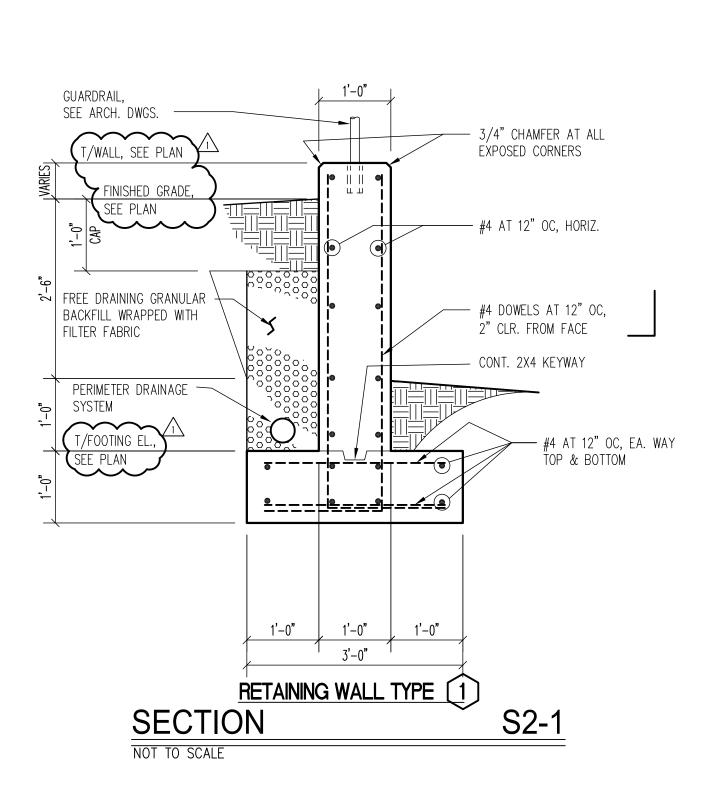

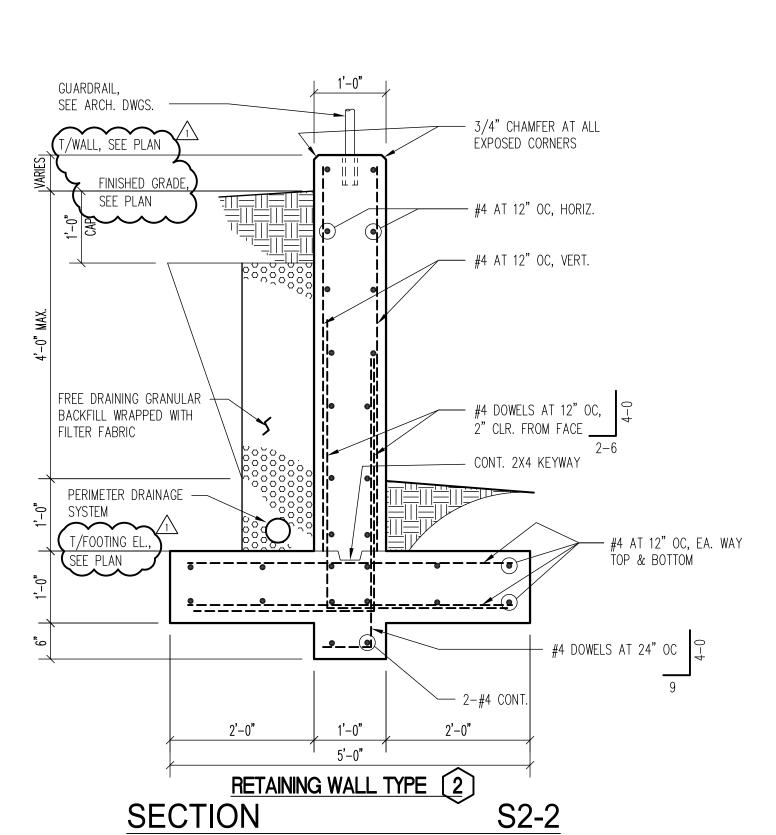

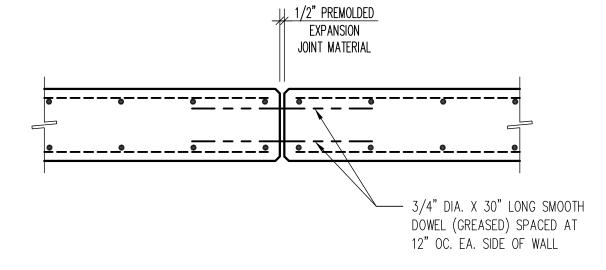

# TYPICAL EXPANSION JOINT DETAIL

PLAN DETAIL

S2-5

NOT TO SCALE

1. VERIFY ALL CONDITIONS AT JOBSITE AND REPORT ANY DISCREPANCIES TO

2. SOIL LOADS ARE IN ACCORDANCE WITH SUBSURFACE INVESTIATION NUMBER 17.401 DATED NOVEMBER 21. 2017 BY HOOPER GROUP. INCORPORATED, AND THE INTERNATIONAL BUILDING CODE, 2015 EDITION.

**EXCAVATION AND BACKFILL UNDER WALL FOOTINGS:** 1. AFTER EXCAVATING FOR WALL FOOTINGS, CHECK TO ENSURE THAT SUBGRADE IS FIRM AND CAPABLE OF SUPPORTING WALL LOAD. IF SUBGRADE IS LOOSE OR MUCKY, OVEREXCAVATE TO FIRM SOIL AND REPLACE WITH LIKE SOIL, COMPACTED TO A MINIMUM OF 95 PERCENT STANDARD PROCTOR.

NOT TO SCALE

<u>CAST-IN-PLACE CONCRETE:</u>

1. CAST-IN-PLACE CONCRETE SHALL CONFORM TO 2014 ACI BUILDING CODE UNLESS OTHERWISE NOTED. REINFORCING SHALL BE DETAILED, FABRICATED AND PLACED IN ACCORDANCE WITH ACI DETAILING MANUAL. 2. CONCRETE SHALL BE NORMAL WEIGHT WITH A MINIMUM COMPRESSIVE STRENGTH OF 3000 PSI AT 28 DAYS AND A MINIMUM OF 5 SACKS OF

CEMENT PER CUBIC YARD. 3. MILD STEEL REINFORCING BARS SHALL BE ASTM A615, GRADE 60. 4. WELDED WIRE FABRIC SHALL BE ASTM A185.

5. UNLESS OTHERWISE NOTED ON THE DRAWINGS, PROVIDE ONE #5 CORNER BAR 4'-0" LONG (2' - 0" EACH LEG) FOR EACH OUTSIDE HORIZONTAL BARS AT CORNER'S IN ALL WALLS AND BEAMS.

6. PROVIDE ADDITIONAL REINFORCING OF 2 \_ #5 BARS X 4' - 0" LONG DIAGONAL AT EACH CORNER OF OPENINGS LARGER THAN 10" X 10" IN SLABS, UNLESS NOTED OTHERWISE.

7. BARS CALLED FOR AS CONTINUOUS SHALL HAVE STAGGERED LAPS 38 BAR DIAMETERS (1' - 0" MINIMUM). 8. CONTRACTOR SHALL BE RESPONSIBLE FOR EXTRA CONCRETE REQUIRED DUE

TO POSSIBLE DEFLECTION OF SYSTEM DURING PLACEMENT OF CONCRETE.

9. CHAMFER ALL EXPOSED CORNERS 3/4" HORIZONTALLY AND VERTICALLY. 10. PROVIDE 3 INCH DIAMETER WEEP HOLES AT EIGHT (8) FOOT CENTERS THROUGHOUT LENGTH OF ALL WALLS. CONNECT WEEPS TO CONTINUOUS

PERFORATED PIPE IN BOTTOM OF DRAINAGE TRENCH. 11. LOCATE CONSTRUCTION JOINTS AS INDICATED ON PLANS. 12. MINIMUM CONCRETE COVER OVER REINFORCING BARS SHALL BE: 3" FOR CONCRETE CAST AGAINST SOIL

2" FOR FOOTINGS AND WALLS EXPOSED TO WEATHER OR SOIL. 13. FULLY BRACE WALLS WHILE BACKFILLING AGAINST THEM. MAINTAIN BRACING IN POSITION UNTIL SOIL CAP IS IN PLACE.

14. REFERENCE ARCHITECTURAL DRAWINGS FOR GUARDRAIL CONSTRUCTION AND CONFIGURATION.

15. REFERENCE ARCHITECTURAL DRAWINGS FOR TEXTURED EXPOSED FACE TREATMENT OF RETAINING WALL.


16. REFERENCE CIVIL DRAWINGS FOR ABOVE—WALL AND BELOW—WALL FINISH GRADES, AND FOR PIPE INVERT ELEVATIONS.


17. EXPANSION JOINTS SHALL BE FORMED AT A MAXIMUM SPACING OF 60 FEET, AND SHALL EXTEND THROUGH THE WALL AND THE FOOTING. EXPANSION JOINTS SHALL BE COMPRISED OF 1/2" PREMOLDED FILLER MATERIAL.

1. DRAINAGE LINER FABRIC SHALL BE TENCATE MIRAFI N-SERIES NONWOVEN POLYPROPYLENE GEOTEXTILES FOR SOIL SEPARATION AND DRAINAGE. INSTALL IN ACCORDANCE WITH THE MANUFACTURER'S INSTRUCTIONS. AS A SPLICE AND 12 INCH MINIMUM TOP OVERLAP.

2. BACKFILL WITH WASHED ROCK, 34 INCH TO 11/2", TYPICAL. 3. CONTINUOUS DRAIN PIPE SHALL BE 4-INCH DIAMETER, SCHEDULE 40 PVC PRE-ENGINEERED PERFORATED FRENCH DRAIN PIPE (DRAIN FABRIC WRAPPED). CONNECT TO WEEP HOLES WITH 3-INCH NON-PERFORATED PVC

4. CLEANOUTS SHALL BE 4-INCH DIAMETER JOSAM 58580-5 SERIES ABS FLOOR ACCESS HOUSING WITH SPECIAL-DUTY SCORIATED SECURED ROUND CAST IRON TOP AND LEVELOC SCREWS. PROVIDE DUCTILE IRON TOP. PROVIDE 4-INCH DIAMETER ACCESS HOUSING ASSEMBLY. PROVIDE CLEANOUT ASSEMBLY WITH SWEEPS, FITTINGS, SPLICES, ETC. LOCATE CLEANOUTS AT DEAD ENDS OF TRENCHES, TURNS, INTERSECTIONS, AND ALONG RUNS OF WALL AT 100 LINEAL FEET, MAXIMUM. PROVIDE SCHEDULE 40 (NON-PERFORATED) PVC ASSEMBLY TO PERFORATED DRAIN PIPE.

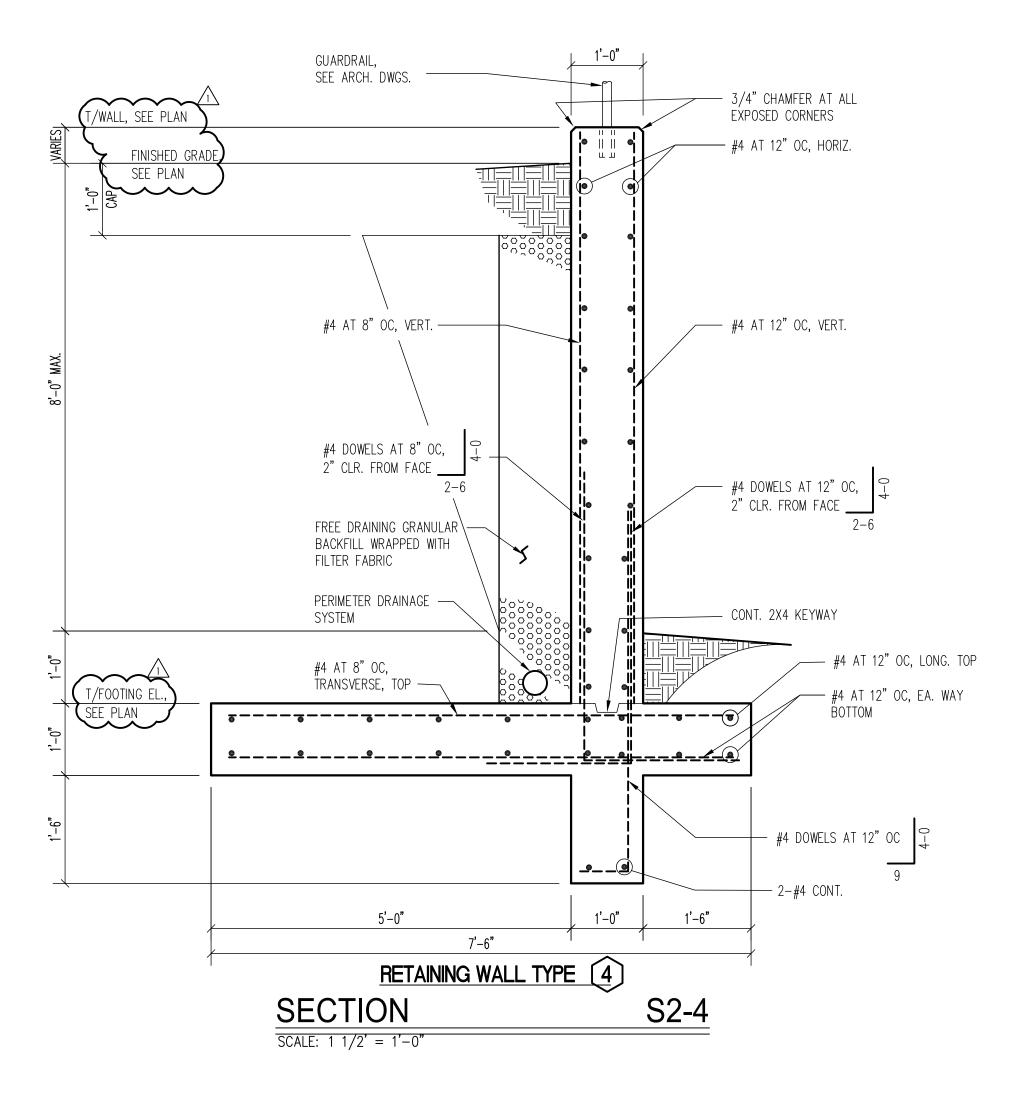

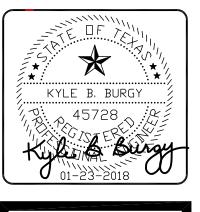



CORNERSTONE CHURCH 1565 AIRPORT ROAD ROCKWALL, TEXAS 75087

MERSHAWN ARCHITEC 2313 RIDGE ROAD ROCKWALL, TEXAS 750

DATE: JAN. 23, 2018 /\ REV. 1 - 01.29.2018

SECTIONS, DETAILS AND GENERAL NOTES

SHEET TITLE:

SCALE: AS NOTED

S201

