BONAFIDE BETTIES PIE COMPANY TCB ADDITION - LOT 1, BLOCK A 505 N. GOLIAD STREET ROCKWALL, TEXAS 75087


SHEET INDEX

- 1 COVER SHEET
- 2 FINAL PLAT (BY OTHERS)
- 3 FINAL PLAT (BY OTHERS)
- 4 SITE PLAN 5 GRADING PLAN
- 6 DRAINAGE AREA MAP
- 7 PAVING PLAN
- 8 EROSION CONTROL PLAN


NOTE: CITY OF ROCKWALL ENGINEERING DEPARTMENT LATEST STANDARD DETAILS AND NCTCOG 4TH EDITION SHALL BE USED FOR CONSTRUCTION OF THIS PROJECT UNLESS OTHERWISE NOTED WITHIN THESE PLANS. THE CONTRACTOR SHALL OBTAIN THE STANDARD DETAIL BOOK FROM THE CITY'S ENGINEERING DEPARTMENT.

TCB CONSTRUCTION GROUP, LLC. 906 N. GOLIAD STREET ROCKWALL, TEXAS 75087 (972) 961-0200

SITE IMPROVEMENTS AUGUST 2019

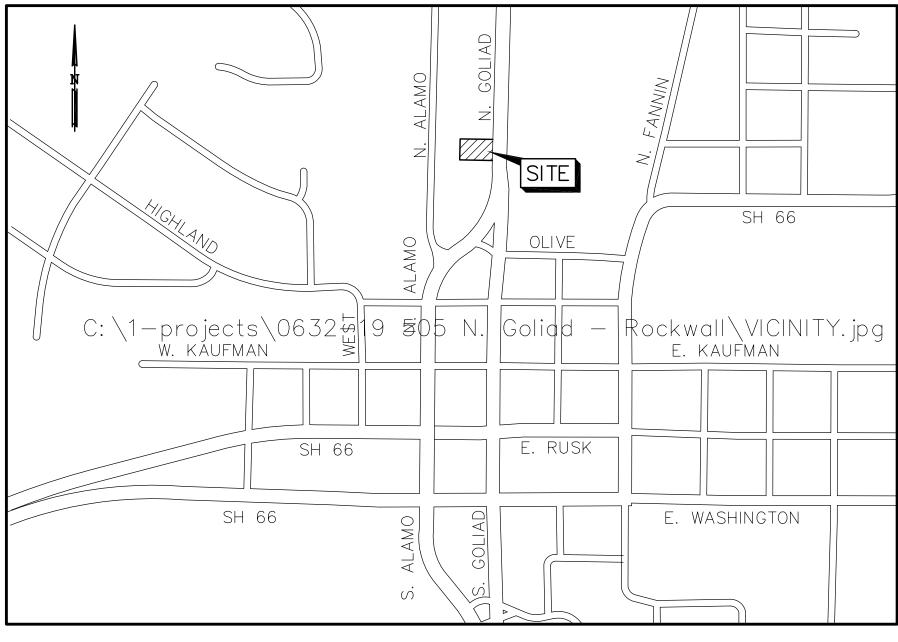

VICINITY MAP

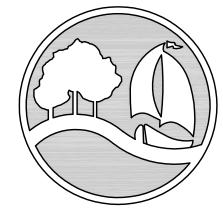

City of Rockwall The New Horizon

PREPARED BY :

LAM CONSULTING ENGINEERING 6804 WILHELMINA DRIVE SACHSE, TEXAS 75048 (214) 766-1011 www.lamcivil.com Firm# F-9763 AS-BUILT PLANS

TO THE BEST OF OUR KNOWLEDGE LAM CONSULTING ENGINEERING, HEREBY STATES THAT THIS PLAN IS AS-BUILT. THIS INFORMATION PROVIDED IS BASED ON THE OWNER SURVEYOR SURVEYING AT THE SITE AND INFORMATION PROVIDED BY THE CONTRACTOR. 10/01/20

ALL RESPONSIBILITY FOR ADEQUACY OF DESIGN REMAINS WITH THE DESIGN ENGINEER. THE CITY OF ROCKWALL, IN REVIEWING AND RELEASING PLANS FOR CONSTRUCTION, ASSUMES NO RESPONSIBILITY FOR ADEQUACY OR ACCURACY OF DESIGN.




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SURVEY INFORMATION ON THIS DRAWING WAS PROVIDED BY OTHERS. LAM CONSULTING ENGINEERING IS NOT RESPONSIBLE FOR THE ACCURACY OF THE TOPOGRAPHIC MAPPING NOR BENCHMARK DATUM.

THE INFORMATION SHOWN ON THIS PLAN IS FROM RECORD DRAWINGS. THE ENGINEER IS NOT RESPONSIBLE FOR THE ACCURACY OF THE INFORMATION SHOWN ON THIS DRAWING. CONTRACTOR SHALL FIELD VERIFY ALL UTILITIES AND CONTACT ALL UTILITY COMPANIES 48 HRS PRIOR TO ANY EXCAVATION. 1-800-DIG TESS BONAFIDE BETTIES PIE COMPANY GOLIAD STREET – ROCKWALL, TEXAS Ζ 505BLOCK LOT ADDITION TCB

LAM CONSULTING ENGINEERING PROJECT #0632-19

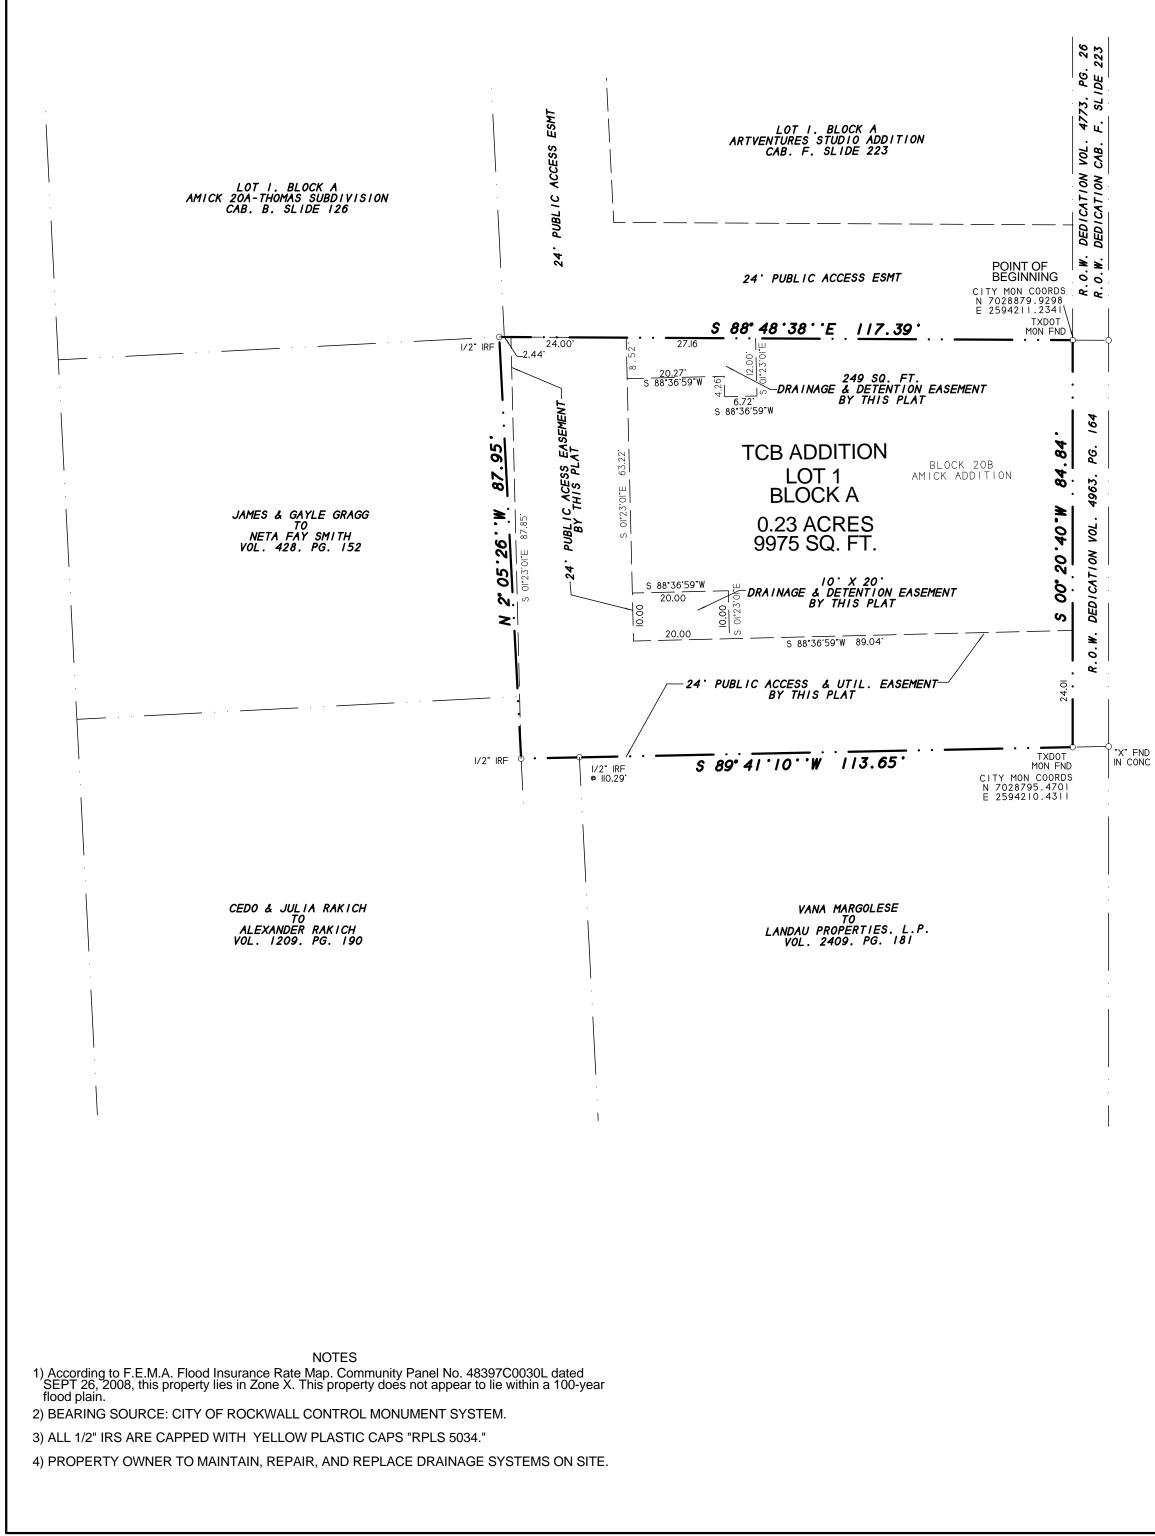

IGHWAY 205 · 0 ° STATE H N. GOL

SITE LOCATION KAUFMAN RUSK STREET WASHINGTO VICINITY MAP N.T.S. GRAPHIC SCALE I" - 20" FINAL PLAT ADDITION ТСВ LOT 1, BLOCK A 0.23 ACRES OR 9975 S.F. (1 LOT)BEING A REPLAT OF BLOCK 20B AMICK ADDITION B. F. BOYDSTUN SURVEY ABSTRACT NO. 14 CITY OF ROCKWALL, ROCKWALL COUNTY, TEXAS SHEET 1 OF 2 SYMBOL LEGEND © © POWER TU GAS TEL FH PP TELEVISION GAS TEL FH PP CABLE RISER METER RISER HYDRANT POLE ELEC ELEC WM LP ELEC ELEC WM LP ELECTRIC BOX WATER LIGHT WETER SUBSURFACE METER POLE JUNCTION BOX OWNER: PRICE POINTER O I/2" IRF IRON ROD FOUNE (CORNER) MANUEL LOZANO 906 N GOLIAD STREEET 0 FENCE ROCKWALL, TEXAS 75087 UNIT PROPAN TANK PROPERTY LINES SURVEY DATE <u>APRIL 19. 2019</u> SCALE <u>1 20</u> FILE # <u>20020657-P</u> CLIENT <u>POINTER & LOZANO</u> H.D. Fetty Land Surveyor, LLC 6770 FM 1565 ROYSE CITY, TX 75189 972-635-2255 PHONE tracy@hdfetty.com CITY CASE P2019-

OWNER'S CERTIFICATE (Public Dedication)

STATE OF TEXAS COUNTY OF ROCKWALL

WHEREAS PRICE POINTER & MANUEL LOZANO, BEING THE OWNERS OF A TRACT OF land in the County of Rockwall, State of Texas, said tract being described as follows:

All that certain lot, tract or parcel of land situated in the B.F. BOYDSTUN SURVEY, ABSTRACT NO. 14, City of Rockwall, Rockwall County, Texas, and being known as a part of Lot 20 of AMICK ADDITION, not of record, and also being a part of a tract of land as described in a Warranty deed from Eddie Walker to Stained Glass Creations, dated August 16, 2002 and being recorded in Volume 2364, Page 181 of the Real Property Records of Rockwall County, Texas, and Correction Warranty deed recorded in Volume 4754, Page 130 of the Official Public Records of Rockwall County, Texas, and being more particularly described as follows: described as follows:

BEGINNING at a TXDOT monument found for corner in the West right-of-way line of State Highway 205 N. Goliad Street, at the intersection of said right-of-way with the north line of the above cited tract;

THENCE S. 00 deg. 20 min. 40 sec. W. along said right-of-way line, a distance of 84.84 feet to a TXDOT monument found for corner in the North line of a tract of land as described in a Warranty deed from Vana Margolese to Landau Properties, LP, dated January 23, 2002, and being recorded in Volume 2409, Page 181 of the Real Property Records of Rockwall County, Texas;

THENCE S. 89 deg. 41 min. 10 sec. W. along the common line between said tracts, a distance of 113.65 feet to a 1/2" iron rod found for corner at the Southwest corner of the above cited tract;

THENCE N. 02 deg. 05 min. 26 sec. W. along the West line of said tract, a distance of 87.95 feet to a 1/2" iron rod found for corner being the Northwest corner of said tract;

THENCE S. 88 deg. 48 min. 38 sec. E. a distance of 117.39 feet to the POINT OF BEGINNING and containing 9,975 square feet or 0.23 acres of land.

NOW, THEREFORE, KNOW ALL MEN BY THESE PRESENTS:

STATE OF TEXAS COUNTY OF ROCKWALL

I the undersigned owner of the land shown on this plat, and designated herein as TCB ADDITION, LOT 1, BLOCK A, an Addition to the City of Rockwall, Texas, and whose name is subscribed hereto, hereby dedicate to the use of the public forever all streets, alleys, parks, water courses, drains, easements and public places thereon shown on the purpose and consideration therein expressed. I further certify that all other parties who have a mortgage or lien interest in TCB ADDITION, LOT 1, BLOCK A, have been notified and signed this plat.

I understand and do hereby reserve the easement strips shown on this plat for the purposes stated and for the mutual use and accommodation of all utilities desiring to use or using same.

I also understand the following:

1. No buildings shall be constructed or placed upon, over, or across the utility easements as described herein

2. Any public utility shall have the right to remove and keep removed all or part of any buildings, fences, trees, shrubs, or other growths or improvements which in any way endanger or interfere with construction, maintenance or efficiency of their respective system on any of these easement strips; and any public utility shall at all times have the right of ingress or egress to, from and upon the said easement strips for purpose of construction, reconstruction, inspecting, patrolling, maint aining, and either adding to or removing all or part of their respective system without the necessity of, at any time, procuring the permission of anyone.

3. The City of Rockwall will not be responsible for any claims of any nature resulting from or occasioned by the establishment of grade of streets in the subdivision.

4. The developer and subdivision engineer shall bear total responsibility for storm drain improvements.

5. The developer shall be responsible for the necessary facilities to provide drainage patterns and drainage controls such that properties within the drainage area are not adversely affected by storm drainage from the development. Property owner is responsible for all maintenance, repair, and replacement of storm systems in easements.

6. No house dwelling unit, or other structure shall be constructed on any lot in this addition by the owner or any other person until the developer and/or owner has complied with all requirements of the Subdivision Regulations of the City of Roc kwall regarding improvements with respect to the entire block on the street or streets on which property abuts, including the actual installation of streets with the required base and paving, curb and gutter, water and sewer, drainage structures, stor m structures, storm sewers, and alleys, all according to the specifications of the City of Rockwall; or

Until an escrow deposit, sufficient to pay for the cost of such improvements, as determined by the city's engineer and/or city administrator, computed on a private commercial rate basis, has been made with the city secretary, accompanied by an agreement signed by the developer and/or owner, authorizing the city to make such improvements at prevailing private commercial rates, or have the same made by a contractor and pay for the same out of the escrow deposit, should the developer and/or the same out of the escrow deposit, should the developer an d/or owner fail or refuse to install the required improvements within the time stated in such written agreement, but in no case shall the City be obligated to make such improvements itself. Such deposit may be used by the owner and/or developer as p rogress. payments as the work progresses in making such improvements by making certified requisitions to the city secretary, supported by evidence of work done; or

Until the developer and/or owner files a corporate surety bond with the city secretary in a sum equal to the cost of such improvements for the designated area, guaranteeing the installation thereof within the time stated in the bond, which time shall be fixed by the city council of the City of Rockwall.

I further acknowledge that the dedications and/or exaction's made herein are proportional to the impact of the subdivision upon the public services required in order that the development will comport with the present and future growth needs of the City; I, my successors and assigns hereby waive any claim, damage, or cause of action that I may have as a result of the dedication of exaction's made herein.

PRICE POINTER

MANUEL LOZANO

STATE OF TEXAS COUNTY OF ROCKWALL

Before me, the undersigned authority, on this day personally appeared PRICE POINTER known to me to be the person whose name is subscribed to the foregoing instrument, and acknowledged to me that he executed the same for the purpose and consideration therein stated.

Given upon my hand and seal of office this _____day of _

Notary Public in and for the State of Texas

My Commission Expires:

NOTE: It shall be the policy of the City of Rockwall to withhold issuing building permits until all streets, water, sewer and storm drainage systems have been accepted by the City. The approval of a plat by the City does not constitute any representation, assurance or guarantee that any building within such plat shall be approved, authorized or permit therefore issued, as required under Ordinance 83-54.

STATE OF TEXAS COUNTY OF ROCKWALL

Before me, the undersigned authority, on this day personally appeared MANUEL LOZANO known to me to be the person whose name is subscribed to the foregoing instrument, and acknowledged to me that he executed the same for the purpose and consideration therein stated.


Given upon my hand and seal of office this _____day of ___

Notary Public in and for the State of Texas


SURVEYOR'S CERTIFICATE	
NOW, THEREFORE KNOW ALL MEN BY THESE PRESENTS: THAT I, Harold D. Fetty, III, R.P.L.S. No. 5034, do hereby certify that I prepared this from an actual and accurate survey of the land, and that the corner monuments show were properly placed under my personal supervision.	plat wn thereon
	A E OF TE+ S EGISTER TR
Harold D. Fotty III	HAROLD D. FETTY III
Harold D. Fetty, III Registered Professional Land Surveyor No. 5034	⁵⁰³⁴ ⁶ ⁷⁰ ⁶ ⁷ ⁹ ND SURVE ¹⁰
RECOMMENDED FOR FINAL APPROVAL	- Yoa
Planning and Zoning Commission Date	
APPROVED	
I hereby certify that the above and foregoing plat of TCB ADDITION, LOT 1, BLOCK A, an a to the City of Rockwall, Texas, an addition to the City of Rockwall, Texas, was approved by Council of the City of Rockwall on the day of	ddition the City
This approval shall be invalid unless the approved plat for such addition is recorded in the office of the County Clerk of Rockwall, County, Texas, within one hundred eighty (180) days from said date of final approval.	
Said addition shall be subject to all the requirements of the Subdivision Regulations of the City of Rockwall.	
WITNESS OUR HANDS, this day of,	
Mayor, City of Rockwall City Secretary City of Rockwall	
City Engineer Date	
FINAL PLAT	
TCB ADDITION	
LOT 1, BLOCK A	A
0.23 ACRES OR 9975 S.F.	
(1 LOT) BEING A REPLAT OF BLOCK 2	0 B
AMICK ADDITION B. F. BOYDSTUN SURVEY ABSTRACT NO. 14	
CITY OF ROCKWALL, ROCKWALL COU	JNTY, TEXAS
	SHEET 2 OF 2
OWNER:	SYMBOL LEGEND © © TV GAS TEL FH PP
PRICE POINTER MANUEL LOZANO	TELEVISION GAS PHONE FIRE POWER CABLE RISER NUTER RISER HYDRANT POLE ELEC ELEC WATER LIGHT RIGHT RON ROD FOUND ELECTRIC BOX WATER LIGHT RON ROD FOUND METER SUBSURFACE METER POLE
906 N GOLIAD STREEET ROCKWALL, TEXAS 75087	PELER SUBJICATURE TOLE TOLE
H.D. Fetty Land Surveyor, LLC	SURVEY DATE APRIL 19. 2019 SCALE I* - 20' FILE # 20020657-P CLIENT POINTER & LOZANO
Firm Registration no. 10150900 6770 FM 1565 ROYSE CITY, TX 75189 972-635-2255 P	

My Commission Expires:

CITY CASE P2019-

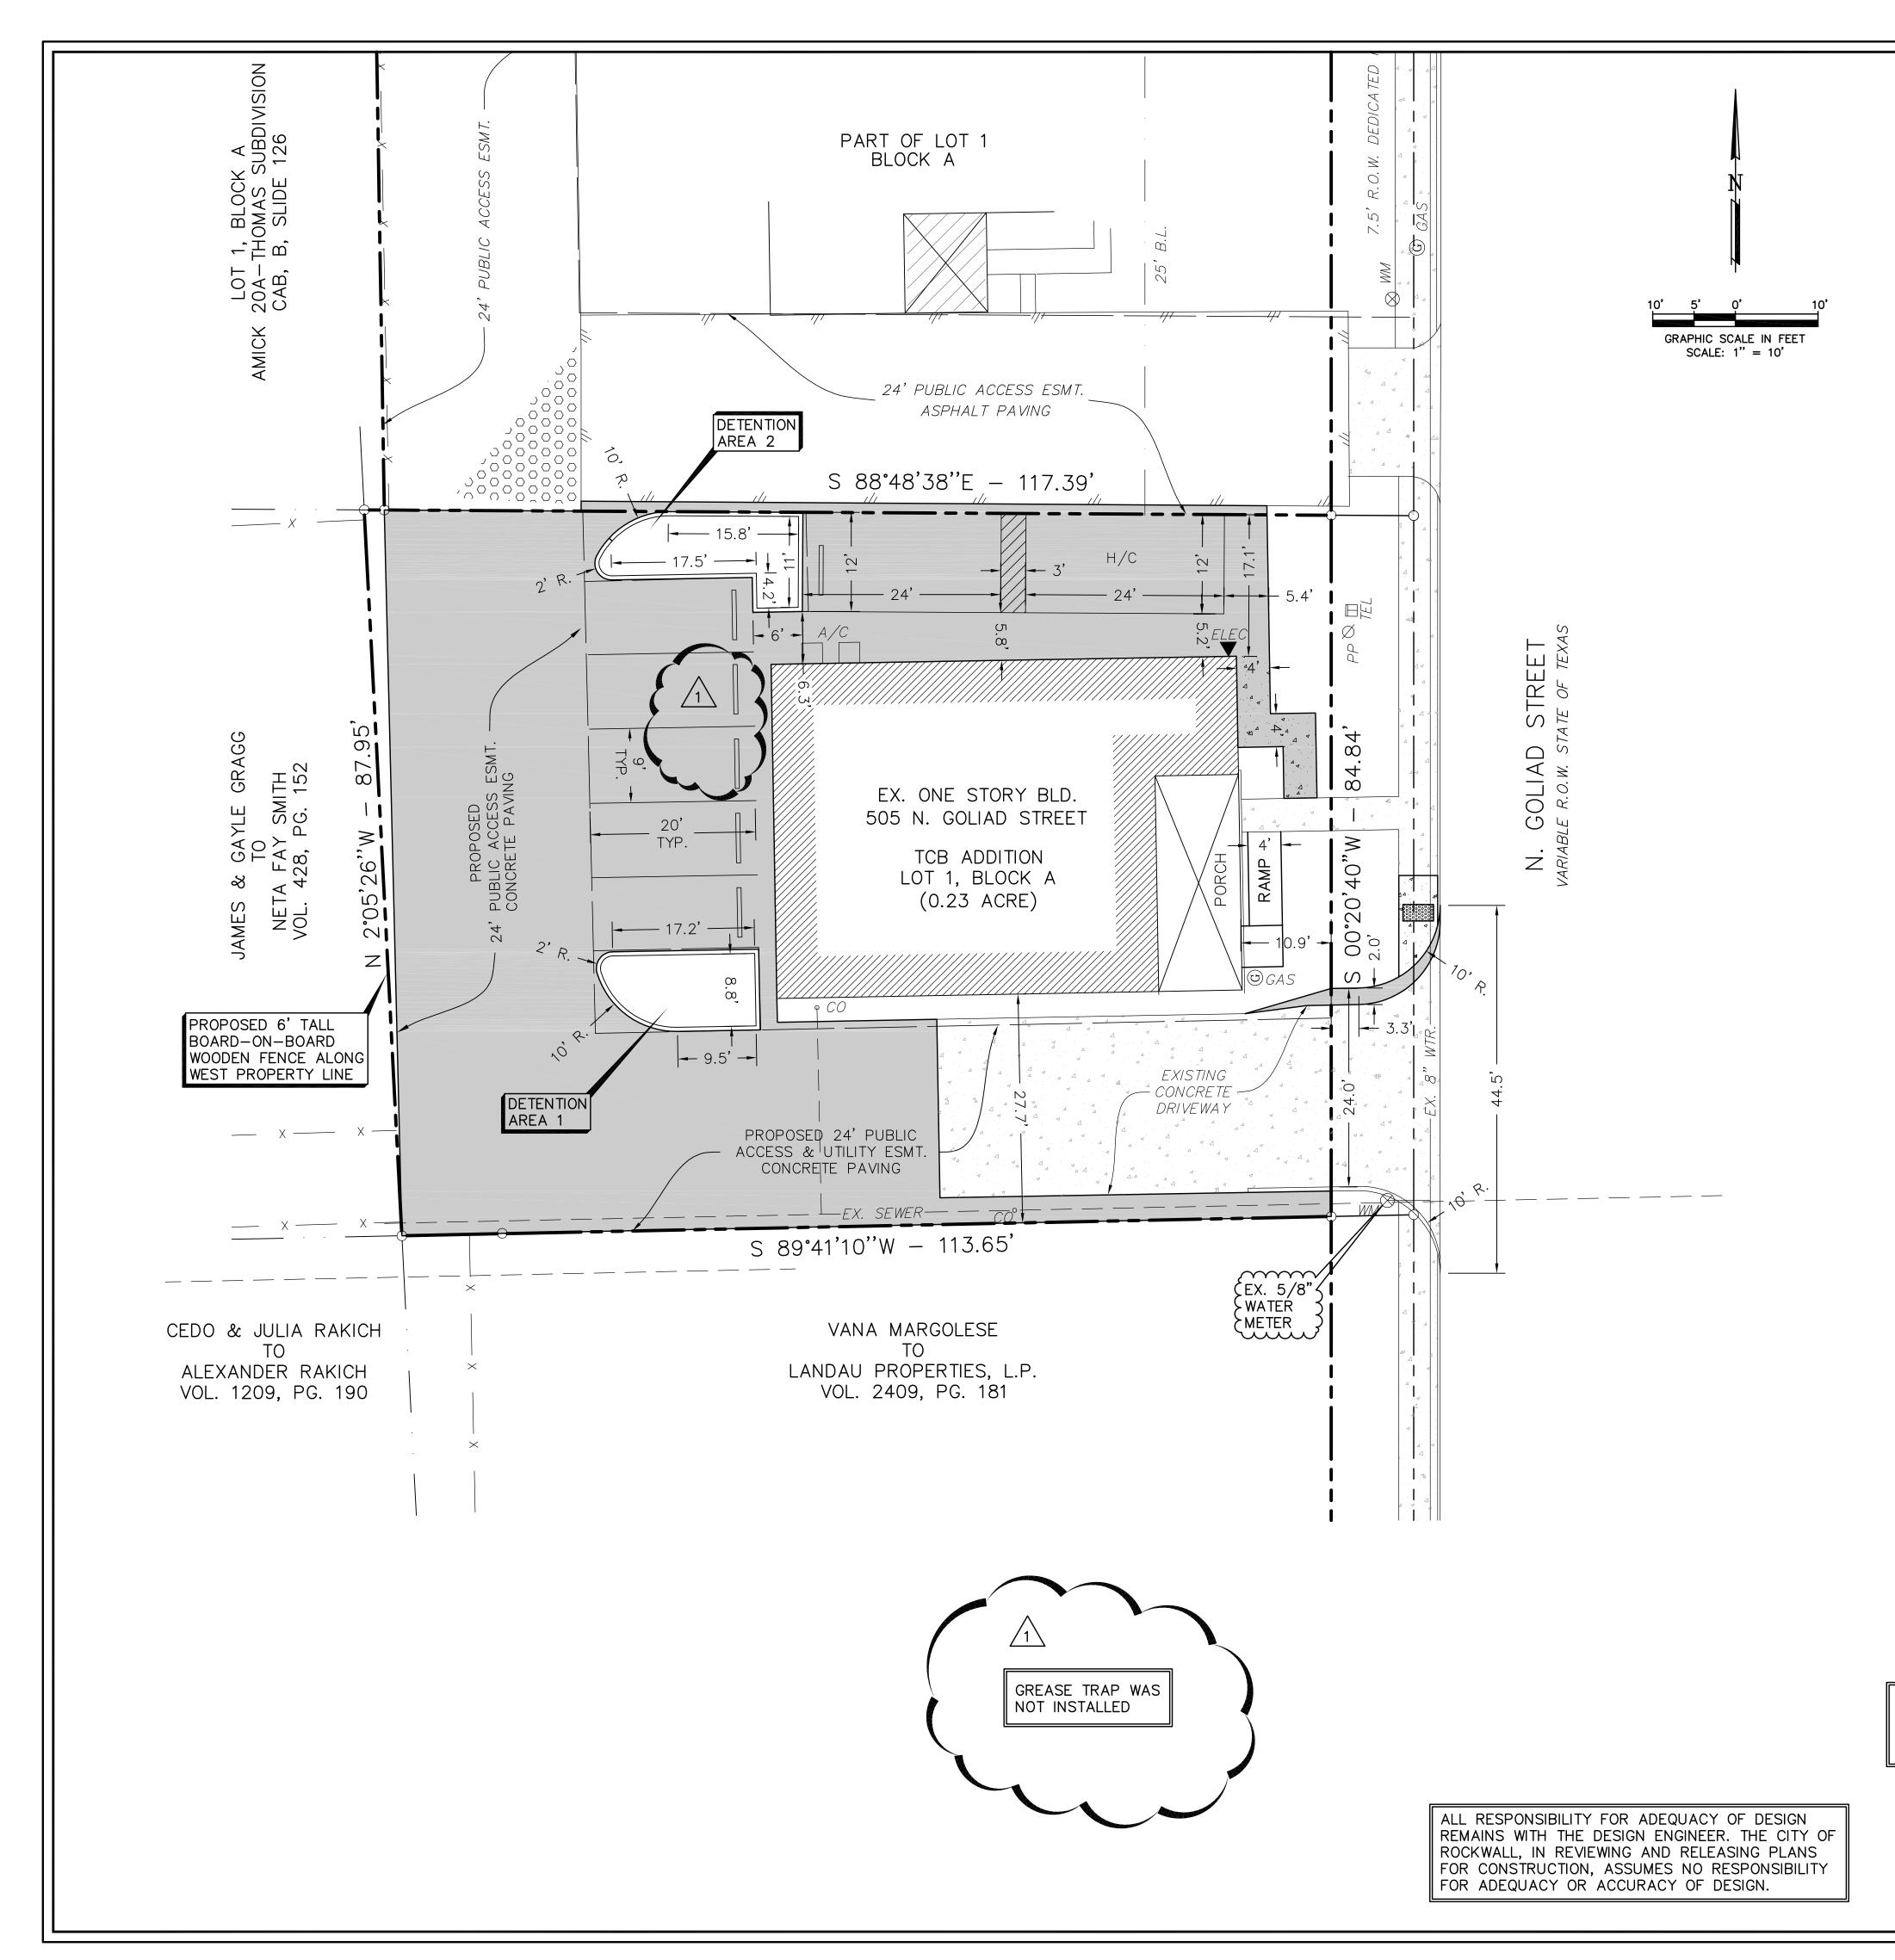

SURVEY INFORMATION ON THIS DRAWING WAS PROVIDED BY OTHERS. LAM CONSULTING ENGINEERING IS NOT RESPONSIBLE FOR THE ACCURACY OF THE TOPOGRAPHIC MAPPING NOR BENCHMARK DATUM.

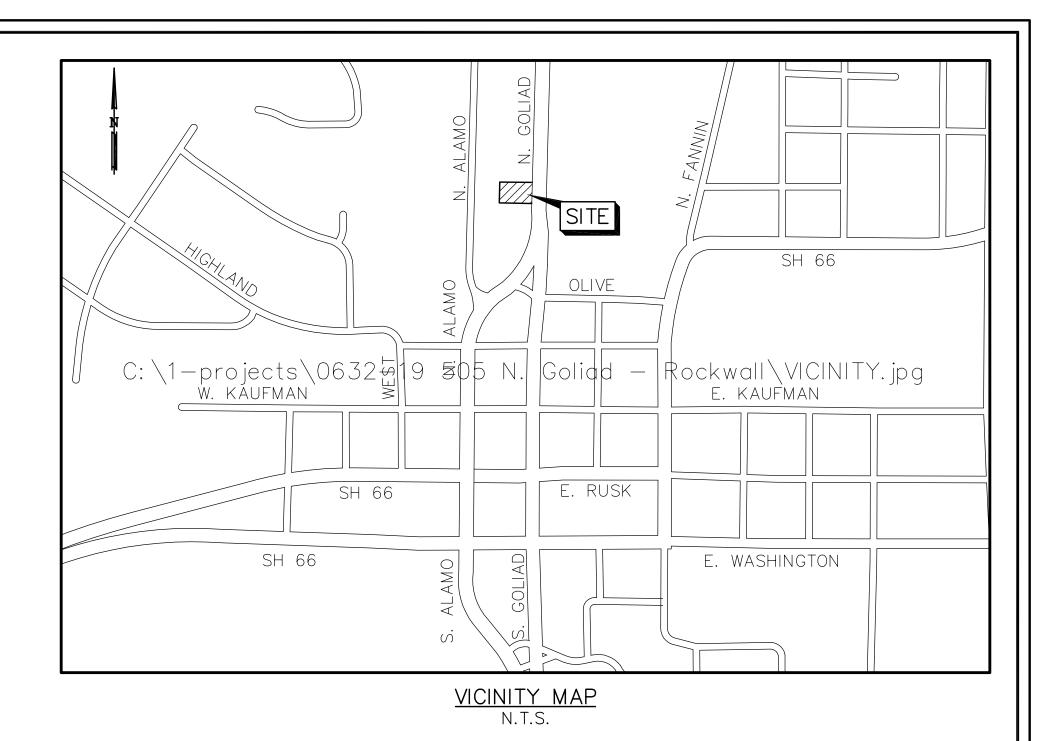

<u>OWNER:</u> TCB CONSTRUCTION GROUP, LLC. 906 N. GOLIAD STREET ROCKWALL, TEXAS 75087

SITE DATA

LOT AREA	10,019 SF ~ 0.23 AC
ZONING	PD-50 NORTH GOLIAD OVERLAY DISTRICT
INSIDE BUILDING AREA	1916 SF
FRONT PORCH	264 SF
PARKING REQUIRED	8 SPACES
PARKING PROVIDED	7 SPACES



AS-BUILT PLANS TO THE BEST OF OUR KNOWLEDGE LAM CONSULTING ENGINEERING, HEREBY STATES THAT THIS PLAN IS AS-BUILT. THIS INFORMATION PROVIDED IS BASED ON THE OWNER SURVEYOR SURVEYING AT THE SITE AND INFORMATION PROVIDED BY THE CONTRACTOR. <u>10/01/20</u>

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CASE No. SP2019-015

SITE PLAN


TCB ADDITION - LOT 1, BLOCK A BONAFIDE BETTIES PIES CO. 505 N. GOLIAD STREET ROCKWALL, TEXAS 75087 LAM CONSULTING ENGINEERING 6804 WILHELMINA DRIVE C SACHSE, TEXAS 75048 Phone (214) 766-1011 www.lamcivil.com Firm #F-9763] 54 DESIGN: LCE CHECK: LCE SCALE: AS NOTED

DATE: MAY 2019

DRAWN: CTL

4 of 8

PROJECT: 632–19

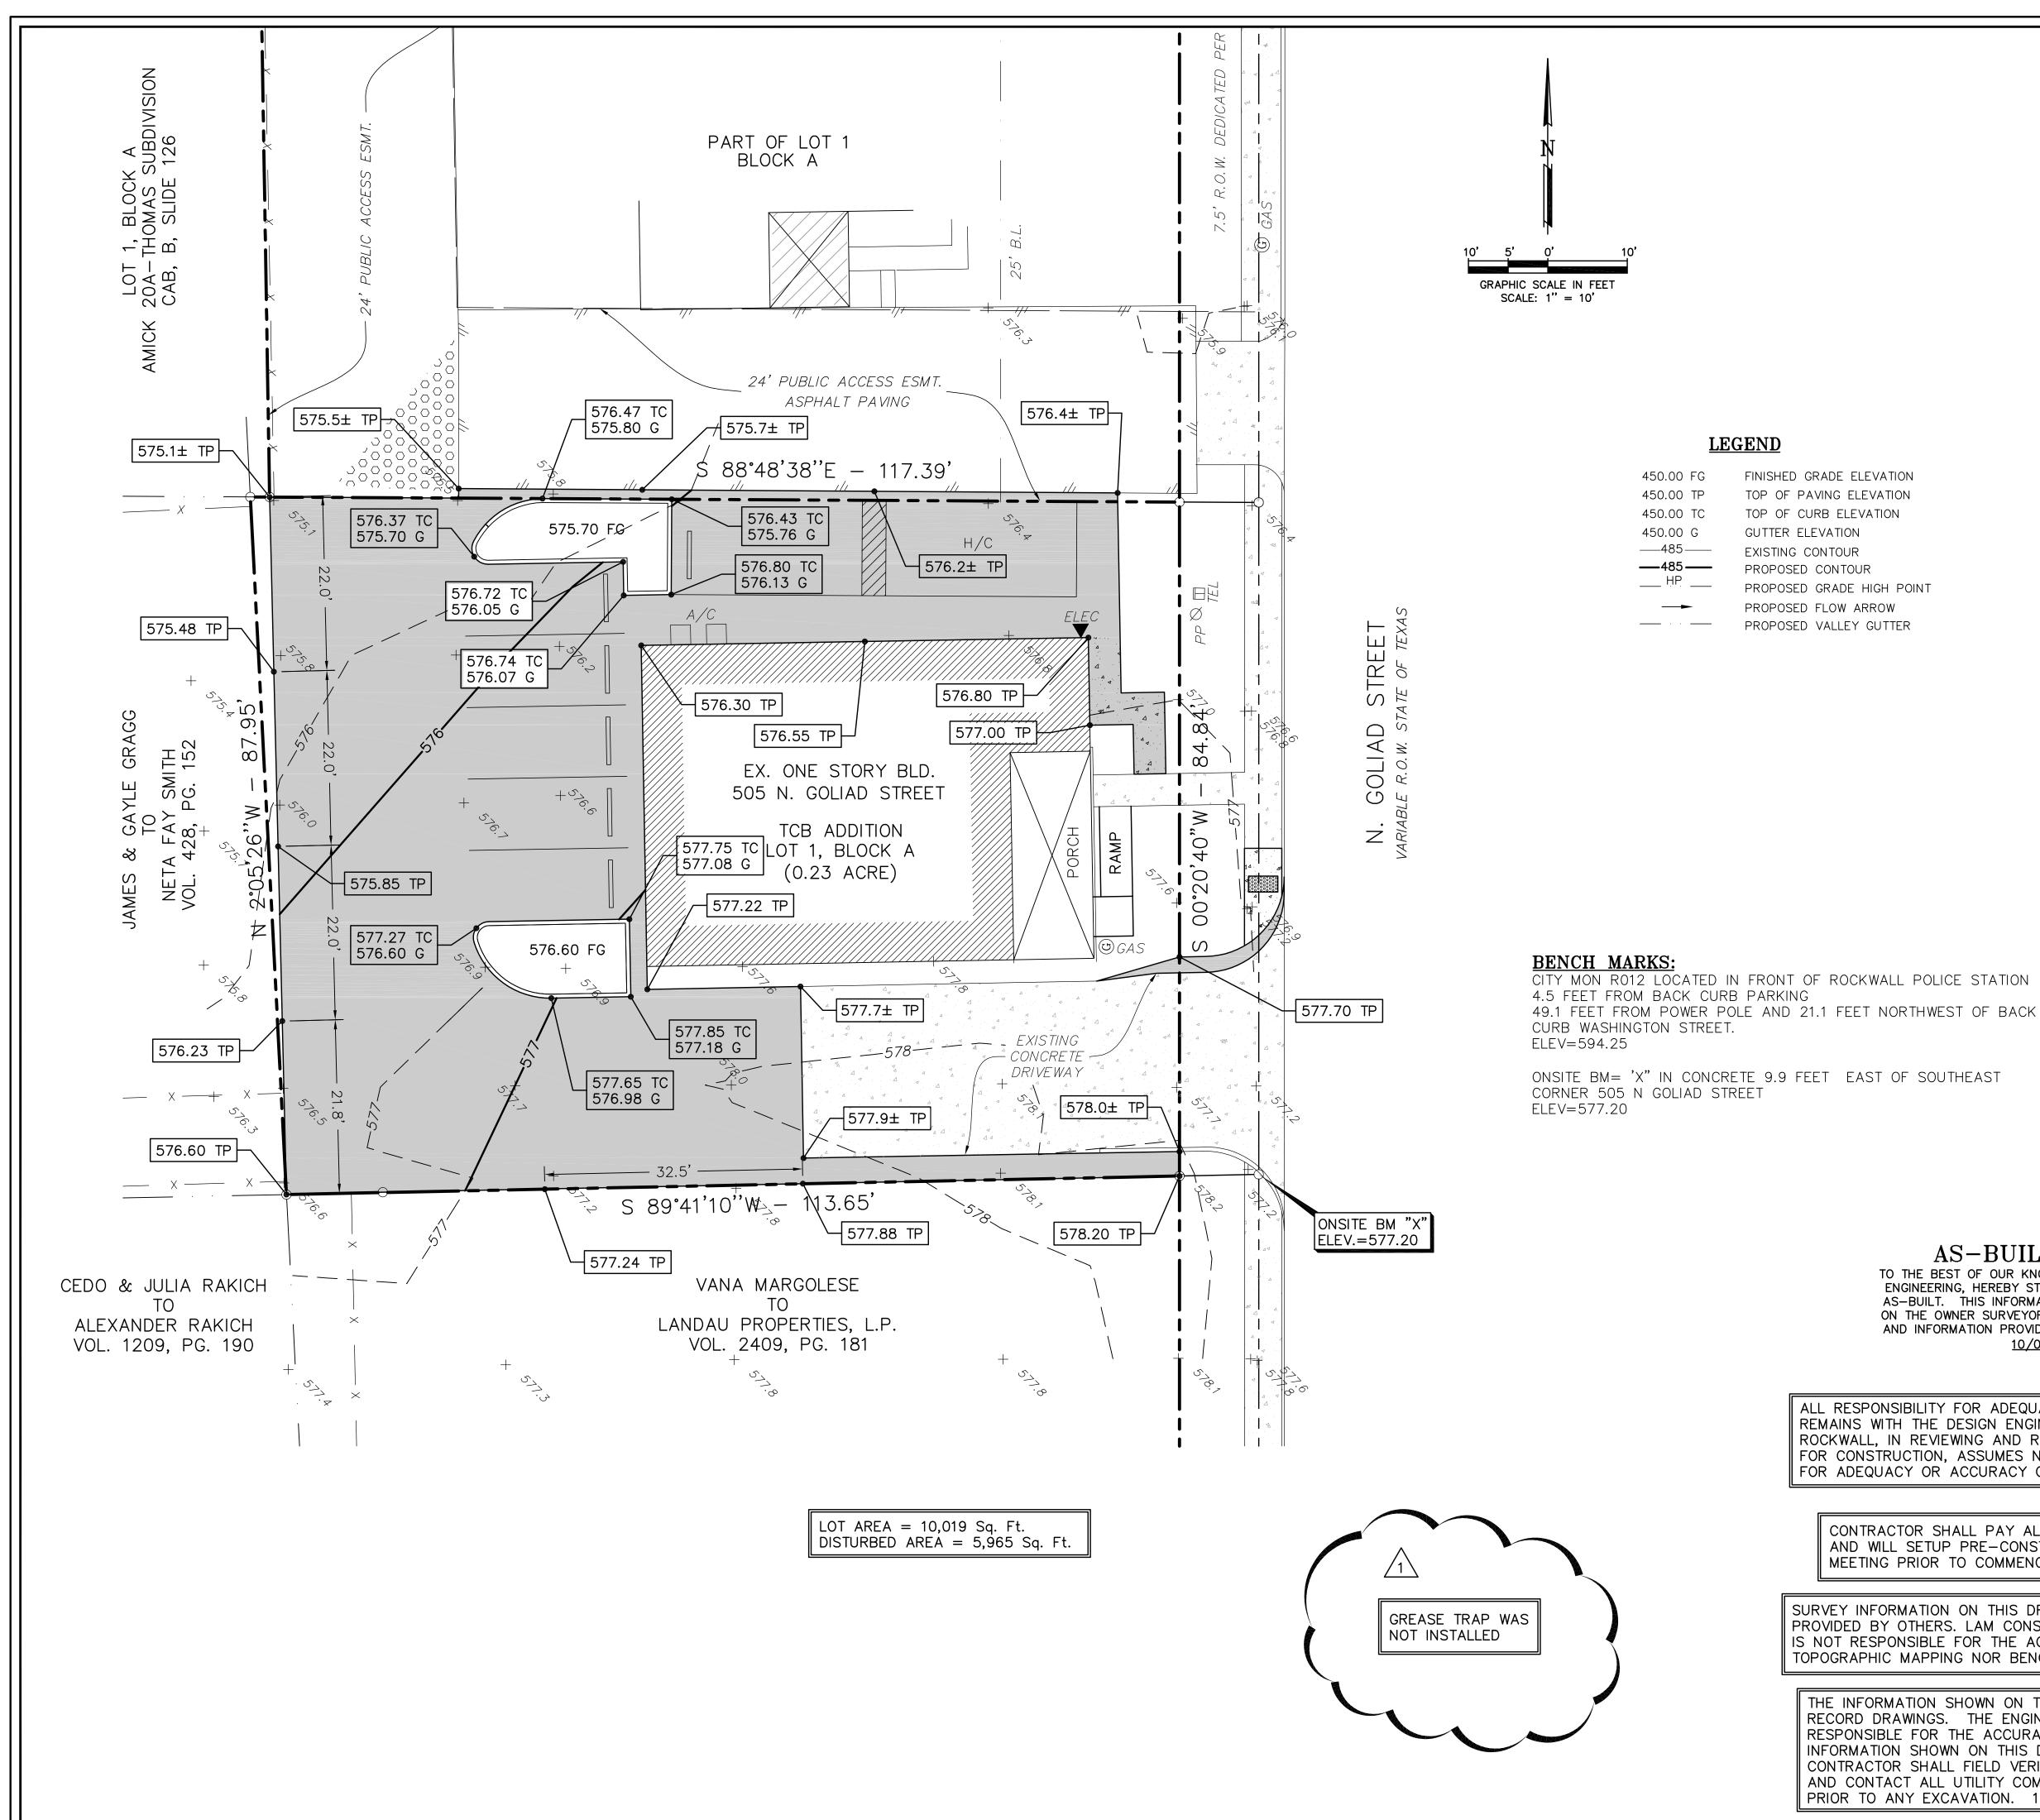

GRADING NOTES:

1. ALL MATERIALS AND CONSTRUCTION SHALL CONFORM TO THE CITY'S PLANS AND SPECIFICATIONS, EXCEPT AS NOTED HEREIN AND APPROVED BY THE CITY AND NCTCOG 4TH EDITION.

2. THE LOCATION OF ALL UTILITIES LOCATED ON THESE PLANS ARE TAKEN FROM EXISTING PUBLIC RECORDS. THE EXACT LOCATION AND ELEVATION OF ALL PUBLIC UTILITIES MUST BE DETERMINED BY THE CONTRACTOR. IT SHALL BE THE DUTY OF THE CONTRACTOR TO ASCERTAIN WHETHER ANY ADDITIONAL FACILITIES OTHER THAN THOSE SHOWN ON THE PLANS MAY BE PRESENT.

3. IT SHALL BE THE RESPONSIBILITY OF THE CONTRACTOR TO PROTECT ALL PUBLIC UTILITIES IN THE CONSTRUCTION OF THIS PROJECT. ALL MANHOLES, CLEAN-OUTS, VALVE BOXES, FIRE HYDRANTS, ETC. MUST BE ADJUSTED TO PROPER LINE AND GRADE BY THE CONTRACTOR PRIOR TO AND AFTER THE PLACING OF PERMANENT PAVING. UTILITIES MUST BE MAINTAINED TO PROPER LINE AND GRADE DURING CONSTRUCTION OF THE PAVING FOR THIS DEVELOPMENT.

4. DRAINAGE SHOULD BE MAINTAINED AWAY FROM THE FOUNDATIONS, BOTH DURING AND AFTER CONSTRUCTION.

6. CONTRACTOR TO ADJUST ALL EXISTING AND PROPOSED UTILITIES AND STORM TO FINAL GRADE.

7. THE SUBGRADE IN AREAS TO BE FILLED SHOULD BE STRIPPED OF VEGETATION AND ANY MAJOR ROOT SYSTEMS. IT SHOULD THEN BE PROOFROLLED WITH HEAVY PNEUMATIC EQUIPMENT. ANY SOFT PUMPING AREAS SHOULD BE UNDERCUT AND PROPERLY BACKFILLED. THE SUBGRADE SHOULD THEN BE SCARIFIED TO A MINIMUM +2 PERCENTAGE POINTS ABOVE THE SOIL'S OPTIMUM MOISTURE DETERMINED BY THAT TEST.

8. ALL BACKFILL SHALL BE COMPACTED TO 95% PROCTOR DENSITY. BACKFILL SHOULD BE STRIPPED OF VEGETATION AND ANY MAJOR ROOT SYSTEMS. IT SHOULD THEN BE PROOFROLLED WITH HEAVY PNEUMATIC EQUIPMENT. ANY SOFT PUMPING AREAS SHOULD BE UNDERCUT AND PROPERLY BACKFILLED. THE BACKFILL SHOULD THEN BE SCARIFIED TO A MINIMUM +2 PERCENTAGE POINTS ABOVE THE SOIL'S OPTIMUM MOISTURE DETERMINED BY THAT TEST. THE FILL MATERIALS SHOULD THEN BE SPREAD IN LOOSE LIFTS, LESS THAN 8 INCHES THICK, AND UNIFORMLY COMPACTED TO THE SAME CRITERIA. IF FILLING IS SUSPENDED AND THE SUBGRADE BECOMES DESICCATED OR RUTTED, IT SHOULD BE REWORKED PRIOR TO PLACEMENT OF A SUBSEQUENT LIFT. ALL FILL TO BE COMPACTED USING A SHEEP FOOT ROLLER.


9. COMPACTION TEST SHALL BE DONE FOR EACH 8" OF FILL, BUT NOT LESS THAN ONE TEST FOR EVERY CUBIC YARDS, OR MORE FREQUENTLY IF REQUIRED BY THE SOILS ENGINEER.


10. THE CONTRACTOR SHALL BE RESPONSIBLE FOR ANY ADDITIONAL COSTS INCURRED FOR THE INSPECTION AND TESTING OF SOILS DUE TO FAILURE TO COMPLY WITH THE MINIMUM REQUIREMENTS OF THE SOILS REPORT.

11. ALL PROPOSED SPOT SHOTS ARE TOP OF PAVEMENT ELEVATIONS UNLESS OTHERWISE SPECIFIED.

12. ALL DISTURBED AREAS SHALL BE STABILIZED WITH BROADCAST SEED AND FERTILIZER UPON COMPLETION OF GRADING AND PAVING. CONTRACTOR SHALL PROVIDE WATER AS NECESSARY TO ESTABLISH PERMANENT VEGETATION. 75%-80% OF ALL DISTURBED AREA TO HAVE 1" TALL ESTABLISHED GRASS PRIOR TO ENGINEERING ACCEPTANCE. ALL RIGHT-OF-WAYS TO BE SODDED.

AS-BUILT PLANS TO THE BEST OF OUR KNOWLEDGE LAM CONSULTING ENGINEERING, HEREBY STATES THAT THIS PLAN IS AS-BUILT. THIS INFORMATION PROVIDED IS BASED ON THE OWNER SURVEYOR SURVEYING AT THE SITE AND INFORMATION PROVIDED BY THE CONTRACTOR. 10/01/20		TUAN P. LAM			
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D ANY EXCAVATION. 1-800-DIG TESS	DESIGN: LCE DRAWN: CTL	CHECK: LCE DATE: MAY 2019	SCALE: AS NOTED PROJECT: 632-19	5 of 8	

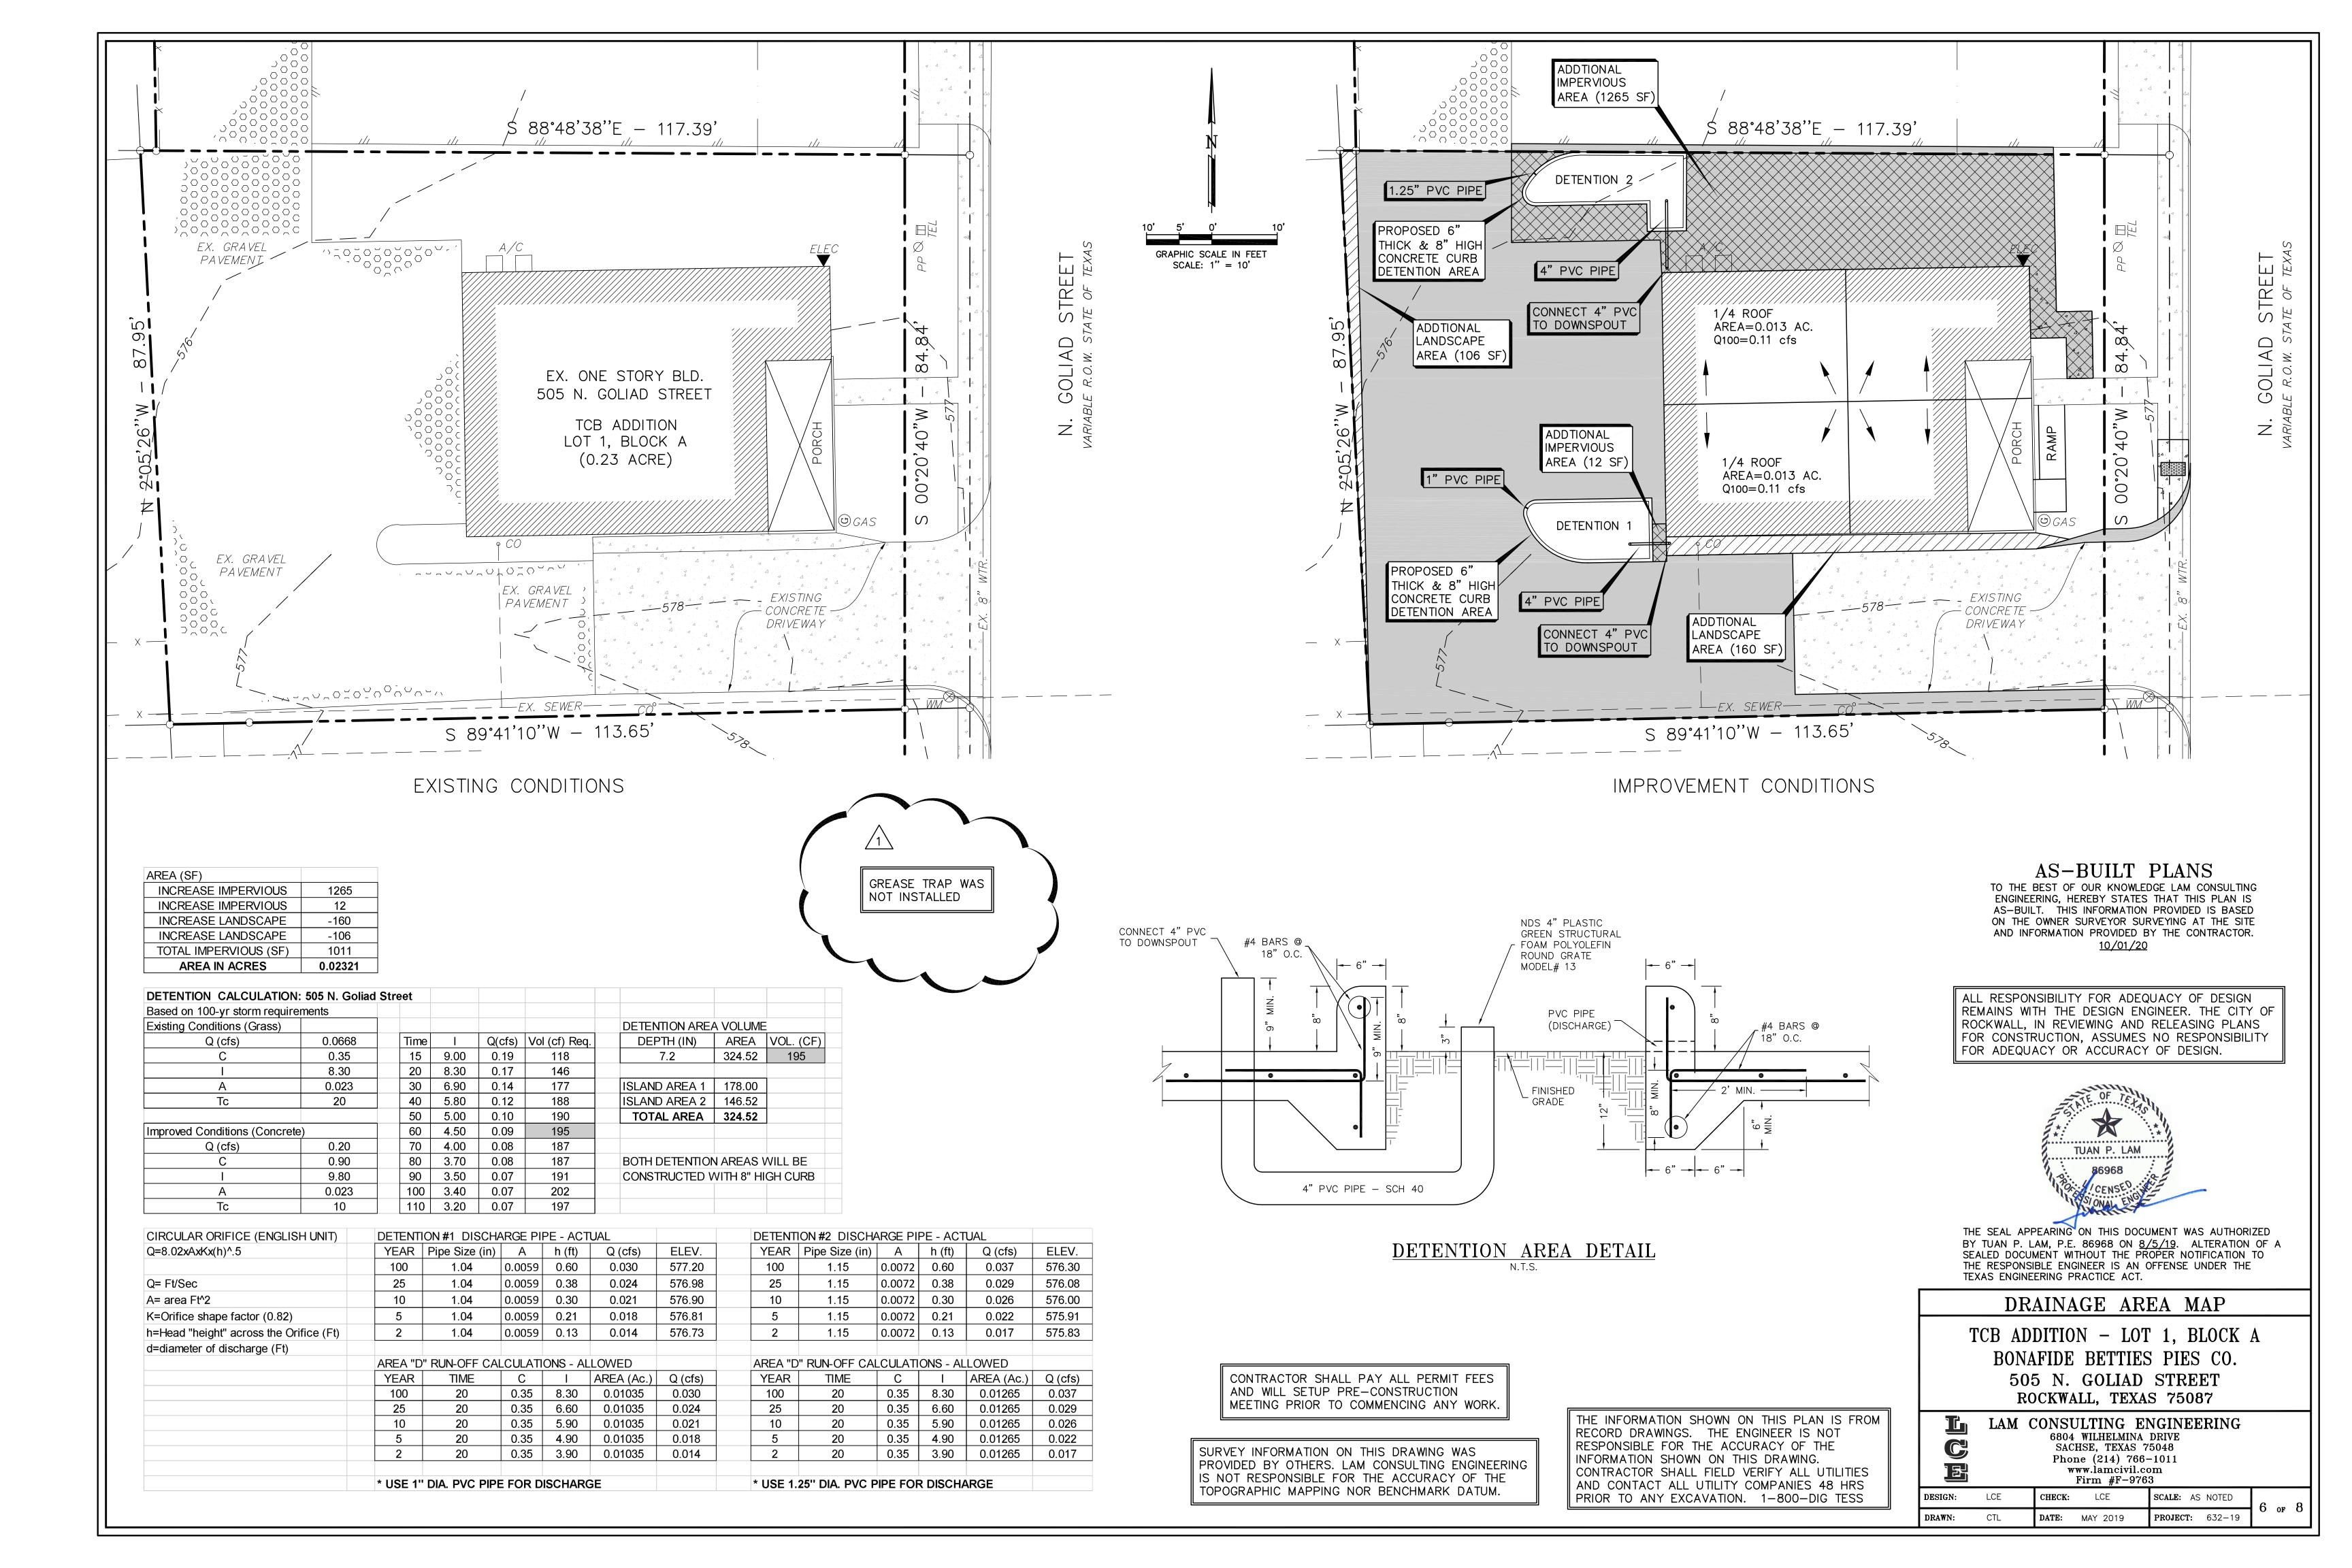

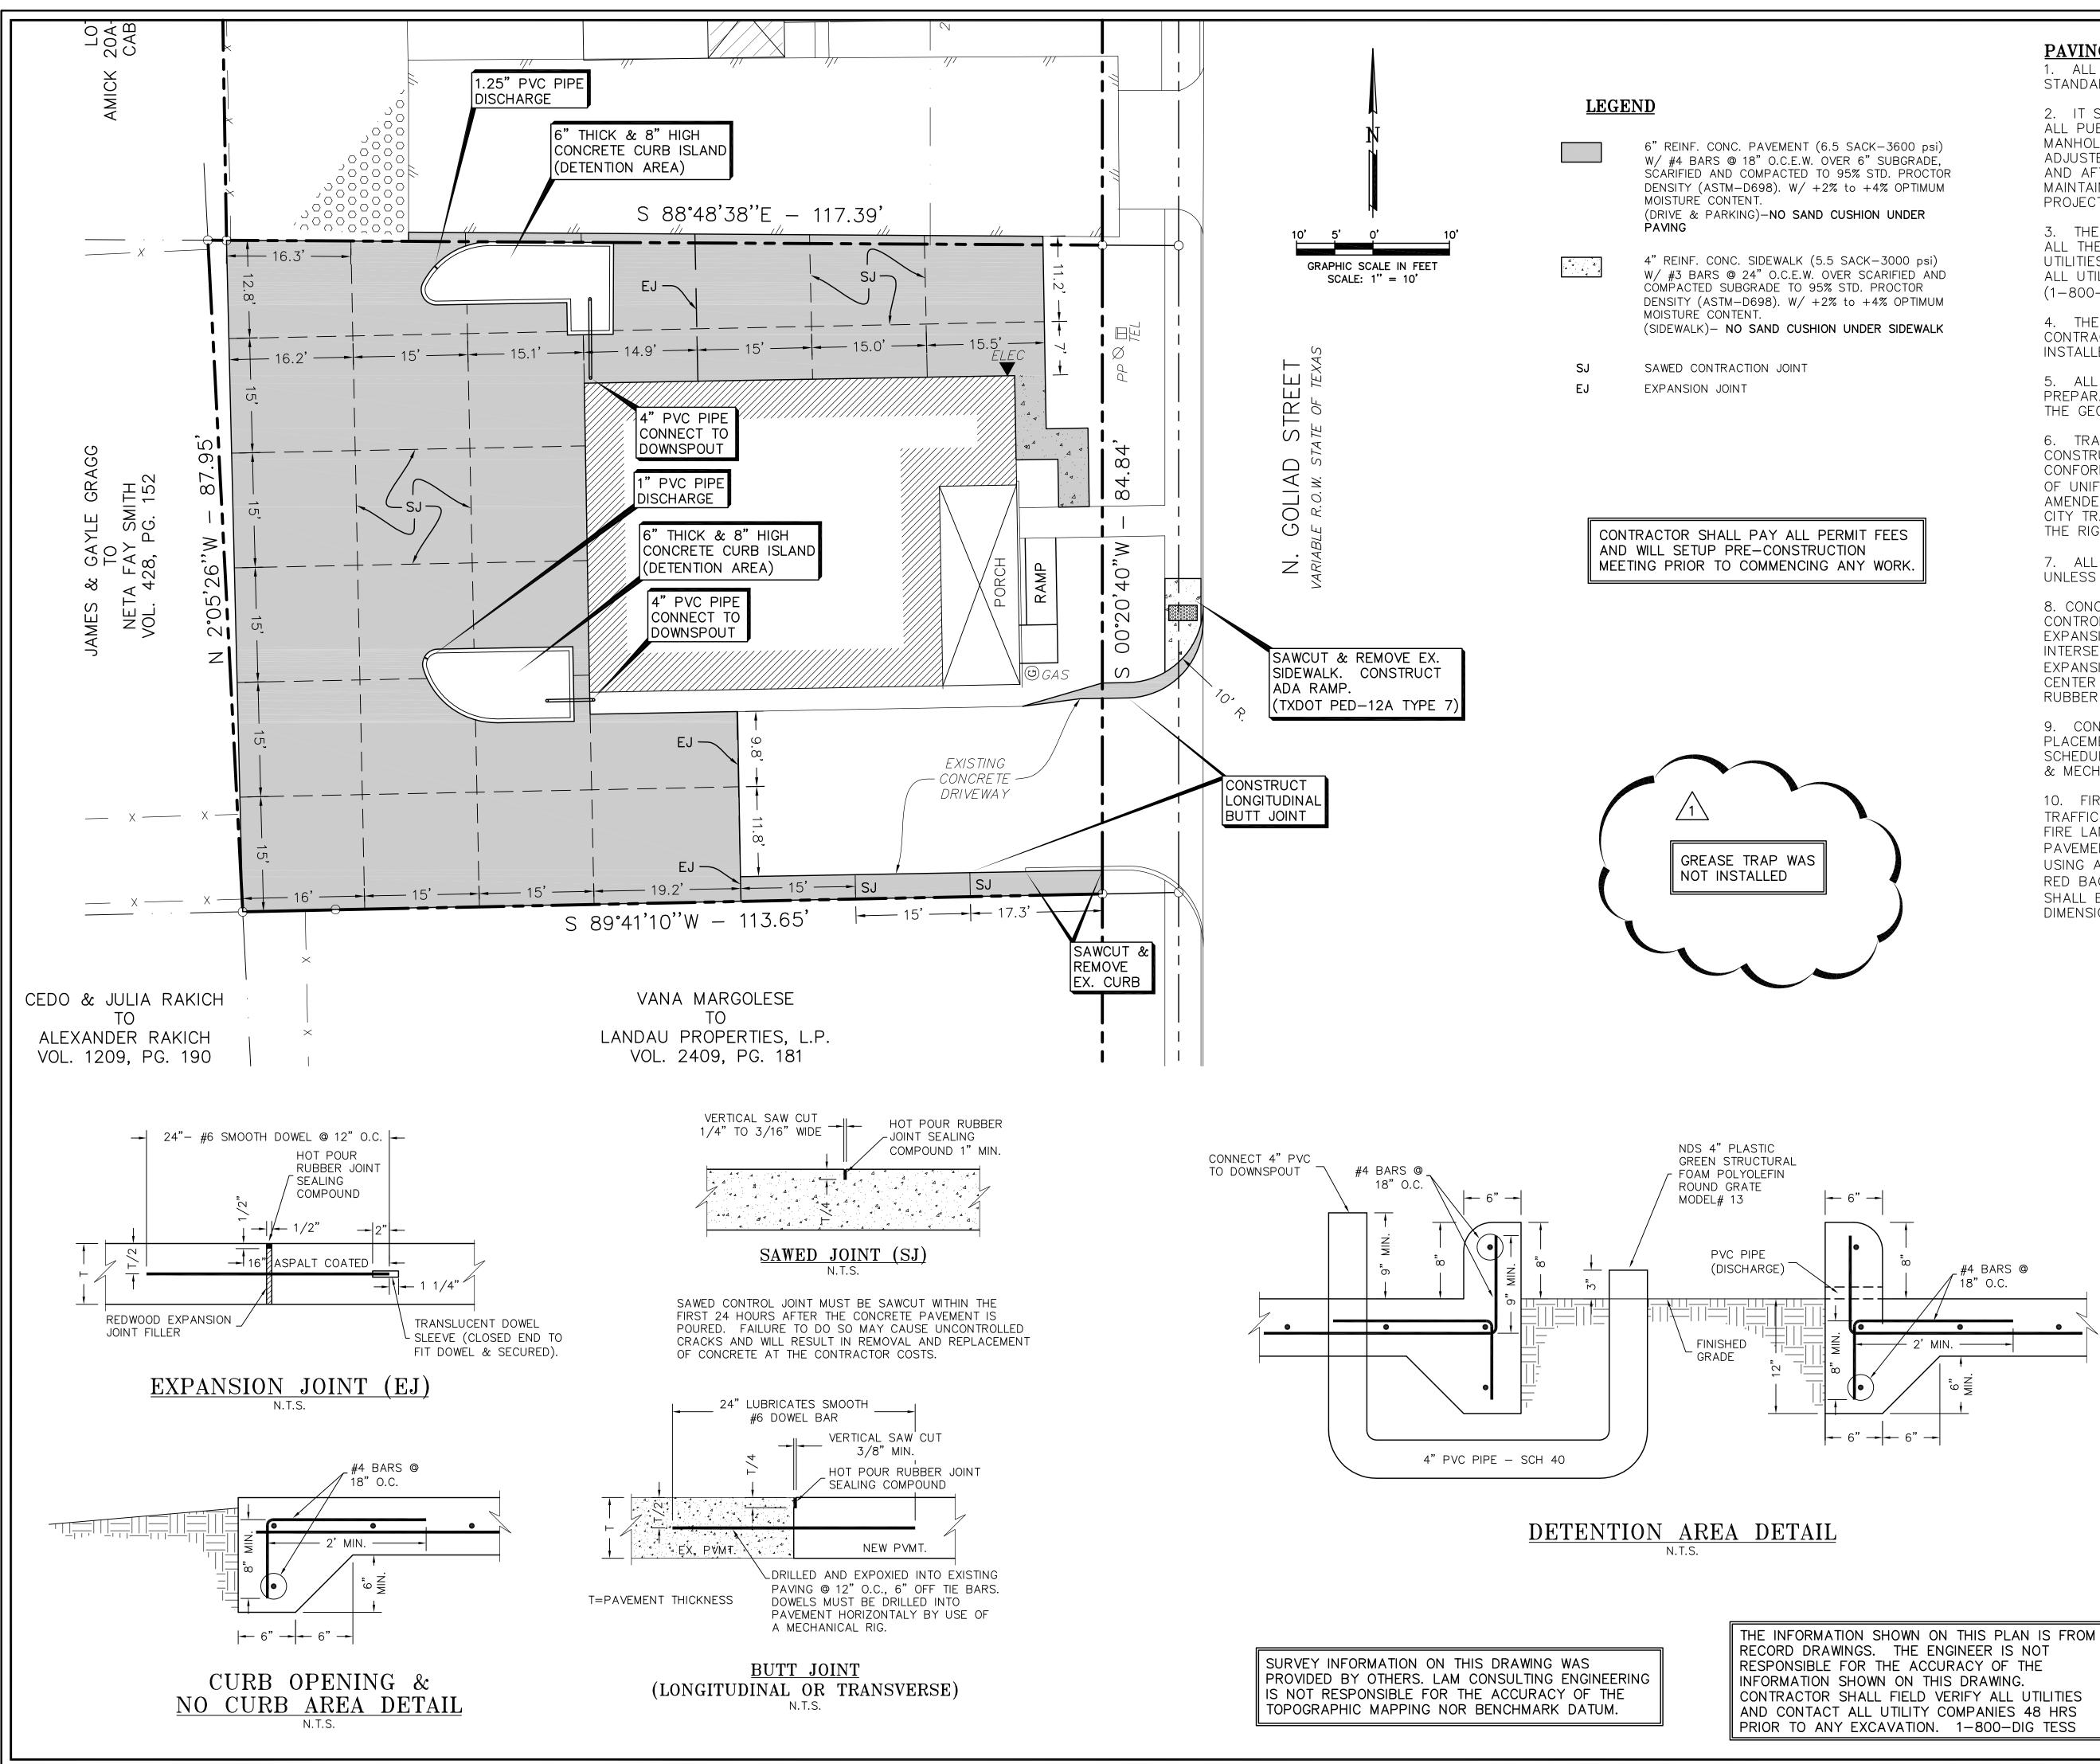

PAVING NOTES

1. ALL MATERIALS AND CONSTRUCTION SHALL CONFORM TO THE CITY'S STANDARDS AND SPECIFICATIONS AND NCTCOG 4TH EDITION.

2. IT SHALL BE THE RESPONSIBILITY OF THE CONTRACTOR TO PROTECT ALL PUBLIC UTILITIES IN THE CONSTRUCTION OF THIS PROJECT. ALL MANHOLES, CLEANOUTS, VALVE BOXES, FIRE HYDRANTS, ETC. MUST BE ADJUSTED TO PROPER LINE AND GRADE BY THE CONTRACTOR PRIOR TO AND AFTER THE PLACING OF PERMANENT PAVING. UTILITIES MUST BE MAINTAINED TO PROPER LINE AND GRADE DURING CONSTRUCTION OF THIS PROJECT.

3. THE CONTRACTOR SHALL BE RESPONSIBLE FOR COORDINATING WITH ALL THE APPROPRIATE UTILITY COMPANIES FOR THE LOCATION OF ALL UTILITIES WITHIN THE CONSTRUCTION AREA. CONTRACTOR SHALL NOTIFY ALL UTILITY COMPANIES 48 HRS PRIOR TO ANY EXCAVATIONS. DIG TESS (1-800-545-6005)

4. THE PAVING CONTRACTOR SHALL COORDINATE WITH THE UTILITY CONTRACTOR TO INSURE ALL CONDUIT FOR IRRIGATION HAS BEEN INSTALLED PRIOR TO PLACEMENT OF PERMANENT PAVEMENT.

5. ALL EARTHWORK OPERATIONS, PAVEMENT AND BUILDING SUBGRADE PREPARATION SHALL COMPLY WITH ALL RECOMMENDATIONS CONTAINED IN THE GEOTECHNICAL REPORT, PROVIDED BY OTHERS.

6. TRAFFIC BARRICADES WILL BE REQUIRED FOR PAVING AND UTILITY CONSTRUCTION WITHIN THE PUBLIC RIGHT-OF-WAY. BARRICADES SHALL CONFORM TO THE INSTALLATION SHOWN IN THE LATEST TEXAS MANUAL OF UNIFORM TRAFFIC CONTROL DEVICES (MUTCD), AS CURRENTLY AMENDED BY THE TEXAS DEPARTMENT OF TRANSPORTATION. CONTACT CITY TRANSPORTATION DEPARTMENT PRIOR TO SETTING BARRICADES IN THE RIGHT OF WAY.

7. ALL DRIVE AREAS AND ISLANDS SHALL HAVE 6" CONCRETE CURB, UNLESS OTHERWISE NOTED ON PLANS.

8. CONCRETE PAVING SHALL HAVE A CONSTRUCTION JOINT OR SAWED CONTROL JOINT EVERY 15 FEET TRANSVERSELY AND LONGITUDINALLY WITH EXPANSION JOINTS AS SHOWN IN THE DRAWINGS. JOINTS SHALL INTERSECT ALL PAVEMENT EDGES AT 90° INCLUDING RADIUS RETURNS. EXPANSION JOINTS SHALL BE PLACE AT A MAXIMUM SPACING OF 100' CENTER TO CENTER. ALL JOINTS SHALL BE SEALED WITH HOT POURED RUBBER JOINT SEALING COMPOUND.

9. CONTRACTOR SHALL INSTALL ALL CONDUITS PRIOR TO THE PLACEMENT OF PAVEMENT. ALL SLEEVES SHOWN ON PLANS SHALL BE SCHEDULE 40 PVC WITH PULLED WIRES & CAPPED. REFER TO LANDSCAPE & MECHANICAL PLANS FOR LOCATIONS AND SIZE OF CONDUITS.

10. FIRE LANE PAVEMENT MARKINGS SHALL BE PAINTED LINES OF RED TRAFFIC PAINT, 6" WIDE, TO SHOW THE EXACT BOUNDARY LINES OF THE FIRE LANE. THESE BOUNDARY LINES MAY BE ON THE CURB OR FLAT PAVEMENT. THE LINES SHALL BE MARKED BY PAINTED 4" HIGH LETTERING USING A 1" WIDE STROKE OF WHITE TRAFFIC PAINT ON THE CONTRASTING RED BACKGROUND STATING "NO PARKING - FIRE LANE". THIS MARKING SHALL BE PLACED AT 25' INTERVALS ALONG EACH BOUNDARY LINE -SEE DIMENSIONAL CONTROL PLAN FOR DETAILS AND LOCATION.

AS-BUILT PLANS

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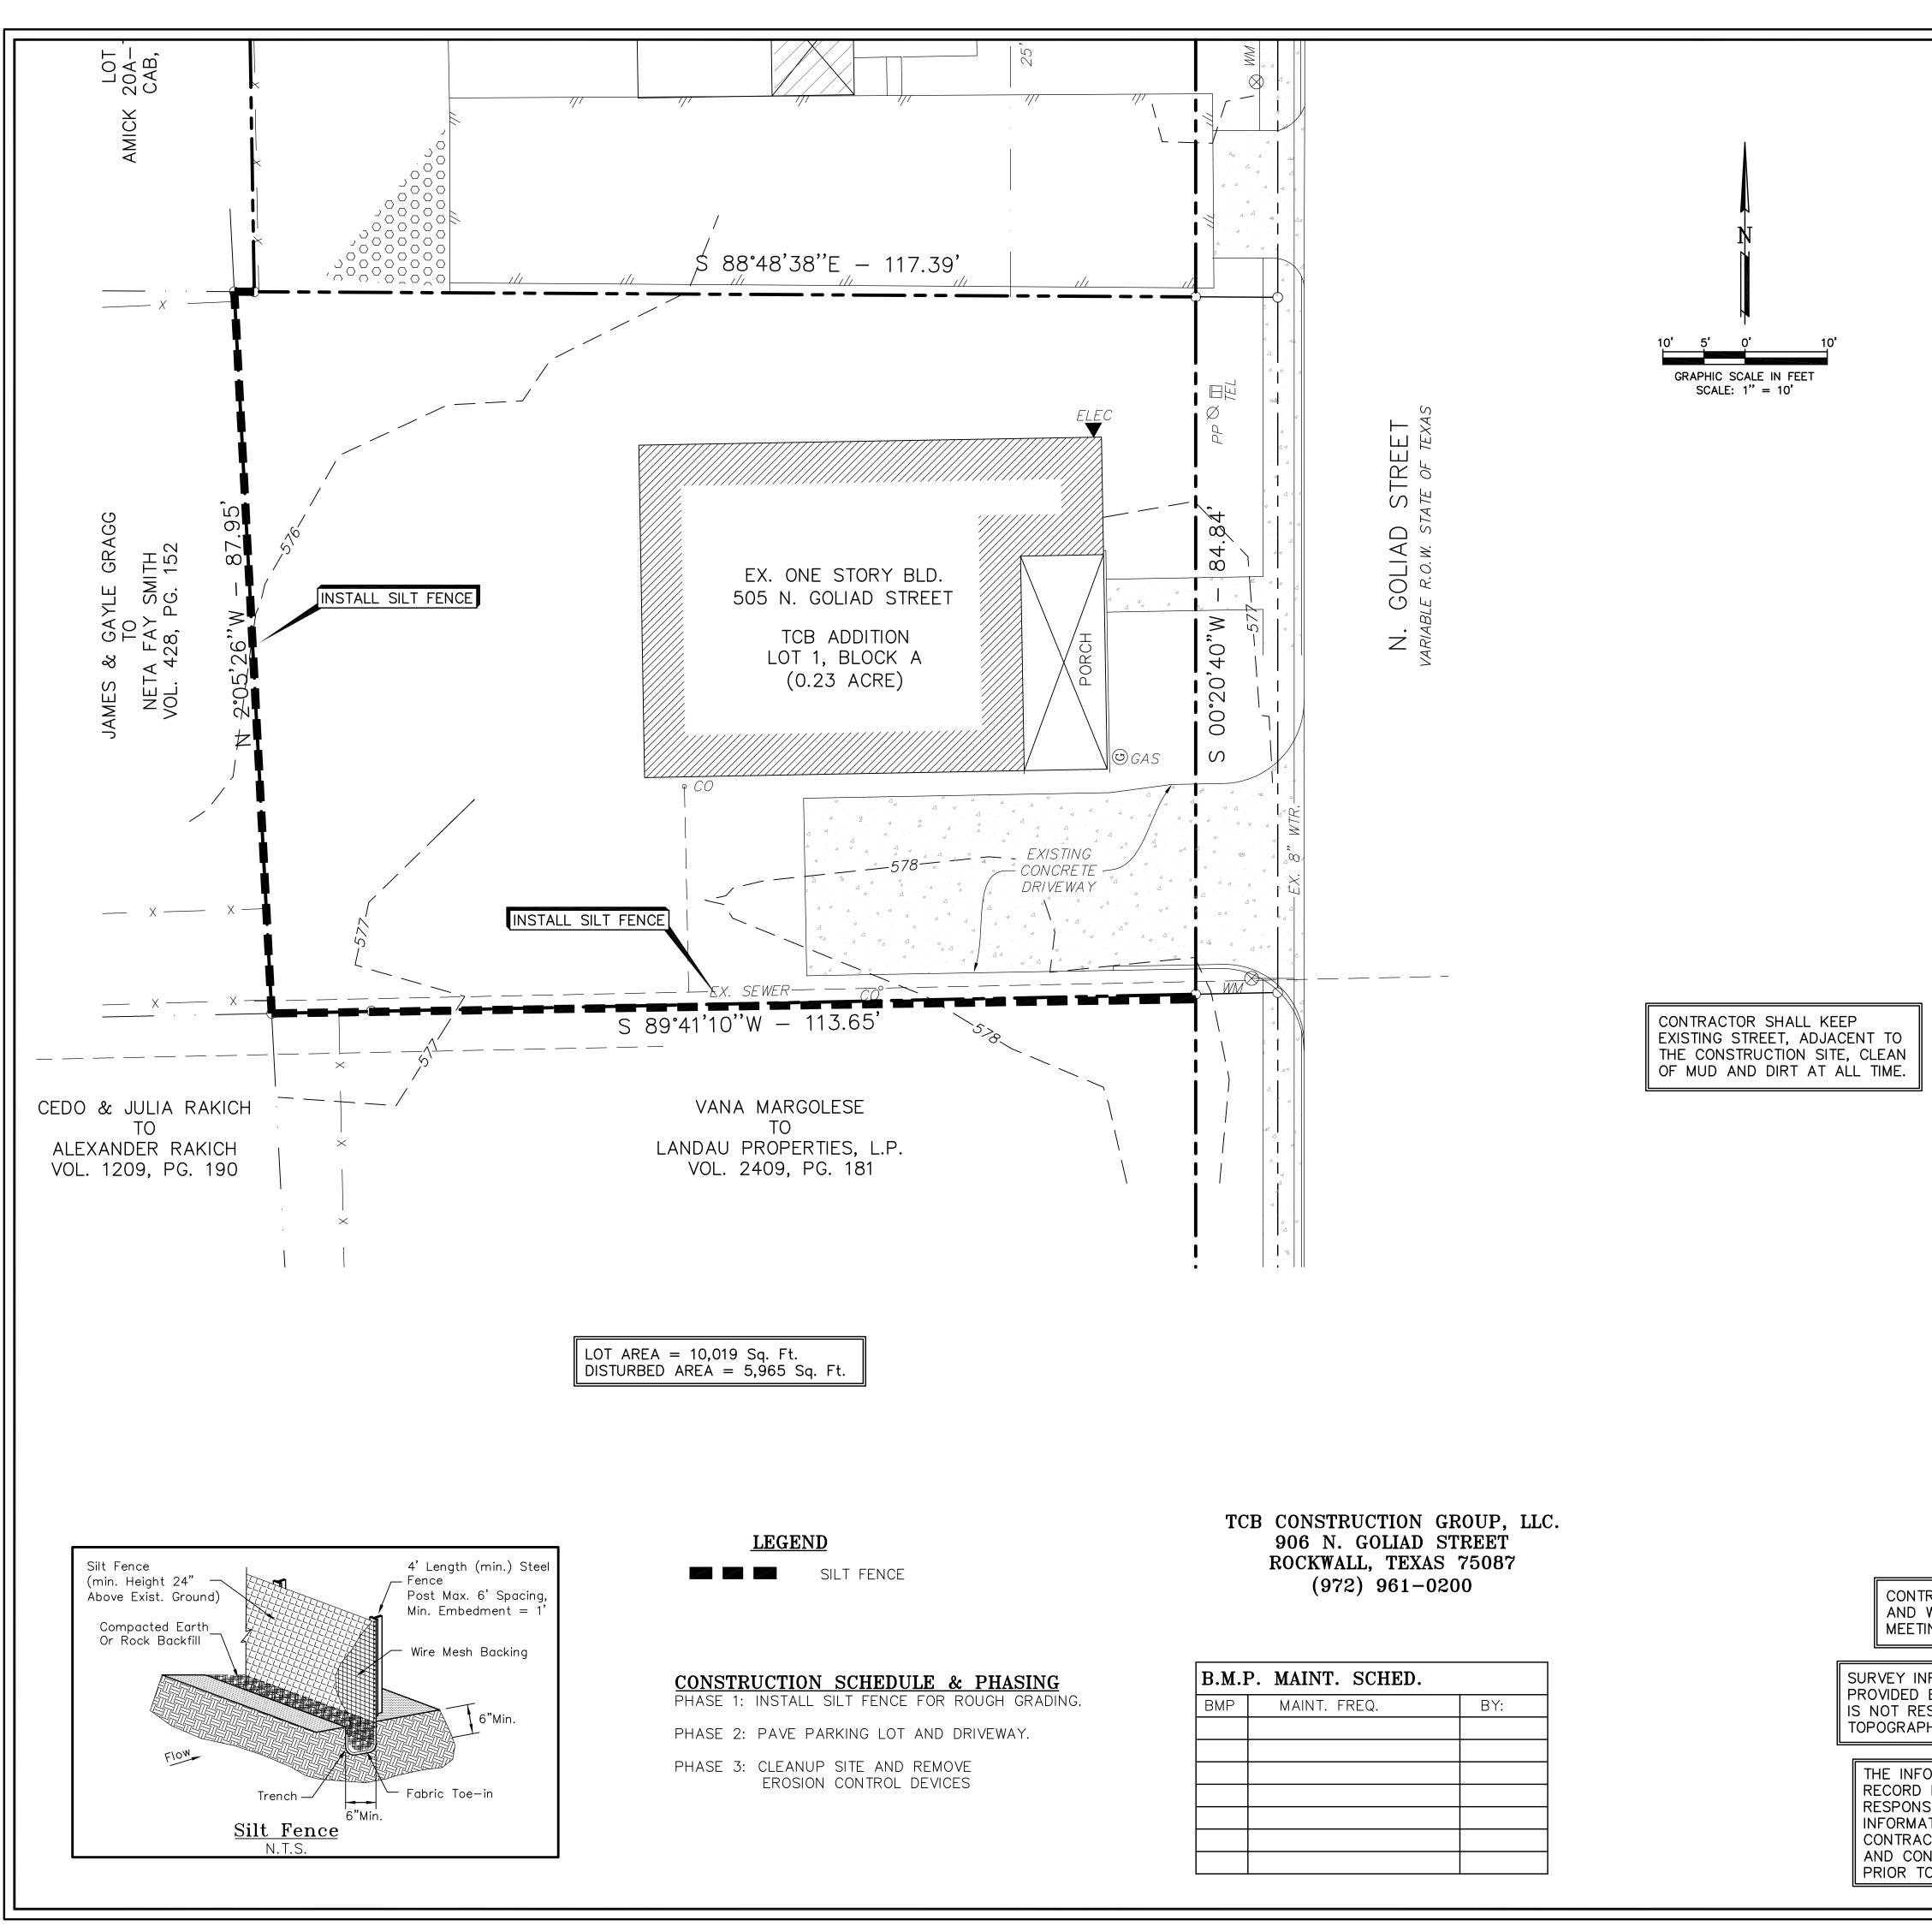
PAVING PLAN								
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LAM CONSULTING ENGINEERING 6804 WILHELMINA DRIVE SACHSE, TEXAS 75048 Phone (214) 766-1011 www.lamcivil.com Firm #F-9763								
DESIGN:	LCE	CHECK:	LCE	SCALE:	AS NOTED	7		

PROJECT: 632–19

DATE: MAY 2019

DRAWN:

CTL



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GENERAL NOTES:

1. EROSION CONTROL DEVICES AS SHOWN ON THE EROSION CONTROL PLAN FOR THE PROJECT SHALL BE INSTALLED PRIOR TO THE START OF LAND DISTURBING ACTIVITIES ON THE PROJECT.

2. ALL EROSION CONTROL DEVICES ARE TO BE INSTALLED IN ACCORDANCE WITH THE APPROVED PLANS AND SPECIFICATIONS FOR THE PROJECT. CHANGES ARE TO BE APPROVED BEFORE CONSTRUCTION BY THE DESIGN ENGINEER AND THE CITY ENGINEERING DIVISION.

3. IF THE EROSION CONTROL PLAN AS APPROVED CANNOT CONTROL EROSION AND OFF-SITE SEDIMENTATION FROM THE PROJECT THE EROSION CONTROL PLAN WILL BE REQUIRED TO BE REVISED AND/OR ADDITIONAL EROSION CONTROL DEVICES WILL BE REQUIRED ON SITE.

4. IF OFF-SITE SOIL BORROW OR SPOIL SITES ARE USED IN CONJUNCTION WITH THIS PROJECT, THIS INFORMATION SHALL BE DISCLOSED AND SHOWN ON THE EROSION CONTROL PLAN. OFF-SITE BORROW AND SPOIL AREAS ARE CONSIDERED A PART OF THE PROJECT SITE AND THEREFORE SHALL COMPLY WITH THE CITY'S EROSION CONTROL REQUIREMENTS. THESE AREAS SHALL BE STABILIZED WITH PERMANENT GROUND COVER PRIOR TO FINAL APPROVAL OF THE PROJECT.

5. EROSION CONTROL MEASURES SHALL BE INSPECTED AND REPAIRED, IF NECESSARY, AT THE EARLIEST POSSIBLE DATE BUT NO LATER THAN SEVEN (7) CALENDAR DAYS AFTER EACH RAIN. ANY ITEM DISTURBED BY THE CONTRACTOR SHALL BE REPAIRED.

6. THE CONTRACTOR IS RESPONSIBLE FOR MONITORING DOWNSTREAM CONDITIONS THROUGHOUT THE CONSTRUCTION PERIOD AND WILL CLEAN ANY DEBRIS AND SEDIMENT CAUSED BY CONSTRUCTION

7. THE CONTRACTOR SHALL PREVENT EROSION OF THE SITE AND PROTECT ALL DRAINAGE STRUCTURES BY THE USE OF SILT FENCING OR OTHER APPROVED EROSION CONTROL PRODUCTS AS NEEDED. TEMPORARY EROSION CONTROL DEVICES INSTALLED BY THE CONTRACTOR ON THIS PROJECT SHALL ALSO BE REMOVED BY THE CONTRACTOR AT THE APPROPRIATE TIME AS INCIDENTAL TO THE RESPECTIVE EROSION CONTROL DEVICE ITEM.

8. ADDITIONAL EROSION AND SEDIMENT CONTROL MEASURES SHALL BE INSTALLED IF DEEMED NECESSARY BY THE PROJECT ENGINEER DURING ON-SITE INSPECTIONS.

9. WETLANDS ARE NOT PRESENT ON-SITE NOR ADJACENT TO THIS PROJECT.

10. ALL POLLUTION PREVENTION CONTROL DEVICES SHALL CONFORM TO THE CITY'S EROSION AND SEDIMENT CONTROL MANUAL.

11. CONTRACTOR SHALL ADD OR REMOVE EROSION CONTROL DEVICES AS NEEDED DURING THE CONSTRUCTION PHASES.

AS-BUILT PLANS

TO THE BEST OF OUR KNOWLEDGE LAM CONSULTING ENGINEERING, HEREBY STATES THAT THIS PLAN IS AS-BUILT. THIS INFORMATION PROVIDED IS BASED ON THE OWNER SURVEYOR SURVEYING AT THE SITE AND INFORMATION PROVIDED BY THE CONTRACTOR. <u>10/01/20</u>

ALL RESPONSIBILITY FOR ADEQUACY OF DESIGN REMAINS WITH THE DESIGN ENGINEER. THE CITY OF ROCKWALL, IN REVIEWING AND RELEASING PLANS FOR CONSTRUCTION. ASSUMES NO RESPONSIBILITY FOR ADEQUACY OR ACCURACY OF DESIGN.



THE SEAL APPEARING ON THIS DOCUMENT WAS AUTHORIZED BY TUAN P. LAM, P.E. 86968 ON 8/5/19. ALTERATION OF A SEALED DOCUMENT WITHOUT THE PROPER NOTIFICATION TO THE RESPONSIBLE ENGINEER IS AN OFFENSE UNDER THE TEXAS ENGINEERING PRACTICE ACT.

EROSION CONTROL PLAN TCB ADDITION – LOT 1, BLOCK A BONAFIDE BETTIES PIES CO. 505 N. GOLIAD STREET ROCKWALL, TEXAS 75087 LAM CONSULTING ENGINEERING 6804 WILHELMINA DRIVE C SACHSE, TEXAS 75048 Phone (214) 766-1011] 5위 www.lamcivil.com Firm #F-9763 DESIGN: LCE CHECK: LCE SCALE: AS NOTED

DATE: MAY 2019

DRAWN:

CTL

8 OF 8

PROJECT: 632–19

CONTRACTOR SHALL PAY ALL PERMIT FEES AND WILL SETUP PRE-CONSTRUCTION MEETING PRIOR TO COMMENCING ANY WORK.

THE INFORMATION SHOWN ON THIS PLAN IS FROM RECORD DRAWINGS. THE ENGINEER IS NOT RESPONSIBLE FOR THE ACCURACY OF THE INFORMATION SHOWN ON THIS DRAWING. CONTRACTOR SHALL FIELD VERIFY ALL UTILITIES AND CONTACT ALL UTILITY COMPANIES 48 HRS PRIOR TO ANY EXCAVATION. 1-800-DIG TESS