
NORTH TEXAS MUNICIPAL WATER DISTRICT

CONSTRUCTION PLANS FOR

LAKESIDE LIFT STATION IMPROVEMENTS


PROJECT NO. SRWWPCF 07-1(102)

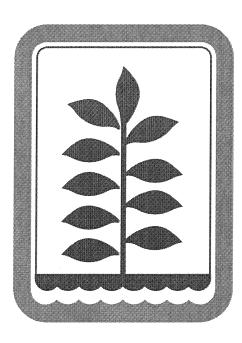

BIRKHOFF, HENDRICKS & CARTER, LLP.
PROFESSIONAL ENGINEERS

Texas Firm F526
Dallas, Texas

OCTOBER, 2008

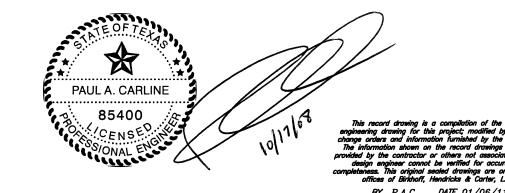

CONFORMED SET

ED: 1/7/11 - RLOWE H:\Projects\NTMWD\2007104\Sheets\2007104-LIFT-COVER.dwg

PLOT SCALE: 1:1

PLOT STYLE: ---- PLOTTED BY: ANGEL ON 1/7/2011

nese plans and related specifications were prepared for

LOCATION MAP NOT TO SCALE

BUILDING ADDRESS: 1927 GULLWING DRIVE ROCKWALL, TEXAS 75087

CITY OF ROCKWALL BLDG PERMIT NO: 2009-0106

This record drawing is a compilation of the sealed engineering drawing for this project; modified by addenda, change orders and information furnished by the contractor. The information shown on the record drawings that was provided by the contractor or others not associated with the design engineer cannot be verified for accuracy or completeness. This original sealed drawings are on file at the offices of Birkhoff, Hendricks & Carter, LLP.

BY P.A.C. DATE 01/06/11

PROJECT NOTES (NO SEPARATE PAY ITEMS)

- 1) ALL TOPSOIL SHALL BE STOCKPILED AND REPLACED TO A MINIMUM DEPTH OF 6 INCHES. THE REPLACED TOPSOIL SHALL BE DISC HARROWED AND SMOOTHED.
- FINISHED GROUND SHALL NOT CONTAIN ANY MORE ROCK OR DEBRIS THAN THE SURROUNDING UNDISTURBED GROUND.
- 3) UNLESS OTHERWISE SHOWN ON THE PLANS THE CONTRACTOR SHALL RESTORE GROUND TO ORIGINAL GRADE AND PREVENT PONDING OF STORM WATER RUNOFF ON ALL GROUND DISTURBED BY CONSTRUCTION ACTIVITIES.
- 4) CONTRACTOR SHALL NOT REMOVE ANY TREES LARGER THAN 4 INCHES IN DIAMETER UNLESS IT IS SHOWN WITH A BOLD "X" ON THE PLANS WITHOUT WRITTEN PERMISSION OF THE OWNER.
- 5) CONTRACTOR MAY TRIM TREES AS NECESSARY UNDER OWNERS SUPERVISION.
- 6) ALL CUT LIMBS OVER 1 INCH IN DIAMETER SHALL BE PAINTED WITH TREE WOUND PAINT IMMEDIATELY AFTER CONSTRUCTION ACTIVITIES HAVE BEEN COMPLETED IN THIS AREA.
- 7) ALL TREES OVER 4 INCHES IN DIAMETER THAT ARE REMOVED OR SEVERELY DAMAGED BY CONSTRUCTION OPERATIONS WITHOUT PERMISSION SHALL BE REPLACED WITH AN EQUIVALENT TYPE AND DIAMETER OF TREE AT THE SOLE EXPENSE OF THE CONTRACTOR OR THE CONTRACTOR SHALL PAY THE FAIR MARKET VALUE TO THE OWNER.
- B) THE CONTRACTOR SHALL TAKE SPECIAL CARE IN AVOIDING DAMAGE TO PLANT MATERIAL OR TREES WITHIN THE SITE OR PROPERTY ADJACENT TO THE WORK, ANY AND ALL DAMAGE TO PLANT MATERIAL OR TREES AS A RESULT OF THE CONTRACTOR'S WORK SHALL BE PAID FOR AND CORRECTED AT THE EXPENSE OF THE CONTRACTOR IN ACCORDANCE WITH THE TEXAS A&M FORMULA FOR SHADE TREE EVALUATION.
- 9) ANY FENCES DAMAGED OR REMOVED BY CONSTRUCTION ACTIVITIES NOT NOTED ON PLANS SHALL BE REPLACED WITH A FENCE OF EQUAL OR SUPERIOR QUALITY AT CONTRACTOR'S
- 10) CONTRACTOR SHALL INCLUDE ALL COSTS FOR REMOVAL AND/OR REPLACEMENT OF PAVEMENT, FENCES, CATES, AND OTHER IMPROVEMENTS DAMAGED BY RELATED CONSTRUCTION ACTIVITIES IN THE APPROPRIATE ITEM OF THE BID SCHEDULE.
- 11) THE LOCATION OF ALL UNDERGROUND UTILITIES SHOWN IN THE PLANS IS APPROXIMATE AND BASED ON THE INFORMATION AVAILABLE TO THE ENGINEER DURING DESIGN OF THE PROJECT. CONTRACTOR SHALL VERIEY THE LOCATIONS OF ALL EXISTING UTILITIES SUFFICIENTLY IN ADVANCE OF THE CONSTRUCTION SO THAT, IF IT IS NECESSARY TO CHANGE OR MOVE THE UTILITY THE PROGRESS OF THE WORK WILL NOT BE DELAYED.
- 12) CONTRACTOR SHALL BE RESPONSIBLE FOR PROTECTING ALL EXISTING SERVICE LINES AND IRRICATION SYSTEMS CROSSED OR EXPOSED BY HIS CONSTRUCTION OPERATIONS. WHERE THEY ARE CUT, BROKEN OR DAMAGED, THE CONTRACTOR SHALL IMMEDIATELY REPLACE THEM WITH THE SAME TYPE AS THE ORIGINAL CONTRACTION OR SUPERIOR.
- 13) ANY CONCRETE PAVEMENT OR SIDEWALK, NOT SHOWN TO BE REMOVED IN THE PLANS, REMOVED BY THE CONTRACTOR SHALL BE REPLACED BY THE CONTRACTOR AT HIS SOLE EXPENSE.
- 14) IF CONTRACTOR ENCOUNTERS GROUNDWATER ON THE PROJECT, HE SHALL PROVIDE ADEQUATE
 MEASURES FOR DEWATERING THE TRENCH. ALL COSTS FOR PUMPS AND/OR OTHER RELATED
 APPURTENANCES SHALL BE INCLUDED IN THE APPROPRIATE ITEM OF THE BID SCHEDULE.
- 15) REMOVAL AND REPLACEMENT OF GRAVEL DRIVES, PARKING AREAS, AND WALKWAYS NOT SHOWN IN THE PLANS SHALL BE SUBSIDIARY. ALL COSTS SHALL BE INCLUDED IN THE APPROPRIATE ITEM OF THE BID SCHEDULE.
- 16) CONTRACTOR SHALL CONSTRUCT TEMPORARY ASPHALT RAMP TO PROTECT CURBS AT THE CONCRETE PAYEMENT USED BY CONSTRUCTION TRAFFIC, AND SHALL REMOVE ASPHALT AT COMPLETION OF PROJECT.
- 17) NO TRENCHES SHALL BE LEFT OPEN WHILE CONTRACTOR IS NOT WORKING.
- 18) CONTRACTOR SHALL CONTAIN ALL WORK WITHIN THE EASEMENTS PROVIDED FOR THIS PROJECT AS SHOWN ON THE PLANS.
- 19) THE CONTRACTOR SHALL PROVIDE BARRICADES, FLAGMEN AND OTHER TRAFFIC CONTROL DEVICES AS REQUIRED BY THE CITY OF ROCKWALL ENGINEERING DEPARTMENT FOR ANY CITY STREET LANE CLOSURES AND AS REQUIRED BY THE TEXAS DEPARTMENT OF TRANSPORTATION FOR WORK WITHIN TOTAL TOTAL TOTAL TOTAL TRANSPORTATION FOR WORK WITHIN TOTAL TRANSPORTATION FOR WORK WITHIN TOTAL TOTAL TOTAL TOTAL TOTAL TOTAL TOTAL TRANSPORTATION FOR WORK WITHIN TOTAL TOTAL TOTAL TOTAL TRANSPORTATION FOR WORK WITHIN TOTAL TOTAL TRANSPORTATION FOR WORK WITHIN TRANSPORTATION FOR WORK WITHIN
- 20) CONTRACTOR SHALL PROVIDE PRE AND POST CONSTRUCTION VIDEO OF THE PROJECT STE. (NO PAY ITEM) CONTRACTOR SHALL PROVIDE VIDEO ON DVD FORMAT TO N.T.M.W.D.

PLOT STYLE: ----

21) CONTRACTOR SHALL PROTECT ALL DRAINAGE STRUCTURES.

SUMMARY OF ABBREVIATIONS AND DEFINITIONS

	GENERAL TOPOGRAPHY & HO	RIZONTAL/ VERTIC	AL CONTROL	_ CONTROL TI		
ABBREVIATION	DEFINITION	ABBREVIATION	DEFINITION	ABBREVIATION	DEFINITION	
B.C.	BACK OF CURB	P.I.	POINT OF INTERSECTION	B.D.	BOIS D'ARC TREE	
B. ⊂ B.	BACK TO BACK		PROPERTY LINE	B.T.	BLACK THORN TREE	
	CENTERLINE	P.P. OR U.P.	POWER POLE OR UTILITY POLE	C.B.	CHINABERRY TREE	
C.M.A.P.	CORRUGATED METAL ARCH PIPE	P.R.C.	POINT OF REVERSE CURVATURE	CDR. C.E.	CEDAR TREE	
C.M.P.	CORRUGATED METAL PIPE	P.T.	POINT OF TANGENCY	U.E.	CEDAR ELM TREE	
C.I.	CORTROWNED METAL FIFE CAST IRON CLEANOUT CONNECTION CULVERT DUCTILE IRON PIPE ELEVATION RIBIED OF FCTRICAL POWER LINE	P.V.C.	PLASTIC PIPE	C.M. C.P. C.W.	CRAPE MYRTLE TREE	
C.O.	CLEANOUT	P.V.I.	POINT OF VERTICAL INTERSECTION	C.P.	CHINESE PISTACHIO TREE	
CONN.	CONNECTION	R.	RADIUS	C.W.	COTTONWOOD TREE CYPRESS TREE	
CULV.	CULVERI	R.C.	REINFORCED CONCRETE	CYP.	HACKBERRY TREE	
D.I.P.	DUCTILE IRON PIPE	R.C.P.	REINFORCED CONCRETE PIPE	H.B.	HICKORY TREE	
EL.	ELEVATION	R.C. R.C.P. R.C.C.P. R.O.W.	REINF. CONCRETE CYLINDER PIPE	H.B. HICK. H.T.	HAWTHORNE TREE	
		K.U.W.	RIGHT OF WAY	JAP.	JAPONICA TREE	
ENC.	ENCASEMENT	SAN. SEW. OR S.S.	SANITARY SEWER	LIG.	LIGUSTRUM BUSH	
E.P.	EDGE OF PAVEMENT EASEMENT FACE TO FACE FIRE HYDRANT	S.H. §	LAWN SPRINKLER HEAD SURVEY LINE	LO.	LIVE OAK TREE	
ESMT.	EASEMENT	ا مر		LU.	LOCUST TREE	
F.–F.	FACE TO FACE	S.S. S.S.M.H.	SANITARY SEWER	LOC. MAG.	MAGNOLIA TREE	
F.H.		2.5.M.H.	SANITARY SEWER MANHOLE	MAG. MAP.	MAPLE TREE	
F.M.	SANITARY SEWER FORCE MAIN	ST. SEW.	STORM SEWER	MAP.	MESOUITE TREE	
F.L.	FLOW LINE	S.V.B.	LAWN SPRINKLER VALVE BOX	MSQ. MIM.	MIMOSA TREE	
G.L.M.	GAS LINE MARKER GAS METER GAS VALVE GUTTER	T.B. T.C. TEL.	TELEPHONE CABLE BOX	MIM.	MULBERRY TREE	
G.M.	GAS MEIER	1.0.	TOP OF CURB BURIED TELEPHONE CABLE	MUL	NANDENA BUSH	
G.V.	GAS VALVE	1111	TELEPHONE CABLE MANHOLE	NAN.	PECAN TREE	
GUT.	GUITER	T.M.H. TO F.		MUL. NAN. PEC. PER.	PECAN TREE PERSIMMON TREE	
HDWL.	HEADWALL	TDANC	TO FACE (OF CURB) ELECTRICAL TRANSFORMER	PER. PHOT.	RED TIPPED PHOTINIA BUSH	
I.P.F. OR I.R.F.	IRON PIN (ROD) FOUND LANDSCAPING LIGHT	trans. T.V.	BURIED TELEVISION CABLE	PIST.	CHINESE PISTACHIO TREE	
LL	LIGHT POLE	1.V. T.V.B.	CABLE TELEVISION CABLE	R.B.	REDBUD TREE	
LP.	SANITARY SEWAGE LIFT STATION	U.G.C.M.	UNDERGROUND CABLE MARKER	R.D. R.O.	RED OAK TREE	
LS.		U.G.C.M. U.P.M.	UNDERGROUND PIPELINE MARKER	K.U. S.G.	SWEET GUM TREE	
L.S.T.	LANDSCAPING TIMBERS MAILBOX	U.P.M. V.C.	VERTICAL CURVE	SYC.	SYCAMORE TREE	
M.B. M.B.G.F.	MAILBUX METAL BEAM GUARD FENCE	W. OR W.L.	WATER LINE	WIL.	WILLOW TREE	
	MANHOLE	W. UK W.L.	WATER LINE WATER METER	#IL	WILLOW INCL	
M.H. P.C.	POINT OF CURVATURE	W.V.	WATER VALVE			
F.U.	FOINT OF CORVATURE	π.٧.	WATER VALVE	L		

SHEET INDEX

DESCRIPTION	SHEET	NC
COVER SHEET		
CIVIL-LOCATION MAP, PROJECT NOTES & SHEET INDEX	C2	
CIVIL-GENERAL NOTES	С3	
CIVIL-SITE PLAN	C4	
ARCHITECTURAL - FLOOR PLAN, ROOF PLAN, DOOR SCHEDU	LE A1	
ARCHITECTURAL - EXTERIOR ELEVATIONS	A2	
ARCHITECTURAL - WALL SECTIONS & MISC. DETAILS	A3	
STRUCTURAL - GENERAL NOTES & TYPICAL DETAILS	S1	
STRUCTURAL - PLANS, SECTIONS & DETAILS	S2	
STRUCTURAL - CMU, SECTIONS & DETAILS	S3	
ELECTRICAL - SITE PLAN	E1	
ELECTRICAL - SITE PLAN DETAILS	E1A	
ELECTRICAL - ONE LINE DIAGRAM	E2	
ELECTRICAL - CONTROL SCHEMATICS	E3	
ELECTRICAL - INSTRUMENTATION SCHEMATICS	E4	
ELECTRICAL - SCHEDULES	E5	
ELECTRICAL - FLOOR PLAN & DETAILS	E6	
ELECTRICAL — GENERATOR ROOM DETAILS	E6A	
ELECTRICAL - DETAILS I	E7	
ELECTRICAL - DETAILS II	E8	
MECHANICAL - HVAC PLANS & DETAILS	М1	

BIRKHOFF, HENDRICKS & CARTER, L.L.P.

PROFESSIONAL ENGINEERS Texas Firm F526 11910 Greenville Ave., Suite 600 Dallas, Texas (214) 361-7900





PROJECT NO.

2007-104

October, 2008

SHEET NO

C2

LEGEND OF SYMBOLS

Δ Δ	CONCRETE PAVEMENT
	GRAVEL PAVEMENT
	STONE OR ROCK PAVEMENT
	PROPERTY OR SUB-DIVISION LINE
	PERMANENT EASEMENT
<u> </u>	TEMPORARY EASEMENT
	SLOPE OR TOP BANK
	CREEK OR DITCH
TELE	BURIED TELEPHONE CABLE
	TREES, BUSH OR BRUSH
	WOOD FENCE
	WROUGHT IRON FENCE
	CHAIN LINK FENCE

EXISTING UTILITY OWNERS

NORTH TEXAS MUNICIPAL WATER DISTRICT	DENNIS McSHERRY BRUCE COLE	(972) 44 2–5405	
CITY OF ROCKWALL	CHUCK TODD	(972) 771-7746	CITY ENGINEER
COMCAST	-	(800) 252-1133	
SOUTHWESTERN BELL TELEPHONE	-	(800) 395-0440 (800) 545-6005	
TCI CABLE	-	(214) 328 5000	
TEXAS ONE CALL SYSTEM	-	(800) 245-4545	
TEXAS EXCAVATION SAFETY SYSTEM	-	(800) 344-8377	
ONCOR	RICHARD BREWSTER	(214) 486-4245	
ATMOS ENERGY	LINE LOCATE EMERGENCY BEN CURTIS RONNEY LINTON	(800) 344-8377 (800) 817-8090 (800) 344-8377 (469) 261-2023	PROJECT MANAGER
LEVEL 3 FIBER OPTIC	_	(877) 366-8344	
METRO MEDIA FIBER OPTIC	-	(972) 771-7746	DIG/EMERGENCY

GENERAL PROJECT NOTES

- 1. CONTRACTOR SHALL SECURE EXCAVATIONS AT THE END OF EACH DAY. THE OWNER MAY REQUIRE THAT NO TRENCHES BE LEFT OPEN OVERNIGHT IN STREETS OR POPULATED AREAS.
- 2. TOPSOIL SHALL BE STOCKPILED AND REPLACED TO A MINIMUM DEPTH OF 6 INCHES AND DISC HARROWED TO A MINIMUM DEPTH OF 4 INCHES
- FINISHED GROUND SHALL HAVE NO MORE ROCKS OVER 1 INCH THAN SURROUNDING UNDISTURBED GROUND.
- RESTORE GROUND TO ORIGINAL GRADE AND PREVENT PONDING OF STORM WATER RUNOFF ON ALL GROUND DISTURBED BY CONSTRUCTION ACTIVITIES.
- CONTRACTOR SHALL PROVIDE TEMPORARY SUPPORT OF ALL POWER AND TELEPHONE POLES AND GUY WIRES WITHIN PROJECT SITE AND SHALL REPAIR DAMAGED POLES AND GUY WIRES OR RELOCATE POLES AND GUY WIRES AS REQUIRED BY THE UTILITY OWNER AT NO ADDITIONAL COST TO THE OWNER. CONTRACTOR MUST CONTACT & COORDINATE ALL WORK AND FEES W/ UTILITY OWNER AT NO ADDITIONAL COST TO NTMWD.
- 6. TRIMMING OF TREES SHALL BE ACCOMPLISHED USING A SAW OR PRUNING SHEARS. ALL CUT LIMBS OVER 1 INCH IN DIAMETER SHALL BE PAINTED WITH TREE WOUND PAINT IMMEDIATELY AFTER TREE TRIMMING
- CONTRACTOR SHALL REPLACE ANY TREES REMOVED OR DESTROYED WITHOUT THE OWNER'S PERMISSION OR SHALL PAY FAIR MARKET VALUE (AS DETERMINED BY THE OWNER) TO THE OWNER.
- ANY FENCES DAMAGED OR REMOVED BY CONSTRUCTION ACTIVITIES SHALL BE REPLACED AT THE SAME LOCATION WITH A FENCE OF EQUAL OR SUPERIOR QUALITY.
- TEMPORARY FENCING SHALL BE REQUIRED WHERE INDICATED ON THE DRAWINGS, WHERE THERE IS LIVESTOCK, AND WHERE DAMAGED OR REMOVED FENCES ARE NOT TO BE REPLACED BY END OF SAME WORK DAY, OR AS DIRECTED BY OWNER. CONTRACTOR TO VERIFY PRESENCE OF LIVESTOCK WITH LANDOWNER PRIOR TO ENTERING PROPERTY.
- 10. CONTRACTOR SHALL VERIFY THE LOCATIONS OF ALL EXISTING UTILITIES SUFFICIENTLY IN ADVANCE OF THE CONSTRUCTION SO THAT IF IT IS NECESSARY TO CHANGE OR MOVE THE UTILITY, THE PROGRESS OF THE WORK WILL NOT BE DELAYED, & ALL COSTS INCURRED FOR UTILITY CONFLICTS WILL BE AT NO ADDITIONAL COST TO
- 11. CONTRACTOR SHALL BE RESPONSIBLE FOR THE PROTECTION OF ALL EXISTING SERVICE LINES CROSSED OR EXPOSED BY HIS CONSTRUCTION OPERATIONS. WHERE EXISTING SERVICE LINES ARE CUT, BROKEN OR DAMAGED THE CONTRACTOR SHALL IMMEDIATELY REPLACE THE SERVICE LINES IN KIND WITH LIKE OR BETTER MATERIALS.
- 12. CONTRACTOR SHALL PROVIDE A STORM WATER POLLUTION PREVENTION PLAN AND PROVIDE ALL APPURTENANCES TO COMPLY WITH THE LATEST TCEQ STORM WATER POLLUTION PREVENTION REGULATIONS. CONTRACTOR SHALL BE RESPONSIBLE FOR FILING A NOTICE OF INTENT (NOI) AT THE START OF CONSTRUCTION WITH THE TCEQ AND A NOTICE OF TERMINATION (NOT) AT THE END, ALSO WITH THE TCEQ.
- 13. CONTRACTOR SHALL PROVIDE ADEQUATE MEASURES FOR DEWATERING AS NECESSARY.
- 14. CONTRACTOR SHALL REMOVE FENCES AS REQUIRED FOR CONSTRUCTION. BARBED WIRED, WROUGHT IRON, CHAIN AND CHAIN LINK FENCES SHALL BE REPLACED OR RECONSTRUCTED. NEW MATERIALS SHALL MATCH EXISTING FENCES. ALL WOOD FENCES SHALL BE REPLACED WITH NEW CEDAR WITH THE POSTS MATCHING THE EXISTING ANY FENCING REMOVED SHALL BE REPLACED IN KIND WITH LIKE OR BETTER MATERIALS, AND BE PAINTED OR STAINED TO MATCH EXISTING FENCE
- 15. CONTRACTOR SHALL PROTECT ALL UNDERGROUND IRRIGATION SYSTEMS (KNOWN AND UNKNOWN). ALL DAMAGE SHALL BE REPAIRED BY IRRIGATOR LICENSED IN THE STATE OF TEXAS.
- 16. CONTRACTOR SHALL SUBMIT A WRITTEN PLAN AND SCHEDULE 14 DAYS IN ADVANCE OF CONSTRUCTION ACTIVITIES REQUIRING REPLACEMENT OR SUPPORT OF EXISTING SANITARY SEWER PIPE, WATER PIPE OR STORM DRAIN PIPE. THE PLAN SHALL DESCRIBE IN DETAIL THE METHOD FOR REPLACING OR SUPPORTING EXISTING PIPE AND ASSOCIATED SCHEDULE. (I.E.SHUTDOWN/TIE-IN)
- 17. THE CONTRACTOR SHALL EMPLOY ADEQUATE METHODS TO MINIMIZE TURBIDITY IN WATERWAYS DURING ALL PHASES OF THE PROJECT. THE CONTRACTOR SHALL COMPLY WITH ALL APPLICABLE LAWS AND REGULATIONS CONCERNING WATER POLLUTION AND CONTROL OF EROSION.
- 18. CONTRACTOR SHALL CLEAN THE RIGHT-OF-WAY OF ANY AND ALL TRASH.
- 19. NO FIRES WILL BE ALLOWED. BRUSH AND CONSTRUCTION DEBRIS SHALL BE REMOVED FROM THE SITE.
- 20. LIFT STATION GATE SHALL BE KEPT CLOSED TO CONTROL ACCESS TO THE PROJECT SITE.
- 21. ANY EXISTING UTILITY DAMAGED DURING CONSTRUCTION SHALL BE REPAIRED OR REPLACED IMMEDIATELY WITH LIKE OR BETTER MATERIALS.
- 22 CONTRACTOR SHALL NOT DAMAGE FXISTING TREES LARGER THAN 4 INCHES IN DIAMETER (MEASURED 4 FT ABOVE THE GROUND) THAT ARE MORE THAN TWELVE FEET FROM CENTERLINE OF NEW INTERCEPTOR. THE CONTRACTOR MUST OBTAIN APPROVAL FROM THE OWNER'S REPRESENTATIVE BEFORE ANY TREES MORE THAN 10-FT FROM CENTERLINE OF INTERCEPTOR CAN BE REMOVED OR TRIMMED.

- 23. IT SHALL BE THE COMPLETE RESPONSIBILITY OF THE CONTRACTOR TO REBUILD THE CONCRETE OR ASPHALT PAVEMENT REPLACEMENT SECTIONS TO THE SAME LINE AND GRADE AS WAS EXISTING PRIOR TO PIPELINE CONSTRUCTION. SEE NOTE ON TEMP. ASPHALT RAMPS.
- 24. ALL NEW TREES REQUESTED BY THE OWNER SHALL BE PLANTED BY A NURSERYMAN LICENSED IN THE STATE OF
- 25. SURVEY POINTS INDICATED AS "CONTROL POINT" (IRON ROD SETS, "X" IN CONC, AND 60D NAILS POINT") SHALL BE USED FOR HORIZONTAL AND VERTICAL SURVEY CONTROL FOR THE PROJECT.
- 26. THE CONTRACTOR SHALL RESTORE AT HIS OWN EXPENSE, TEMPORARY ROADS AND CONSTRUCTION WORK AREAS.
- IN ACCORDANCE WITH TEXAS STATE LAW, AT LEAST 2 DAYS PRIOR TO BEGINNING EXCAVATION, THE CONTRACTOR SHALL BE RESPONSIBLE FOR NOTIFYING A TEXAS REGISTERED NOTIFICATION CENTER (I.E. TEXAS ONE CALL, DIG TESS, ETC.). IN ORDER TO HAVE EXISTING UTILITIES LOCATED. DIGTESS: 1-800-344-8377.
- 28. BLASTING WILL NOT BE ALLOWED
- 29. CONTRACTOR SHALL MAINTAIN AT LEAST ONE LANE OF TRAFFIC ON ALL ROADS AT ALL TIMES, AND CONSTRUCT TEMPORARY BYPASS, IF NECESSARY, IF THE ROADWAY MUST BE CLOSED TO FACILITATE CONSTRUCTION ACTIVITIES. CONTRACTOR SHALL SUBMIT A TRAFFIC CONTROL PLAN TO THE OWNER AND THE RIGHT-OF-WAY OWNER FOR THE ROADWAY FOR APPROVAL NO LESS THAN 14 DAYS IN ADVANCE OF THE PROPOSED ROADWAY CLOSURE. ANY COMMENTS RECEIVED ON THE PLAN BY THE OWNER OR RIGHT-OF WAY OWNER SHALL BE INCORPORATED INTO THE PLAN. THE PLAN SHALL BE PREPARED SPECIFICALLY FOR THIS PROJECT AND SHALL BE SEALED AND SIGNED BY AN ENGINEER LICENSED IN THE STATE OF TEXAS. THE COST TO PREPARE THE TRAFFIC CONTROL PLAN. WHEN REQUIRED, SHALL BE MADE INCIDENTAL TO THE PROJECT. IF AT ANYTIME DURING CONSTRUCTION THE CONTRACTOR'S PROPOSED PLAN OF OPERATION FOR HANDLING TRAFFIC DOES NOT PROVIDE FOR THE SAFE, COMFORTABLE MOVEMENT OF TRAFFIC, THE CONTRACTOR SHALL IMMEDIATELY CHANGE HIS OPERATIONS TO CORRECT THE LINSATISFACTORY CONDITIONS
- 30. CONTRACTOR SHALL PROVIDE APPROPRIATE SIGNAGE, BARRICADES, FLAGMEN, ETC. REQUIRED TO MAINTAIN SAFE TRAFFIC FLOW AT ALL TIMES FOR ANY WORK ACTIVITY ON OR ADJACENT TO ANY CITY, COUNTY OR TXDOT ROADWAY. ALL TRAFFIC CONTROL MEASURES SHALL BE IN ACCORDANCE WITH TXDOT'S MANUAL OF UNIFORM TRAFFIC CONTROL
- CONTRACTORS OPERATIONS MUST STAY WITHIN THE EASEMENTS RIGHT OF WAY & NTMWD PROPERTY. ANY DAMAGE OUTSIDE THESE OPERATIONS SHALL BE REPAIRED AND/OR REPLACED AT THE CONTRACTORS EXPENSE. ACCESS ROUTES OR OPERATIONS WHICH FALL OUTSIDE THE DESIGNATED AREAS WILL ONLY BE ALLOWED WITH PRIOR LANDOWNER CONSENT. CONTRACTOR SHALL PROVIDE THE OWNER WITH A COPY OF ANY AGREEMENTS MADE BETWEEN THE LANDOWNER AND THE CONTRACTOR.
- THE CONTRACTOR SHALL PROVIDE A VIDEO TAPE TO THE OWNER DOCUMENTING THE CONDITION OF THE PROJECT SITE AND SURROUNDING AREA PRIOR TO THE START OF ANY CONSTRUCTION. VIDEO TO BE PROVIDED PRIOR TO
- 33. PROVIDE ACCESS FOR LANDOWNERS AT EXISTING ROADS AND DRIVES AT ALL TIMES.
- WHERE NOT OTHERWISE NOTED BY GRADING PLAN RESTORE GROUND TO ORIGINAL GRADE AND PREVENT PONDING OF STORM WATER RUNOFF ON ALL GROUND DISTURBED BY CONSTRUCTION ACTIVITIES.
- CONTRACTOR SHALL PROTECT ALL TREES, LANDSCAPING AND STRUCTURES LOCATED WITHIN THE PROJECT SITE. TREES, LANDSCAPING AND STRUCTURES NOT INDICATED FOR REMOVAL OR TRANSPLANT ON THE PLANS SHALL NOT BE REMOVED OR TRANSPLANTED WITHOUT RECEIVING WRITTEN APPROVAL FROM THE N.T.M.W.D. OR CITY OF

This record drawing is a compilation of the sealed engineering drawing for this project; modified by addenda, change orders and information furnished by the contractor. The information shown on the record drawings that was provided by the contractor or others not associated with the design engineer cannot be verified for accuracy or completeness. This original sealed drawings are on file at the offices of Birkhoff, Hendricks & Carter, L.L.P.

BY _P.A.C. DATE 01/06/11

BIRKHOFF, HENDRICKS & CARTER, L.L.P.

PROFESSIONAL ENGINEERS Texas Firm F526 11910 Greenville Ave., Suite 600 Dallas, Texas (214) 361-7900



MORTH TEXAS MUNICIPAL WATER DISTRICT

LAKESIDE LIFT STATION IMPROVEMENTS


GENERAL NOTES

PROJECT NO. 2007-104

October 2008


SHEET NO.


C3

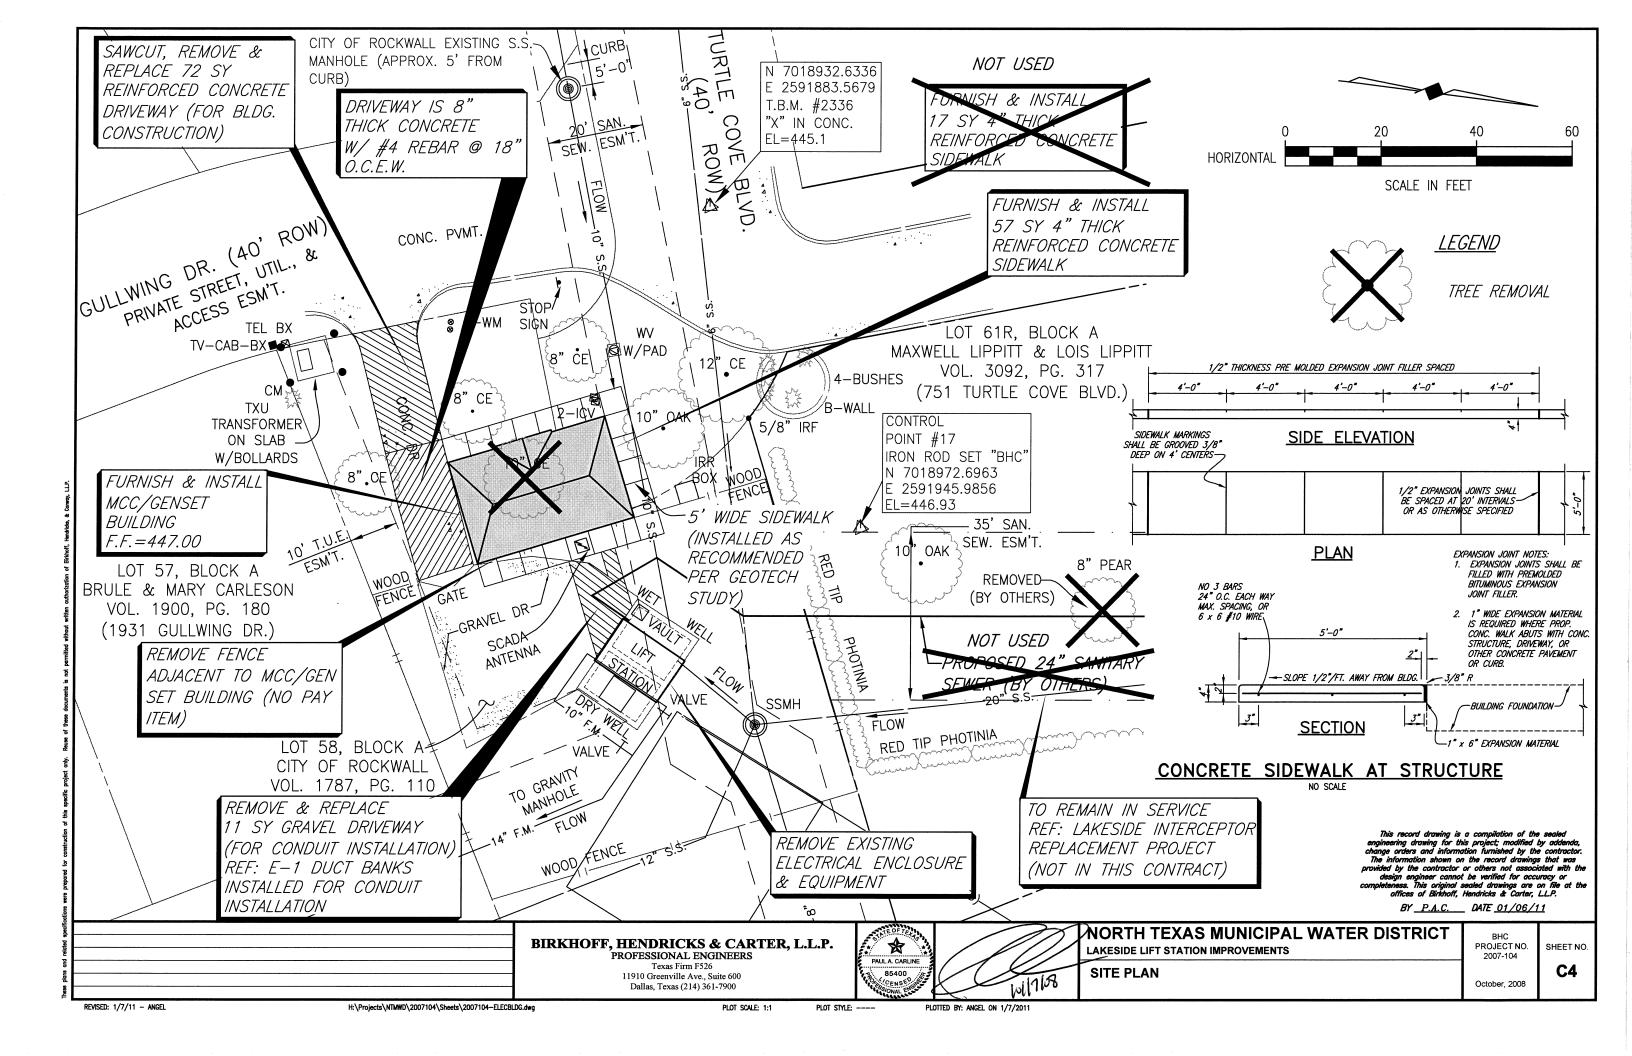

THIS RECORD DRAWING IS A COMPILATION OF THE SEALED ENGINEERING DRAWING FOR THIS PROJECT, MODIFIED BY ADDENDA, CHANGE ORDERS AND INFORMATION FURNISHED BY THE CONTRACTOR. THE INFORMATION SHOWN ON THE RECORD DRAWINGS THAT WAS PROVIDED BY THE CONTRACTOR OR OTHERS NOT ASSOCIATED WITH THE DESIGN ENGINEER CANNOT BE VERIFIED FOR ACCURACY OR COMPLETENESS. THE ORIGINAL SEALED DRAWINGS ARE ON FILE AT THE OFFICES OF BIRKHOFF, HENDRICKS & CARTER, LLP.


BY: LKS DATE: 7/23/10

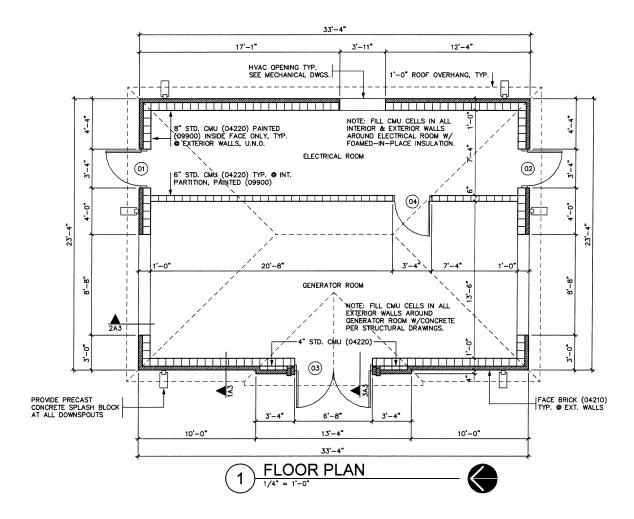


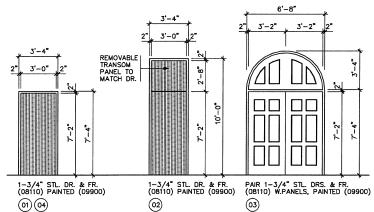

DOOR SCHEDULE 3

NOTE 1: SEE 4A3-10A3 FOR HEAD, JAMB & THRESHOLD DETAILS. NOTE 2: DOORS 03 & 04 SHALL BE HIGH STC TYPE.

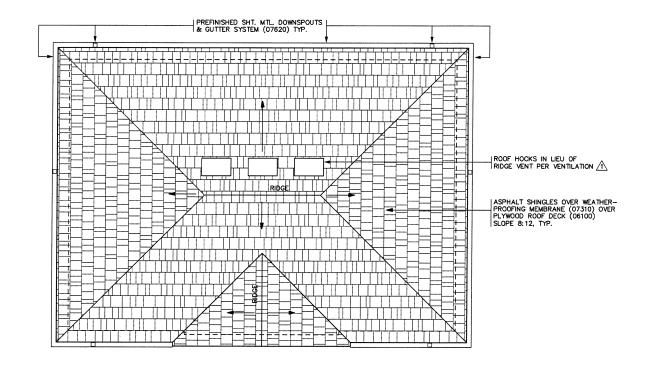

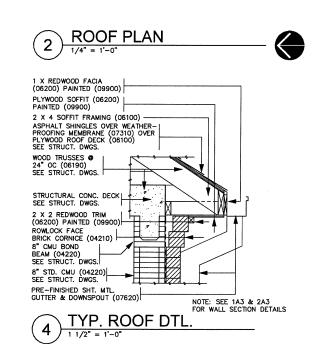

BIRKHOFF, HENDRICKS & CONWAY, L.L.P.

PROFESSIONAL ENGINEERS 11910 Greenville Ave., Suite 600 Dallas, Texas (214) 361-7900



SPURGIN & ASSOCIATES ARCHITECTS McKinney, Texas Tel. 972-562-5368 Fax 972-562-5368

NORTH TEXAS MUNICIPAL WATER DISTRICT LAKESIDE LIFT STATION IMPROVEMENTS


GENERATOR BLDG. FLOOR PLAN, ROOF PLAN, DOOR SCHED.

BHC PROJECT NO. 2007-104

SHEET NO.

Α1

October, 2008

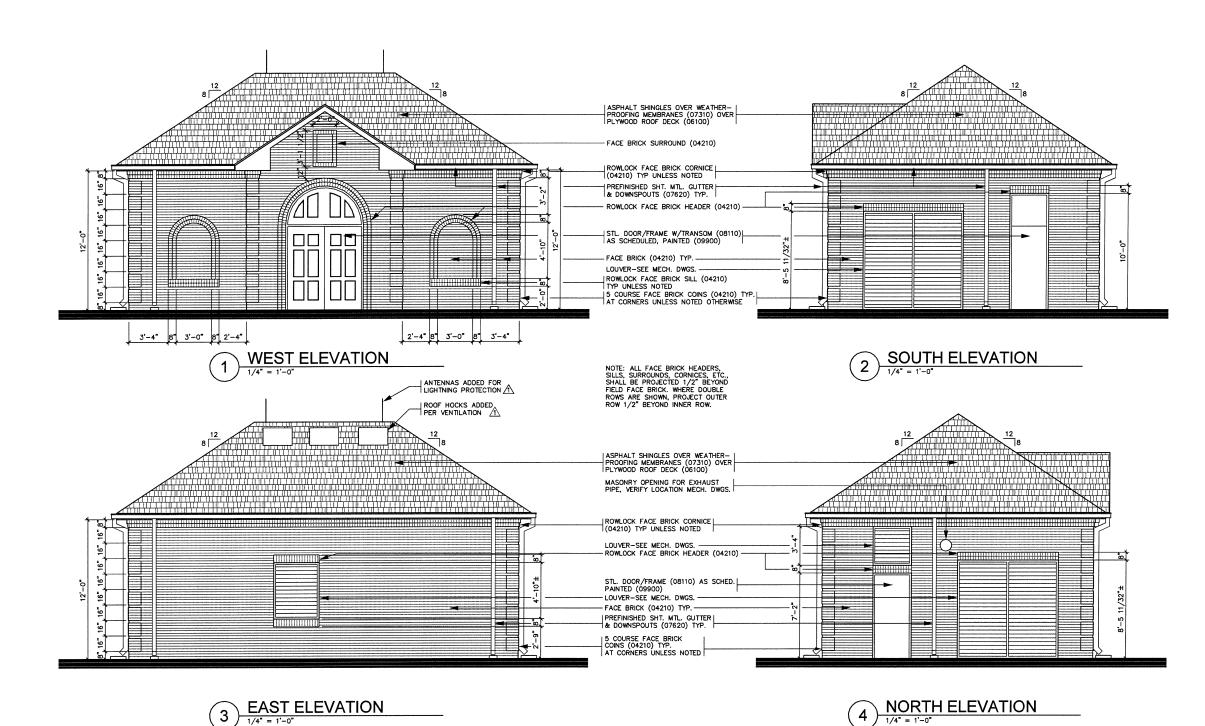

THIS RECORD DRAWING IS A COMPILATION OF THE SEALED ENGINEERING DRAWING FOR THIS PROJECT, MODIFIED BY ADDENDA, CHANGE ORDERS AND INFORMATION FURNISHED BY THE CONTRACTOR. THE INFORMATION SHOWN ON THE RECORD DRAWINGS THAT WAS PROVIDED BY THE CONTRACTOR OR OTHERS NOT ASSOCIATED WITH THE DESIGN ENGINEER CANNOT BE VERIFIED FOR ACCURACY COMPLETENESS. THE ORIGINAL SEALED DRAWINGS ARE ON FILE AT THE OFFICES OF BIRKHOFF, HENDRICKS & CARTER, LLP.

BY: LKS DATE: 7/23/10

NORTH TEXAS MUNICIPAL WATER DISTRICT

BHC PROJECT NO. SHEET NO. 2007-104

A2

BIRKHOFF, HENDRICKS & CONWAY, L.L.P.

PROFESSIONAL ENGINEERS 11910 Greenville Ave., Suite 600 Dallas, Texas (214) 361-7900



SPURGIN & ASSOCIATES ARCHITECTS
McKinney, Texas
Tel. 972-562-5368
Fax 972-562-5368


LAKESIDE LIFT STATION IMPROVEMENTS


GENERATOR BLDG. EXTERIOR ELEVATIONS


October, 2008

THIS RECORD DRAWING IS A COMPILATION OF THE SEALED ENGINEERING DRAWING FOR THIS PROJECT, MODIFIED BY ADDENDA, CHANGE ORDERS AND INFORMATION FURNISHED BY THE CONTRACTOR. THE INFORMATION SHOWN ON THE RECORD DRAWINGS THAT WAS PROVIDED BY THE CONTRACTOR OR OTHERS NOT ASSOCIATED WITH THE DESIGN ENGINEER CANNOT BE VERIFIED FOR ACCURACY OR COMPLETENESS. THE ORIGINAL SEALED DRAWINGS ARE ON FILE AT THE OFFICES OF BIRKHOFF, HENDRICKS & CARTER, LLP.

BY: LKS DATE: 7/23/10

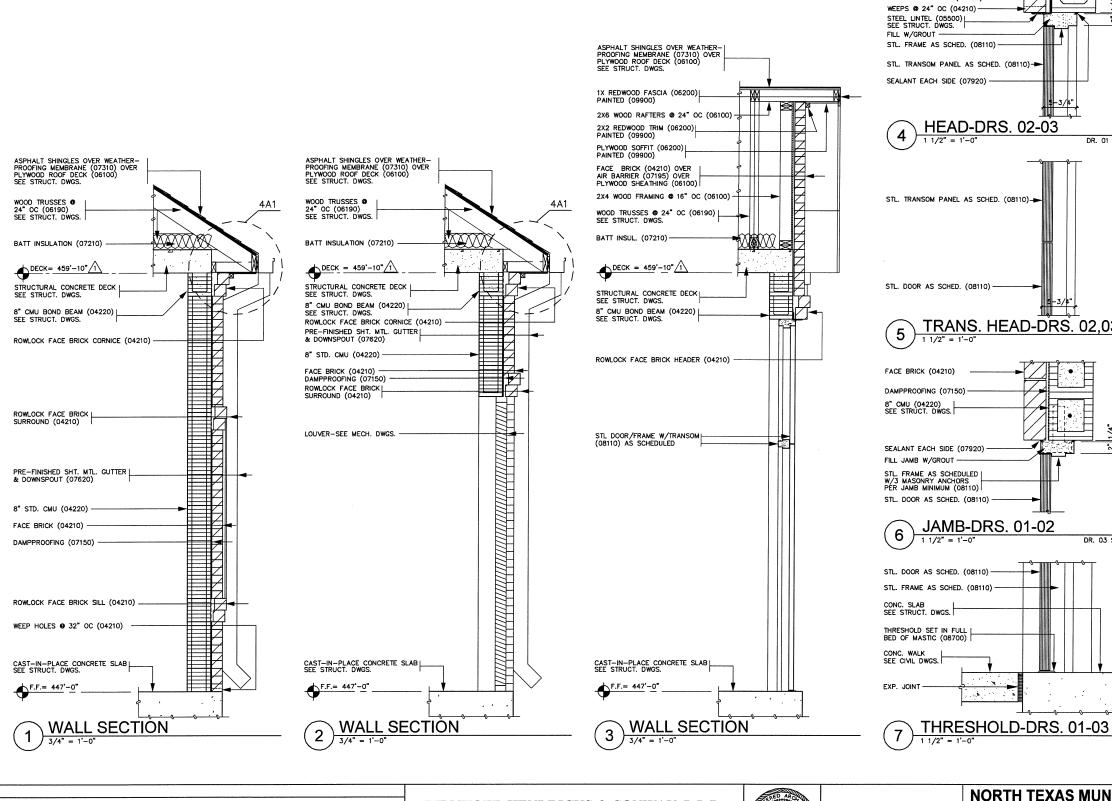

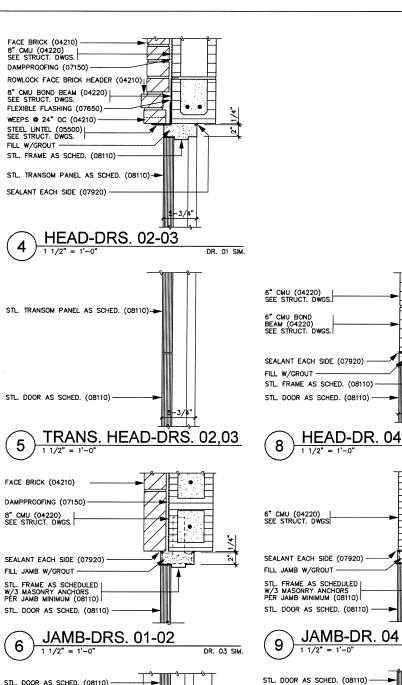

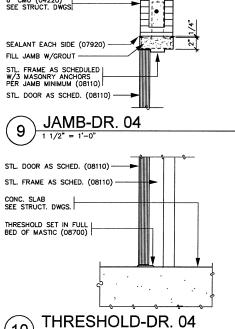

BIRKHOFF, HENDRICKS & CONWAY, L.L.P.

PROFESSIONAL ENGINEERS 11910 Greenville Ave., Suite 600 Dallas, Texas (214) 361-7900



SPURGIN & ASSOCIATES ARCHITECTS McKinney, Texas Tel. 972-562-5368 Fax 972-562-5368

NORTH TEXAS MUNICIPAL WATER DISTRICT LAKESIDE LIFT STATION IMPROVEMENTS

GENERATOR BLDG. WALL SECTIONS & MISC. DETAILS

(10)

PROJECT NO. 2007-104

SHEET NO. **A3**

October, 2008

GENERAL NOTES:

- 1. ANY BACKGROUND DRAWINGS SHOWN ON THE STRUCTURAL PLANS ARE FOR REFERENCE ONLY. SEE ARCHITECTURAL, MECHANICAL, ELECTRICAL, PLUMBING, AND OTHER DRAWINGS FOR ACTUAL REQUIREMENTS OF NON—STRUCTURAL FLORISMS
- 2. STRUCTURAL DRAWINGS SHOW ELEVATIONS AND RELATIONSHIPS OF STRUCTURAL ELEMENTS IN THEIR FINAL POSITION. CONSTRUCTION MEANS AND METHODS SHALL ALLOW FOR CAMBERS, LOSS OF CAMBER DURING CONSTRUCTION LOADING, DEFLECTIONS, AND NORMAL MOVEMENTS OF STRUCTURAL ELEMENTS DURING CONSTRUCTION.
- 3. SECTIONS AND DETAILS INDICATED AS TYPICAL SECTIONS AND TYPICAL DETAILS SHALL BE USED AT ALL LOCATIONS WHERE CONDITIONS ARE SIMILAR TO THOSE DESCRIBED IN THE DETAILS.

EXISTING CONDITIONS

- 1. FIELD VERIFY ALL EXISTING DIMENSIONS AND CONDITIONS PRIOR TO START OF SHOP DRAWINGS OR CONSTRUCTION. WHERE INDICATED ON DRAWINGS, SUBMIT RECORD OF FIELD CONDITIONS TO BIRKHOFF, HENDRICKS & CONWAY, LLP.
- 2. EXISTING CONDITIONS REQUIRING MODIFICATIONS TO DOCUMENTS FOR PROPOSED CONSTRUCTION SHALL BE IMMEDIATELY SUBMITTED TO BIRKHOFF, HENDRICKS & CONWAY, LLP.

- 1. REVIEW OF SUBMITTAL INFORMATION SHALL BE FOR GENERAL REQUIREMENTS OF PROJECT; AND SHALL NOT INCLUDE CHECKING OF DETAILED DIMENSIONS OR DETAILED QUANTITIES, NOR REVIEW OF THE CONTRACTOR'S SAFTY MEASURES IN, ON, OR NEAR THE WORK SITE, OR MEANS AND METHODS OF
- 2. CONTRACTOR SHALL CHECK ALL SHOP DRAWING SUBMITTALS FOR COMPLIANCE WITH CONTRACT DOCUMENTS.
- CONTRACTOR SHALL INDICATE CHECKING AND APPROVAL OF SHOP DRAWINGS BY AFFIXING HIS SHOP DRAWING STAMP WITH THE DATE OF APPROVAL AND NAME OF PERSON APPROVING SHOP DRAWINGS.
- 4. CONSTRUCTION SCHEDULE SHALL ALLOW 2 WEEKS FOR SHOP DRAWING REVIEW AND RETURN BY THE STRUCTURAL ENGINEER. REVIEW BY THE DESIGN TEAM SHALL BE FOR GENERAL COMPLIANCE WITH THE COMPLIANCE WITH THE CONTRACT DOCUMENTS.
- 5. CONTRACTOR SHALL BE RESPONSIBLE FOR ALL QUANTITIES. DIMENSIONS. CONSTRUCTION MEANS, METHODS, AND JOB SITE SAFETY, AS WELL AS PROTECTION AND STABILITY OF EXISTING STRUCTURES DURING DEMOLITION.
- ACTIONS TAKEN ON THE SHOP DRAWINGS SHALL NOT RELIEVE THE CONTRACTOR FROM RESPONSIBILITY OF COMPLIANCE WITH CONTRACT DOCUMENTS.

STRUCTURAL MASONRY

CHANGE ORDER NO. X

FIFI D CHANGE

- 1. MATERIALS SHALL COMPLY WITH THE FOLLOWING:
- A HOLLOW MASONRY UNITS ASTM C90, LIGHTWEIGHT, TYPE N1, MINIMUM COMPRESSIVE STRENGTH OF 1900 PSI ON NET AREA. B. MORTAR - ASTM C 270, TYPE S, WITH MINIMUM COMPRESSIVE STRENGTH
- OF 1800 PSI C. COARSE GROUT - ASTM C 476, WITH MINIMUM COMPRESSIVE STRENGTH OF 2500 PSI, MAXIMUM AGGREGATE SIZE OF 1/2 INCH. D. Z TIES — 3/16 INCH DIAMETER, ASTM A 82, GALVANIZED.
- 2. MASONRY DESIGN BASED ON PRISM STRENGTH OF F'M = 1500 PSI.
- 3. WALL VERTICAL REINFORCING SHALL CONFORM TO SHEET S3 AND THE
- A. VERTICAL BARS SHALL BE CENTERED IN CELLS.
 B. BAR LAP SPLICES SHALL BE 60 BAR DIAMETERS, MINIMUM.
 C. SPLICES SHALL BE STAGGERED WITH NO MORE THAN HALF OF BARS LAPPED WITHIN LENGTH OF LAPS.
- 4. WALL HORIZONTAL REINFORCING SHALL BE AS FOLLOWS
- A PLACED CONTINUOUSLY IN BOND BEAMS AND GROUTED SOLIDLY IN PLACE. B. LAP SPLICES SHALL BE 48 BAR DIAMETERS, MINIMUM. C. LAP SPLICES SHALL HAVE BARS TIED TOGETHER.
- 5. JOINT REINFORCING SHALL BE AS FOLLOWS:
- 1. STANDARD "DUR-O-WALL", TRUSS TYPE, AT 16 INCHES ON CENTER, UNLESS NIDARY DURY-O-WALL, IRUSS 19PE, AT 16 INCHES ON CENTER, UNLESS ED OTHERWISE. WIDE TWO HORIZONTAL WIRES IN BLOCK WYTHES. SPLICES SHALL BE 14 INCHES MINIMUM WITH HORIZONTAL WIRES LAPPED TO CIDE TO THE STATE OF THE S
- 6. ALL CMU EXTERIOR WALLS AROUND THE GENERATOR ROOM SHALL BE FILED WITH CONCRETE AND ALL OTHER CMU EXTERIOR AND INTERIOR WALLS SHALL BE FILLED WITH FOAM INSULATION, EXCEPT WHERE GROUTED CELLS ARE REQUIRED PER SHEET S3.

CONCRETE REINFORCING

- ALL CONCRETE REINFORCEMENT SHALL BE OF DOMESTIC MANUFACTURE AND SHALL CONFORM TO ASTM A-615, GRADE 60, U.N.O. FIELD BENT DOWELS SHALL CONFORM TO ASTM A-615,
- 2. ALL WELDED WIRE FABRIC SHALL CONFORM TO ASTM A-185.
- 3. DETAILING OF CONCRETE REINFORCEMENT AND ACCESSORIES SHALL BE PER ACI 315.
- 4. REINFORCING SHOWN IN SECTIONS AND DETAILS IS SCHEMATIC AND INDICATES THAT REINFORCING EXISTS. PROVIDE REINFORCING AS REQUIRED BY SCHEDULE, NOTE, GENERAL NOTES, AND SPECIFICATIONS.
- 5. LONGITUDINAL BEAM REINFORCING SHOWN IN SECTION OR DETAIL TO BE CONTINUOUS SHALL HAVE TOP BARS HOOKED AT DISCONTINUOUS ENDS WITH STANDARD 90 DEGREE HOOKS.
- 6. WHEN PERMITTED, WELDING OF REINFORCEMENT SHALL BE PER AWS D1.4.
- 7. CONTINUOUS REINFORCEMENT IN UNSCHEDULED SLABS BEAMS AND GRADE BEAMS SHALL NOT BE SPLICED. REINFORCING BARS MAY BE SPLICED ONLY AS SHOWN ON THE DRAWINGS EXCEPT THAT REINFORCING DESIGNATED AS "CONTINUOUS" MAY BE LAP SPLICED 36 BAR
- 8. CONCRETE PROTECTION FOR REINFORCEMENT, INCLUDING PRIMARY, STIRRUPS, TIES, ETC. SHALL BE AS NOTED BELOW, OR PER ACI 318 FOR CONDITIONS NOT NOTED:

CONDITION	FOR CARBONATE, LIGHTWEIGHT AND SAND LIGHTWEIGHT AGGREGATES	FOR SILICEOUS AGGREGATES
CONCRETE PLACED AGAINST SOIL	3 INCHES	3 INCHES
FOOTINGS	3 INCHES	3 INCHES
SLABS ON GRADE	1-1/2 INCHES TOP	1-1/2 INCHES TOP
	2 INCHES BOTTOM	2 INCHES BOTTOM
GRADE BEAMS (FORMED)	2 INCHES BOTTOM	2 INCHES BOTTOM
	2 INCHES SIDE	2 INCHES SIDE
	2 INCHES TOP	2 INCHES TOP

DEFORMED BAR ANCHORS

DEFORMED BAR ANCHORS (DBA) SHALL BE NELSON, FLUX FILLED DEFORMED BAR ANCHORS, TYPE D2L, WEDLED TO STEEL AS SHOWN IN ACCORDANCE WITH THE RECOMMENDATIONS OF THE MANUFACTURER.

CONCRETE


- 1. CONCRETE PROPORTIONING, MIXING, TRANSPORTING, PLACING, AND CURING SHALL BE PER ACI 301.
- 2. CONCRETE SURFACES SHALL CONFORM TO TOLERANCE LIMITS PER ACI 117, U.N.O.
- 3. CONCRETE SHALL HAVE SAND, COARSE AGGREGATES PER ASTM C-33 OR C-330 AS SCHEDULED, TYPE I OR III PORTLAND CEMENT PER ASTM C-150, AND SHALL COMPLY WITH THE FOLLOWING:


USAGE	28 DAY STRENGTH	COARSE AGGR.	MAX. AGGR. SIZE	SLUMP	OTHER
BEAMS AND SLABS	4000 PSI	ASTM C33	1"	4 ± 1	
GRADE BEAMS AND SLAB-ON-GRADE	4000 PSI	ASTM C33	1*	4 ± 1	W/C = 0.45 MAX.

- 4. JOINTS NOT SHOWN SHALL BE MADE AND LOCATED TO LEAST IMPAIR STRENGTH AND APPEARANCE OF STRUCTURE, AS APPROVED. NO HORIZONTAL JOINTS SHALL BE PERMITTED IN CONCRETE EXCEPT WHERE THEY NORMALLY OCCUR OR WHERE NOTED. VERTICAL JOINTS SHALL OCCUR NEAR CENTERS OF SPANS AT LOCATIONS APPROVED.
- 5. JOINTS BETWEEN FOOTINGS AND WALLS SHALL BE PREPARED BY ROUGHENING THE SURFACE OF THE CONCRETE IN AN APPROVED MANNER SO THAT THE AGGREGATE SHALL BE EXPOSED UNIFORMLY LEAVING NO LAITANCE, LOOSENED PARTICLES OR DAMAGED CONCRETE.
- 6. U.N.O., OR AS INDICATED ON ARCHITECTURAL DRAWINGS, PROVIDE CHAMFERS AT EXPOSED EDGES OF CONCRETE.
- ALL SLEEVES, INSERTS, ANCHORS, AND EMBEDDED ITEMS REQUIRED FOR ADJOINING WORK SHALL BE VERIFIED BY CONTRACTOR AND SHALL BE IN PLACE PRIOR TO CONCRETING.
- 8. SLAB ON GRADE SHALL HAVE A SMOOTH TROWEL FINISH
- 9, ROOF SLAB SHALL HAVE A HAND TROWEL FINISH.
- 10. DRIVEWAYS AND SIDEWALKS SHALL USE 4000 PSI (6 SACK) CONCRETE.

FOUNDATIONS

- 1. THE SUBSURFACE INFORMATION AND FOUNDATION DESIGN ARE BASED ON "GEOTECHNICAL STUDY, NTMWD LAKESIDE LIFT STATION IMPROVEMENTS, ROCKWALL, TX," REPORT NO. 95237, PREPARED BY KLEINFELDER, DATED MARCH 20, 2008.
- METHODS OF CONSTRUCTION OF FOUNDATION AND OTHER PORTIONS OF PROJECT SHALL COMPLY WITH THE REPORT.
- PROVIDE A MINIMUM OF 6 FEET OF SELECT FILL BELOW THE FLOOR SLAB TO REDUCE THE CALCULATED PVR TO 1 INCH OR LESS.
- 4. THE SELECT FILL SHOULD NOT BE ALLOWED TO EXTEND BEYOND THE BUILDING PERIMETER. HOWEVER, THIS OPTEN OCCURS DURING CONSTRUCTION. AS SUCH, EARTHWORK OPERATIONS SHOULD UNDERCUIT THE SUBGRADE AROUND THE BUILDING PERIMETER FOLLOWING GRADE BEAM CONSTRUCTION SO THAT 2 FEET OF ON-SITE CLY MAY BE PLACED AT THE GROUND SURFACE TO ACT AS A BARRIER TO SURFACE WATER INFLITRATION. THE WIDTH OF THE REPLACEMENT SHOULD BE ENOUGH TO REMOVE THE SELECT FILL BUT SHOULD ALSO BE NO LESS THAN 5 FEET WIDE. FAILURE TO PROVIDE THIS COULD RESULT IN POTENTIAL DEEP—SEATED SWELL UNDER NO CIPIEL METAMOCES SHOULD A. "PAINT THIS EFFECT" BE CORATTO BENEATH THE NO CIRCUMSTANCES SHOULD A "BATH TUB EFFECT" BE CREATED BENEATH THE
- 5. THE BUILDING AREA SHOULD BE STRIPPED OF EXISTING CONCRETE AND ALSO VEGETATION, ROOTS, OTHER ORGANIC MATERIAL, AND DEBRIS BEFORE CONSTRUCTION. THE STRIPPING DEPTH SHOULD BE BASED ON FIELD OBSERVATIONS WITH PARTICULAR ATTENTION GIVEN TO UNEVEN TOPOGRAPHY, AND EXCESSIVELY WET SOILS. SPECIAL CARE SHOULD BE GVEN TO THE REMOVAL OF TREE STUMPS AND ASSOCIATED ROOT SYSTEMS. AFTER EXCAMATING, THE STRIPPED SUBGRADE SHOULD BE FIRM AND ABLE TO SUPPORT THE CONSTRUCTION EQUIPMENT WITHOUT DISPLACEMENT. SOFT OR FLEDING SUBGRADE SHOULD BE CORRECTED AND MADE STABLE BEFORE CONSTRUCTION PROCEEDS. PROOF ROLLING SHOULD BE USED TO DETECT SOFT SPOTS OR PUMPING SUBGRADE AREAS, PROOF ROLLING SHOULD BE PERFORMED USING A HEAVY PNEUMATIC TIRED ROLLER, LOADER TRUCK, OR SIMILAR EQUIPMENT WEIGHING AT LEAST 25 TONS. THE PROOF ROLLING SHOULD BE OBSERVED BY THE OWNERS REPRESENTATIVE. OBSERVED SOFT SPOTS OR AREAS OF PUMPING SUBGRADE OBSERVED SHOULD BE UNDERCUIT AND REVIORNED. WHE PROOF ROLLING SHOULD BE UNDERCUIT AND REVIORNED. WHE PROOF ROLLING SHOULD COLUR ONCE THE EXISTING SOILS HAVE BEEN EXCAVATED, BUT BEFORE THE FILL IS PLACED AND COMPACTED. THE PROOF ROLLING IS INTENDED TO ALVIE OF THE BUILDING AND FOUNDATION AREA, BUT ALSO WITHIN ALL AREAS OF PAVEMENT, SIDEWALKS, AND OTHER LOCATIONS THAT WILL SUPPORT SUMPINE LOCATIONS THAT WILL SUPPORT SUMPINE LOADS.
- PRIOR TO FILL PLACEMENT, THE EXPOSED SUBGRADE SHOULD BE SCARIFIED TO A
 DEPTH OF 8 INCHES; ITS MOISTURE CONTENT ADJUSTED, AND RECOMPACTED TO THE
 DENSITY SPECIFIED FOR FILL BELOW.
- 7. SELECT FILL NON-EXPANSIVE SELECT FILL SHOULD BE FREE OF ROOTS AND SELECT FILL - NON-EXPANSIVE SELECT FILL SHOULD BE FREE OF ROUSS AND RORGANIC DEBRIS. THE SOIL SHOULD BE SANDY CLAY OR CLAYEY SAND HAVING A PLASTICITY INDEX BETWEEN 7 AND 15, A LIQUID LIMIT LESS THAN 35, AND A MAXIMUM OF 70 PERCENT PASSING SIEVE #200. THE SELECT FILL MATERIAL SHOULD BE COMPACTED TO 95 TO 100 PERCENT OF THE MAXIMUM DRY DENSITY AS DETERMINED BY THE STD PROCTOR TEST, ASTM D 698. IN CONJUNCTION WITH THE COMPACTING OPERATIONS, THIS FILL MATERIAL SHOULD BE BROUGHT TO BETWEEN 1 PERCENT BELOW TO 4 PERCENT ABOVE THE OPTIMUM MOISTURE CONTENT (-1 TO

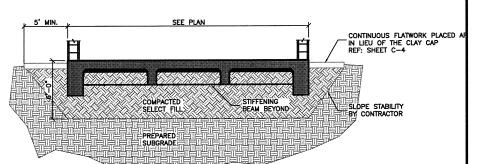

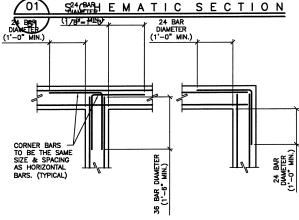


N O T E : PROVIDE CORNER BARS FOR BOTTOM AND INTERMEDIATE BARS IN GRADE BEAMS

S1,

GENERAL NOTES AND TYPICAL DETAILS

ADDITIONAL CORNER BARS at GRADE BEAMS and WALLS

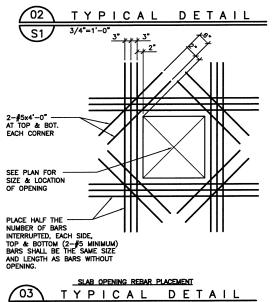

THE SEAL APPEARING ON THIS DOCUMENT WAS AUTHORIZED BY: STEVEN H. BALDAUF, P.E. 44827 ON AUGUST 05, 2010



BALDAUF # HERRIN & ASSOCIATES, INC. STRUCTURAL ENGÍNEERS 91806 108AL ENGINEERS 9603 WHITE ROCK TRAIL, SUITE 207 DALLAS, TX 75238 214-341-7575 FAX 214-341-4850

BHA JOB NUMBER 2006150

NORTH TEXAS MUNICIPAL WATER DISTRICT LAKESIDE LIFT STATION IMPROVEMENTS

PROJECT NO. 2007-104


S1 August, 2010


SHEET NO.


BIRKHOFF, HENDRICKS & CONWAY, L.L.P.

PLOT SCALE: 1:1

PROFESSIONAL ENGINEERS 11910 Greenville Ave., Suite 600 Dallas, Texas 75243 (214) 361-7900

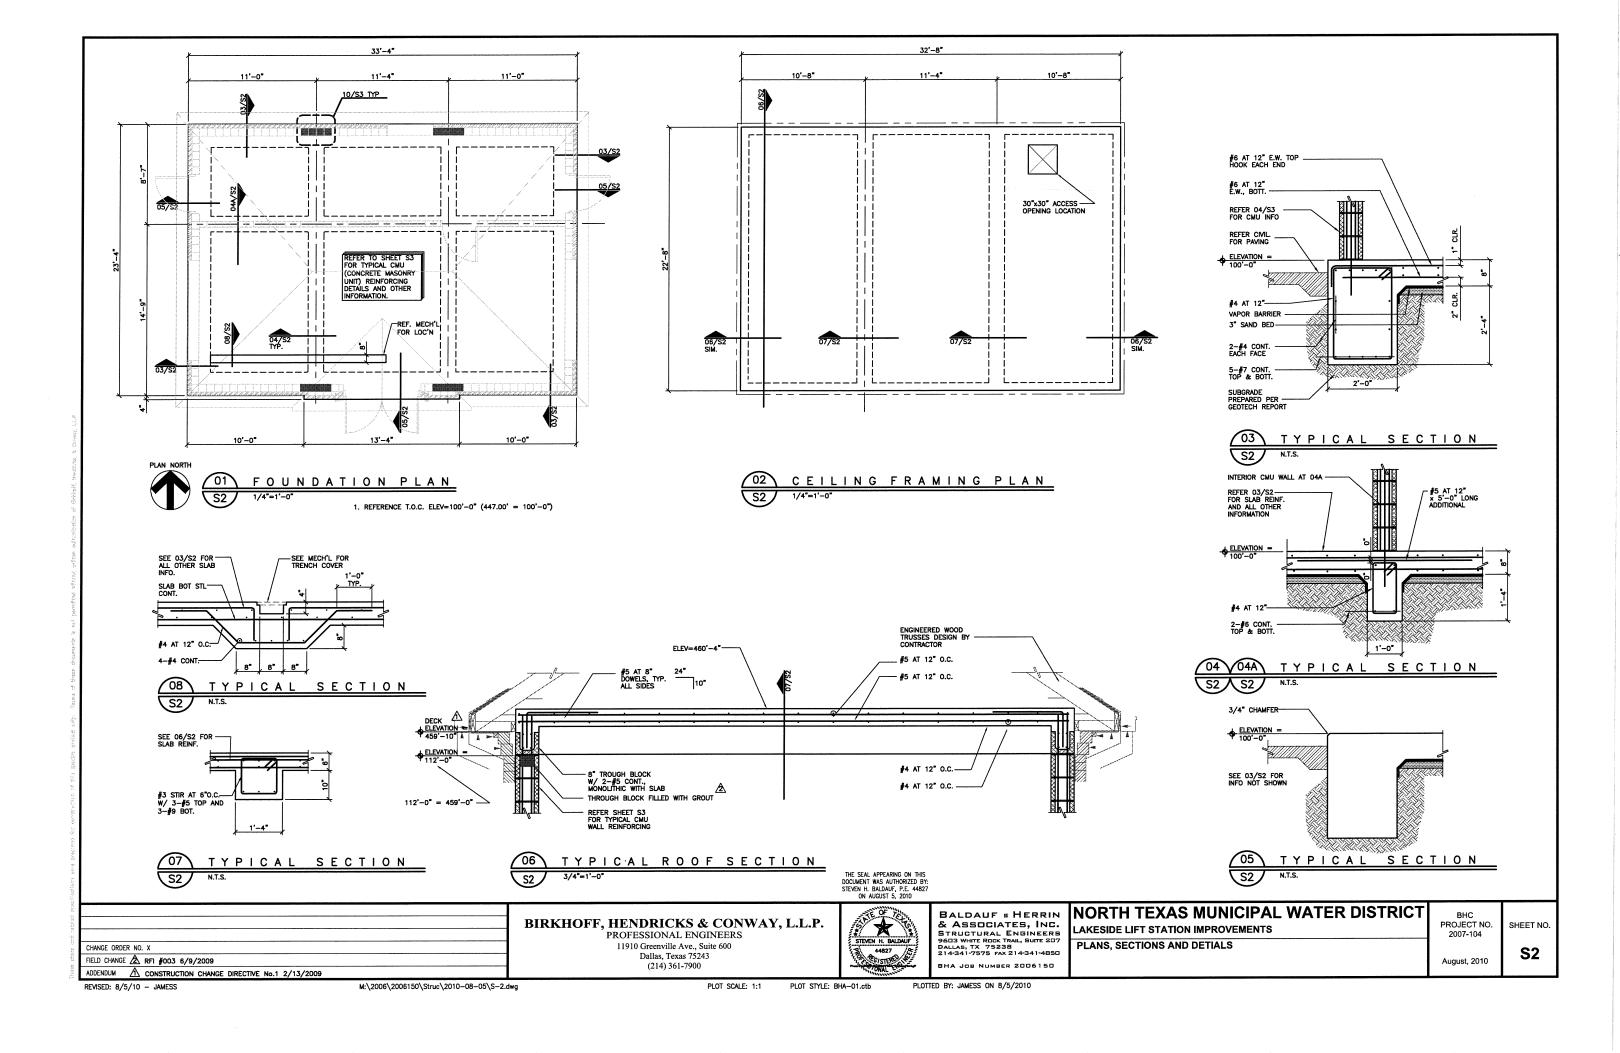

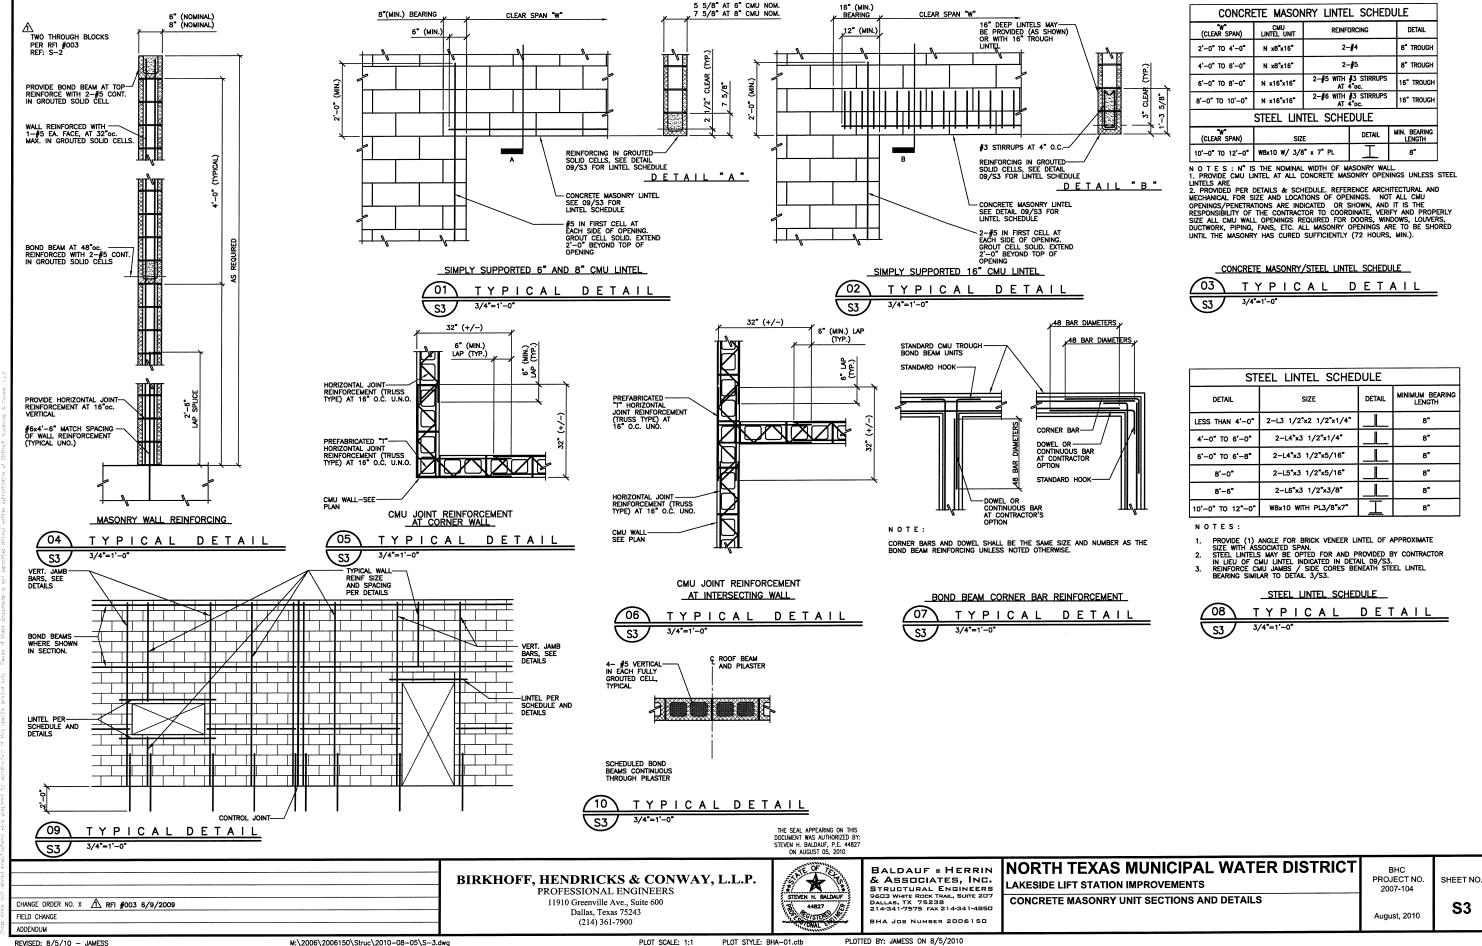

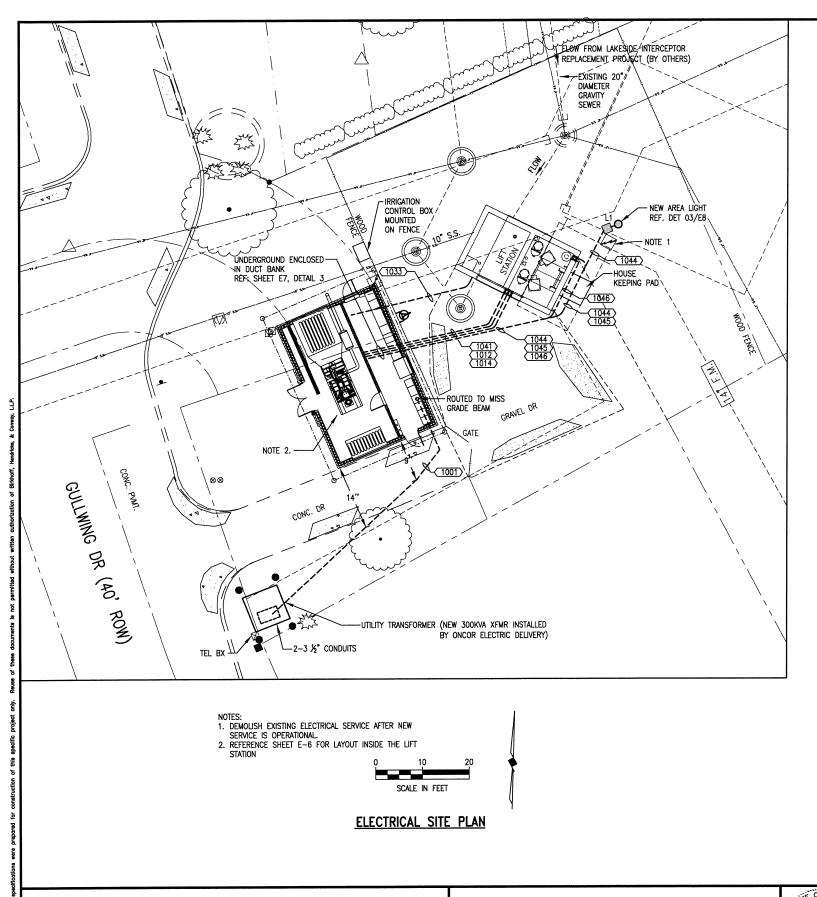

ELEC	TRIC	CAL	SITE	& PLAN	SYMB	OL LE	GEN	D				
SYMBOL	DESCRIPTION								,	SYMBOL		DESCRIPTION
Ø	LIG	HT FIXT	URE -	LETTER DENO	tes fixtur	E TYPE				\boxtimes	MAGNETIC MOTOR STARTE	R
HΑ	HID	WALL	MOUNT	ed fixture –	LETTER DE	NOTES FI	XTURE	TYPE			DISCONNECT SWITCH - H	HEAVY DUTY TYPE
(A)	FLU	JORESCI	ent fix	TURE - RECE	SSED, SUR	FACE OR	WALL I	MOUNTED		C	CONTACTOR	
	EMI	ERGENC	Y POW	ER PACK FIXTU	IRE - WAL	L MOUNTE	D			S	EXPLOSION-PROOF COND	OUIT SEAL
	EXF	POSED	CONDUI	T RUN						HH	HAND HOLE	
	COI	NCEALEI	D OR L	INDERGROUND	CONDUIT F	RUN				cs	CONTROL STATION. REF (CONTROL SCHEMATICS FOR TYPE.
	CIR	CUIT H	OME RU	IN TO PANELBO	OARD					$\overline{}$	FLEXIBLE CONDUIT	
<u>\$</u>	WAL	⊥ SWIT	CH, SP	ST						+++	CONDUIT TEE FITTING	
\$ 2	WAL	L SWIT	CH, 2	POLE						4	CONDUIT FITTING LB, LR, ETC.	
Ş 3	WAL	L SWIT	СН, 3-	WAY						+‡+	CROSS CONDUIT FITTING	
<u>\$</u> м	MO.	TOR RA	TED SW	ITCH WITH OVE	RLOADS					Ю	WALL MOUNTED THERMOSTAT	
O © _{WP}	DUP	LEX RCF	PT & GF	CI DEVICE MOUN	TING IN WEA	THERPROOF	BOX 4	& COVERS		-OHE	OVERHEAD ELECTRICAL LINES	
Ө	RCF	PT-20A	125V	2P 3W GND. [OUPLEX-12	" UP OR	AS NO	TED		WP	WEATHERPROOF	
Ю OR O	JUN	ICTION	BOX -	WALL OR CEI	LING MOUN	TED				GFI	GROUND FAULT INTERRUPTER	
Ø	MO	TOR LO	CATION							E.C.	EMPTY CONDUIT	
⊠i	COI	IBINATIO	ON FUS	ED DISCONNEC	T SW./ MA	GNETIC M	OTOR	STARTER	\langle	1122	CONDUIT AND CABLE TAG	NUMBER. REF SCHEDULE
I.S.	INTI	RUSION	SWITCH	1						0	TEMPERATURE TRANSMITTE	ER
A	ANTENNA											
	Luminaire Schedule											
Symbol	Qty	Volt	Label	Arrangement	Lamp	Lumens	LLF	Manufacti	urer	Descriptio	n	Comments
₩	1	120	L	SINGLE	70W HPS	6300	.80	0 GARDCO		GULLWING	G13-3XL-70HPS-120-BRP-F	INTERNAL HOUSE SIDE SHIIELD
Luminaire Loca												
Pole #							Distribution	Comment				
11	L 14 FT. 90° 0			Ü			TYPE III	CLEAR, FLAT LENS, FULL CUTOFF				

- NOIES:

 1. PHOTOMETRIC DATA USED IS BASED ON ESTABLISHED IES PROCEDURES AND PUBLISHED LAMP RATINGS.

 2. THE LIGHT LOSS FACTOR (LLF) IS BASED ON LAMP MANUFACTURER'S PUBLISHED MEAN LUMEN RATINGS.

 3. FIELD PERFORMANCE WILL DEPEND ON ACTUAL LAMP, BALLAST, ELECTRICAL, AND SITE CHARACTERISTICS.

 4. REFERENCE ENCLOSED PLAN SHEET E1—A FOR ADDITIONAL SITE PLAN DETAILS.

This record drawing is a compilation of the sealed engineering drawing for this project; modified by addenda, change orders and information furnished by the contractor. The information shown on the record drawings that was provided by the contractor or others not associated with the design engineer cannot be verified for accuracy or completeness. This original sealed drawings are on file at the offices of Birkhoff, Hendricks & Conway, L.L.P.

BY <u>JJK</u> DATE <u>12/15/10</u>

THESE DOCUMENTS ARE FOR BIDDING, CONSTRUCTION, AND PERMIT PURPOSES. DATE: 10-17-2008 MCREARY & ASSOCIATES, INC.
Consulting Engineers
Dallas, Texas FIRM No. F-338

NORTH TEXAS MUNICIPAL WATER DISTRICT LAKESIDE LIFT STATION IMPROVEMENTS ELECTRICAL **ELECTRICAL SITE PLAN**

BHC PROJECT NO. SHEET NO. 2007-104


E1


DECEMBER, 2010


BIRKHOFF, HENDRICKS & CONWAY, L.L.P.


PROFESSIONAL ENGINEERS 11910 Greenville Ave., Suite 600 Dallas, Texas 75243 (214) 361-7900


PLOT SCALE: 1:240

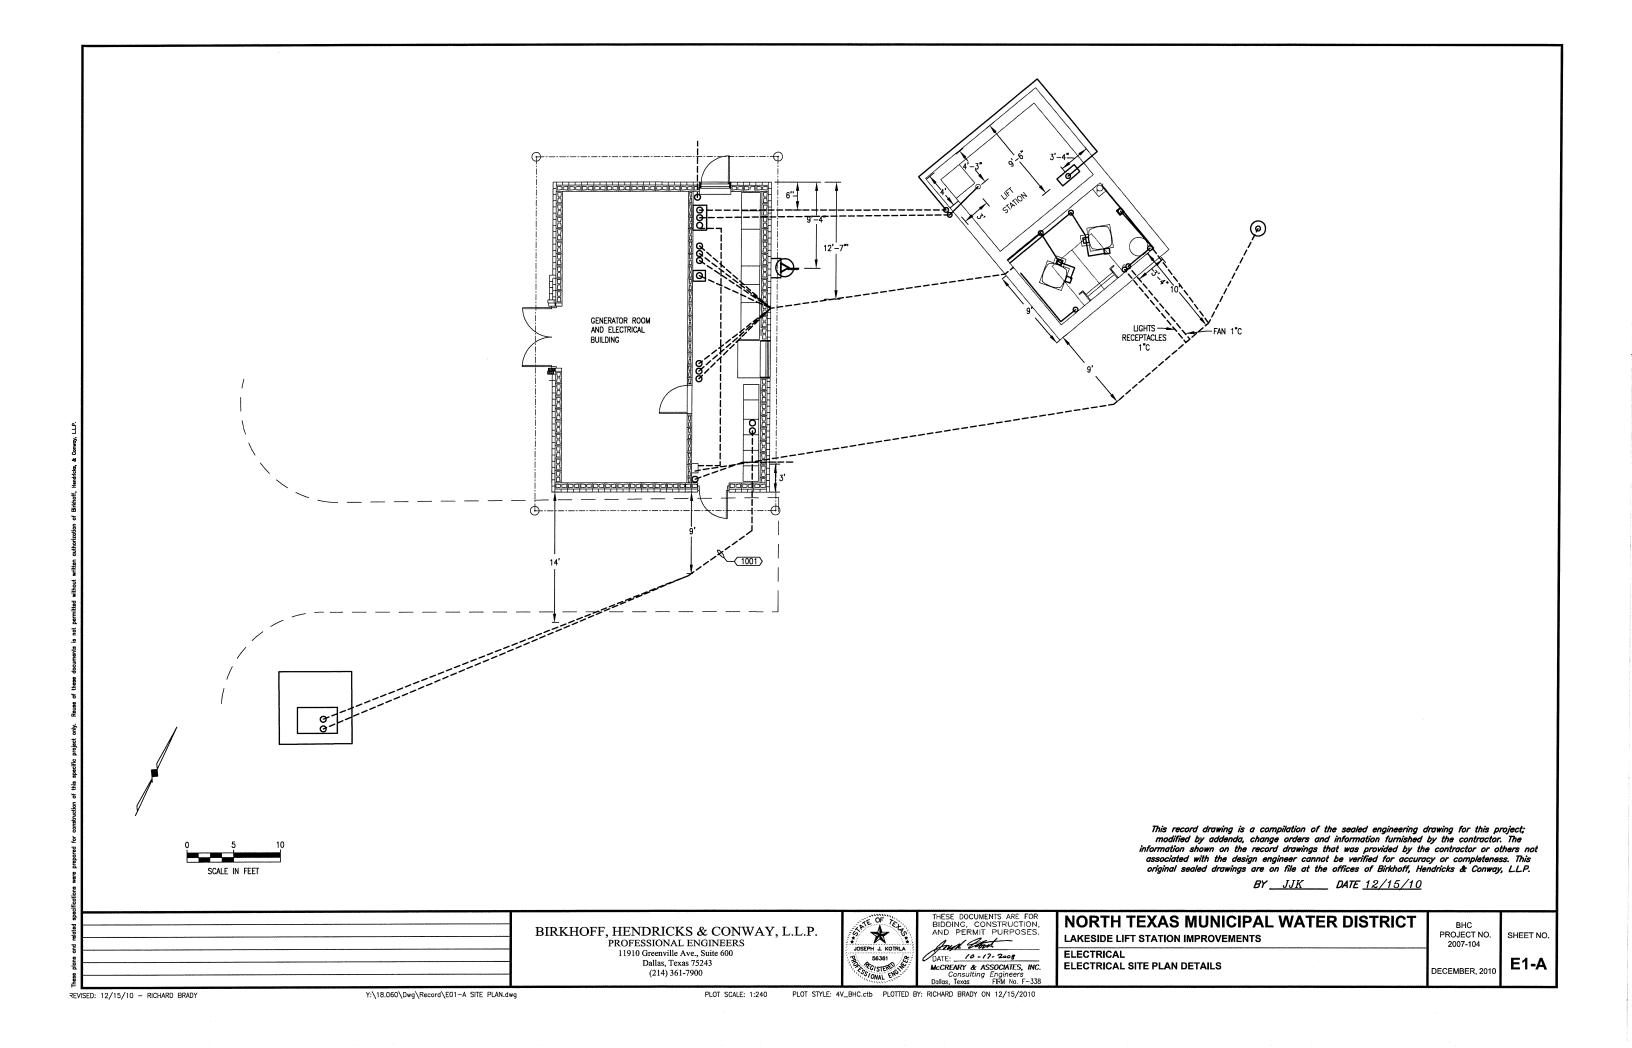

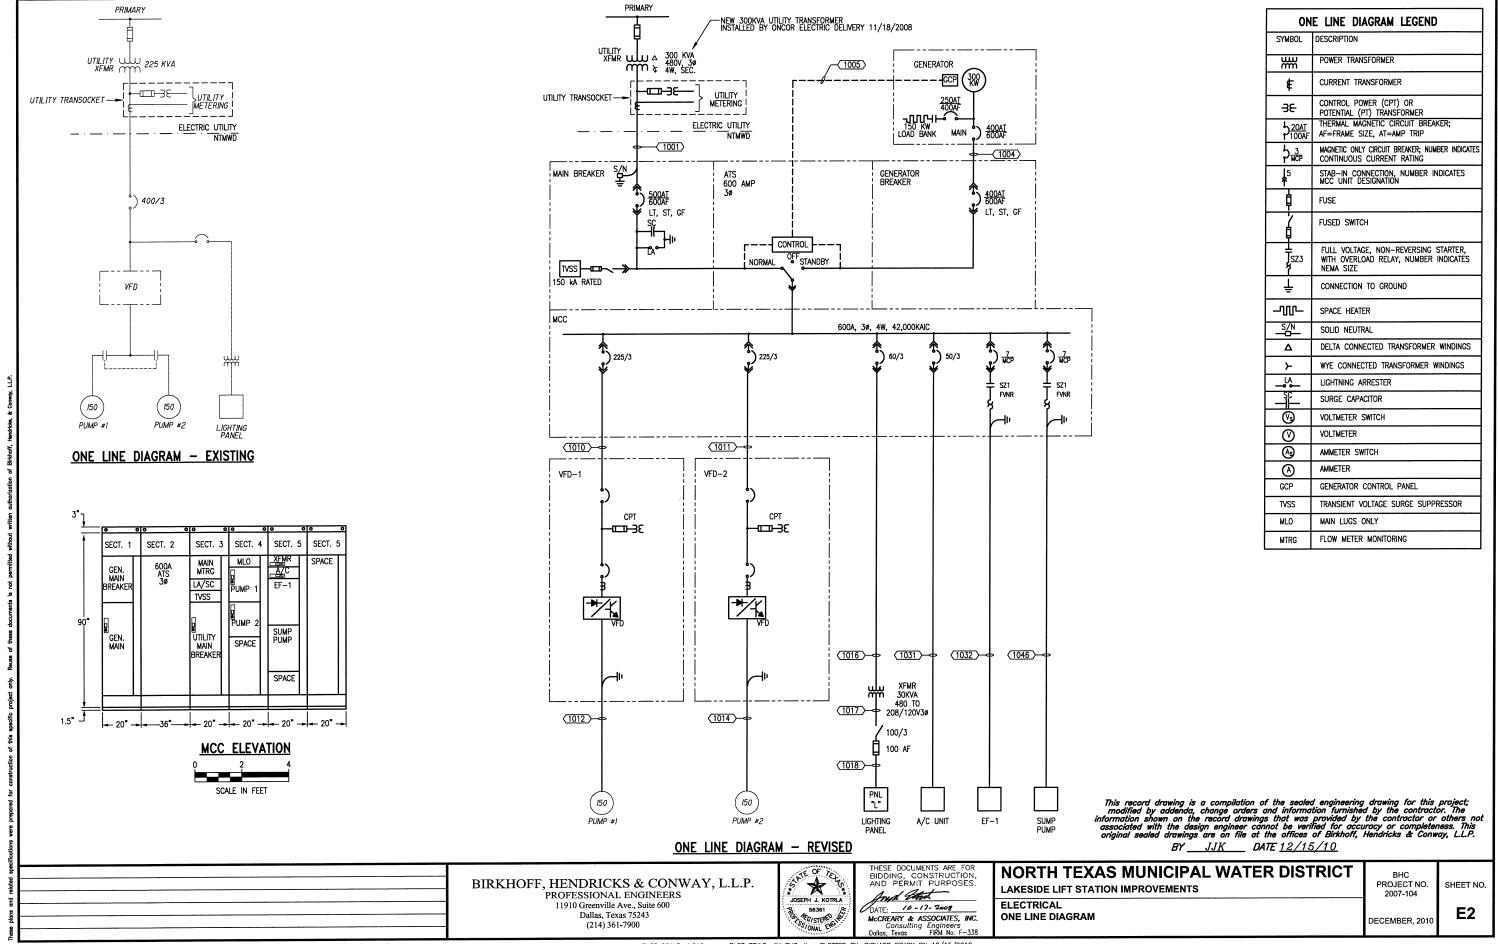


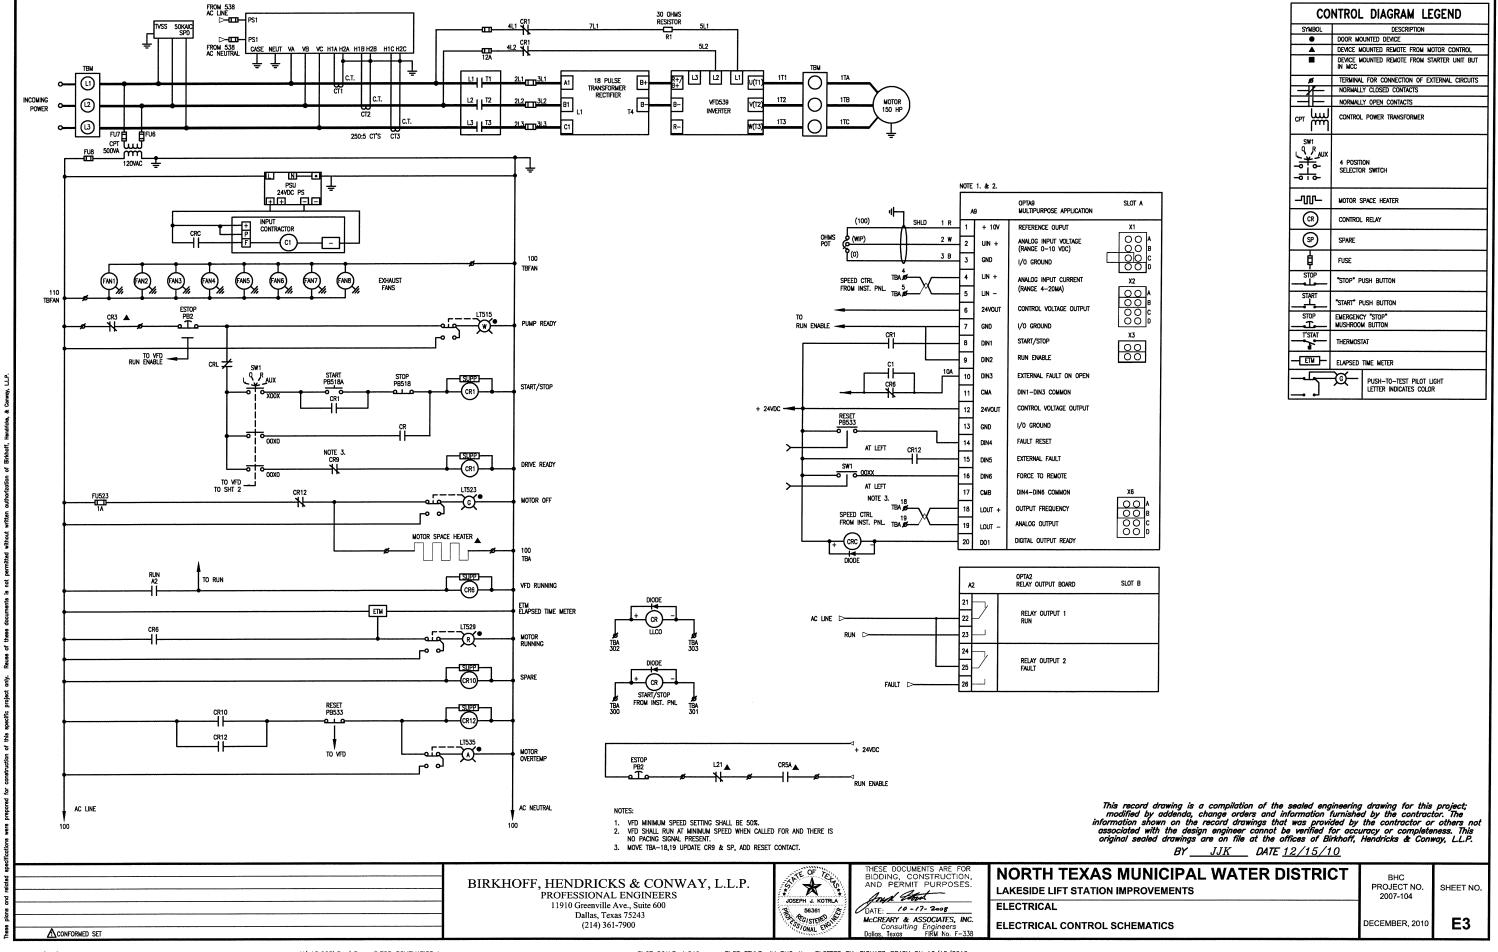

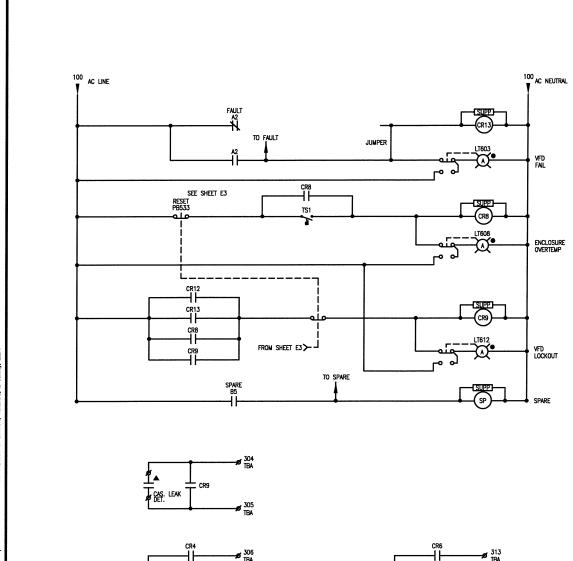

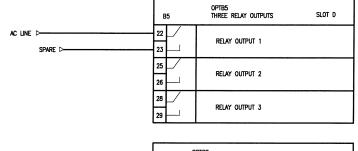

С	OPTC2 2 RS-485	COMMUNICATION W/ TERM BLK SLOT E
1	NC	NO CONNECTION
2	V P	+5V SUPPLY
3	RXD/TXD -N	REC/XMIT DATA - MINUS (A)
4	RXD/TXD -P	REC/XMIT DATA - PLUS (B)
5	DGND	DATA GROUND (VP REF)

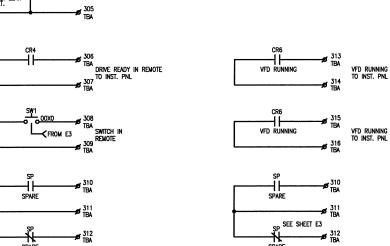

This record drawing is a compilation of the sealed engineering drawing for this project; modified by addenda, change orders and information furnished by the contractor. The information shown on the record drawings that was provided by the contractor or others not associated with the design engineer cannot be verified for accuracy or completeness. This original sealed drawings are on file at the offices of Birkhoff, Hendricks & Conway, L.L.P. BY JJK DATE 12/15/10

SHEET NO.

E4

JOSEPH J. KOTRLA

THESE DOCUMENTS ARE FOR BIDDING, CONSTRUCTION, AND PERMIT PURPOSES. Any State DATE: __ 10 -17- 2008 McCREARY & ASSOCIATES, INC. Consulting Engineers Dallas, Texas FIRM No. F-338

NORTH TEXAS MUNICIPAL WATER DISTRICT BHC PROJECT NO. LAKESIDE LIFT STATION IMPROVEMENTS 2007-104 ELECTRICAL DECEMBER, 2010 **ELECTRICAL CONTROL SCHEMATICS II**

BIRKHOFF, HENDRICKS & CONWAY, L.L.P.
PROFESSIONAL ENGINEERS
11910 Greenville Ave., Suite 600
Dallas, Texas 75243

(214) 361-7900

	CONDUIT AND CABLE SCHEDULE									
TAG	WIRING	CONDUIT		DESTINATION	COMMENTS					
1001	2 SETS: EACH: 3#350, #1G	2-3/5"	PAD MOUNTED TRANSFORMER	MAIN BREAKER						
	2 SETS; EACH: 3#350, #1G	2-31/5"	GENERATOR BREAKER	GENERATOR						
	12 #14 T/C	1"	ATS	GENERATOR						
	3#4/0, #2G T/C	2 1/2"	MCC	VFD#1	CABLE TRAY					
1011	3#4/0. #2G T/C	2 1/2"	MCC	VFD#2	CABLE TRAY					
1012	3#4/0, #2G, 12#14, #14G 1-1" E-STOP	2 1/2"	VFD#1	PUMP No.1						
1014	3#4/0, #2G, 12#14, #14G 1-1" E-STOP	2 1/2"	VFD#2	PUMP No.2						
1016	3#6, #6G	1"	MCC	LIGHTING TRANSFORMER						
	3#2, #2G	1 1/4"	LIGHTING TRANSFORMER	LIGHTING PANEL DISCONNECT						
	3#2, #2G	1 1/4"		LIGHTING PANEL						
1020	2#8, #8N, #8G	1*	LIGHTING PANEL	GENERATOR	JACKET HTR, BATT. CHGR					
	12C#14 T/C	1"	ATS	GENERATOR	GENERATOR CONTROLS					
	2C/S#16, 2#14	1"	GENERATOR A/V ALARM PNL	GENERATOR						
	2C/S#16	1"	INSTRUMENT PANEL	GENERATOR A/V ALARM PNL						
	2C/S#16, 12C#14 T/C	1 1/4"	GENERATOR CONTROL PANEL	INSTRUMENT PANEL						
1025	24#14, 19C#14 T/C	1 1/4"	MCC	INSTRUMENT PANEL						
	24#14, 19C#14 T/C		ATS	INSTRUMENT PANEL						
1027	PULL CORD	2"	ANTENNA POLE	INSTRUMENT PANEL						
	4-2C/S#16, 19C#14 T/C	1 1/2"	VFD#1	INSTRUMENT PANEL						
	4-2C/S#16, 19C#14 T/C	1 1/2"	VFD#2	INSTRUMENT PANEL						
	2C/S#16	3/4"	ELECTRIC ROOM TT	INSTRUMENT PANEL						
	3#8, #8G	1"	MCC	A/C UNIT						
	3C#12, #12G T/C	3/4"	MCC	EF-1						
	2-MANUFACTURER'S CABLE, 7#14	1 1/4"	WET WELL	LEVEL TRANSMITTERS	ULTRASONIC, SUBMERSIBLE, FLOATS					
	2-2C/S#16, 7#14	1 1/4"	LEVEL TRANSMITTERS	INSTRUMENT PANEL						
	2-MANUFACTURER'S CABLE, 6#14	2"	DOPPLER FLOW TRANSDUCERS		FLOW, HIGH WATER, INTRUSION, FAN FAIL					
	2C/S#16	3/4"	PUMP #1 FLOW TRANSMITTER	INSTRUMENT PANEL						
	2C/S#16	3/4"	PUMP #2 FLOW TRANSMITTER	INSTRUMENT PANEL						
	2#12, #12G	1"	LIGHTING PANEL	SITE LIGHT	LIQUITE DECERTACIES					
	8#12, #12G	1"	LIGHTING PANEL	DRY PIT	LIGHTS, RECEPTACLES SUMP PUMP					
	3#12, #12G	1"	MCC	DRY PIT						
	3#12, #12G	1"	LIGHTING PANEL	DRY PIT	FAN CUMP PUMP FLOATS					
1048	4#14, #14G	1"	MCC	DRY PIT	SUMP PUMP FLOATS					

LIFT STATION RTU 1/0									
TAG DESCRIPTION	I/O TYPE	FUNCTION	FIELD DEVICE	RANGE	COMMENTS				
WET WELL LEVEL	A/I	LEVEL			ULTRASONIC TRANSMITTER				
WET WELL HIGH LEVEL	D/I	ALARM							
WET WELL LLCO	D/I	ALARM							
PUMP No.1	D/I	STATUS	VFD#1		ON/OFF				
PUMP No.1	A/0	CONTROL	VFD#1		SPEED CONTROL				
PUMP No.1	A/I	STATUS	VFD#1		SPEED REFERENCE				
PUMP No.1 HOA IN AUTO	D/I	STATUS							
PUMP No.2	D/I	STATUS	VFD#2		ON/OFF				
PUMP No.2	A/0	CONTROL	VFD#2		SPEED CONTROL				
PUMP No.2	A/I	STATUS	VFD#2		SPEED REFERENCE				
PUMP No.2 HOA IN AUTO	D/I	STATUS							
ATS NORMAL	D/I	STATUS							
ATS EMERGENCY	D/I	ALARM							
GENERATOR ON	D/I	STATUS							
GENERATOR FUEL LEVEL	A/I	LEVEL			FUEL LEVEL				
GENERATOR ALARM	D/I	ALARM							
GREEN LIGHT	D/0	STATUS			NO ALARMS				
SURGE PROTECTION FAILURE	D/I	ALARM			TVSS - MAIN				
SURGE PROTECTION FAILURE	D/I	ALARM			TVSS - LIGHTING PANEL				
EFFLUENT FLOWMETER PUMP 1	A/I	FLOW							
EFFLUENT FLOWMETER PUMP 1	D/I	FLOW			TOTAL FLOW				
EFFLUENT FLOWMETER PUMP 2	A/I	FLOW							
EFFLUENT FLOWMETER PUMP 2	D/I	FLOW			TOTAL FLOW				
AC UNIT	D/I	ALARM							
DRY WELL HIGH WATER	D/I	ALARM							
DRY WELL FAN FAIL	D/I	ALARM							
INTRUSION ALARM	D/I	ALARM			LIFT STATION, WIRE IN SERIES				
INTRUSION ALARM	D/I	ALARM			DRY WELL HATCH				
UPS ALARM	D/I	ALARM							
ELECTRICAL ROOM HIGH TEMP	A/I	ALARM	π						
POWER FAILURE	D/I	ALARM			PHASE FAILURE/ UNDERVOLT				

PANEL SCHEDULE

NUMBER: PRL 1A
LOCATION: ELECTRICAL ROOM
NEUTRAL AMPS: 100
NEUTRAL VOLTS: 120

VOLTS: 208Y/120V 3Ø 4WIRE SIZE: 100A (PANEL AMPS) MAIN LUGS ONLY

	LOAD	CKT	CKT	CKT	CKT	LOAD	
CIRCUIT DESCRIPTION	WATTS	BKR	#	#	BKR	WATTS	CIRCUIT DESCRIPTION
LIFT STATION ELECTRIC ROOM LIGHTING		20/1	1	2			TRANSIENT VOLTAGE
INTERIOR RECEPTACLES	1080	20/1	3	4	15/3		SURGE SUPPRESSOR (TVSS)
SPARE		20/1	5	6			30KGE 3011 KE330K (1433)
MCC HEATER		20/1	7	8	20/1		GENERATOR ROOM LIGHTS
GENERATOR JACKET, HEATER AND	9 KW	50/2	9	10	20/1		SPARE
BATTERY CHARGER	3 11	30/2	11	12	20/1		DRY PIT LIGHTS AND RECEPTACLES
DRY PIT EXHAUST FAN	240	20/1	13	14	20/1		IRRIGATION CONTROL FOR LAWN SPRINKLERS
EMERGENCY LIGHTS		20/1	15	16	20/1		SPARE
FLOW METERS AND LEVEL XMTR		20/1	17	18	20/1		SPARE
SPARES		20/1	19	20	20/1		INSTRUMENT PANEL
3FAILE3		20/1	21	1 20	20/1		INSTROMENT PANCE
AREA LIGHT		15/1	23	22&24	20/1		SPARE
AREA LIGHT		15/1	25	26			SPACE
SPARE		20/2	27&29	28&30			SPACE (NOTE 3.)

NOTES:

- 1. SQUARE D NOOD OR EQUAL PROVIDE INTEGRAL TVSS UNIT WITH 120KA SURGE RATING, SURGE COUNTER, AND ALARM CONTACTS NEUTRAL GROUND
- 2. EATON CUTLER HAMMER CLIPPER VL INSTALLED 120KA SURGE AMP RATING
- SPACES ARE IN THE LIGHTING PANEL FOR SLOTS 31 THROUGH 42 REFERENCE SHEET E-6 FOR LOCATION.

LIGHT FIXTURE SCHEDULE										
MARK	DESCRIPTION	LAMPS	VOLTS	MFGR	CATALOG NUMBER	COMMENTS				
Α	ENCLOSED FLUORESCENT	32 W T8	120	HOLOPHANE	HESSO4XBBBN042YPIU	PROVIDE LAMPS				
В	DOORWAY LIGHT	70W HPS	120	GARDCO	111MT70HPS120BRPFPCB	FULL CUTOFF, PROVIDE PHOTOCELL				
Ε	EMGCY LT, SEALED BATTERY	50W TUN	120	HOLOPHANE	DM6C50TNS2	PROVIDE LAMPS				

This record drawing is a compilation of the sealed engineering drawing for this project; modified by addenda, change orders and information furnished by the contractor. The information shown on the record drawings that was provided by the contractor or others not associated with the design engineer cannot be verified for accuracy or completeness. This original sealed drawings are on file at the offices of Birkhoff, Hendricks & Conway, L.L.P.

BY <u>JJK</u> DATE <u>12/15/10</u>

BIRKHOFF, HENDRICKS & CONWAY, L.L.P.

PROFESSIONAL ENGINEERS 11910 Greenville Ave., Suite 600 Dallas, Texas 75243 (214) 361-7900

PLOT SCALE: 1:96



NORTH TEXAS MUNICIPAL WATER DISTRICT
LAKESIDE LIFT STATION IMPROVEMENTS

ELECTRICAL
SCHEDULES


BHC
PROJECT NO.
2007-104


SHEET NO.


E5


Y:\18.060\Dwg\Record\E05 SCHEDULES.dwg

PLOT STYLE: 4V_BHC.ctb PLOTTED BY: RICHARD BRADY ON 12/15/2010

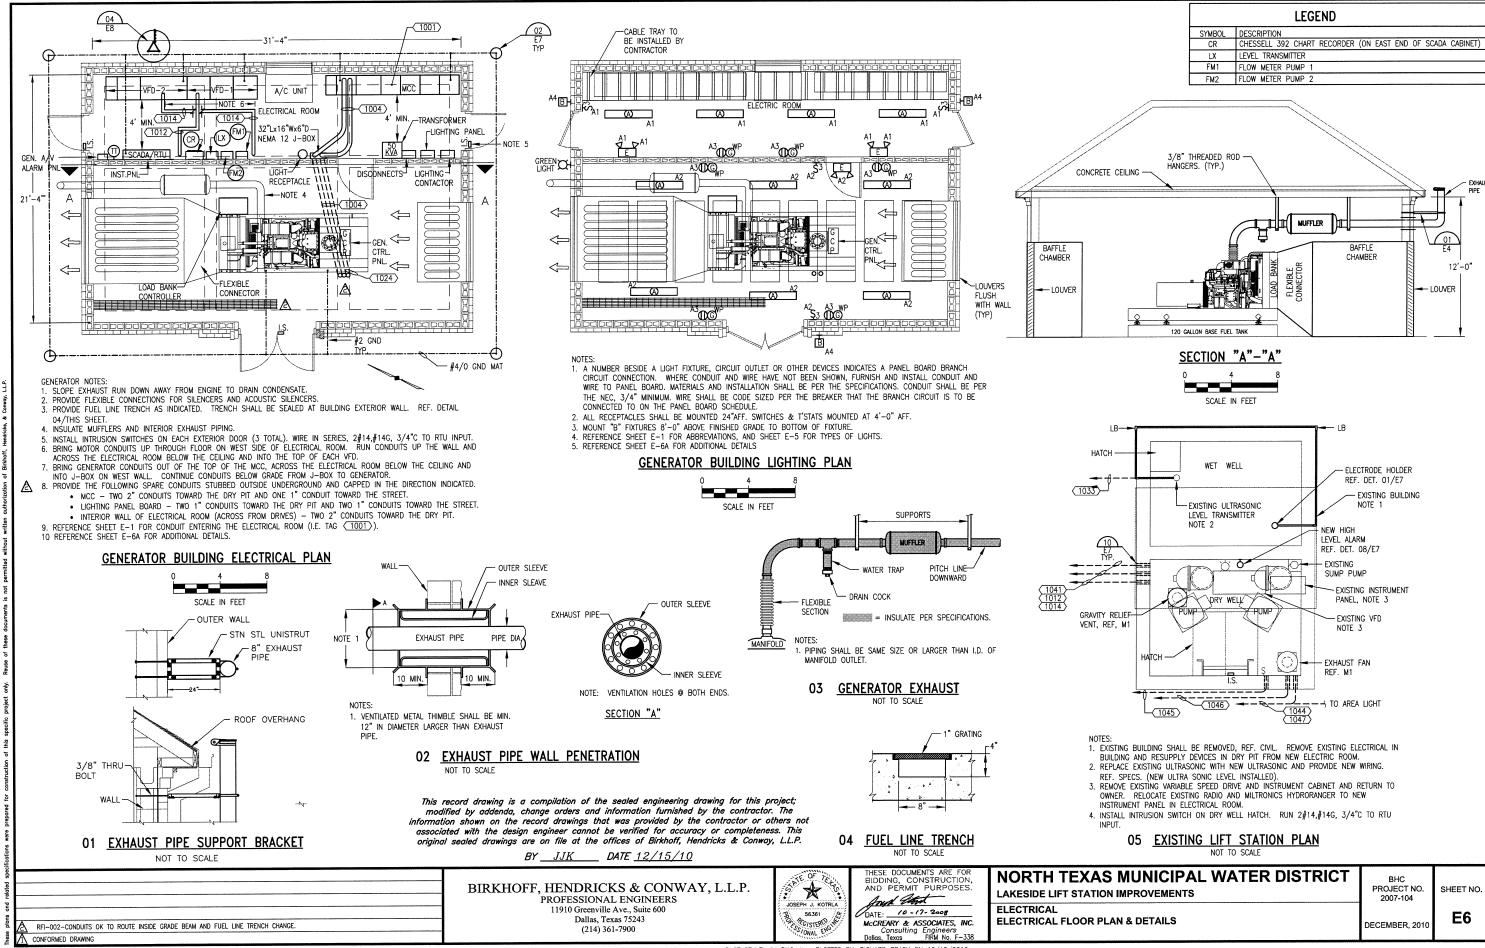

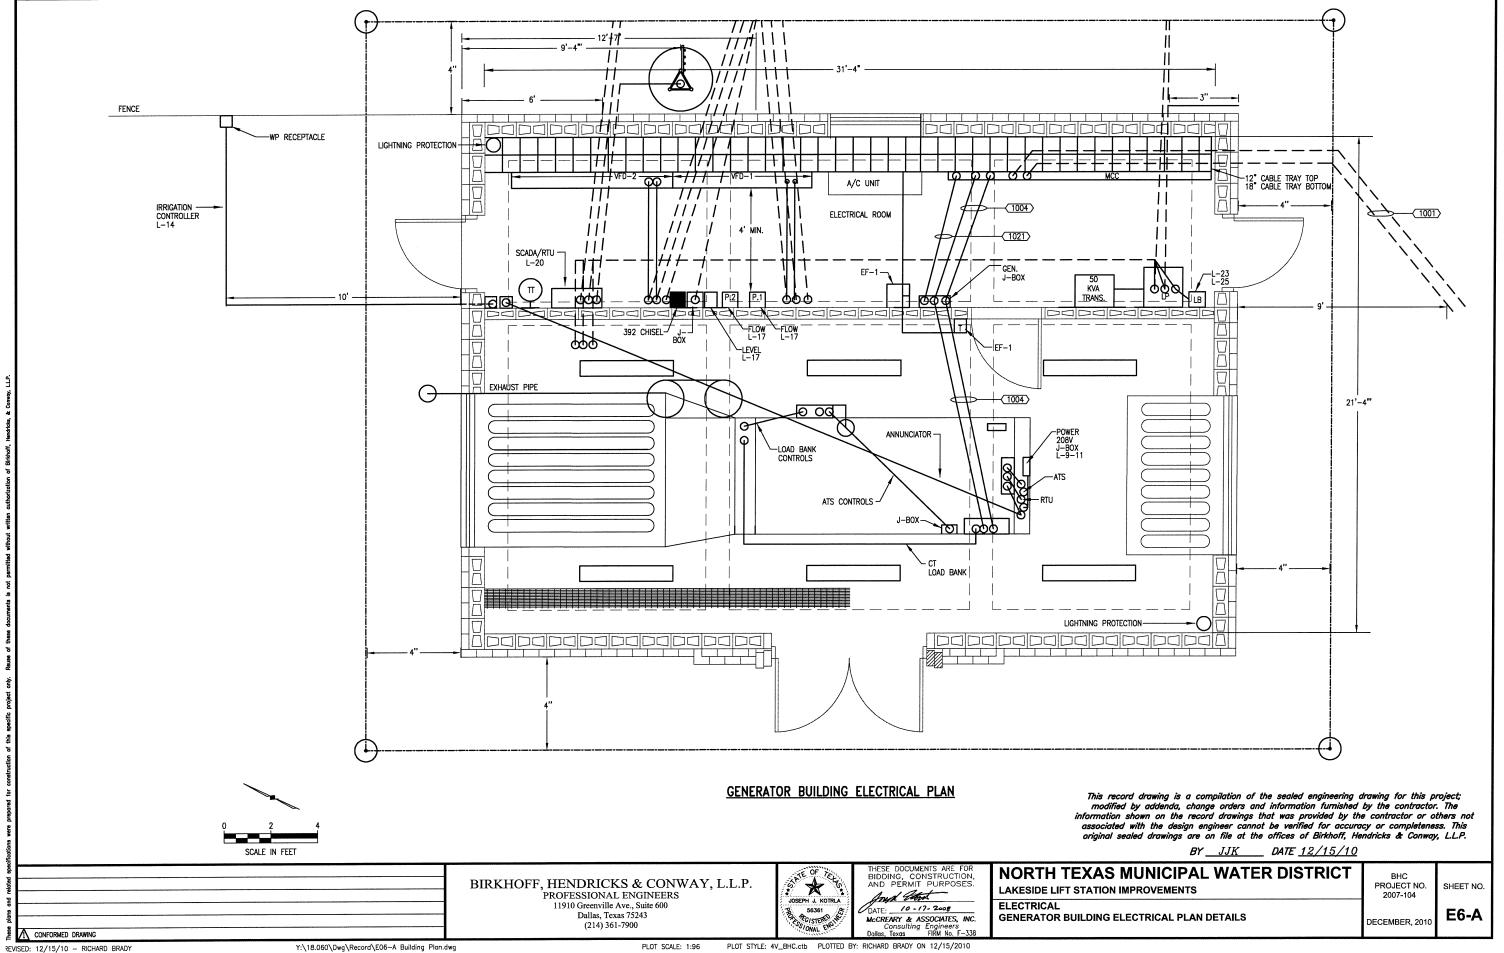

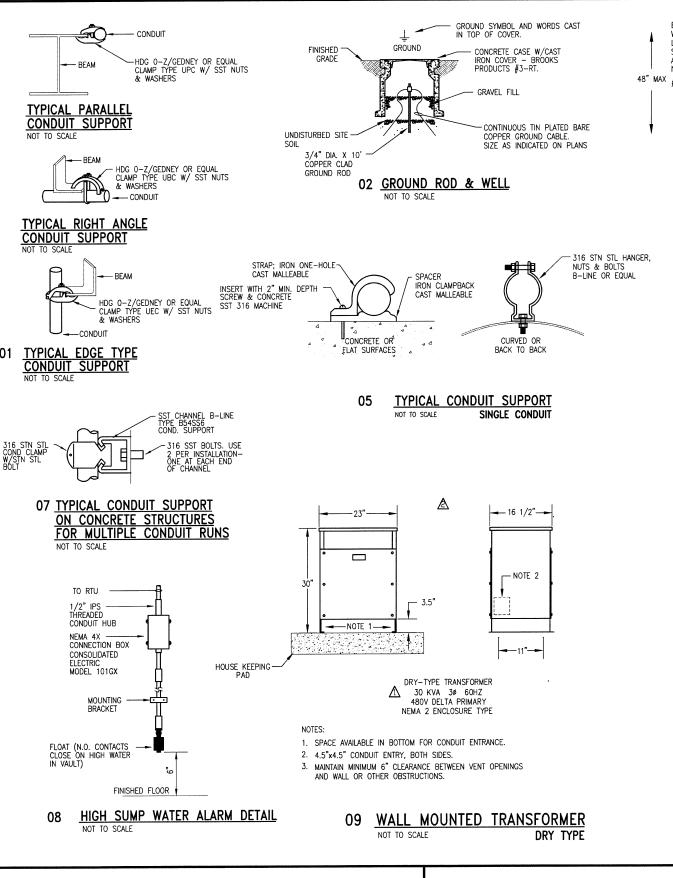


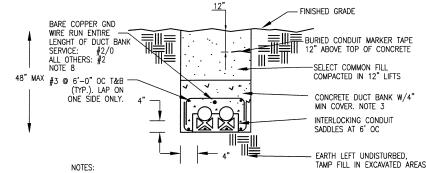

NUMBER AND SIZE OF CONDUITS SHALL BE AS SHOWN ON THE PLANS.


- 2. TOP OF CONCRETE ENCASEMENT SHALL BE A MINIMUM OF 18" BELOW GRADE. 3. SPRAY TOP OF CONCRETE WITH RED DYE AFTER POUR.
- 4. TYPICAL REINFORCEMENT SHALL BE #3 @ 6 IN. T & B
- 5. PROVIDE 6" SEPARATION BETWEEN 480 VOLT POWER CONDUITS AND ANALOG SIGNAL CONDUIT.
- 6. CONCRETE SHALL BE 3000 PSI @ 28 DAYS.
- 7. WHERE DUCTBANK CONTACTS AND EXISTING STRUCTURE, DOWEL 6 IN. INTO STRUCTURE W/ #3 REBAR.
- 8. CONNECT DUCT BANK GROUND WIRE TO GROUND MAT WHERE AVAILABLE AT END OF DUCT BANK. WHERE GROUND MAT IS NOT AVAILABLE, DRIVE A 3/4 IN. X 10'-0" COPPER CLAD STEEL GROUND ROD AND CONNECT DUCT BANK GROUND

03 <u>DETAIL - CONCRETE ENCASED UNDERGROUND</u> TO SCALE DUCTBANK

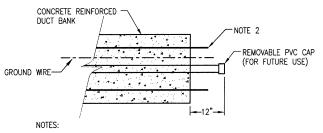

- TYPICAL FOR ALL CONDUITS STUBBED OUTSIDE OF BUILDING.
- 2. EXPOSED COATED REBAR FOR TIE-IN AND CONTINUANCE OF FUTURE DUCTBANK.

06 UNDERGROUND CONDUIT NO SCALE

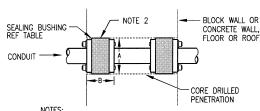

- 1. TYPICAL FOR NEW PENETRATIONS OF EXISTING WALLS, ROOFS & FLOORS.
- 2. CAULK ALL AROUND WITH SILICONE SEALANT PRIOR TO INSTALLING
- 3. REPAIR ALL DAMAGE DONE BY CORE DRILL.

CONDUIT	DRILLED HOLE DIA.		0-Z GEDNEY
NOM. I.D.	-A	"B"	CATALOG #
3/4"	2*	1 5/8"	CSMI-200P
1"	2 1/2"	1 5/8"	CSMI-250P
1 ¼"-1 ½"	3"	1 5/8"	CSMI-300P
2"	4"	1 7/8"	CSMI-400P
2 ½"-3"	5*	1 7/8"	CSMI-500P
3 ½"-4"	6"	1 7/8"	CSMI-600P


10 WATERTIGHT CONDUIT PENETRATION

THESE DOCUMENTS ARE FOR BIDDING, CONSTRUCTION, AND PERMIT PURPOSES. And Potent DATE: 10-17-2008 56361 McCREARY & ASSOCIATES, INC. Consulting Engineers
, Texas FIRM No. F-338


NORTH TEXAS MUNICIPAL WATER DISTRICT LAKESIDE LIFT STATION IMPROVEMENTS ELECTRICAL

BRONZE BOLTS & -CONNECTOR -INSULATED GND #2 AWG MIN. - PROVIDE BLOCKOUT IN POUR. SET "VG" FLOOR SLAB THEREIN. FILL WITH CONDUCTOR TO GND MAT. EXOW THERETO. -RF-INFORCING BAR

04 IN-SLAB GROUNDING CONNECTOR

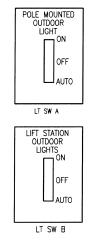

11 DETAIL-ENGRAVED SWITCH PLATES NOT TO SCALE

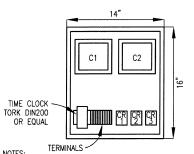

1. ENCLOSURE SHALL BE NEMA 12 WITH SUBPANEL. FURNISH AND INSTALL HOFFMAN OR EQUAL.

- 2. CONTACTORS C1 AND C2 SHALL BE ELECTRICALLY HELD AND RATED FOR 30A. REF SCHEMATIC ON SHEET E3.
 3. CONTROL RELAYS SHALL BE POTTER & BRUMFIELD TYPE
- 4 REE LIGHTING PLAN SHEET EG FOR LOCATION OF CONTROL PANEL
- 5. CR1 & CR2 ARE FOR LIGHTING CONTROL, CR3 IS A SPARE.

12 DETAIL-OUTDOOR LIGHTING CONTROL

This record drawing is a compilation of the sealed engineering drawing for this project; modified by addenda, change orders and information furnished by the contractor. The information shown on the record drawings that was provided by the contractor or others not associated with the design engineer cannot be verified for accuracy or completeness. This original sealed drawings are on file at the offices of Birkhoff, Hendricks & Conway, L.L.P.

BY JJK __ DATE <u>12/15/10</u> BHC PROJECT NO. SHEET NO. 2007-104 **E7** DETAILS DECEMBER, 2010

BIRKHOFF, HENDRICKS & CONWAY, L.L.P.


PROFESSIONAL ENGINEERS

11910 Greenville Ave., Suite 600

Dallas, Texas 75243


(214) 361-7900

↑ PER SHEET E-2 AND APPROVED SUBMITTAL

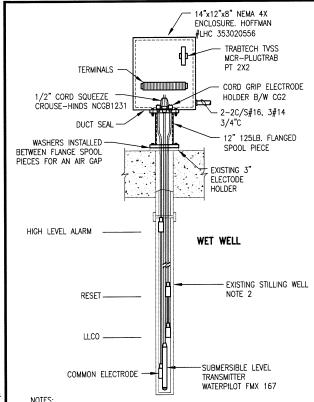


- 1. REMOVE EXISTING ELECTRODE HOLDER AND REPLACE WITH SPOOL PIECE AS INDICATED.
- 2. REMOVE EXISTING ELECTRODES AND WIRING FROM EXISTING STILLING WELL AS REQUIRED. REMOVE ALL DEBRIS AND BUILDUP FROM EXISTING STILLING

01 DETAIL - WET WELL LEVEL INSTRUMENTATION NOT TO SCALE

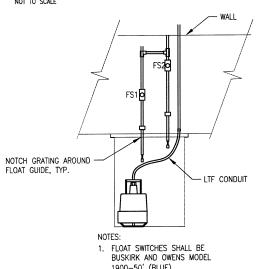


This record drawing is a compilation of the sealed engineering drawing for this project; modified by addenda, change orders and information furnished by the contractor. The nformation shown on the record drawings that was provided by the contractor or others not associated with the design engineer cannot be verified for accuracy or completeness. This original sealed drawings are on file at the offices of Birkhoff, Hendricks & Conway, L.L.P. BY <u>JJK</u> DATE <u>12/15/10</u>

02 DETAIL - SUMP PUMP

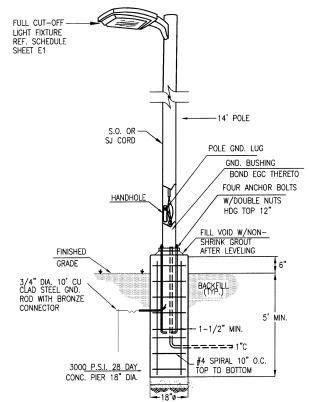


- 1. POLE SHALL BE 5" SQUARE STRAIGHT ALUMINUM. POLE SHALL BE RATED @ 100 MPH + 30% GUST FACTOR. PROVIDE GARDCO #SSA5-CB-14 OR APPROVED EQUAL.
- THE POLE AND FIXTURE INSTALLATIONS SHALL UTILIZE THE SPECIFIED PRODUCTS.
 SHOULD A CONTRACTOR DESIRE TO SUBSTITUTE AND ALTERNATE LIGHT FIXTURE AND/ OR
 POLE FOR THAT SPECIFIED, PRE-APPROVAL MUST BE GRANTED BY THE CITY AND THE THIS DECISION TO ALLOW AN ALTERNATE WILL BE FORWARDED TO ALL PLAN HOLDERS BY ADDENDUM.
- 3. ALL PROPOSED CONDUITS SHALL BE A MINIMUM OF 24 INCHES BELOW GRADE.

03 LIGHTING FIXTURE AND POLE INSTALLATION NOT TO SCALE

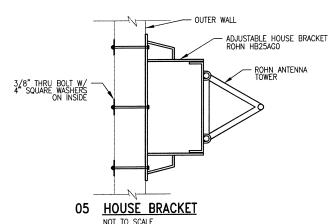

DESCRIPTION MANUFACTURER CATALOG NUMBER A-604810 1 NEMA 12 ENCLOSUR HOFFMAN SUBPANEL A-60P48 HOFFMAN 4 RTU & L SCADAPACK 6 WIRE DUCT WIRE DUCT PANDUIT
ANT. SURGE PROTECTOR POLYPHASER 8 AC TERMINALS 9 24 VDC I/O TERMINALS 9 24 VDC 1/O TERMINALS
10 24 VDC POWER SUPPLIES PHOENIX
11 24 VDC 1/O FUSED TERMINALS
12 SIGNAL ISOLATOR/CONVERTER PHOENIX
13 LEVEL SWITCH RELAYS DEC

NOTES:
1. REF: SHEET E-5 FOR MARKERS AND SEE INSTRUMENTATION O&M.

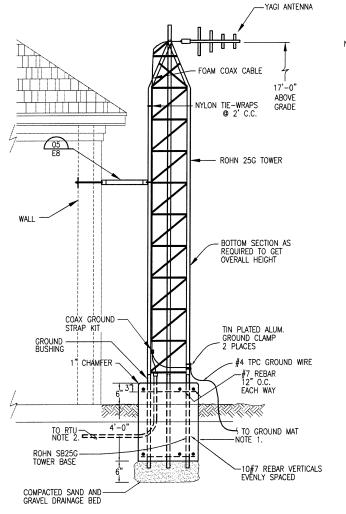

CGB FITTING DOPPLER-TRANSDUCERS 2#12, 3/4°C TO E-STOP REF PLAN, 2" LIQUID TIGHT -FLEX (LTF) REPLACE EXISTING MOTOR POWER CONDUITS AND MOTOR SPACE HEATER

CONDUITS WITH NEW CONDUITS AS SCHEDULED.

. PROVIDE 3/4" LTF FROM MOTOR JUNCTION BOX TO MOTOR SPACE HEATERS. MOUNT EACH E-STOP NEAR LADDER FOR EACH PUMP. EACH E-STOP SHALL HAVE SEALED CONTACT BLOCKS, PILOT DUTY RATED, MAINTAINED CONTACT WITH MUSHROOM HEAD AND LOCKOUT. FURNISH CROUSE-HINDS #EFD-S769.

DRY PIT ELEVATION

850 VA UPS

04 ANTENNA DETAIL NOT TO SCALE

2. REF: THIS SHEET, DETAIL 6
3. REF: SHEET E-1 FOR LOCATION

CONSTRUCTRED AS SHOWN AS A MINIMUM.

1. ANTENNA BASE SHALL BE CLASS A 3000 PSI, 30"ø. CONCRETE AND

	01
COMMENTS 0"x48"x10" 6"x44" XISTING USED	AUTO
"X2"	

NOTE 1

HMI 5120 COLOR LCD TOUCH SCREEN

PANFI-DIALER-(12) 2"C FROM ANTENNA-TOWER DOORS CLOSED 1. INSTRUMENTATION WORKS WITH MAPLE SYSTEM

-LEVEL INDICATOR

1. REF: O&M MANUAL ON INSTRUMENTATION FOR FURTHER DETAIL

06 INSTRUMENT PANEL - LIFT STATION

BIRKHOFF, HENDRICKS & CONWAY, L.L.P.

PROFESSIONAL ENGINEERS 11910 Greenville Ave., Suite 600 Dallas, Texas 75243



BIDDING, CONSTRUCTION AND PERMIT PURPOSES Any Potent DATE: 10-17-2008 McCREARY & ASSOCIATES, INC.

NORTH TEXAS MUNICIPAL WATER DISTRICT LAKESIDE LIFT STATION IMPROVEMENTS ELECTRICAL **DETAILS II**

RHC PROJECT NO. SHEET NO **E8** DECEMBER, 2010

TO WET WELL LLCO (1033)

TO FLOWMETER

TO ULTRASONIC

Y:\18.060\Dwg\Record\E08 DETAILS II.dwg

PLOT STYLE: 4V_BHC.ctb PLOTTED BY: RICHARD BRADY ON 12/15/2010

