CONSTRUCTION PLANS FOR

INDUSTRIAL BOULEVARD FROM RAILROAD TO AIRPORT ROAD

CITY OF ROCKWALL

JUNE 2006

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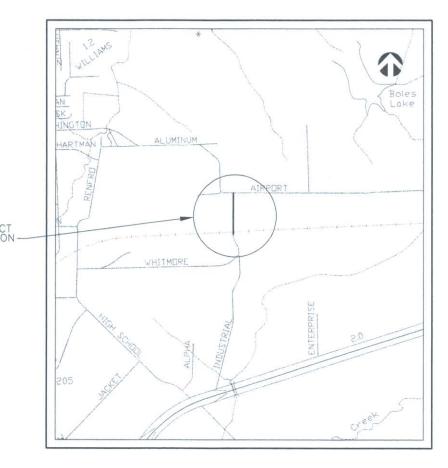
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18383 PRESTON ROAD ~ SUITE 500 DALLAS, TEXAS 75252 PH. (972) 818~7275 FAX (972) 380~2609



BERNARD D. HIETBRINK, P.E., SR. PROJECT MANAGER



LOCATION MAP

CITY OFFICIALS

MAYOR Bill Cecil

COUNCIL
Bob Cotti
Stephen Straughan
Tim McCallum
John King
Matt Scott
Margo Nielsen


CITY MANAGER Julie Couch

DIRECTOR OF PUBLIC WORKS Chuck Todd, P.E.

APPROVED FOR CONSTRUCTION

SEP 1 4 2006

City of Rockwall Engineering Dept.

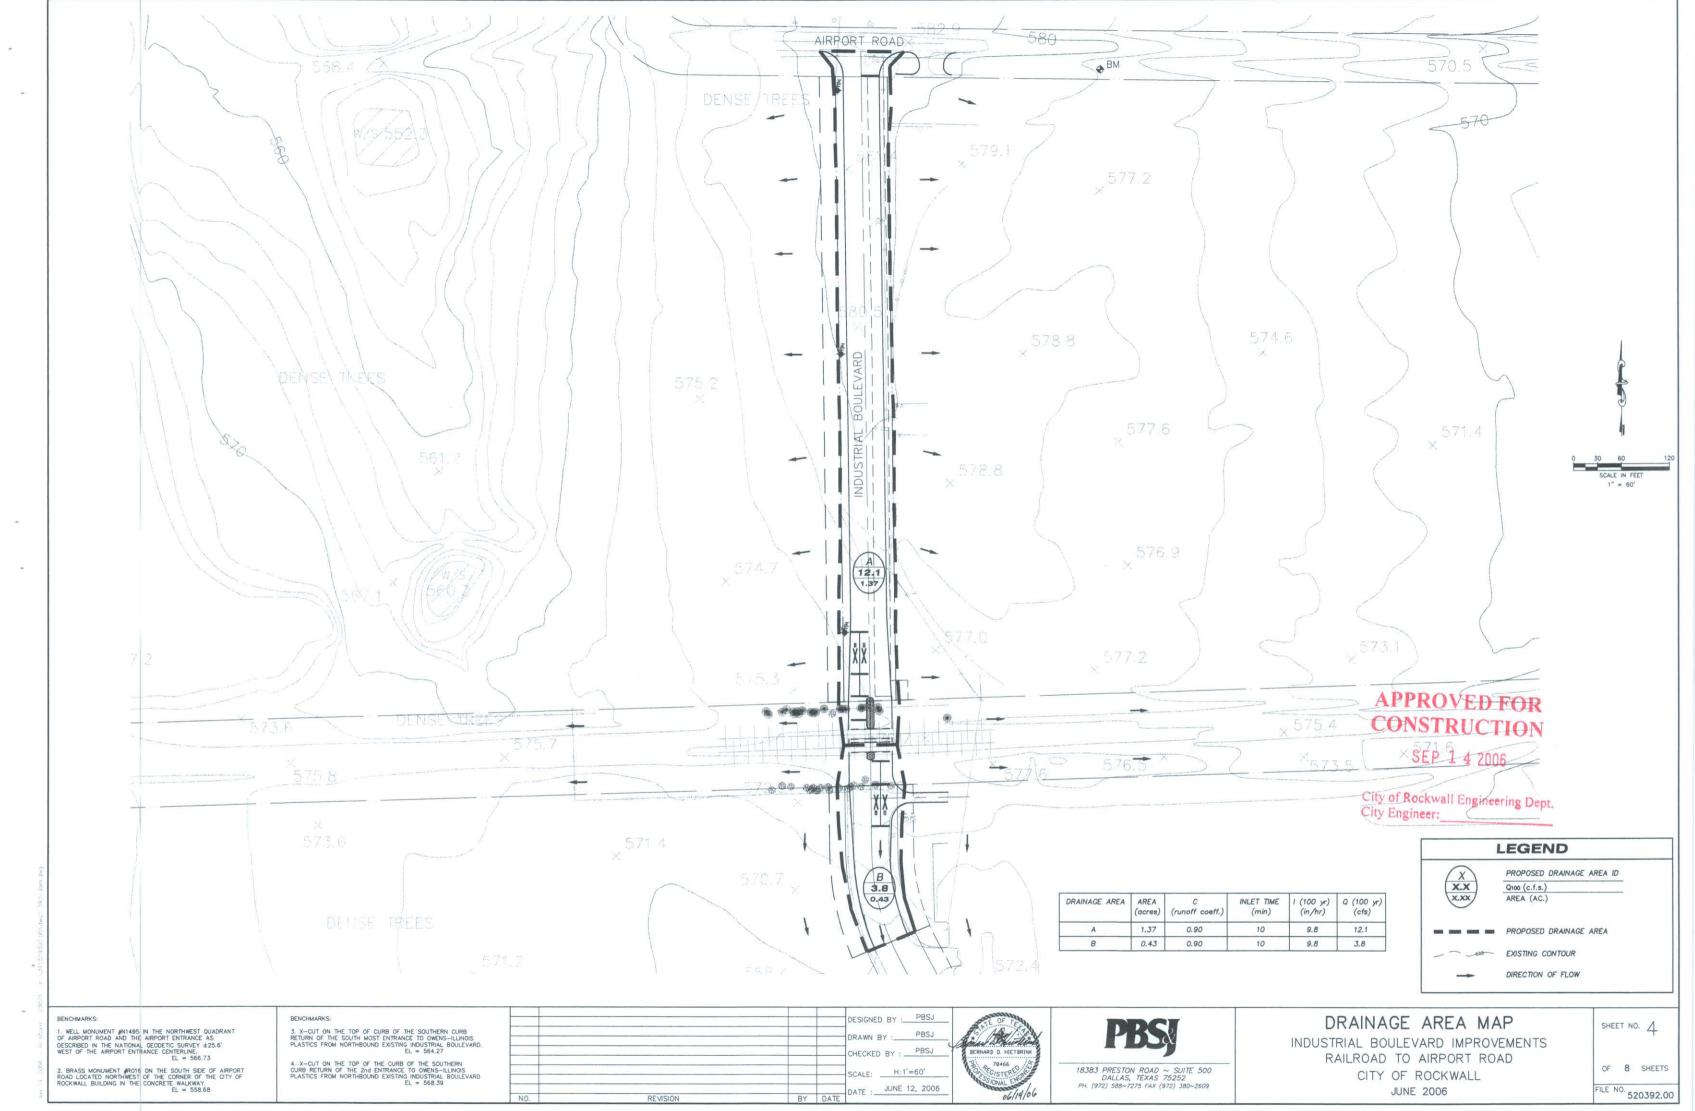


| SUPERELEVATION DATA | |
|---------------------|--|
| STATION -2+00.00 | MATCH EXISTING 6" NORMAL CROWN |
| STATION -1+07.45 | END 6" NORMAL CROWN AND BEGIN TRANSITION |
| STATION 0+27.55 | END TRANSITION AND BEGIN FULL SUPERELEVATION (0.30%) |
| STATION 0+83.35 | END FULL SUPERELEVATION (0.30%) AND BEGIN TRANSITION |
| STATION 2+18.35 | END TRANSITION AND BEGIN 6" NORMAL CROWN |
| STATION 9+18.43 | END 6" NORMAL CROWN AND MATCH EXISTING |

NORTH TEXAS MUNICIPAL WATER DISTRICT NOTES

- 1. North Texas Municipal Water District (NTMWD) 30-inch waterline is located within limits of construction
- 2. Operation of heavy earthmoving equipment, compaction equipment or heavy construction equipment, such as concrete trucks, shall be restricted to specific crossing points across NTMWD easements, as approved by the NTMWD. The crossings shall be designated and verified to provide a minimum of five-feet of cover.
- 3. To assure that placing of significant loads over the NTMWD pipeline does not damage the existing pipeline, no materials shall be stockpiled on the NTMWD easement, without authorization from the NTMWD. If the contractor desires to use NTMWD easement for stockpile of materials, contact NTMWD Engineering at (972) 442-5405 so your plans for use of the NTMWD easement can be reviewed.
- Unless otherwise shown or required a minimum of one—foot clearance shall be provided for all utilities crossing the NTMWD pipelines.
- "The contractor shall contact NTMWD Engineering at (972) 442-5405 at least 48 hours prior to performing any work in the vicinity of the NTMWD facilities."


PAVING GENERAL NOTES

- Unless otherwise noted, all material and construction shall conform to applicable specifications
 of the City of Rockwall with amendments The North Central Texas Council of Governments
 "Standard Specifications for Public Works Construction", Parts II and III, latest edition. Refer to
 applicable City of Rockwall "Standard Construction Details", latest edition (Rev. August, 2003).
- 3. Pavement reinforcing will be grade 60.
- 4. For details of paving joints see Rockwall's "Standard Construction Details", Sheet SD-3.
- Construct a barrier—free curb and ramp at all street intersections. See Rockwall's "Standard Construction Details", Sheet SD-P33.
- 7. Contractor will be responsible for field verifying the location of all existing utilities prior to his operations.
- Installation, maintenance and removal of traffic safety devices for all construction in or contiguous to existing pavement, will be at the expense of the contractor and will follow as a guide "The Manual of Uniform Traffic Control Devices", latest edition.
- 9. Unless shown otherwise, all street pavement on this project will be 8"-4200 psi on 6"-6% lime min. and having a minimum compressive strength of 4200 psi at 28 days (6.5 sacks min. of cement/CY). Refer to City of Rockwall Standard Details Sheets SD-P01 through 19 for additional reference. All street pavement will be constructed on a 6" lime stabilized subbase with lime applied at a minimum rate as directed in the geotchnical report, but not less than 32#/SY and Compacted to a density not less than 95 percent, laboratory tests must be submitted to the engineering department for approval to determine amount of lime required. Laboratory test may be waived provided at least 36 lbs. of lime per sq yd. is used. SEE ITEM 4.6,4 SPECIAL PROVISIONS
- 10. Upon completion of utility work and prior to lime stabilization operations, the engineer will verify areas that can suitably be stabilized and other areas which, in his opinion, may require additional removal of weathered shale. Remove the weathered shale at the direction of the engineer as follows:
 - To a point 1 foot behind the back of curb.
 To a point 6" below the bottom of the proposed pavement.
- 11. Replace this excavated shale with an approved onsite material and continue lime stabilization.
- 12. Bar chairs or an approved device shall be furnished.
- 13. Bar laps shall be thirty diameters.
- 14. Utility adjustments will not be paid for separately and associated costs shall be considered subsidiary to construction.
- 15. All fill shall be compacted using a sheep's footer roller.

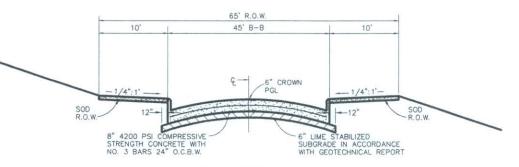


TYPICAL STREET SECTION


- * STATION -2+00.00 TO STATION -0+98.44
- * STATION 2+09.35 TO STATION 9+18.43

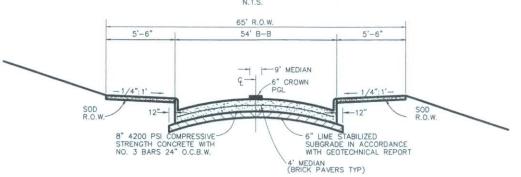


TYPICAL STREET SECTION

- * STATION 0+01.56 TO STATION 1+09.35
- 40:1 PAVEMENT TRANSITION FROM STATION -0+98.44 TO STATION 0+01.56 AND STATION 1+09.35 TO STATION 2+09.35

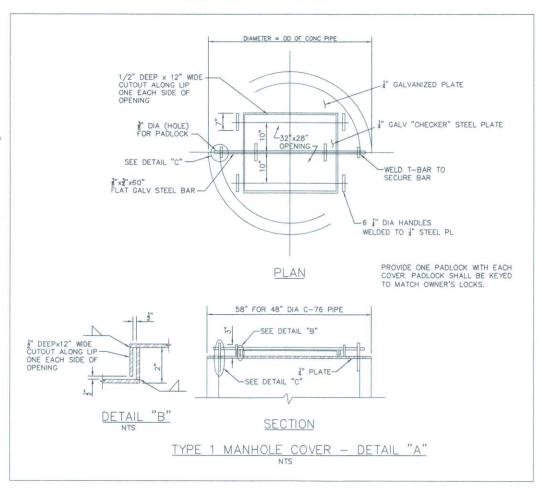


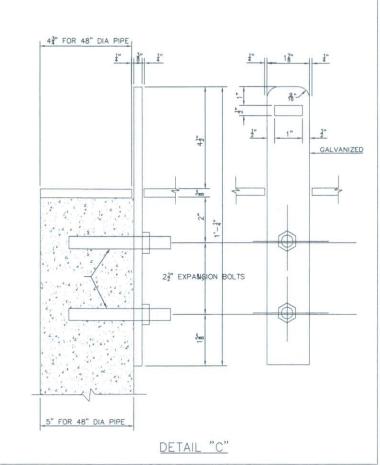

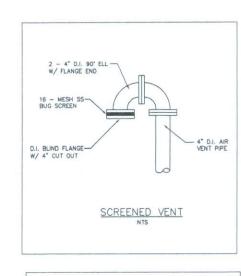

4" DUCTILE IRON AIR VENT PIPE

SCREENED VENT (SEE DETAIL)

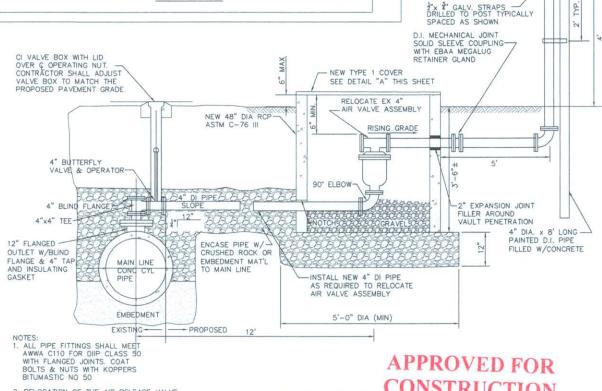

RELOCATION OF THE AIR RELEASE VALVE AND VAULT WILL REQUIRE CLOSING OF THE EXISTING BUTTERFLY VALVE, WHICH WILL

3. THE CLOSING OF THE BUTTERFLY VALVE WILL BE CONDUCTED BY NTMWD OPERATIONS PERSONNEL ONLY. SCHEDULING AND COORDINATION OF THIS WORK BY THE CONTRACTOR WITH THE NTMWD WILL REQUIRE A MINIMUM OF ONE WEEK NOTICE IN

OFFSET INSTALLATION SEP 1 4 2006

City of Rockwall Engineering Dept. City Engineer:__

CONTROL POINTS:

BENCHMARKS

DESIGNED BY : PBSJ PBSJ CHECKED BY : __PBSJ SCALE: NTS DATE : __ JUNE 12, 2006







GENERAL NOTES AND TYPICAL SECTIONS | SHEET NO. 2


INDUSTRIAL BOULEVARD IMPROVEMENTS RAILROAD TO AIRPORT ROAD CITY OF ROCKWALL JUNE 2006


OF 8 SHEETS

FILE NO. 520392.00

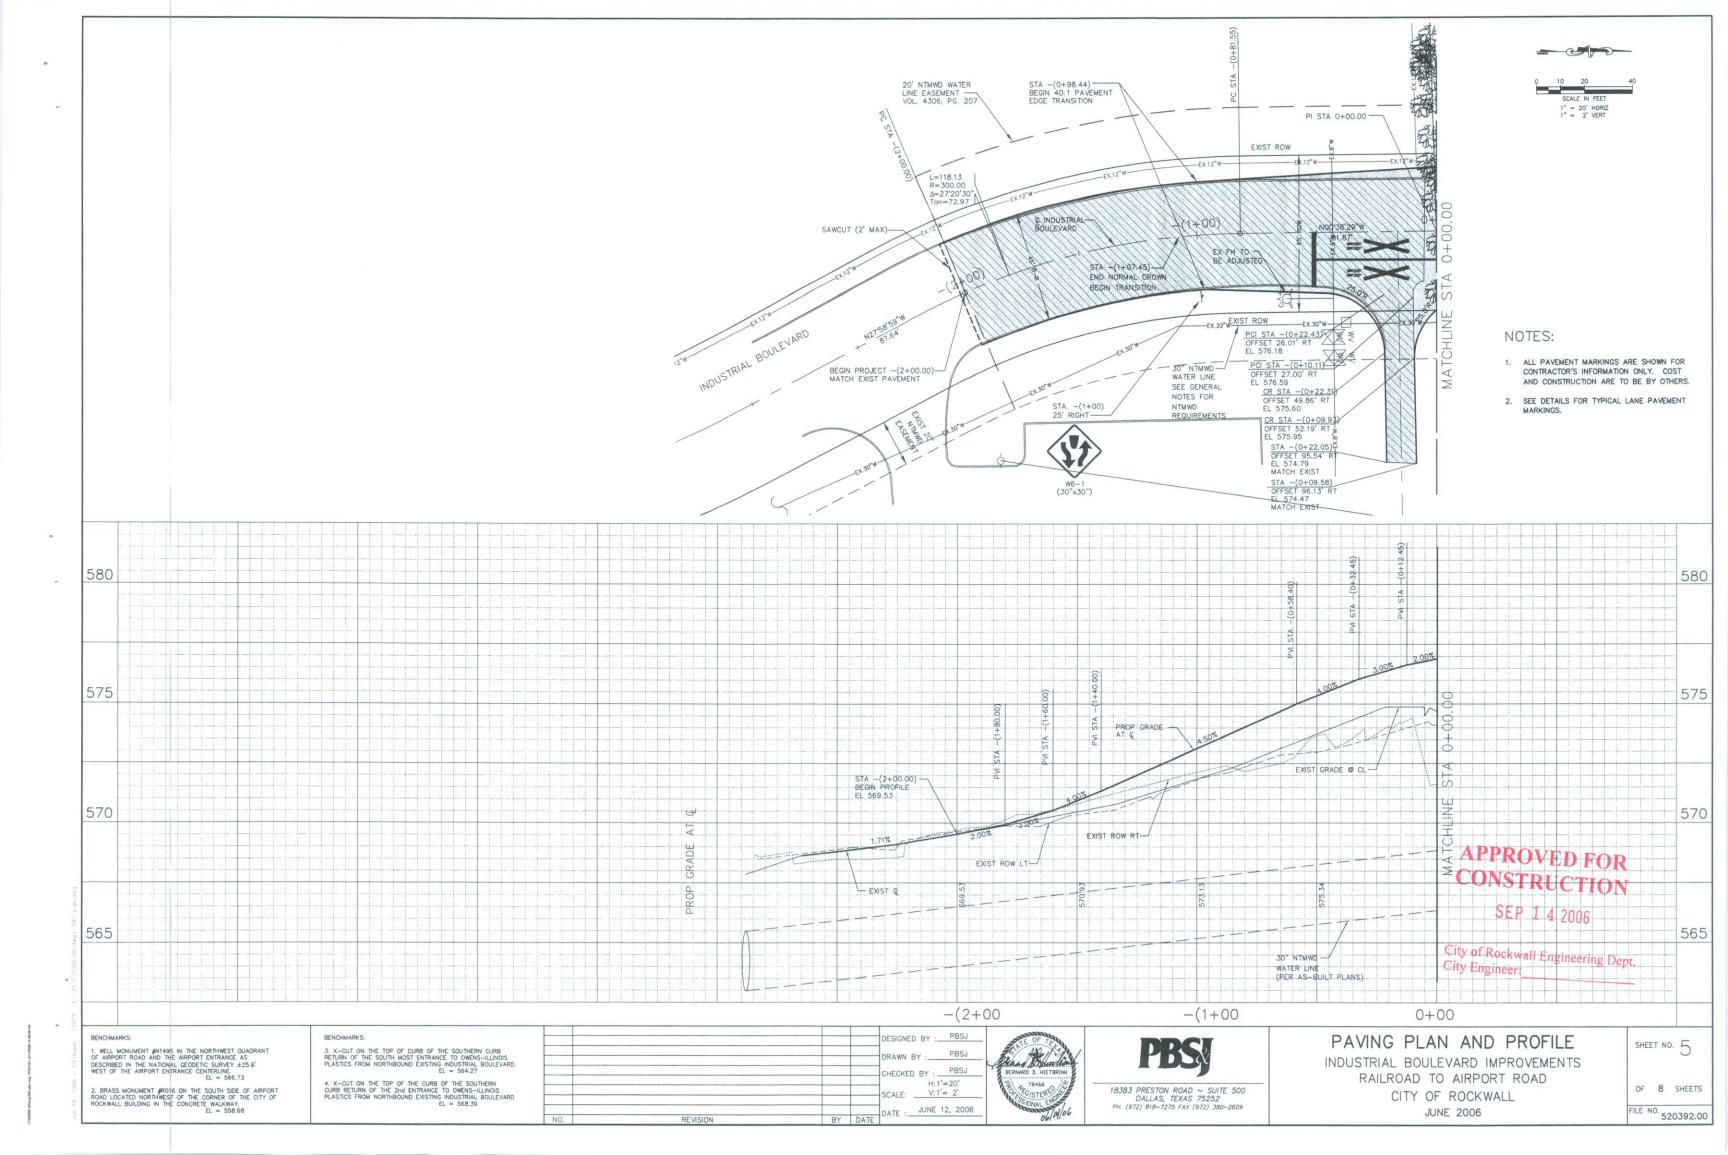

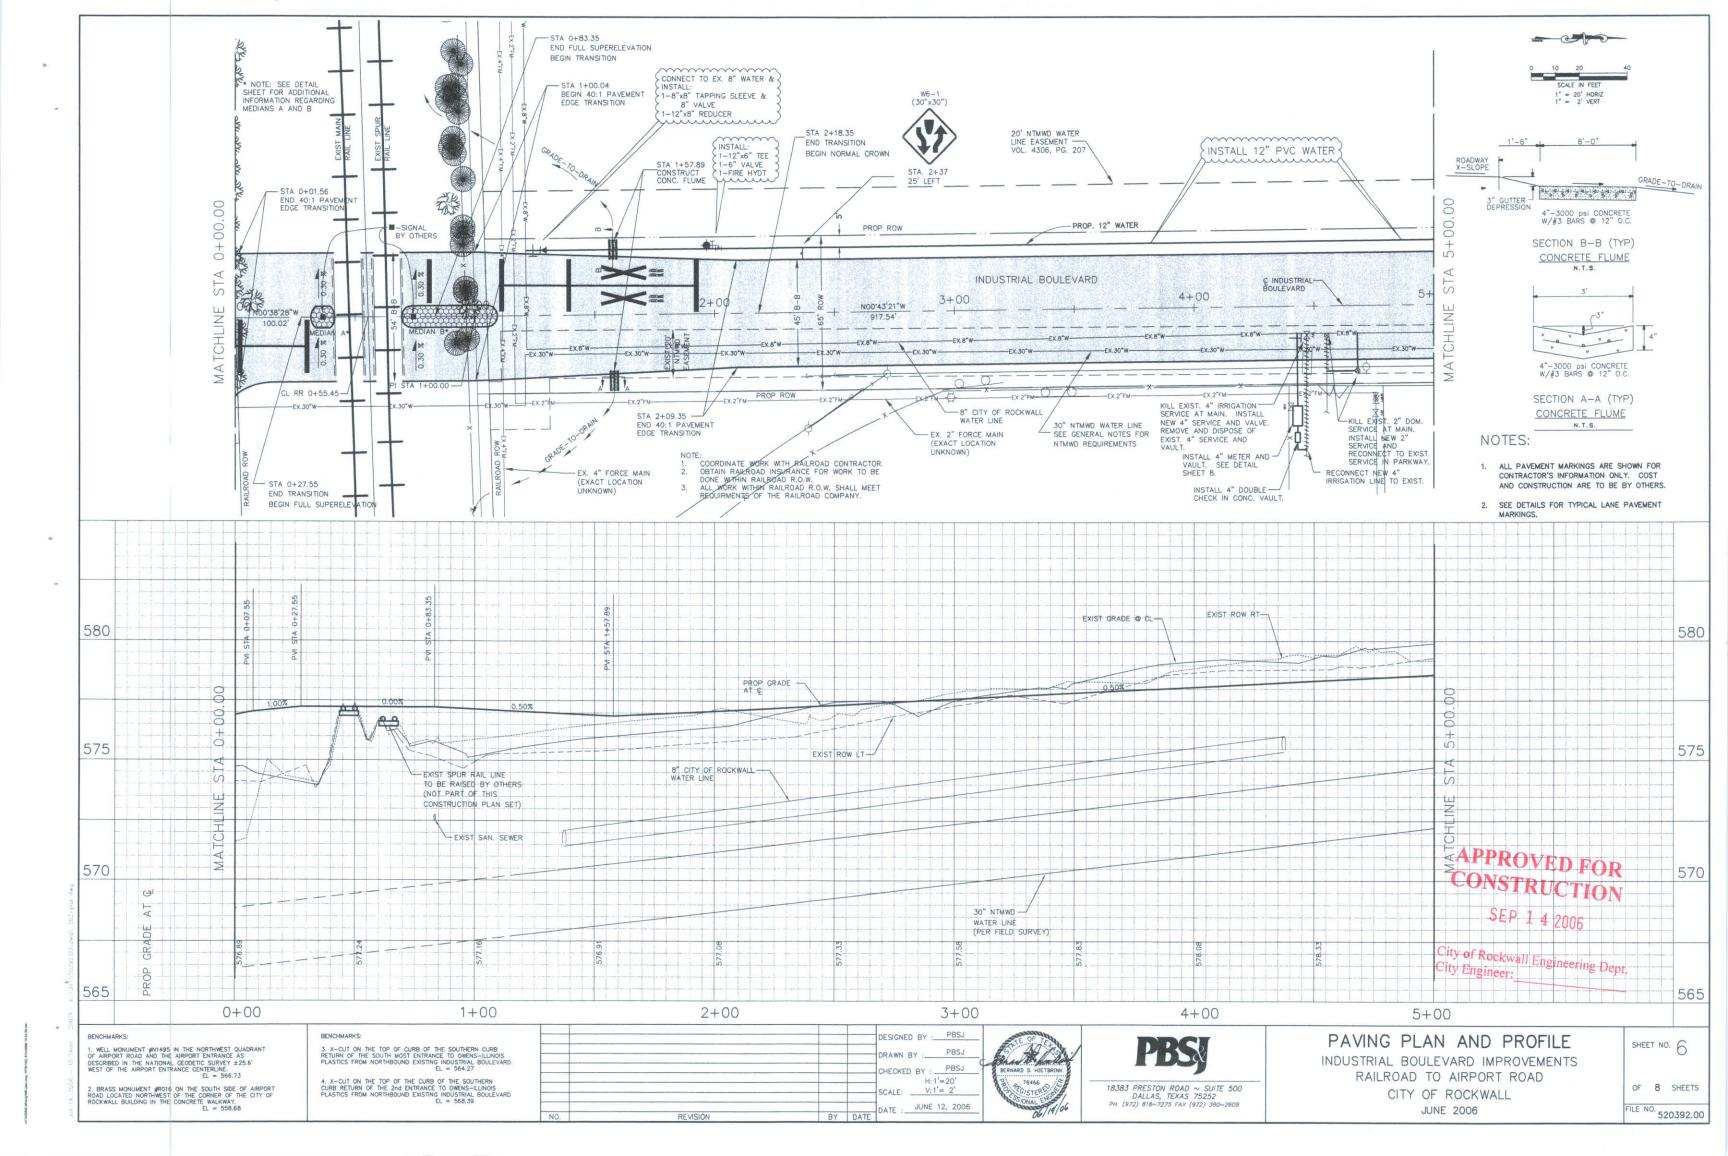

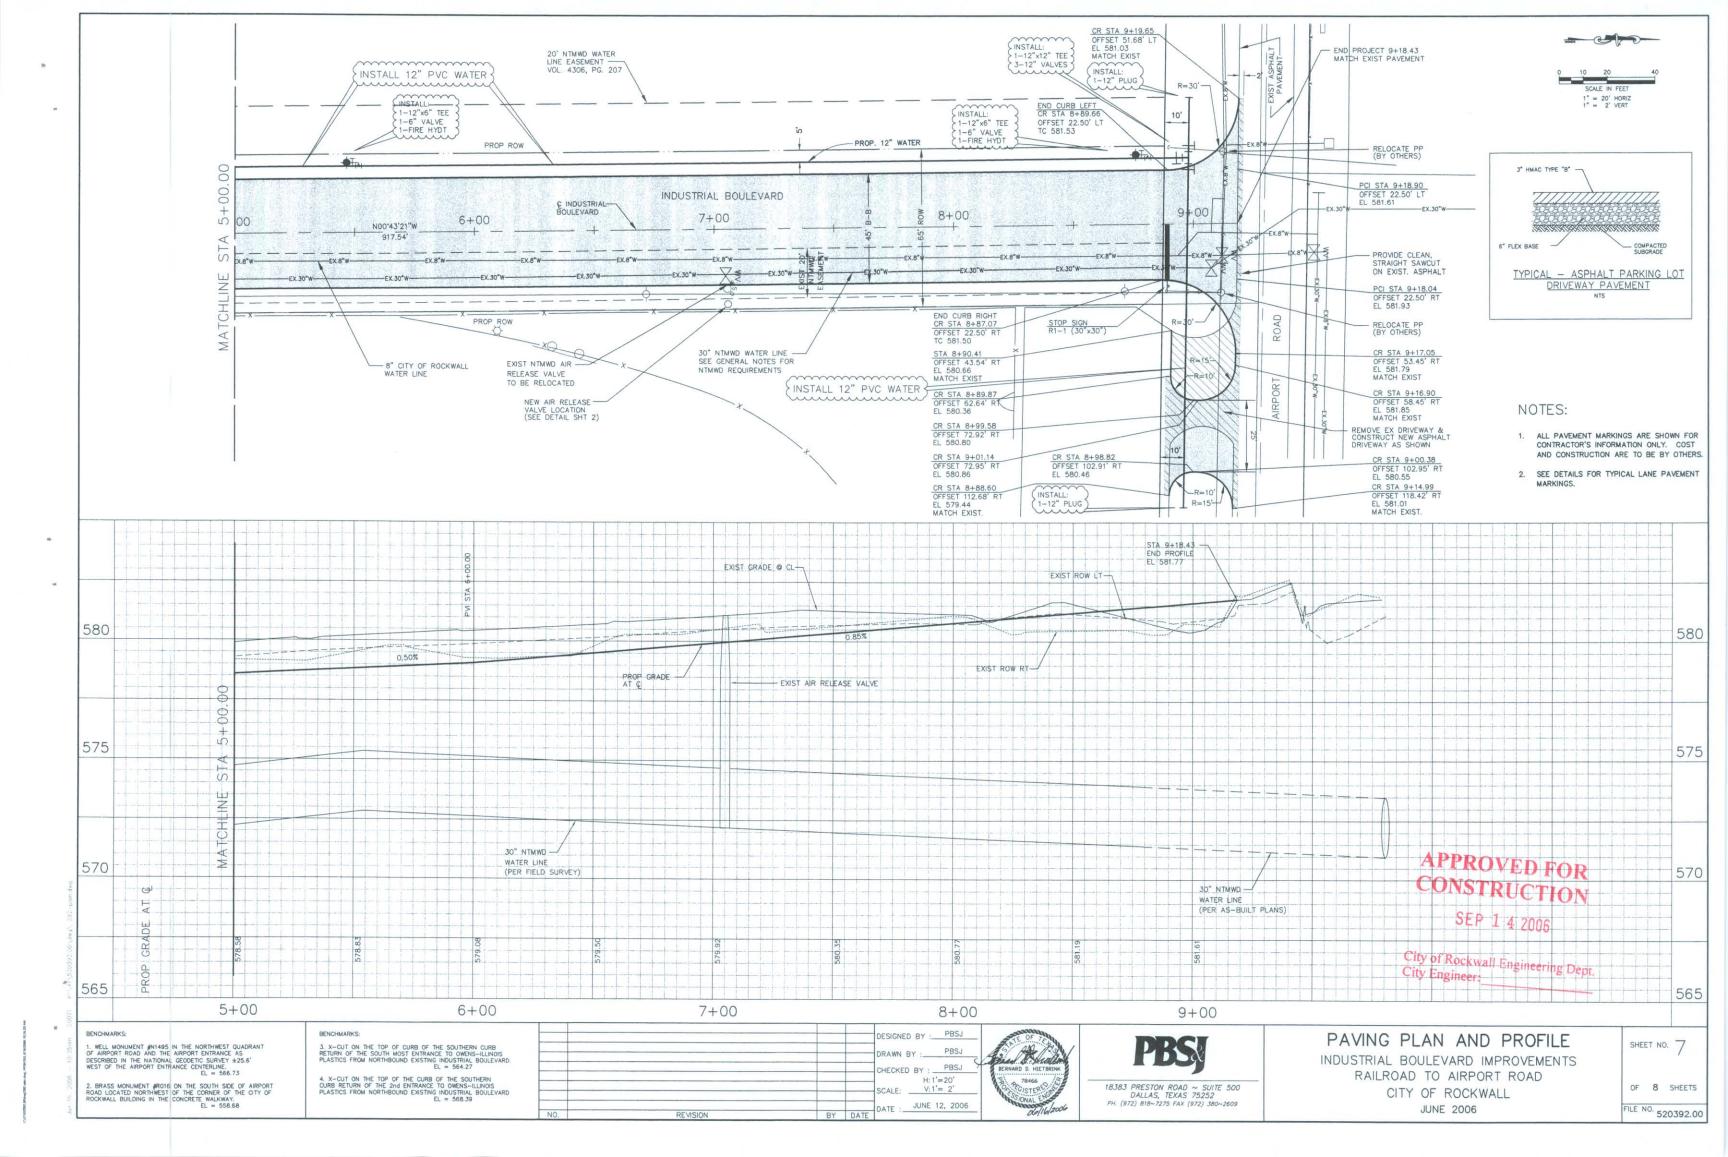

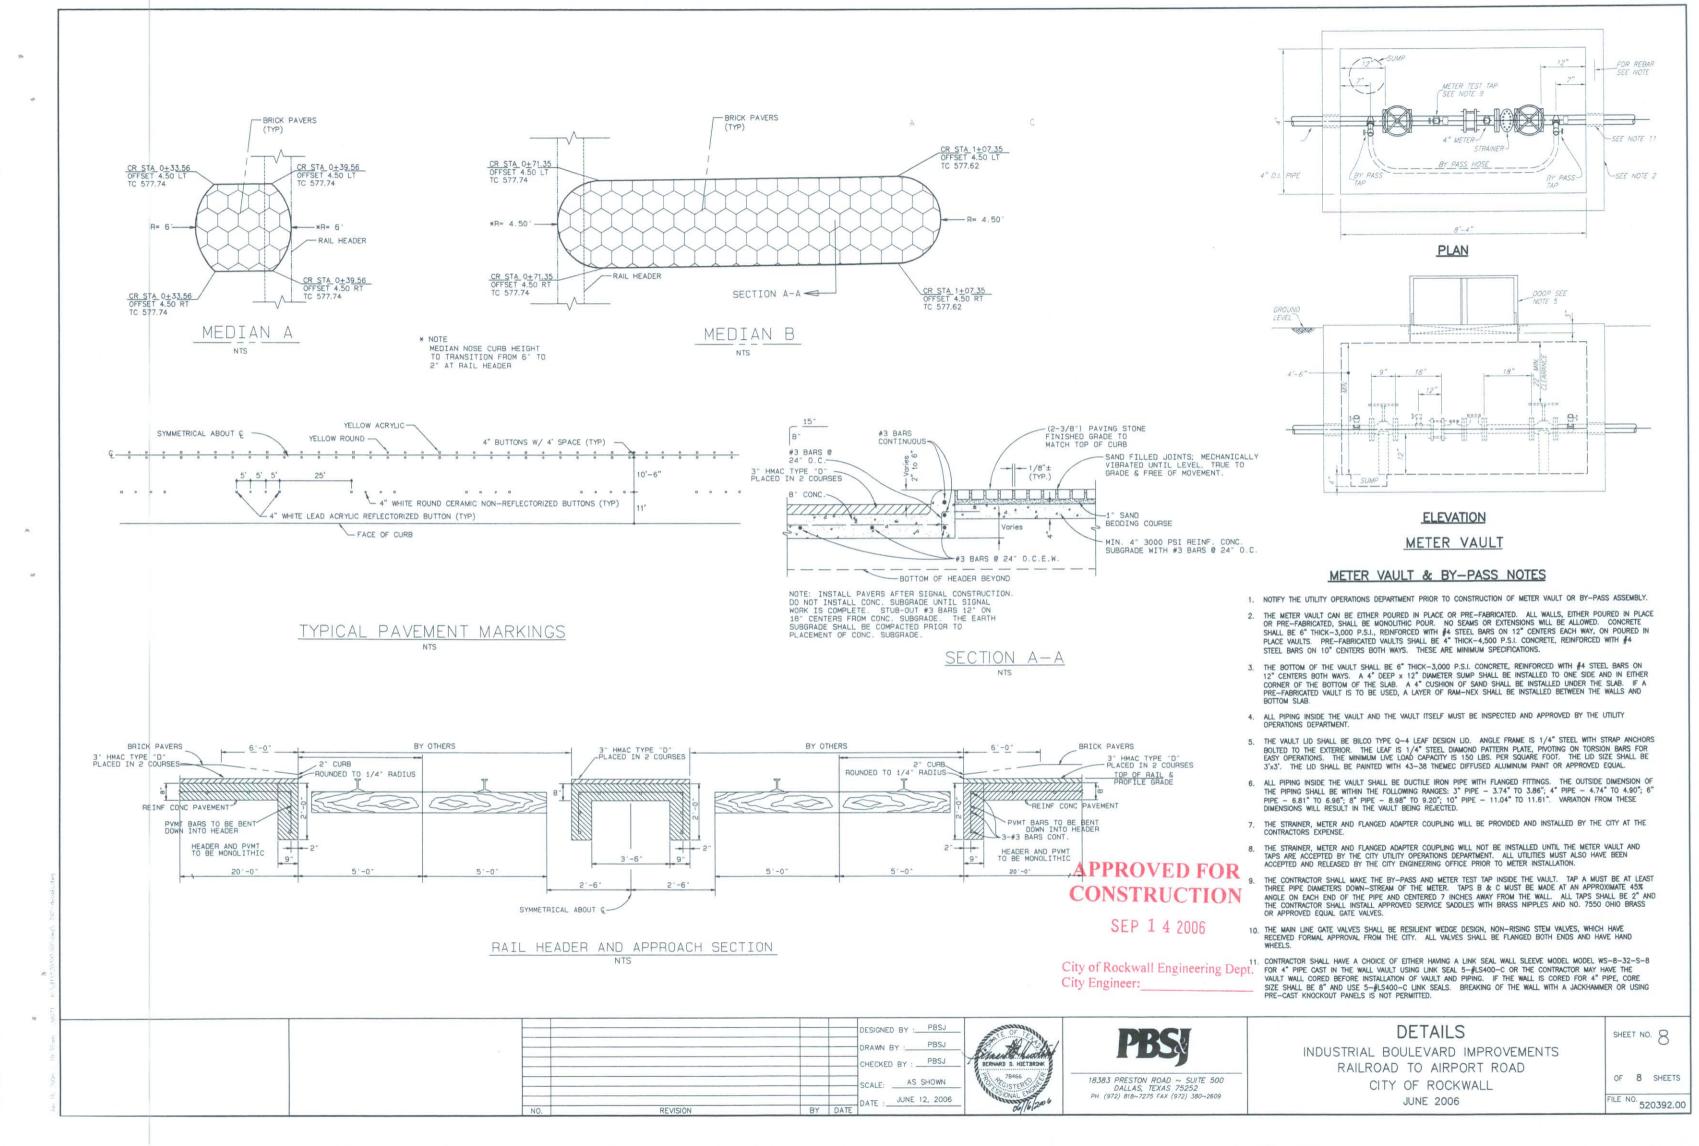

AIRPORT ROAD 580 TEMP. STABILIZED CONSTRUCTION ACCESS PROPOSED SILT FENCE (TYP) - LIMITS OF CONSTRUCTION LIMITS OF-CONSTRUCTION TEMP. STABILIZED CONSTRUCTION ACCESS

EROSION CONTROL NOTES:

- EROSION CONTROL DEVICES AS SHOWN ON THE SWPP PLAN FOR THE PROJECT SHALL BE INSTALLED PRIOR TO THE START OF LAND DISTURBING ACTIVITIES ON THE PROJECT.
- IF THE SWPPP AS APPROVED CANNOT CONTROL EROSION AND OFF-SITE SEDIMENTATION FROM THE PROJECT, THE SWPPP WILL BE REQUIRED TO BE REVISED AND/OR ADDITIONAL EROSION CONTROL DEVICES WILL BE REQUIRED ON SITE.
- 3. SITE ENTRY AND EXIT LOCATIONS SHALL BE MAINTAINED IN A CONDITION WHICH WILL PREVENT TRACKING OR FLOWING OF SEDIMENT ONTO PUBLIC ROADWAYS. ALL SEDIMENT SPILLED, DROPPED, WASHED OR TRACKED ON A PUBLIC ROADWAY MUST BE REMOVED IMMEDIATELY. WHEN WASHING IS REQUIRED TO REMOVE SEDIMENT PRIOR TO ENTRANCE TO A PUBLIC ROADWAY, IT SHALL BE DONE ON AN AREA STABILIZED WITH CRUSHED STONE WHICH DRAINS INTO AN APPROVED SEDIMENT BASIN. ALL FINES IMPOSED FOR TRACKING ONTO PUBLIC ROADS SHALL BE PAID BY THE CONTRACTOR.
- TEMPORARY SEEDING OR OTHER METHOD OF STABILIZATION SHALL BE INITIATED WITHIN 14 DAYS OF THE LAST DISTURBANCE ON ANY AREA OF THE SITE, UNLESS ADDITIONAL CONSTRUCTION ON THE AREA IS EXPECTED WITHIN 21 DAYS OF THE LAST DISTURBANCE.
- UPON COMPLETION OF FINE GRADING, ALL AREAS NOT OTHERWISE PERMANENTLY STABILIZED SHALL BE SEEDED AND MAINTAINED UNTIL A UNIFORM COVERAGE OF 1" DEPTH (75-80%) MINIMUM DENSITY, AS DETERMINED BY THE OWNER'S REPRESENTATIVE, IS ACHIEVED.
- ACCUMULATED SILT AT ANY EROSION CONTROL DEVICE SHALL BE REMOVED WHEN IT REACHES A DEPTH OF 6", AND SHALL BE DISTRIBUTED ON SITE IN A MANNER NOT CONTRIBUTING TO ADDITIONAL SILTATION.
- A MANNER NOT CONTRIBUTING TO ADDITIONAL SILTATION.

 THE CONTRACTOR IS RESPONSIBLE FOR RE-ESTABLISHING ANY EROSION CONTROL DEVICE WHICH HE DISTURBS. EACH CONTRACTOR SHALL NOTIFY THE OWNER'S REPRESENTATIVE OF ANY DEFICIENCIES IN THE ESTABLISHED EROSION CONTROL MEASURES WHICH MAY LEAD TO UNAUTHORIZED DISCHARGE OR STORM WATER POLLUTION, SEDIMENTATION OR OTHER POLLUTANTS, POTENTIAL UNAUTHORIZED POLLUTANTS INCLUDE, BUT ARE NOT LIMITED TO, EXCESS CONCRETE DUMPING OR CONCRETE RESIDE, PAINTS, SOLVENTS, GREASES, FUEL AND LUBE OIL, PESTICIDES, ANY SOLID WASTE MATERIALS, DISTURBED SOILS AND DEBRIS FROM CLEARING OPERATIONS.
- 8. PERMANENT REVEGETATION IN PARKWAYS SHALL BE BY BLOCK SOD.

STORM WATER DISCHARGE AUTHORIZATION

- A SIGNED CONSTRUCTION SITE NOTICE SHALL BE POSTED AT THE CONSTRUCTION SITE FOR THE DURATION OF THE CONSTRUCTION ACTIVITY.
- A COPY OF THE SWPPP SHALL BE RETAINED ON-SITE DURING CONSTRUCTION.

CONSTRUCTION SEQUENCE:

- PREPARING RIGHT-OF-WAY
- INSTALLATION OF EROSION CONTROL DEVICES
- GRADING AND PAVING
- RESTORATION CLEANUP


GENERAL NOTES:


- . DISTURBED AREA = 1.76 Ac
- 2. UNDISTURBED AREA = 0 Ac 3. TOTAL SITE AREA = 1.76 Ac
- SEE SHEETS 5-7 FOR PROP PAVING
- 5. RUNOFF COEFFICIENT PRE -CONST. = 0.35
 - POST-CONST. = 0.90

MEASUREMENT & PAYMENT:

NO PAYMENT WILL BE MADE FOR SWPPP. INCLUDE COST IN APPLICABLE CONSTRUCTION BID ITEM.



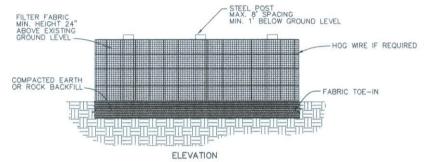

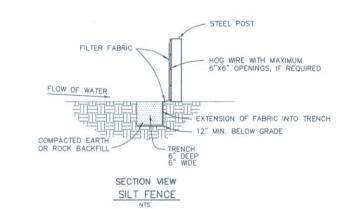


GENERAL NOTES:

- 1. Stone size- 3 to 5 inch open graded rock 2. Length- as effective, but not less than 50 feet. 3. Thickness- not less than 8 inches. 4. Width- not less than full width of all points of ingress or egress.
- or egress. S.

 Washing- when necessary, wheels shall be cleaned to remove sediment prior to entrance anto public roadway. When washing is required, it shall be done on an area stabilized with crushed stone which droins into an approved trap or sediment basin. All sediment shall be
- approved trop or sedinent basin. All sediment shall be prevented from entering any storm drain, ditch, or watercourse using approved nethods.

 5. Maintenance—the entrance shall be maintained in a condition which will prevent tracking or Flowing of sediment anto public roadways. This may require periodic top dressing with additional stone as conditions demand, and repair and/or cleanaut of any neasures used to trap sediment. All sediment spilled, dragged, washed as tracked anto while readway was dropped, washed or tracked onto public roadway mus be removed immediately
- leaving the construction site.

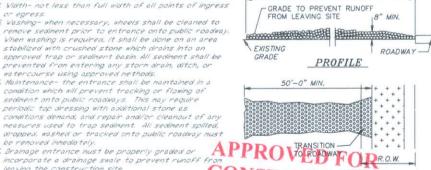

50'-0" MIN.

CONSTRUCTION STABILIZED CONSTRUCTION ENTRANCE SEP 1 4 2006

> City of Rockwall Engineering Dept. City Engineer:

1. WELL MONUMENT #N1495 IN THE NORTHWEST QUADRANT OF AIRPORT ROAD AND THE AIRPORT ENTRANCE AS DESCRIBED IN THE NATIONAL GEODETIC SURVEY \$25.6' WEST OF THE AIRPORT ENTRANCE CENTERLINE.

2. BRASS MONUMENT #R016 ON THE SOUTH SIDE OF AIRPORT ROAD LOCATED NORTHWEST OF THE CORNER OF THE CITY OF ROCKWALL BUILDING IN THE CONCRETE WALKWAY. EL = 558.68

3. X-CUT ON THE TOP OF CURB OF THE SOUTHERN CURB RETURN OF THE SOUTH MOST ENTRANCE TO DWENS-ILLINOIS PLASTICS FROM NORTHBOUND EXISTING INDUSTRIAL BOULEVARD EL=564.27

PBSJ DESIGNED BY :__ PBSJ DRAWN BY CHECKED BY : PBSJ SCALE: H:1'=60' DATE : JUNE 12, 2006

LEGEND

PROPOSED SILT FENCE EXISTING CONTOUR

DIRECTION OF FLOW





18383 PRESTON ROAD ~ SUITE 500 DALLAS, TEXAS 75252

STORMWATER POLLUTION PREVENTION PLAN SHEET NO. 3

JUNE 2006

INDUSTRIAL BOULEVARD IMPROVEMENTS RAILROAD TO AIRPORT ROAD CITY OF ROCKWALL

OF 8 SHEETS

FILE NO. 520392.00