
CONSTRUCT DIVERSION DIKE TO DIVERT STORMWATER RUNOFF THRU SILT FENCE.

## EROSION CONTROL PLAN EARTHWORK OPERATIONS


NOT TO SCALE

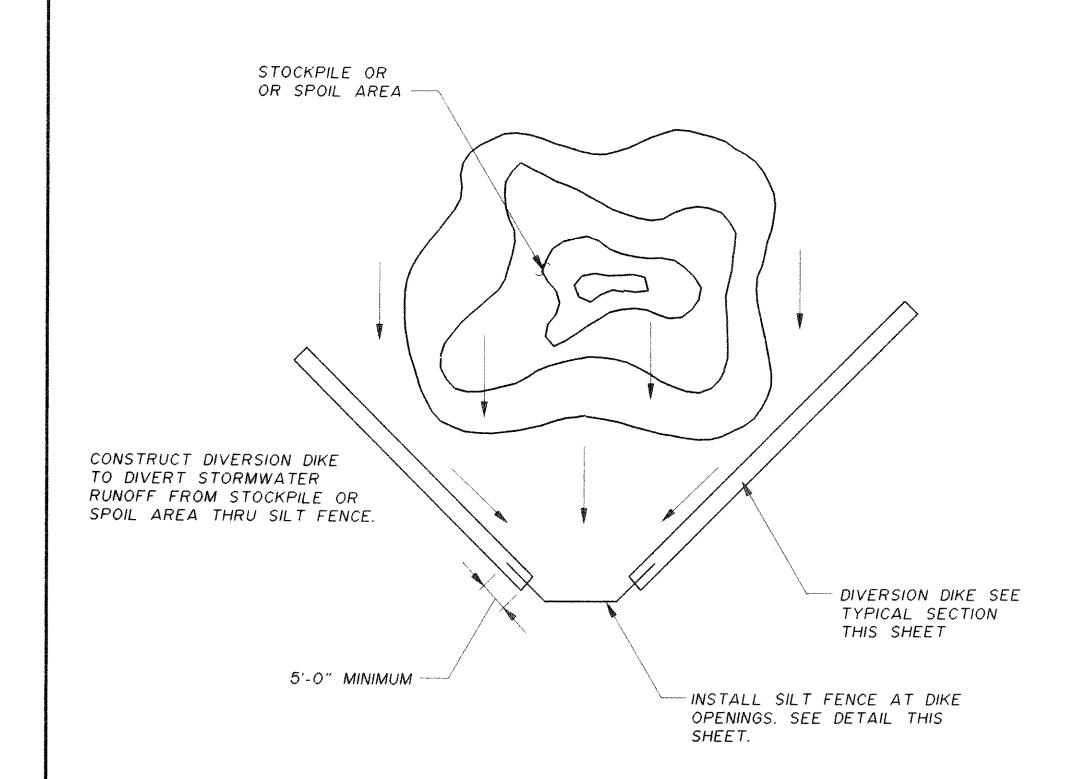


## EROSION CONTROL PLAN EARTH STOCKPILE OR SPOIL AREAS

NOT TO SCALE

NOTE: REFER TO SECTION 01568 FOR EROSION CONTROL AND SEDIMENT CONTROL SPECIFICATIONS.

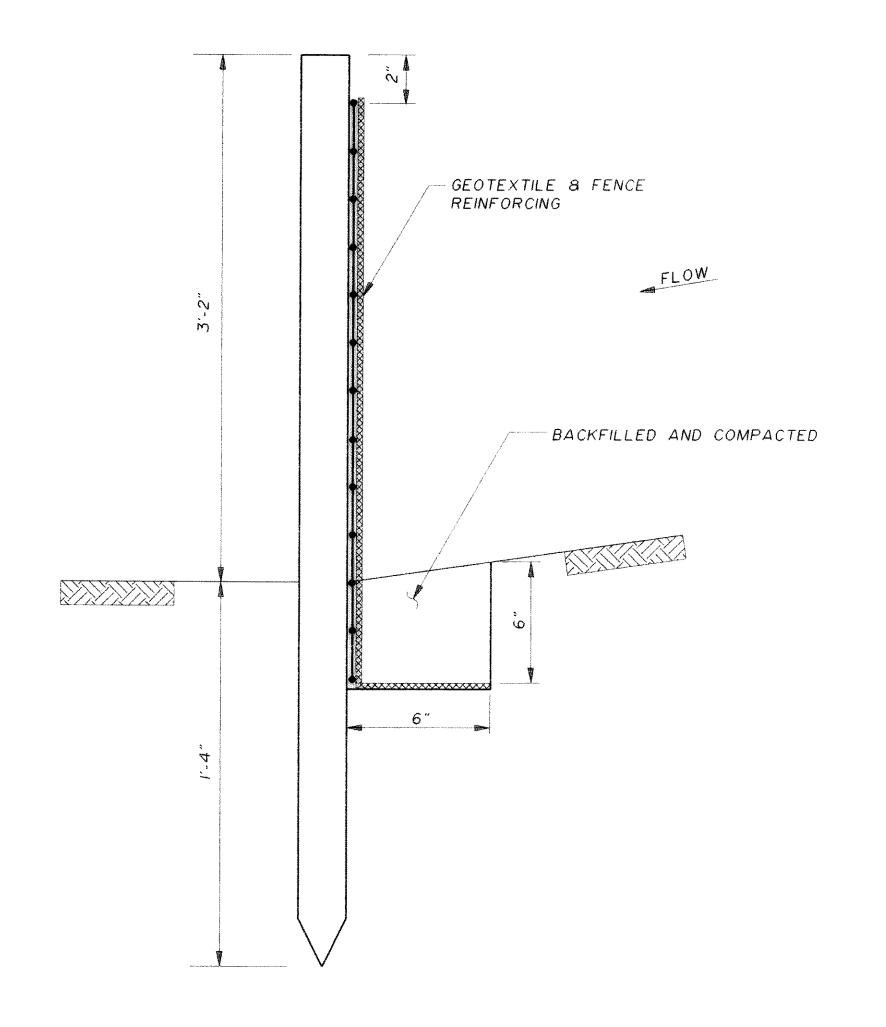


DETAIL - SILT FENCE NOT TO SCALE

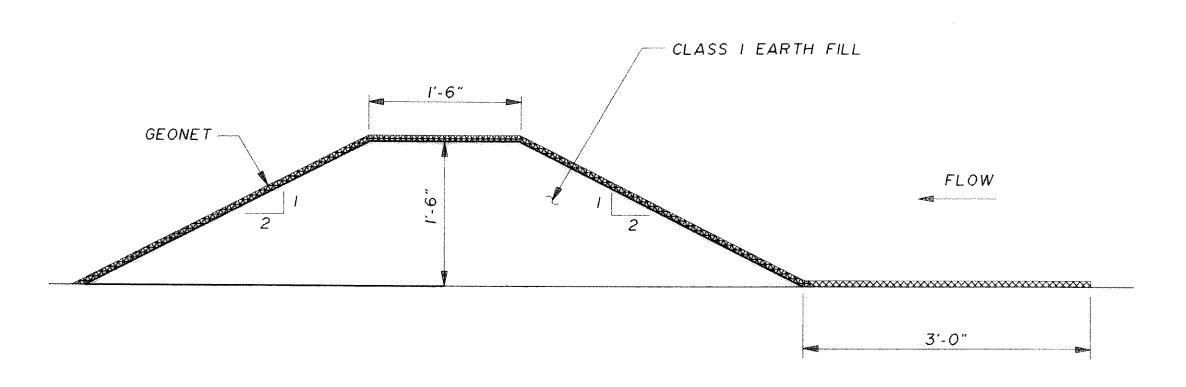


## TYPICAL SECTION - DIVERSION DIKE

NOT TO SCALE

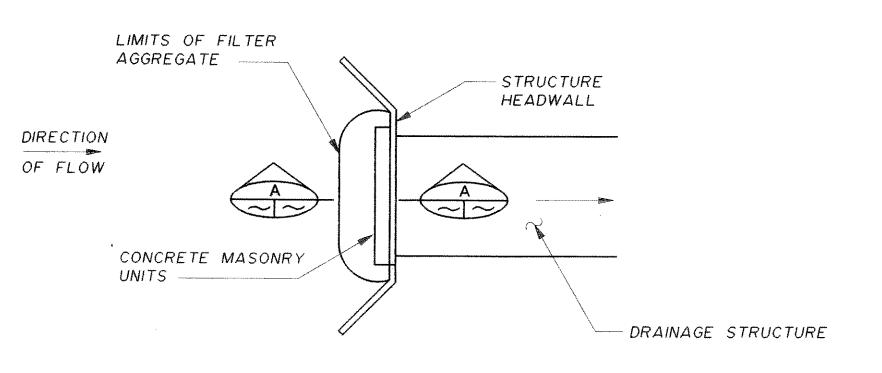

DETAIL SIMILAR AT DRAINAGE STRUCTURE WITHOUT HEADWALL

PLAN

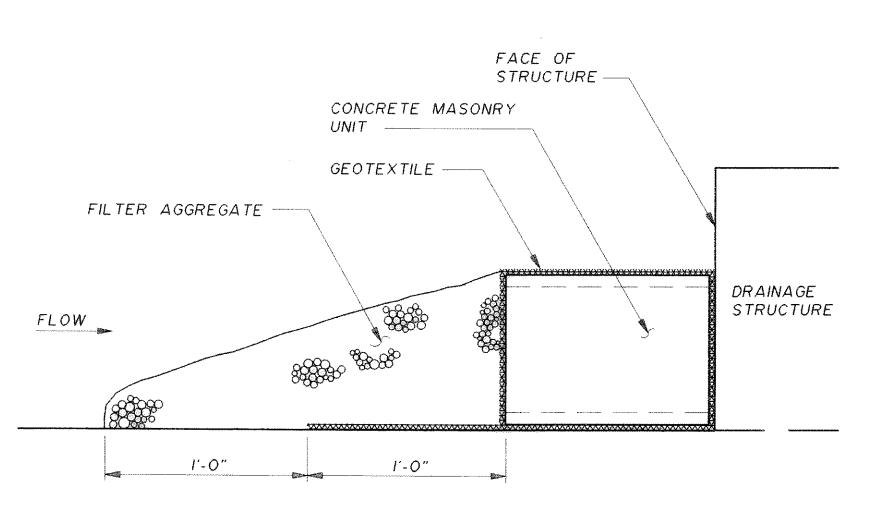




## SILT TRAP AT DRAINAGE STRUCTURES

NOT TO SCALE

RECORD DRAWING
BASED ON INFORMATION SUPPLIED BY THE CONTRACTOR DATE: 10/2/92 BY: LDS

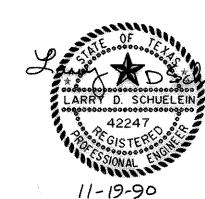

THE SEAL APPEARING ON THIS DOCUMENT WAS AUTHORIZED BY LARRY D. SCHUELEIN, TEXAS P.E. No. 42247 ON NOV. 19, 1990

JOB NO ROK89005 DRAWN: DATE 11/19/90 TRACED: SCALE AS SHOWN

CONSULTING ENGINEERS FORT WORTH - ARLINGTON - AUSTIN, TEXAS

CITY OF ROCKWALL, TEXAS EASTSIDE PUMP STATION

EROSION AND SEDIMENT DETAILS

SHEET 30 OF 39

FREESE AND NICHOLS, INC.