CIVIL CONSTRUCTION PLANS

# SPR PACKAGING - EXPANSION

BLOCK A, LOT 2, SPR PACKAGING ADDITION NWC OF INDUSTRIAL BLVD. @ JUSTIN ROAD N. BUTLER SURVEY, ABSTRACT NO. 20 AND THE R. BALLARD SURVEY, ABSTRACT NO. 29

> ROCKWALL COUNTY CITY OF ROCKWALL, TEXAS

> > PLANS PREPARED BY:

1512 BRAY CENTRAL DRIVE, SUITE 100 McKINNEY, TEXAS 75069 (214) 544 - 8880FAX (214) 544-8882 RANDALL P. POGUE, P.E.

> PLANS PREPARED FOR: MR. STEVEN ROSENBERG SPR PACKAGING, INC. 1480 JUSTIN ROAD ROCKWALL, TEXAS 75087 (469) 252-1070 PHONE (469) 252-1069 FAX

### SSMH | Sanitary Sew er Manhole LS Light Standard STA Station STMH Storm Sew er Manhole Pavement Thickness Controlling Monument MIN Minimum Top of Curb NIC Not In Contract Telephone Lines OC On Center Telephone Riser Curb Return OCEW On Center Each Way Top of Pavement PC Point of Curve Traffic Signal Control Traffic Signal Pole Point of Intersection Hevation

**PLAN ABBREVIATIONS LIST** 

Subgrade Thickness

Set Iron Rod

XXX.XX Ex or Prop Spot Grade

ICV Irrigation Control Valve

GM Gas Meter

ONC Concrete DBL CO Double Clean Ou Television Box VC Vertical Curve PT Point of Tangency Face of Curb Point of Vertical Curvature W Fire Hydrant PVI Point of Vertical Intersection WM Water Meter Found Iron Rod WSEL PVT Point of Vertical Tangency

FRANCHISE UTILITY NOTES:

1. TXU ELECTRIC - (972) 771-3979 - JOE PECINA 2. ATMOS ENERGY (GAS) - (972) 485-6277 - MS. DINAH WOOD 3. SBC - (903) 457-2092 - CAROLYN NAYLOR 4. CHARTER COMM. (CABLE) - (817) 509-6272 x6896 - HECTOR ELIZONDO

Radius

RENF Reinforcing

CAUTIONIII UNDERGROUND UTILITIES ARE LOCATED IN THIS AREA. 48 HOURS PRIOR TO ANY CONSTRUCTION ACTIVITIES, CONTACT LINE LOCATES FOR FRANCHISE UTILITY INFO. CALL BEFORE YOU DIG: TEXAS EXCAVATION SAFETY SYSTEM (TESS) 1-800-344-8377 TEXAS ONE CALL SYSTEMS 1-800-245-4545 BEFORE YOU DIG. LONE STAR NOTIFICATION CENTER 1-800-669-8344 EXT. 5

BENCH MARK LIST:

LEGEND

BOLLARD

ELECTRIC METER

LIGHT STANDARD

IRRIGATION CONTROL VALVE

TRAFFIC SIGNAL CONTROL

TRAFFIC SIGNAL POLE

FIRE DEPARTMENT CONNECTION

WATER METER WATER VALVE

FIRE HYDRANT

CLEAN OUT

GAS METER

TRAFFIC SIGN

TV BOX

PROPERTY LINE

O.H. POWER LINES

WATER U/G WATER LINE

EXISTING CONTOURS

GAS LINE

Back of Curb

Grade Break

----U/O TELE---- U/G TELEPHONE LINES

FLAG POLE

TELEPHONE BOX

LANDSCAPE AREA

EXISTING SPOT GRADES

5/8-INCH IRON ROD WITH

PROPOSED SPOT GRADES

PROPOSED EROSION CONTROL

"POGUE ENG & DEV" CAP SET

PROPOSED DRAINAGE DIVIDES


MANHOLE

POWER POLE

X-CUT FOUND ON THE TOP OF CURB OF THE SOUTHERN CURB RETURN AT EAST SIDE OF INDUSTRIAL BLVD. 590'± SOUTH FROM CENTERLINE OF

BENCHMARK #2
X-CUT SET AT THE SOUTHEAST CORNER OF CURB INLET LOCATED IN
NORTH SIDE OF JUSTIN ROAD 40'± WEST OF SOUTHWEST CORNER OF SITE.

OWNER: MR. STEVEN ROSENBERG FLEXLAND, L.P. 1480 JUSTIN ROAD ROCKWALL, TEXAS 75087 (469) 252-1070 PHONE (469) 252-1069 FAX

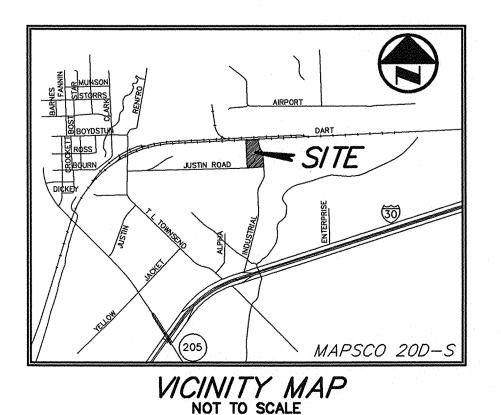

RECORD DRAWNGS:

IT WAS THE INTENT THAT THE IMPROVEMENTS SHOWN BE CONSTRUCTED ACCORDING TO THESE PLANS AS APPROVED BY THE CITY. THE LINES AND GRADES WERE SET ON THE GROUND FOR CONSTRUCTION ACCORDING TO SAID PLANS. THE CITY INSPECTED THE CONSTRUCTION. THE ENGINEER DID NOT VERIFY LINES OR GRADES AFTER CONSTRUCTION, WE ARE NOT AWARE OF ANY CHANGES OR REVISIONS TO THESE PLANS DURING CONSTRUCTION OTHER THAN THOSE SHOWN. DATE: SEPTEMBER 27, 2011

PROJECT GENERAL NOTES:

1. SIZE AND LOCATION OF ALL UNDERGROUND UTILITIES HAVE BEEN REPRODUCED FROM PLANS ON FILE WITH THE CITY. CONTRACTOR TO VERIFY SIZE AND LOCATION OF ALL UTILITIES PRIOR TO COMMENCEMENT OF ANY CONSTRUCTION ACTIVITY.

2. THE BEARING SYSTEM FOR THIS TRACT WAS BASED ON A BEARING OF NORTH 87 DEGREES, 51 MINUTES, 50 SECONDS WEST FOR THE SOUTH LINE OF THAT CERTAIN TRACT OF LAND DESCRIBED IN WARRANTY DEED TO THE WHITMORE MANUFACTURING COMPANY RECORDED IN VOLUME 453, PAGE 167 OF THE DEED RECORDS OF ROCKWALL COUNTY,

3. BASE BOUNDARY AND TOPOGRAPHY INFORMATION SHOWN IS BASED ON THE GROUND SURVEY AS PREPARED BY POGUE ENGINEERING & DEVELOPMENT COMPANY, INC. DATED

4. THE SUBJECT PROPERTY IS SHOWN ON THE NATIONAL FLOOD INSURANCE PROGRAM FLOOD INSURANCE RATE MAP FOR THE CITY OF ROCKWALL, ROCKWALL COUNTY, TEXAS AND INCORPORATED AREAS COMMUNITY PANEL NUMBER 480547 0005 C, DATED JULY 16, 1992. ALL OF THE SUBJECT PROPERTY IS INDICATED TO BE IN ZONE 'X' ON SAID MAP. RELEVANT ZONES ARE DEFINED ON SAID MAP AS FOLLOWS:

ZONE 'X' - AREAS DETERMINED TO BE OUTSIDE OF THE 500-YR FLOOD PLAIN.

THIS FLOOD STATEMENT REGARDING FLOODING DOES NOT IMPLY THAT THE PROPERTY RARE OCCASIONS, GREATER FLOODS CAN AND WILL OCCUR AND FLOOD HEIGHTS MAY BE INCREASED BY MAN-MADE OR NATURAL CAUSES. THIS FLOOD STATEMENT SHALL NOT CREATE LIABILITY ON THE PART OF THE SURVEYOR AND/OR ENGINEER.

5. PRIOR TO ANY CONSTRUCTION ACTIVITY, THE CONTRACTOR SHALL BECOME FAMILIAR WITH THE PLANS AND SPECIFICATIONS INCLUDING ALL NOTES, THE STANDARD SPECIFICATIONS FOR PUBLIC WORKS CONSTRUCTION AS ISSUED BY THE NORTH TEXAS CENTRAL TEXAS COUNCIL OF GOVERNMENTS 3rd ADDITION. THE CITY STANDARDS FOR PLIBLIC WORKS CONSTRUCTION AND ANY OTHER APPLICABLE STANDARD AND SPECIFICATIONS RELEVANT TO THE PROPER COMPLETION OF THE WORK HEREIN SPECIFIE FAILURE ON THE PART OF THE CONTRACTOR TO BECOME FAMILIAR WITH SAID STANDARDS AND SPECIFICATIONS PERTAINING TO THIS WORK SHALL IN NO WAY RELIEVE THE CONTRACTOR OF RESPONSIBILITY OF PERFORMING THE WORK IN ACCORDANCE WITH ALL SUCH APPLICABLE STANDARDS AND SPECIFICATIONS WITHOUT ADDITIONAL COST TO

6. REFER TO THE GEOTECHNICAL REPORT FOR SUBSURFACE SOIL CONDITIONS AND RECOMMENDATIONS PERTAINING TO THE SUBJECT SITE.

7. ALL DIMENSIONS ARE FROM BACK OF CURB TO BACK OF CURB, UNLESS OTHERWISE

8. REFER TO THE STANDARD DETAILS AND GENERAL NOTES PLAN(S) FOR PAVING, DRAINAGE, AND UTILITY STANDARD DETAILS AND GENERAL NOTES.

9. REFER TO THE ARCHITECTURAL AND STRUCTURAL PLANS TO VERIFY ALL BUILDING

10. REFER TO THE ARCHITECTURAL PLANS FOR DETAILED BUILDING ENTRANCE LAYOUTS, RAMPS, DUMPSTER AREA, BUILDING OVERHANGS, BOLLARDS, LANDSCAPING AND

11. REFER TO THE ARCHITECTURAL AND MECHANICAL PLANS FOR THE EXACT LOCATIONS FOR ROOF DRAIN COLLECTION SYSTEM TIE IN LOCATIONS.

12. REFER TO THE ARCHITECTURAL AND ELECTRICAL PLANS FOR THE SITE LIGHTING LOCATIONS, REQUIREMENTS AND SPECIFICATIONS.

13. DUMPSTER SCREENING TO COMPLY WITH CITY REQUIREMENTS.

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C3.01 GRADING PLAN

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C7.01 GENERAL NOTES SHEET

L1.00 TREE PRESERVATION PLAN

L1.01 LANDSCAPE PLAN

L1.02 LANDSCAPE SPECIFICATIONS AND DETAILS


FOR STORM DETAILS SEE CITY OF ROCKWALL/STANDARDS AND NTCOG 3rd ADDITION


09-27-11 RECORD DRAWINGS


05-24-11 RFI #6 (ST-2; DELETED RADIUS PIPE)


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ENGINEERING PRACTICE ACT.



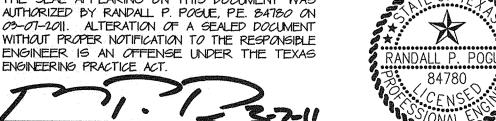

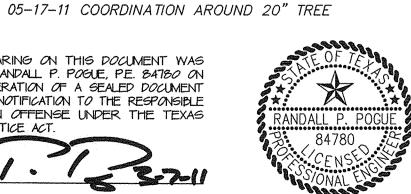

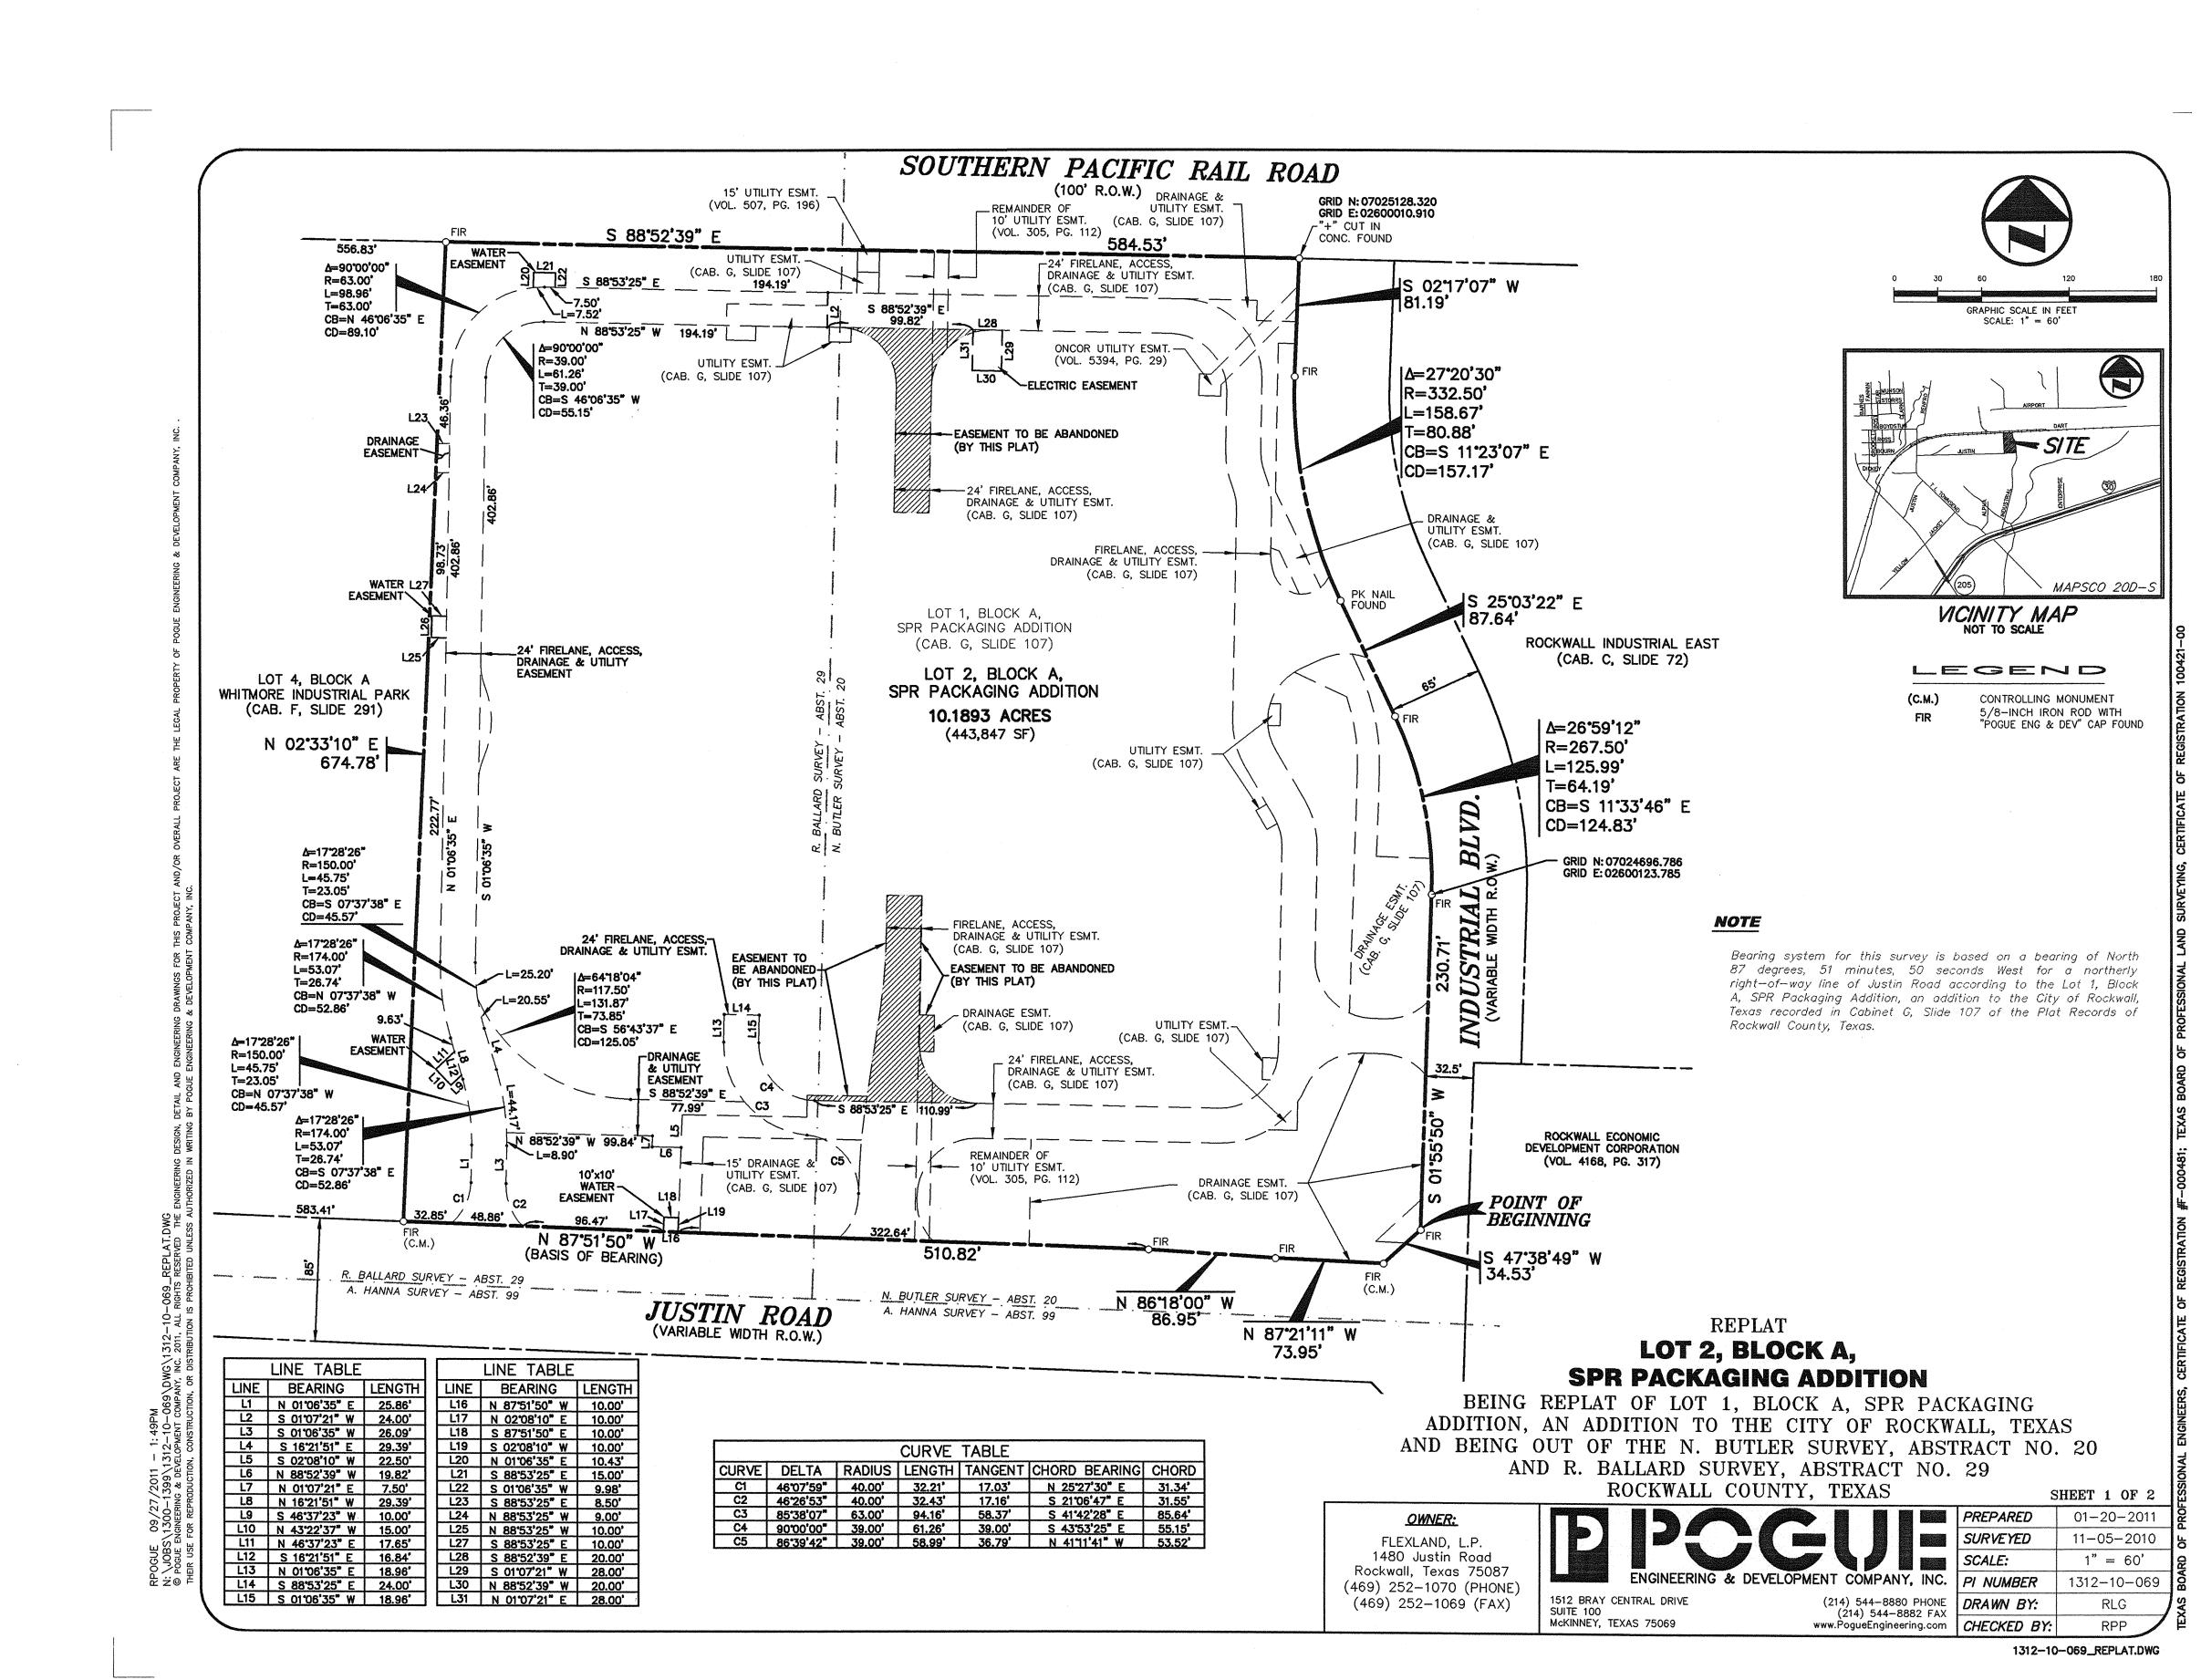


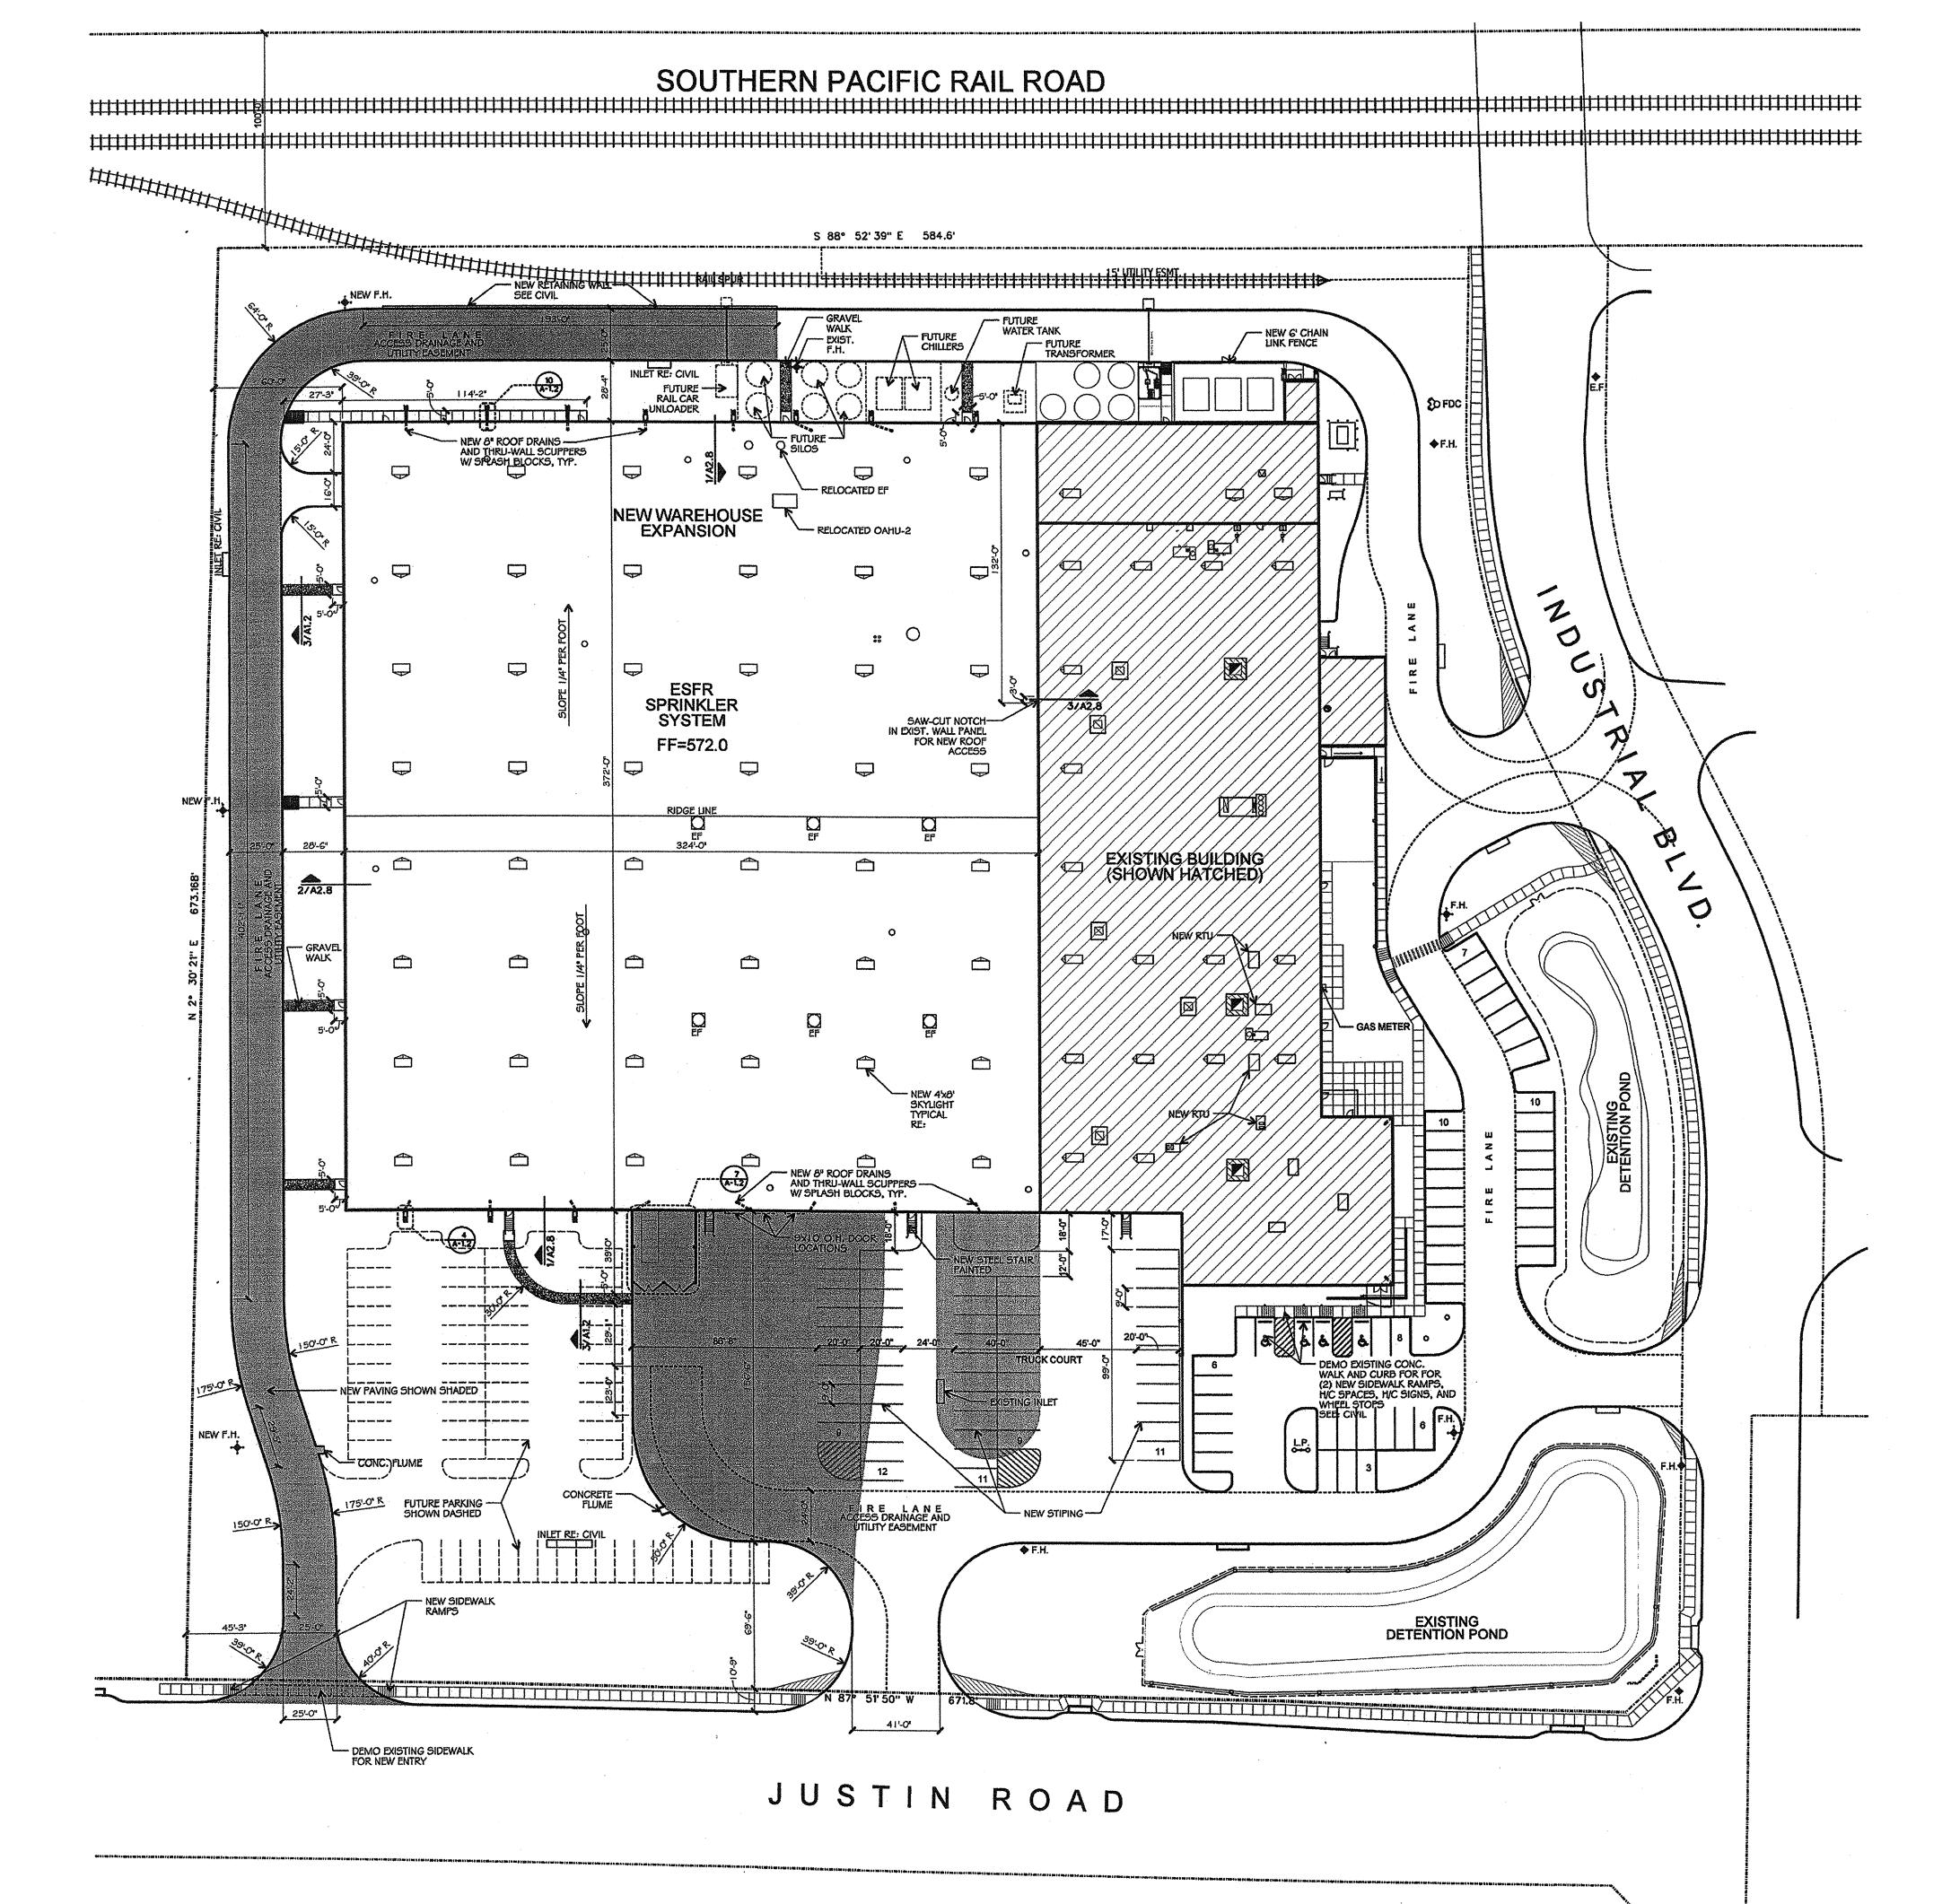



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ROCKWALL

job no 1016 sheet **A11** 



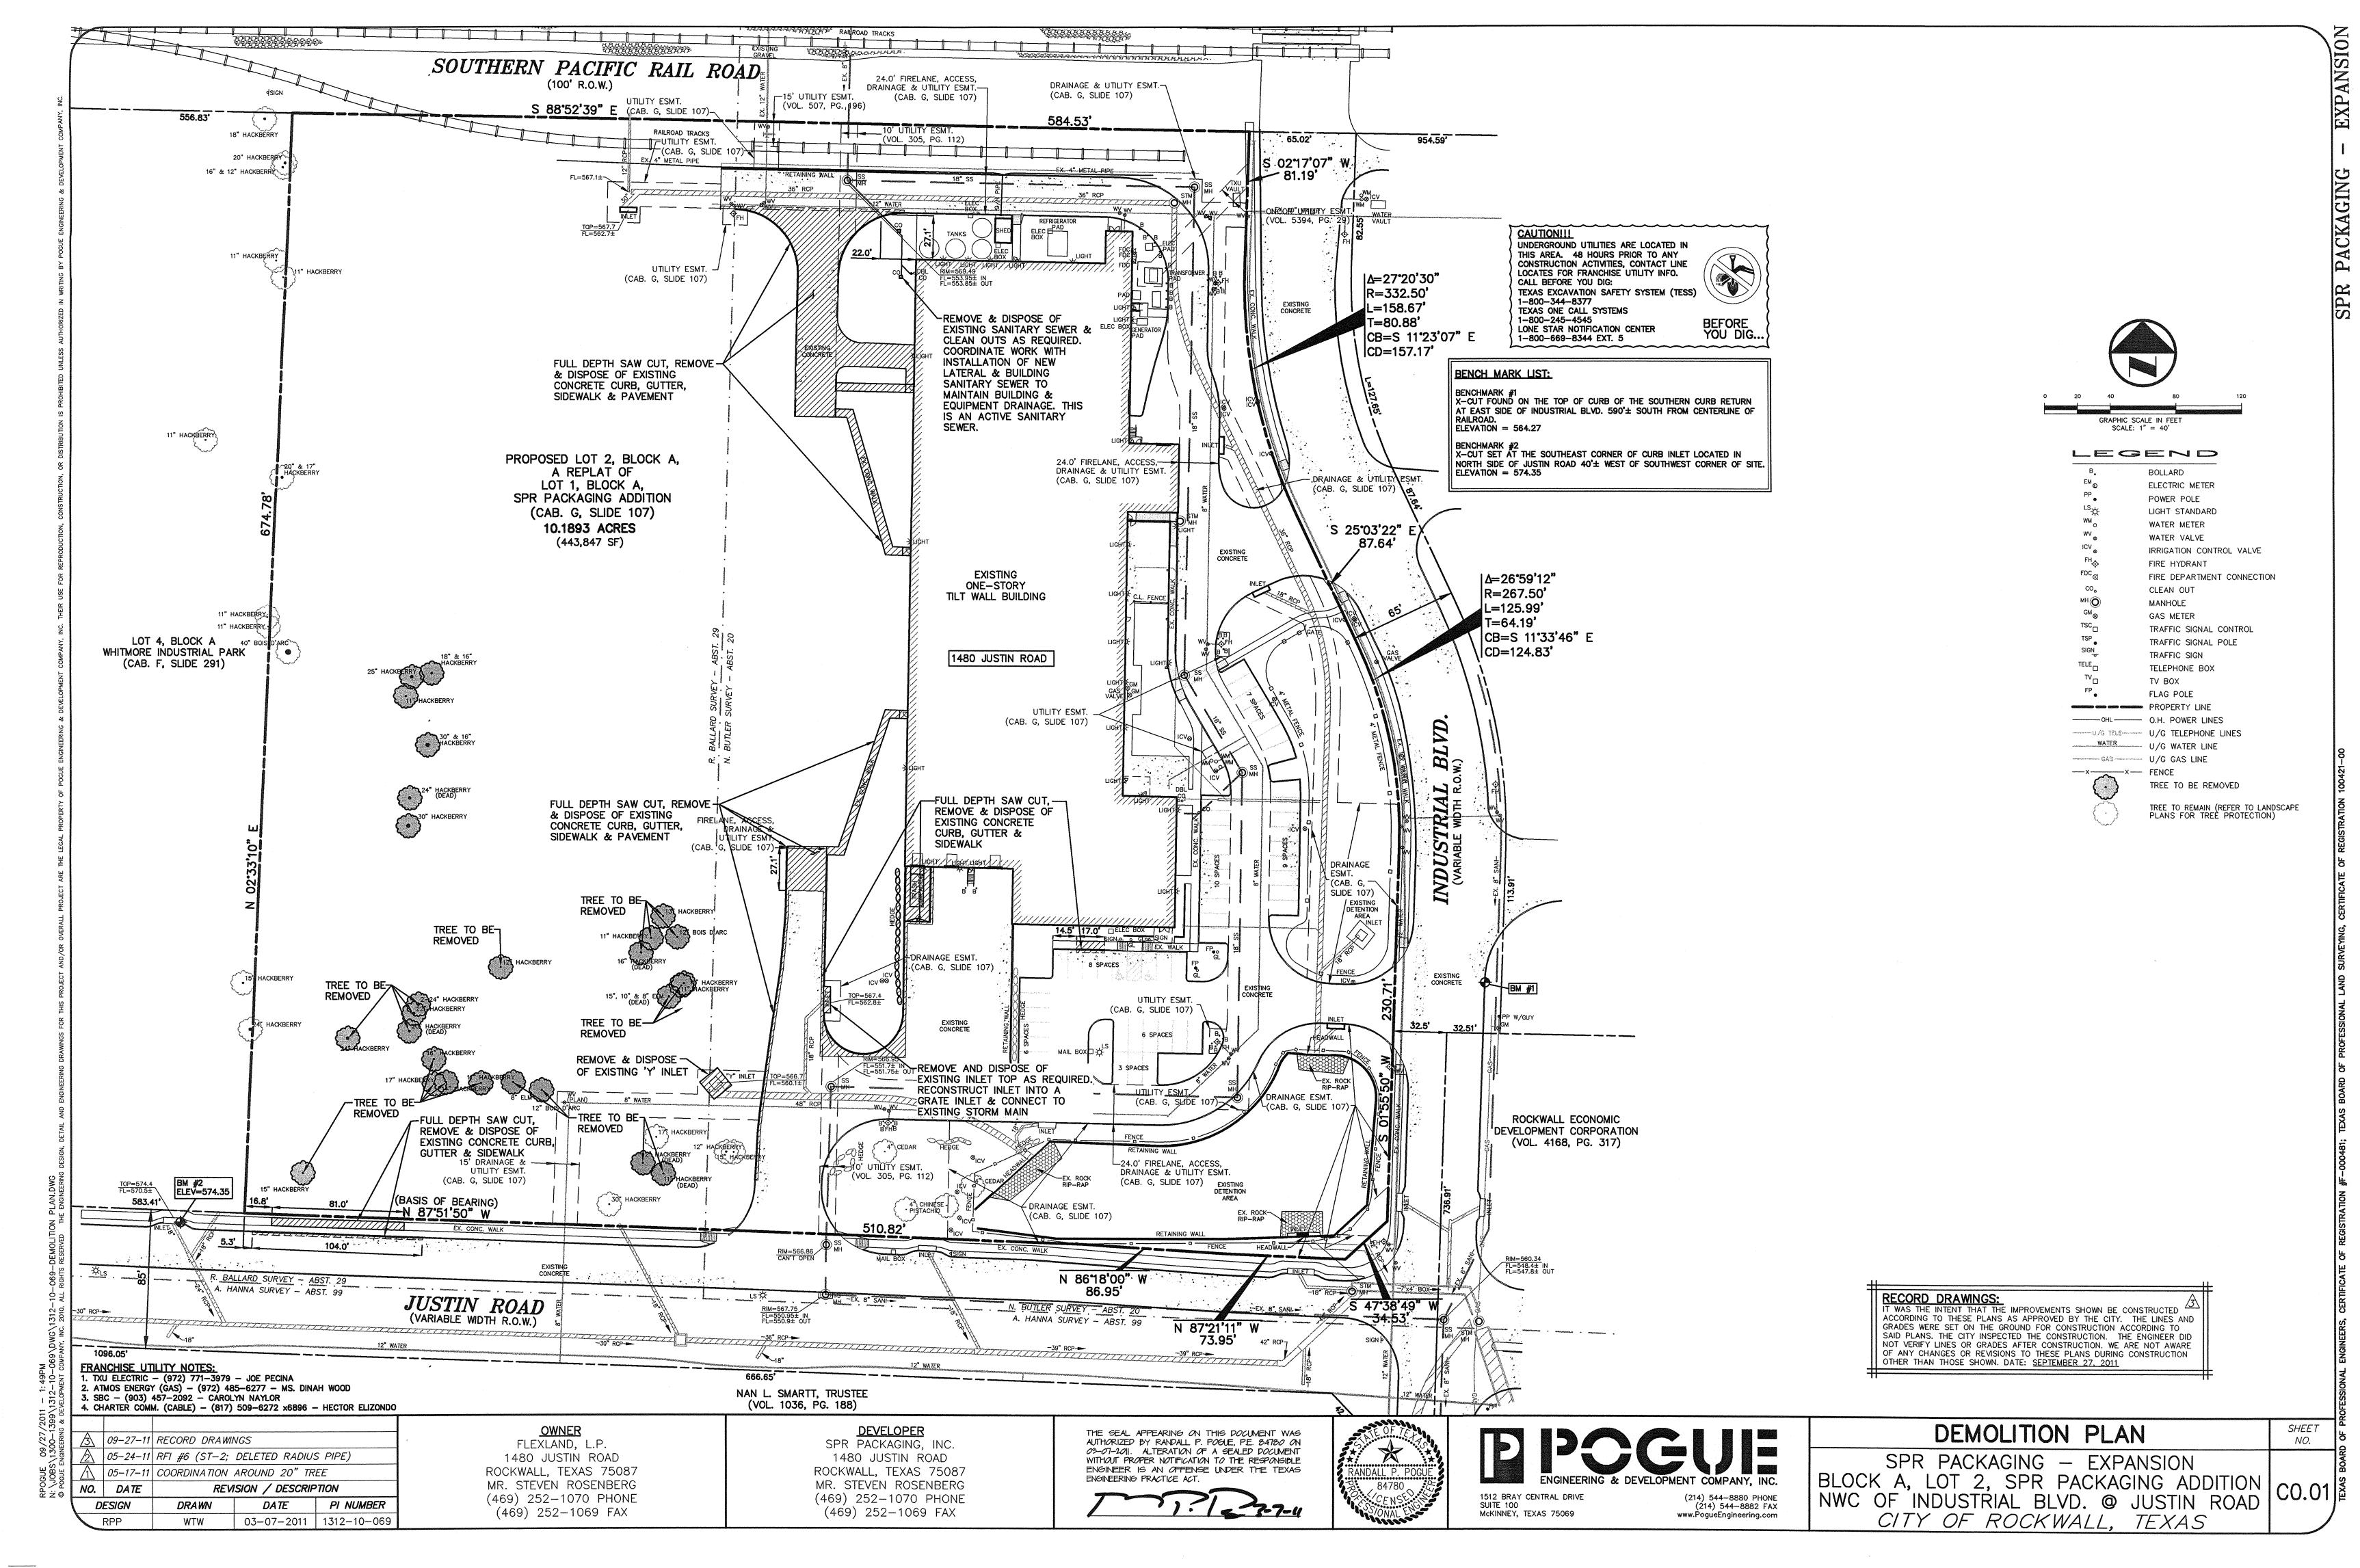

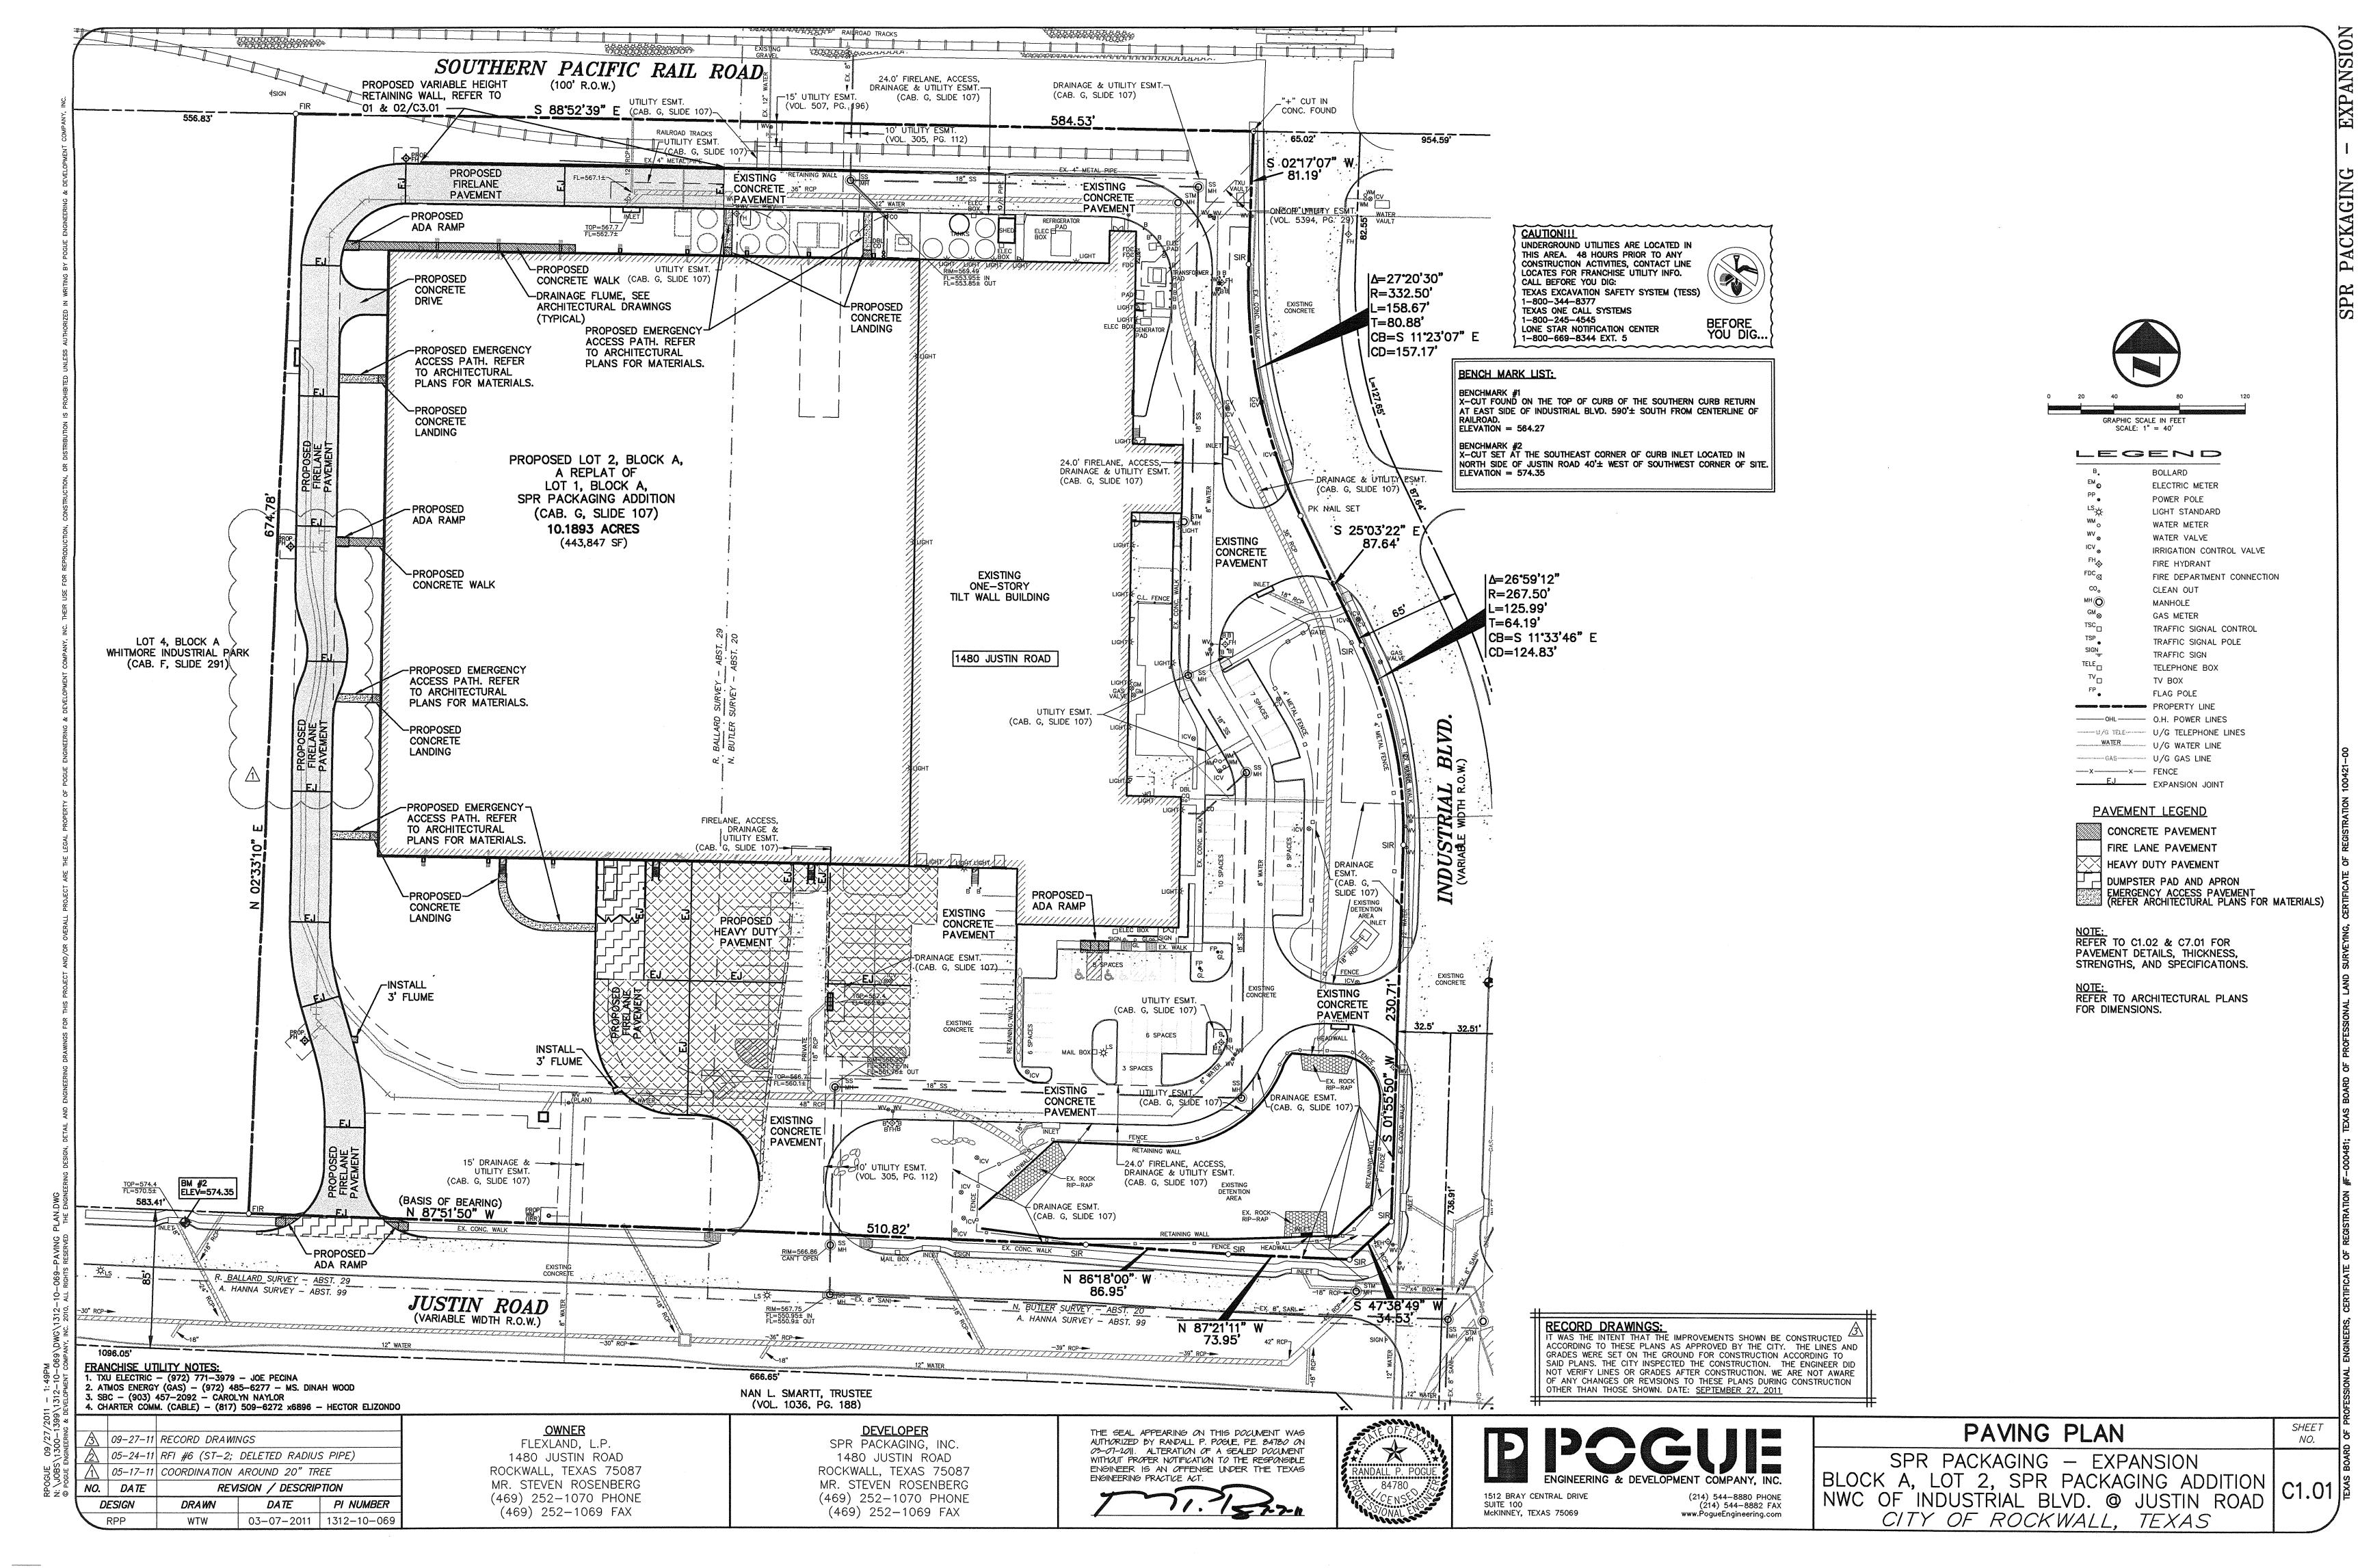

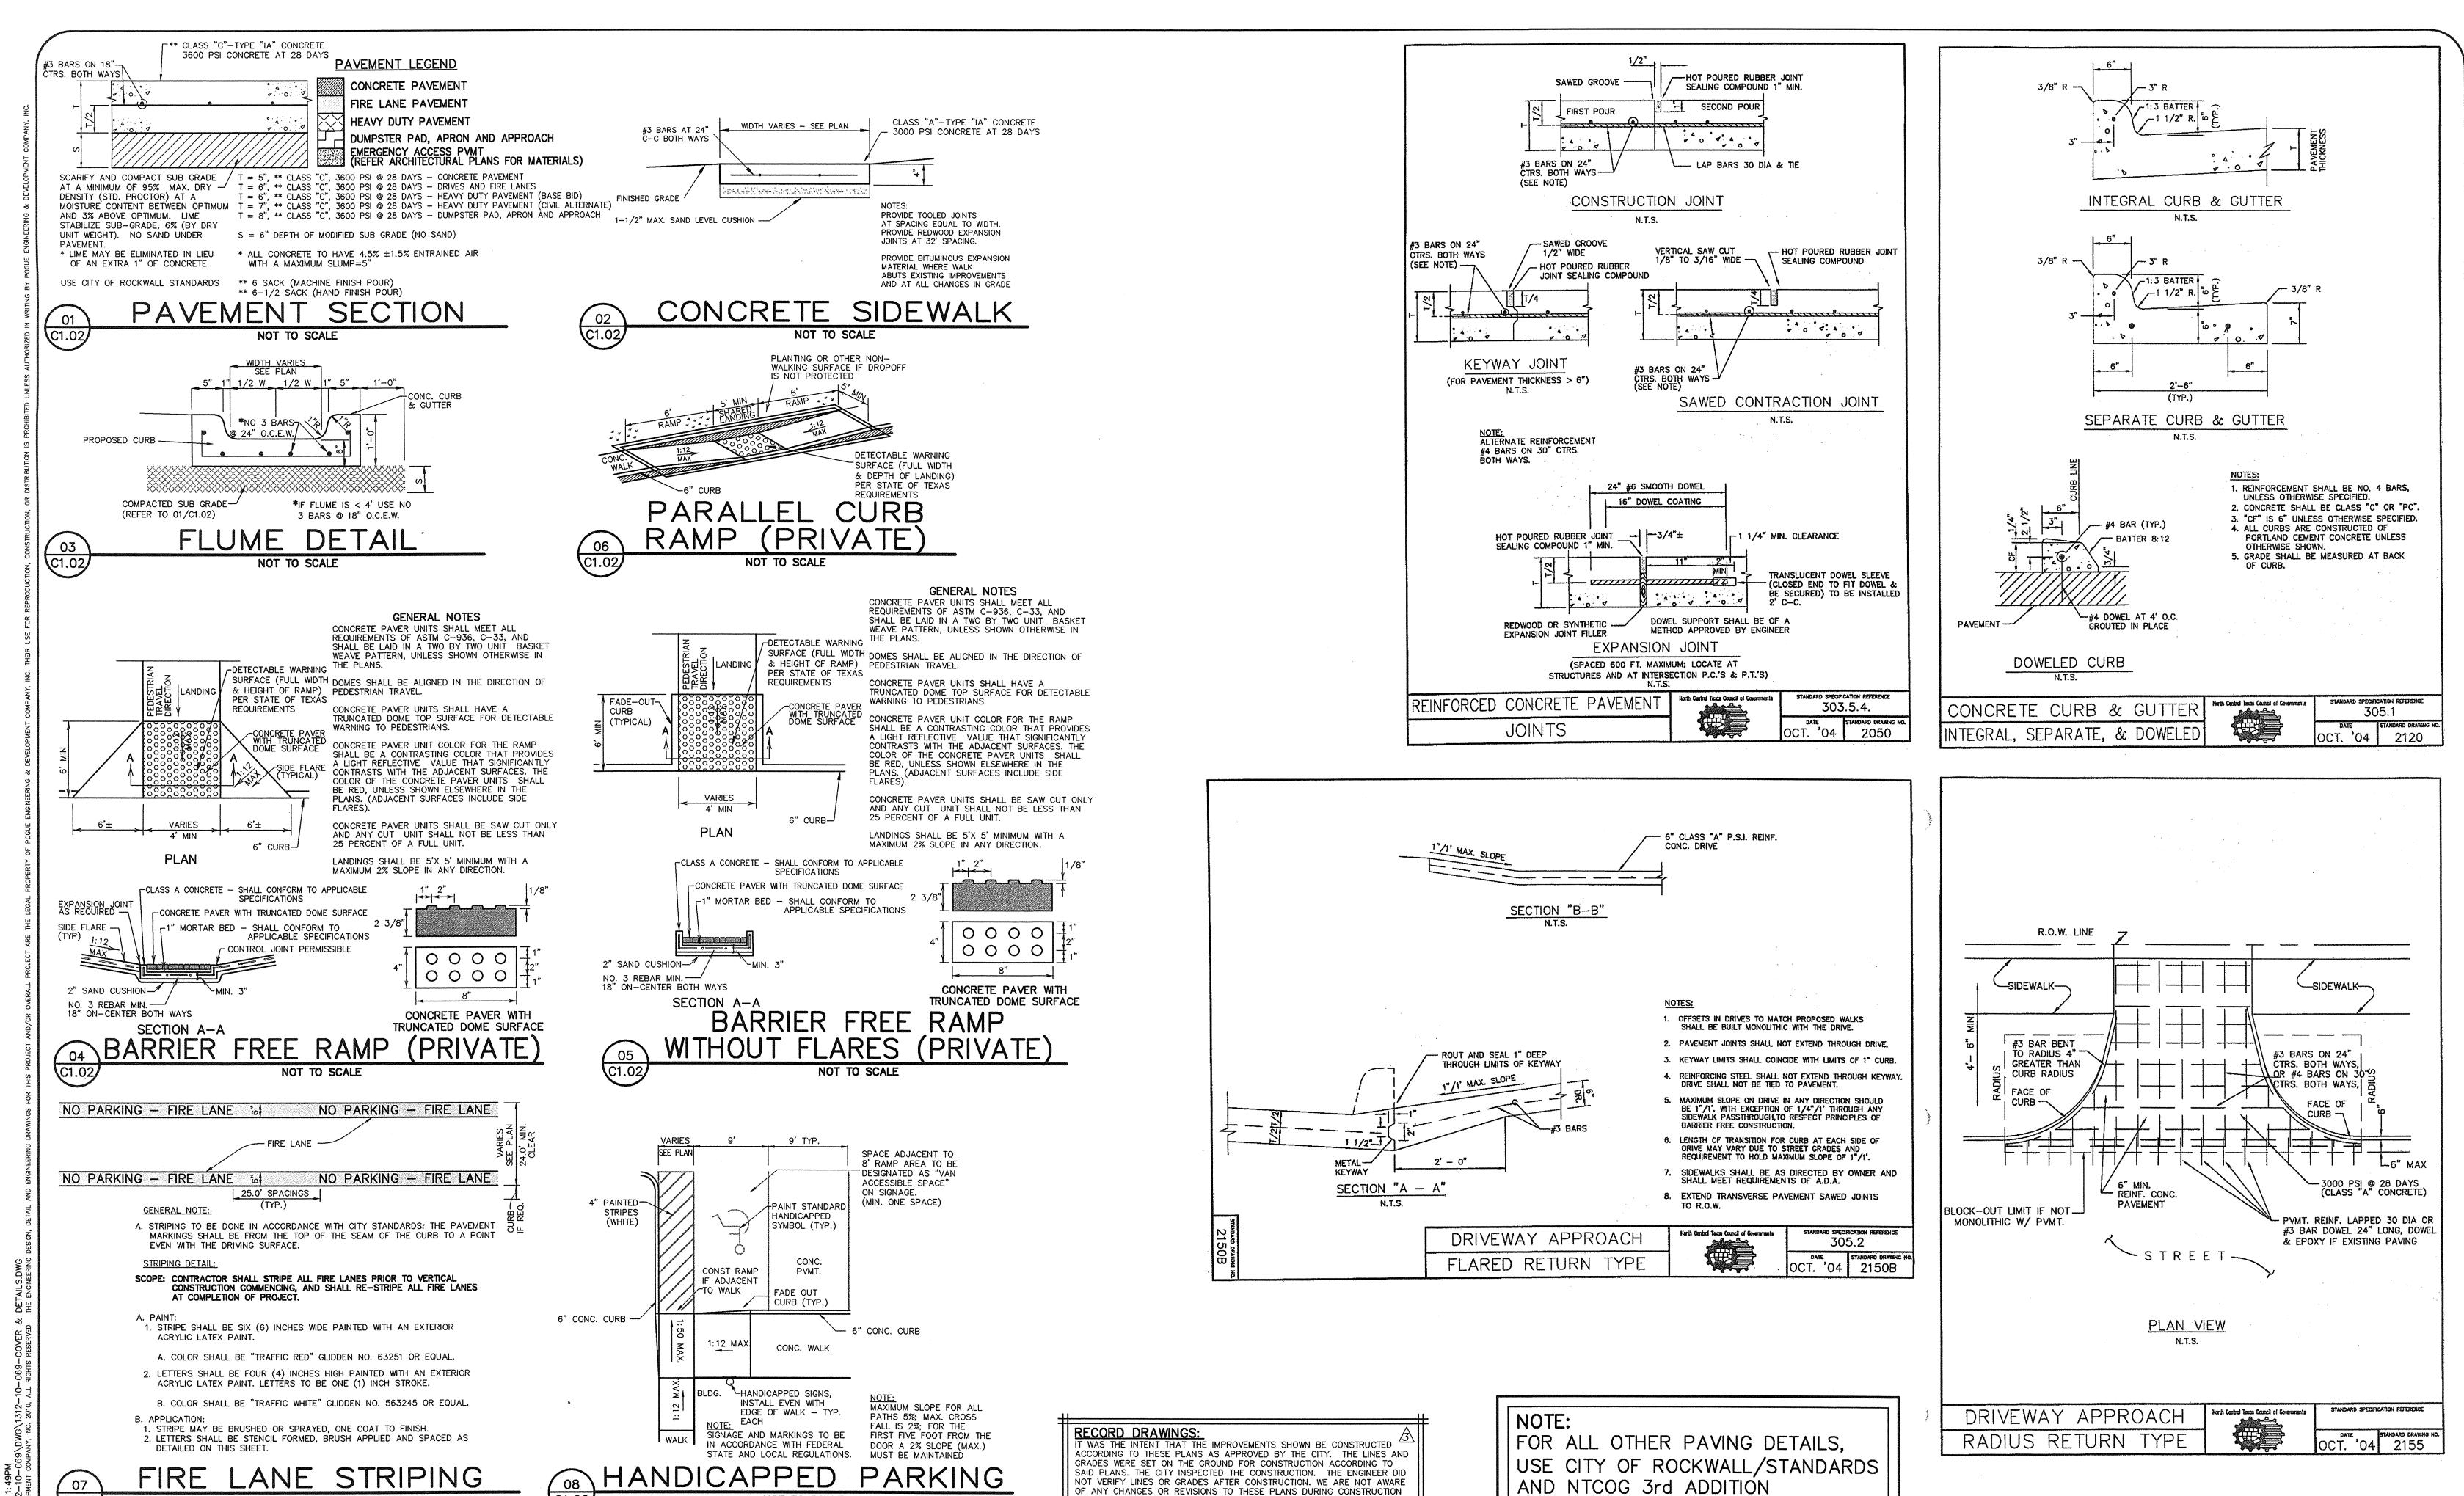C1.02

09-27-11 RECORD DRAWINGS 05-24-11 RFI #6 (ST-2; DELETED RADIUS PIPE) 05-17-11 COORDINATION AROUND 20" TREE REVISION / DESCRIPTION DESIGN DRAWN DATE PI NUMBER 03-07-2011 | 1312-10-069

NOT TO SCALE

FLEXLAND, L.P. 1480 JUSTIN ROAD ROCKWALL, TEXAS 75087 MR. STEVEN ROSENBERG (469) 252-1070 PHONE (469) 252-1069 FAX

<u>DEVELOPER</u> SPR PACKAGING, INC. 1480 JUSTIN ROAD ROCKWALL, TEXAS 75087 MR. STEVEN ROSENBERG (469) 252-1070 PHONE

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OF ANY CHANGES OR REVISIONS TO THESE PLANS DURING CONSTRUCTION

OTHER THAN THOSE SHOWN, DATE: SEPTEMBER 27, 2011







www.PogueEngineering.com


McKINNEY, TEXAS 75069


STANDARD DETAILS (PAGE 1 OF


SPR PACKAGING - EXPANSION BLOCK A, LOT 2, SPR PACKAGING ADDITION C1.02 CITY OF ROCKWALL, TEXAS

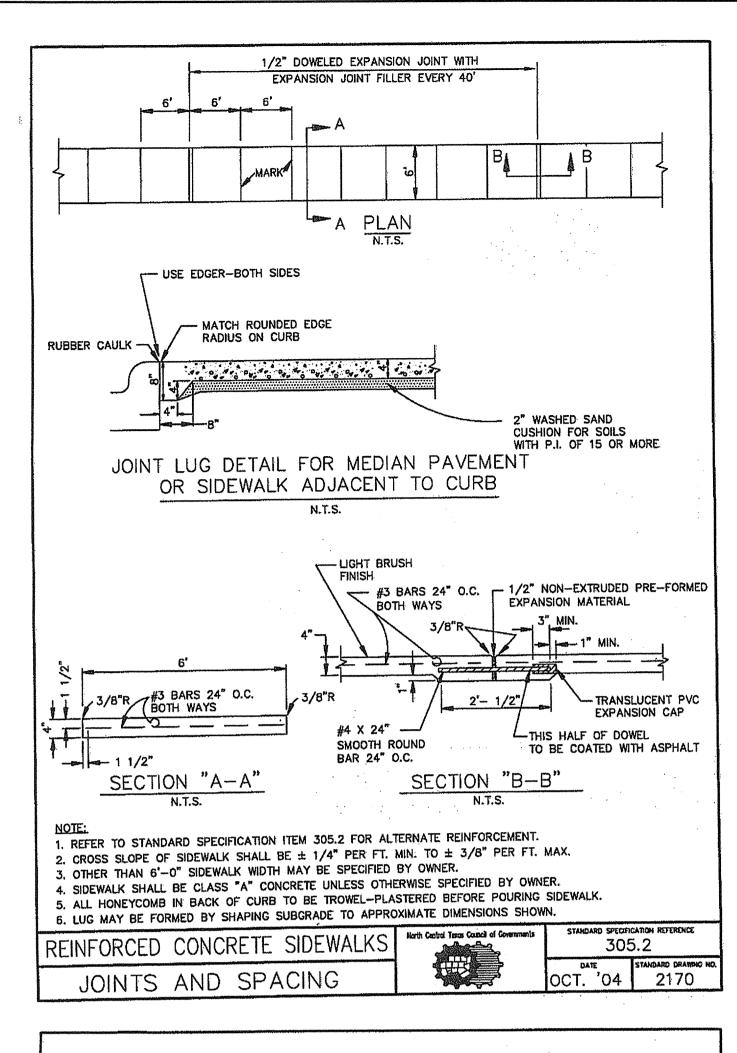

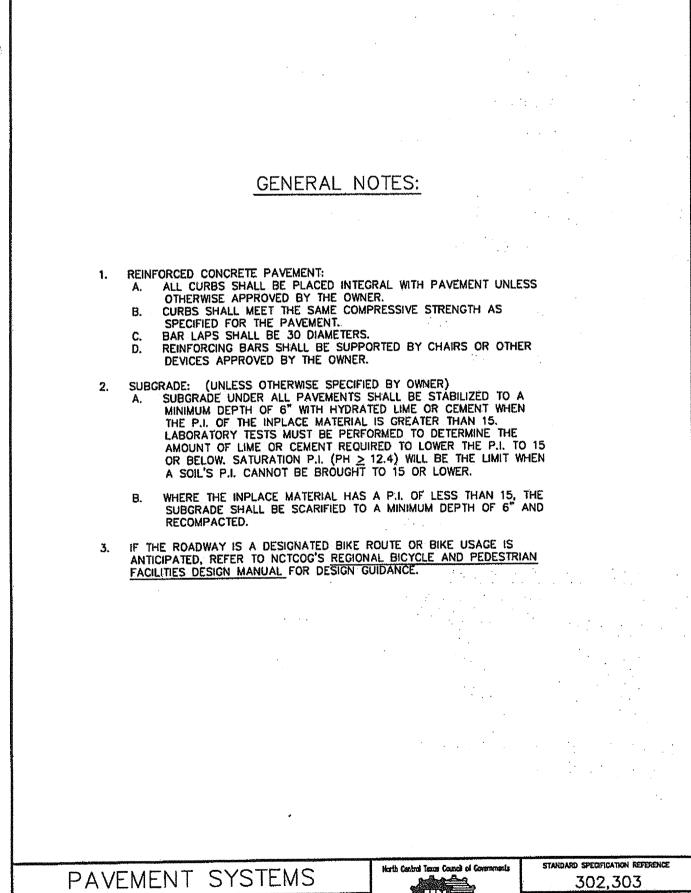

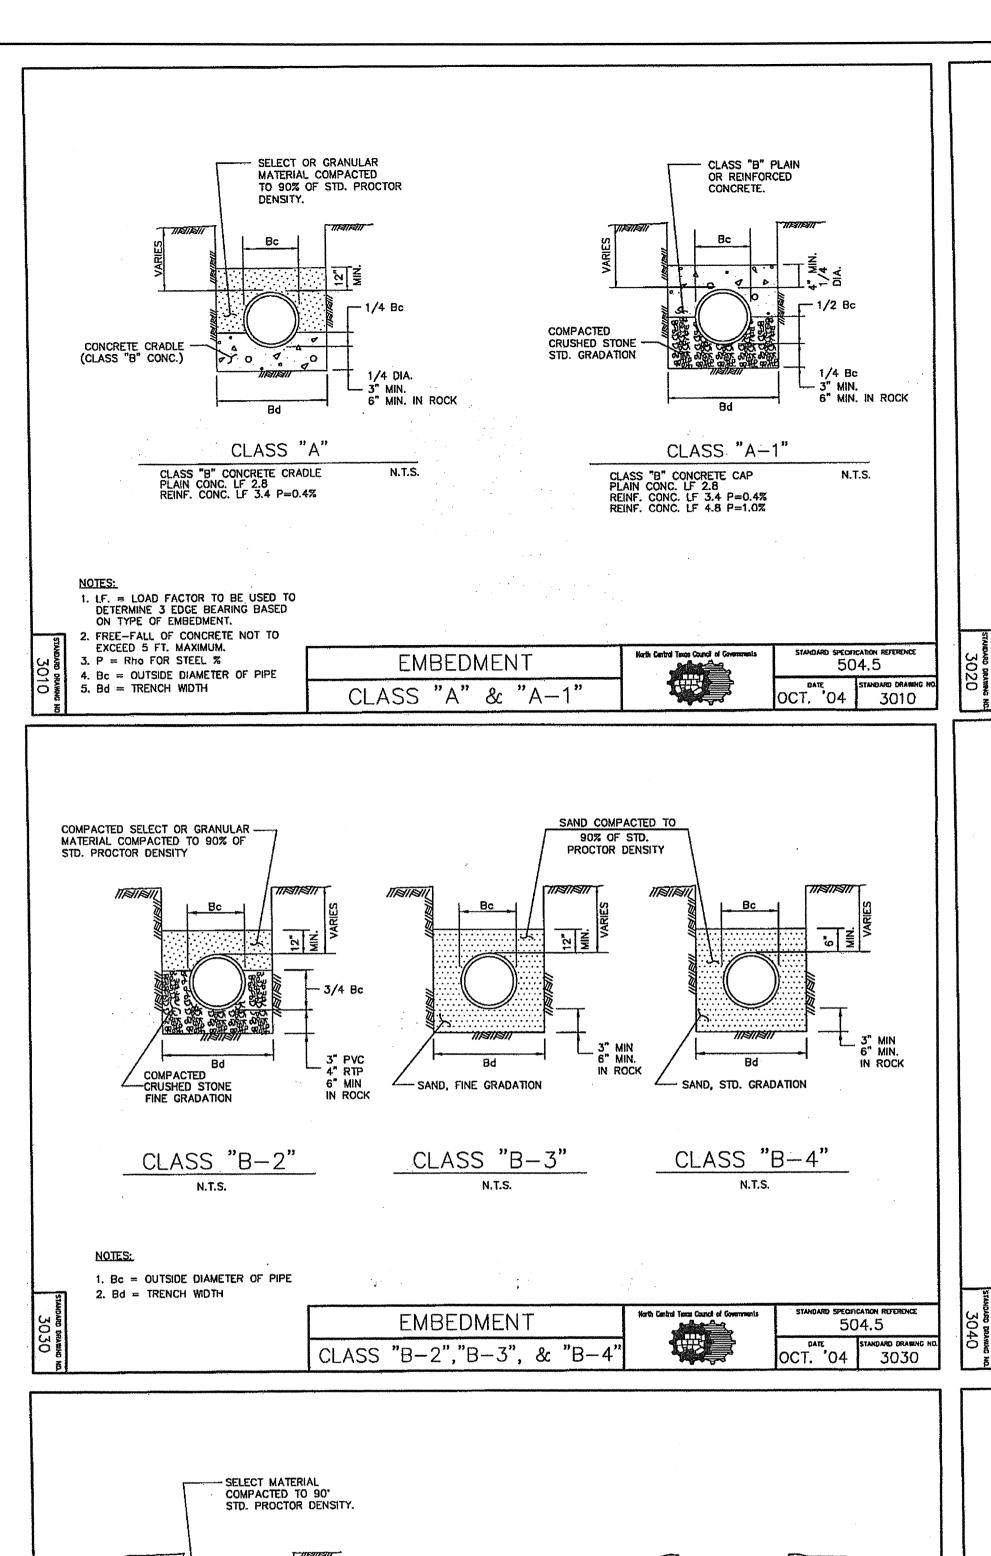

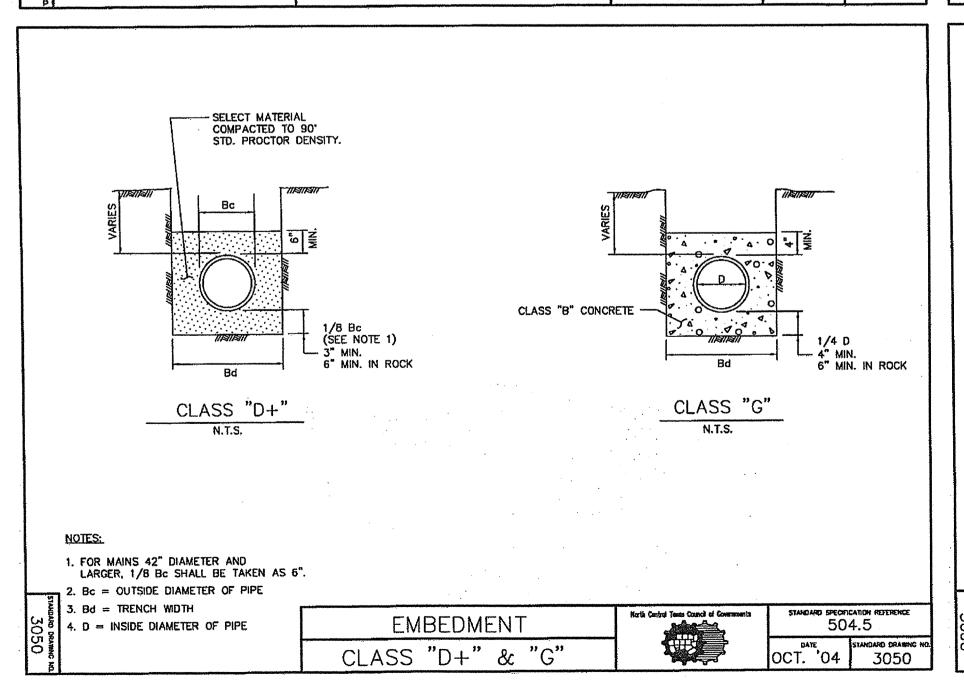

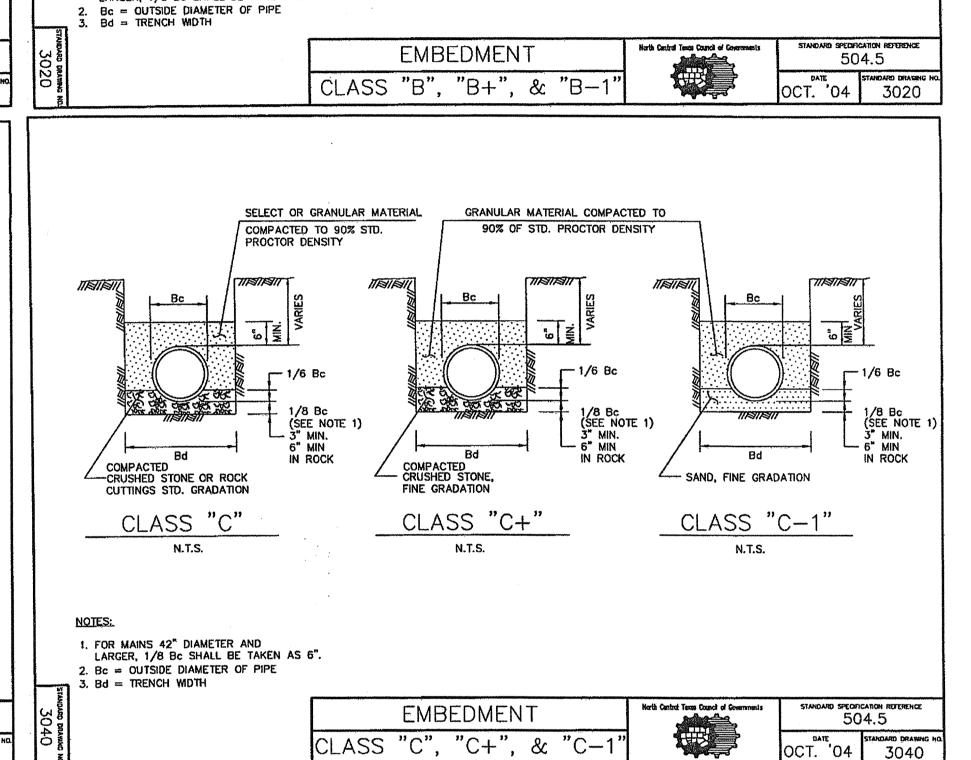

SELECT OR GRANULAR MATERIAL COMPACTED TO 90% OF STD. PROCTOR DENSITY

COMPACTED -CRUSHED STONE,

FINE GRADATION

CLASS "B+

COMPACTED

CLASS "B'

1. FOR MAINS 42" DIAMETER AND LARGER

LARGER, 1/8 Bc SHALL BE TAKEN AS 6".

- GRANULAR MATERIAL COMPACTED

TO 90% OF STD. PROCTOR DENSITY

(SEE NOTE 1)

COMPACTED - CRUSHED STONE,

FINE GRADATION

CLASS "B-1


- 3/4 Bc


(SEE NOTE 1

- 3" MIN.-PVC

OR 4" MIN,-RTP,

6" MIN. IN ROCK

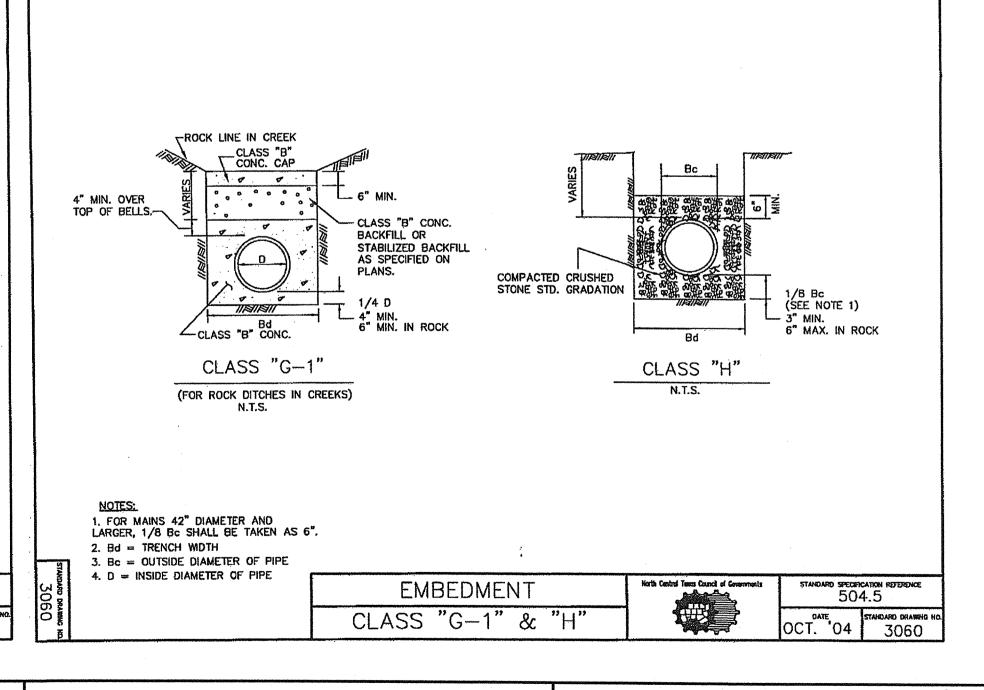

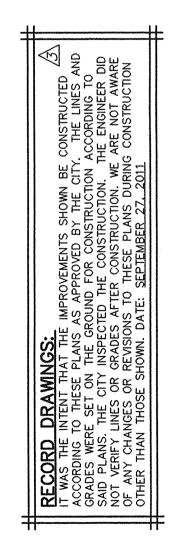

3	09-27-11	RECORD DRAWINGS		
	05-24-11	RFI #6 (ST-2; DELETED RADIUS PIPE)		
$\Lambda$	05-17-11	COORDINATION AROUND 20" TREE		
NO.	DATE	REVISION / DESCRIPTION		
DESIGN		DRAWN	DATE	PI NUMBER
RPP		WTW	03-07-2011	1312-10-069

GENERAL NOTES

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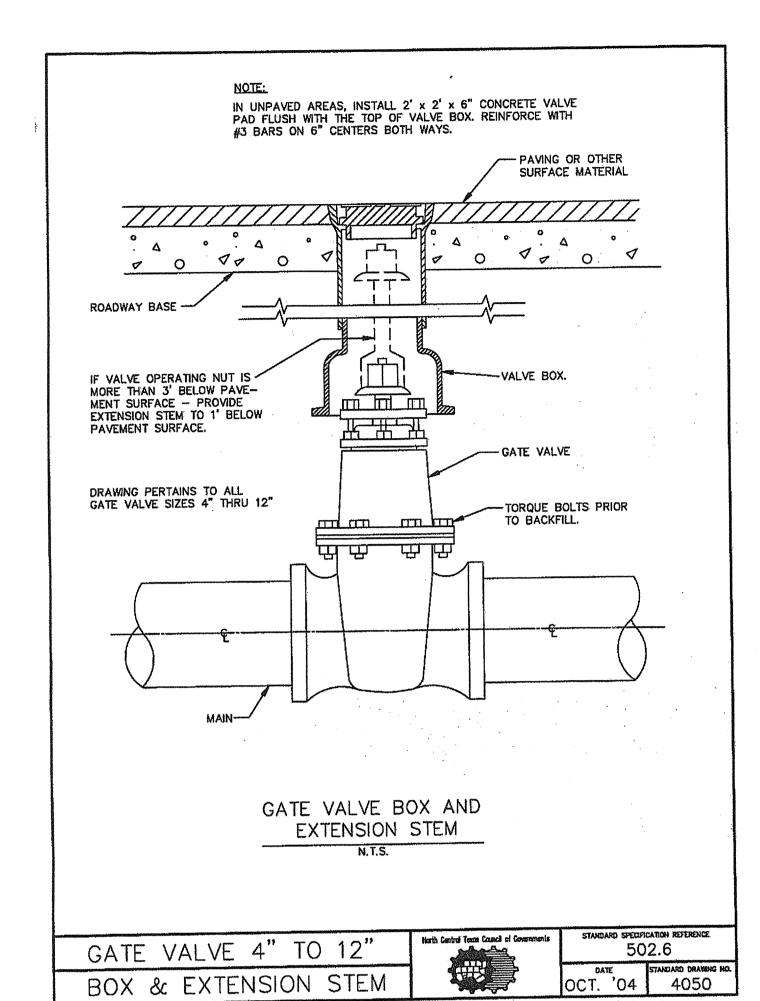






STANDARD DETAILS (PAGE 2 OF 4)


SPR PACKAGING — EXPANSION
BLOCK A, LOT 2, SPR PACKAGING ADDITION
NWC OF INDUSTRIAL BLVD. @ JUSTIN ROAD
CITY OF ROCKWALL, TEXAS







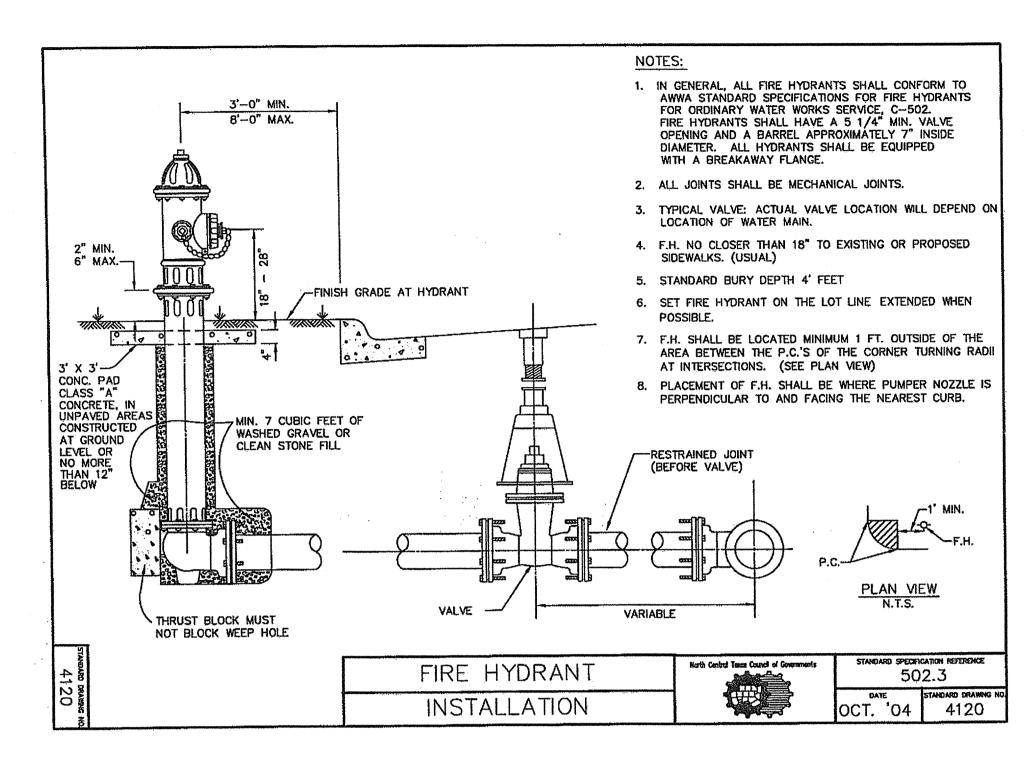


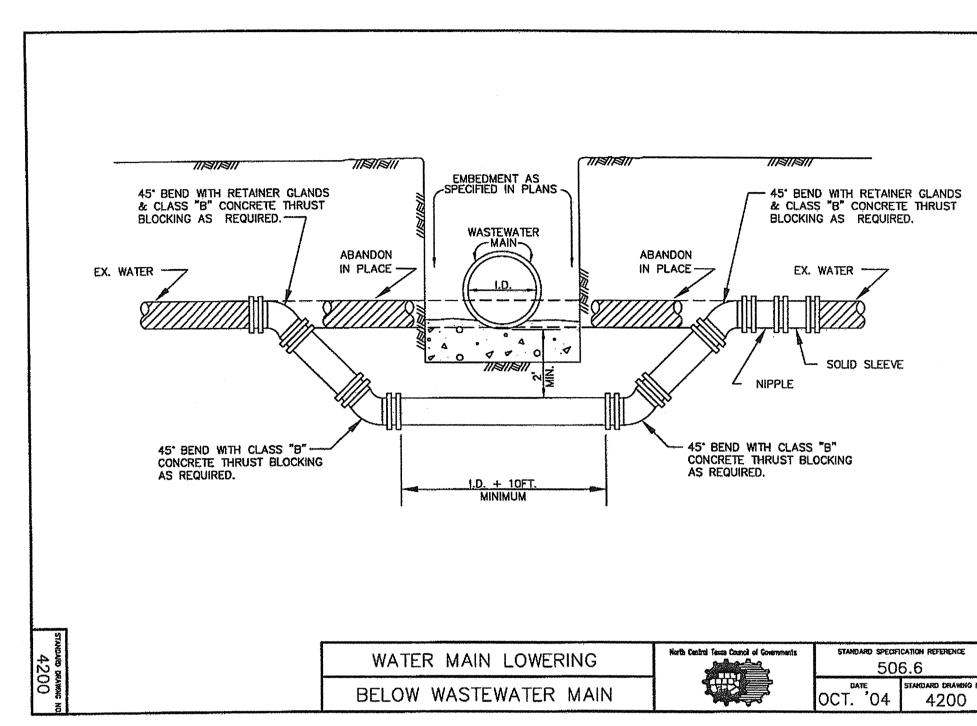


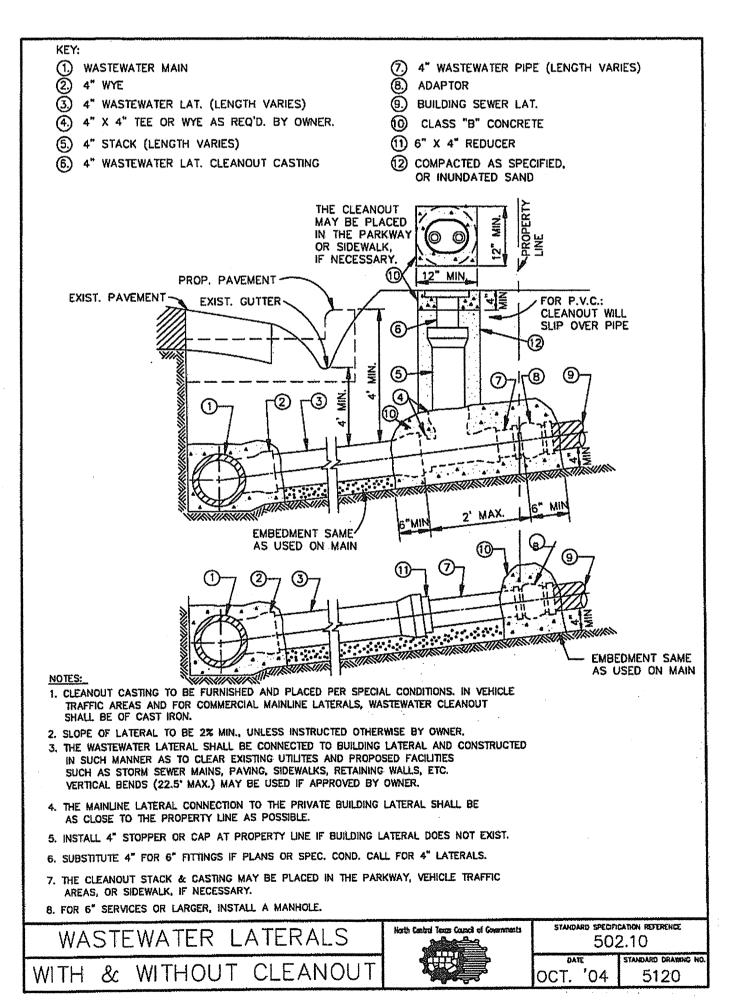

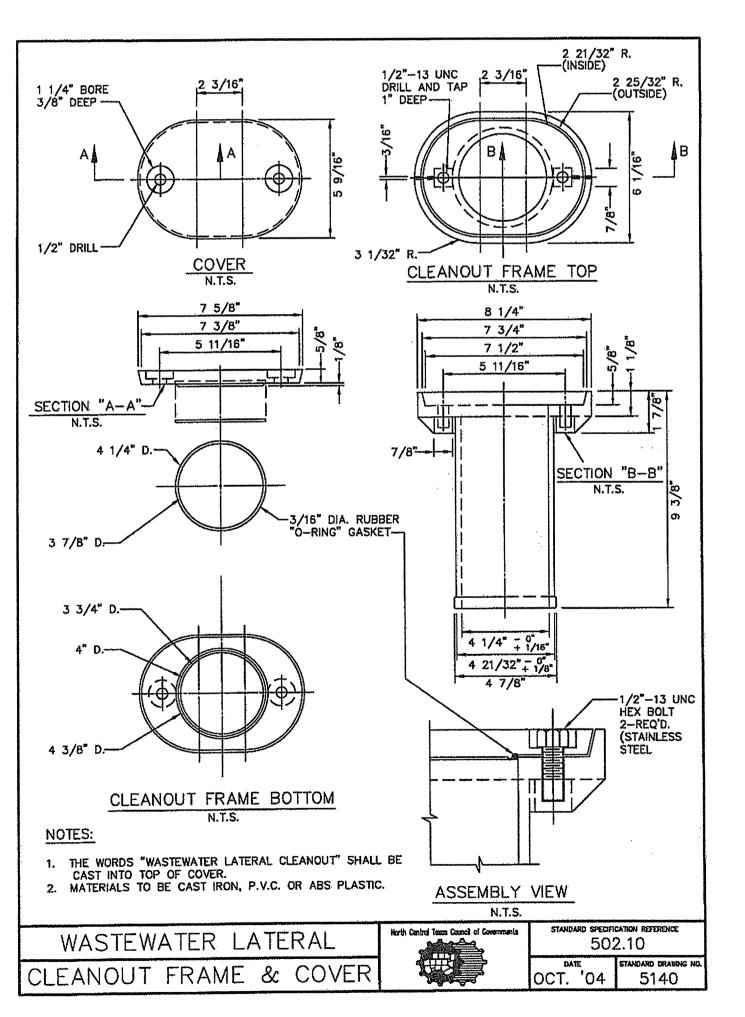

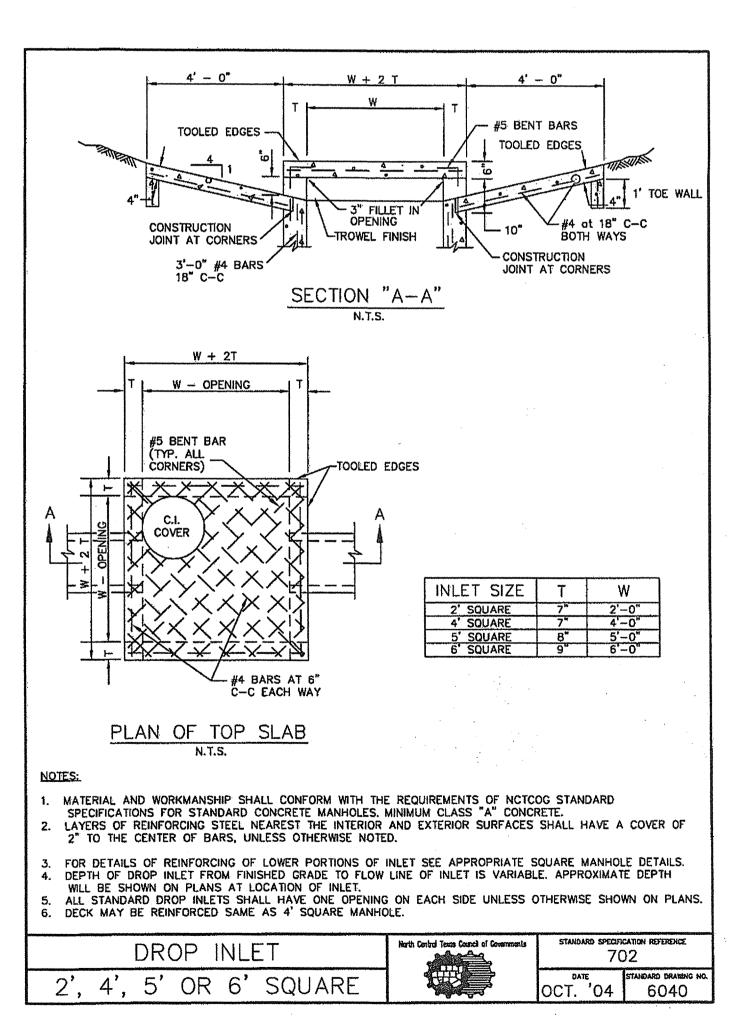

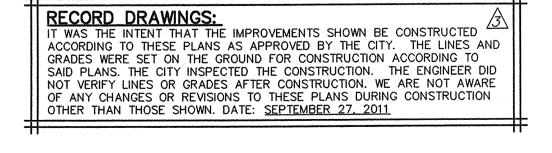


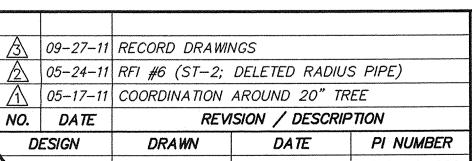

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**DEVELOPER** SPR PACKAGING, INC. 1480 JUSTIN ROAD ROCKWALL, TEXAS 75087 MR. STEVEN ROSENBERG (469) 252-1070 PHONE (469) 252-1069 FAX

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McKINNEY, TEXAS 75069

STANDARD DETAILS (PAGE 3 OF 4) SPR PACKAGING — EXPANSION
BLOCK A, LOT 2, SPR PACKAGING ADDITION
NWC OF INDUSTRIAL BLVD. @ JUSTIN ROAD
C1.04 CITY OF ROCKWALL, TEXAS

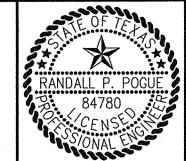RPP

03-07-2011 | 1312-10-069

\* , 84780



undard Drawing No. 2100 (Hot Mix Asphaltic Concrete Pavenment - Four Lane

(Hot Mix Asphaltic Concret

n Island Pavement

2. Median nose to have pavers installed over four (4) inch 3600 psi monolithic orced concrete base with a maximum of one (1) inch bedding sand.

street light pole bases in median are to have a thirty-six (36) inch by

2. No sidewalk adjacent to curb without City approval. Sidewalk against curb is

1. Number 2, Subgrade- replace A with revised A. Revise A. to read: Subgrade under all pavements shall be stabilized to a minimum depth of six inches (6")

Standard Drawing No. 4170 (8" Fire Line Standpipe - Service with 8" Meter)

1. Install gate valve before eight (8) inch coupling adapter.

Standard Drawing No. 4198A (Large Service Meter Vault Insta Hation)

. Gate valves shall be installed on each side of meter.

Standard Drawing No. 4200 (Water Main Lowering Below Wastewater Main)

Standard Drawing No. 5010 (Wastewater Main Tie-In at Cleanout or M H. Drawing shall be medified as follows:

1. The concrete encasement shall encase entire wastewater main.

Standard Drawing Nos. 5020, 5030, 5050, 5060 and 5080 (Wastewater Manholes)

rainer shall be installed before meter. 3. Double check valve shall be installed after meter.

Standard Drawing No. 4109 (4" Domestic Service with 3" )

3. Ductile iron should be used for all mater

2. Install double check valve after eight (8) inch blind flar age

Strainer shall be installed after aduate coupling adapter.
 Double check valve shall be installed after 4" x 3" reducer.

with hydrated lime or cement. Laboratory tests will be performed to determine

(36) inch, four (4) inch thick 3000 psi reinforced concrete mow strip.

1. Left turn lane shall have mower access ramp.

Standard Drawing Nos. 2150A and 2150B (Driveway Approach)

Alley right-of-way is twenty- (20) feet (C).
 Transition length is ten (10) feet instead of twenty (20) feet

Standard Drawing No. 2170 (Reinforced Concrete Sidewalk)

1. Maximum 1 1/2" compacted sand cushion.

the amount of lime or cement to be used.

Standard Drawing No. 2190 (Pavement Systems)

2. Number 2, Subgrade, delete B.

Pavement - 2 and 4 Lane

Nose and Left Turn Lane)

Standard Drawing No. 21

1. Delete this detail.

Standard Drawing No. 2130 (Mg

1. Delete this detail.

2. Utilize City detail.

Drawing shall be modified as follows:

five (5) feet wide.

Drawing shall be modified as follows:

3. Delete Number 3.

Drawing shall be modified as follows:

Drawing shall be modified as follow

Drawing shall be modified as follows:

Drawing shall be modified as follows:

Drawing shall be modified as follows:

Lip to be pre-cast.

4. Install by-pass line with valve.

2. Deflect water line when possible.

DIVISION 5000 WASTEWATER COLLECTION

1. "C - T" pipe adapter shall be non-shear.

1. Install green EMS dieks at all manholes.

Standard Drawing No. 5020 (Wastewater Manhole – Pre-cast)
Drawing shall be modified as follows:

Standard Drawing No. 2160 (Alley Approach)
Drawing shall be medified as follows:

1. Rockwall's alley width(W) is to

Undivided Thoroughfare)



(214) 544-8880 PHONE

STANDARD DETAILS (PAGE 4 OF 4)

SPR PACKAGING - EXPANSION BLOCK A, LOT 2, SPR PACKAGING ADDITION C1.05 NWC OF INDUSTRIAL BLVD. @ JUSTIN ROAD C1.77 OF ROCKWALL, TEXAS

05-24-11 RFI #6 (ST-2; DELETED RADIUS PIPE) 05-17-11 COORDINATION AROUND 20" TREE REVISION / DESCRIPTION NO. DATE PI NUMBER DATE DESIGN 03-07-2011 | 1312-10-069 RPP

RECORD DRAWINGS:

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GRADES WERE SET ON THE GROUND FOR CONSTRUCTION ACCORDING TO SAID PLANS. THE CITY INSPECTED THE CONSTRUCTION. THE ENGINEER DID NOT VERIFY LINES OR GRADES AFTER CONSTRUCTION. WE ARE NOT AWARE OF ANY CHANGES OR REVISIONS TO THESE PLANS DURING CONSTRUCTION OTHER THAN THOSE SHOWN. DATE: SEPTEMBER 27, 2011

> FLEXLAND, L.P. 1480 JUSTIN ROAD ROCKWALL, TEXAS 75087 MR. STEVEN ROSENBERG (469) 252-1070 PHONE (469) 252-1069 FAX

<u>DEVELOPER</u> SPR PACKAGING. INC. 1480 JUSTIN ROAD ROCKWALL, TEXAS 75087 MR. STEVEN ROSENBERG (469) 252-1070 PHONE (469) 252-1069 FAX

Service pipe to be SDR 9 (no copper).

Standard Drawing No. 4120 (Fire Hydrant Installation)

1. All joints are to be restrained. Mega-lug or approved equal.

Drawing shall be modified as follows:

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ENGINEER IS AN OFFENSE UNDER THE TEXAS

Standard Prawing Nos. 2220, 2230, 2240, 2250 (Alley Geometries)

1. Rockwall's alley width (W) is tw

**DIVISION 3000 GENERAL UNDERGROUND CONDUIT** 

Standard Drawing No. 3010 (Embedment - Class "A" and "A-1")

2. Class "A-1" Embedment- crushed stone 3/4 Bc.

1. Material to be compacted to 95% of Standard Proctor.

Standard Drawing No. 3020 (Embedment - Class "B", "B+", "B-1")

1. No granular material above rock or stone embedment.

2. Class "B" Embedment to be used for RCP storm sewer pipe.

Standard Drawing No. 3030 (Embedment - Class "B-2", "B-3" and "B-4")

1. No granular material above rock or stone embedment.

2. Class "B-3" Embedment to be used for PVC water pipe.

5. Class "B-3" and "B-4" - Compact sand to 95% Std. Proctor.

Standard Drawing No. 3040 (Embedment - Class "C", "C+", and "C-1")

1. No granular material above rock or stone embedment.

Standard Drawing No. 5040 (Wastewater Manhole - Fiberglass)

Standard Drawing No. 5110 (Wastewater Main- Cleanout)

Standard Drawing No. 5070 (Wastewater Manhole Outside Derop Connection)

Standard Drawing No. 5120 (Wastewater Laterals With and Without Cleanout)

2. Green EMS disk shall be installed at cleanout or end of lateral.

Standard Drawing No. 5130 (Wastewater Laterals- In Earth and In Rock)

Standard Drawing No. 5166 (Wastewater Lateral Replacement in Advance of Paving)

3. Cleanout shall be cast iron sewer cleanout, Type Trinity Valley, Pattern 1684 or

4. If cleanout is installed in roadway or parking area then traffic cleanout shall be

3. Class "C-1" - Compact granular material to 95% Std. Proctor.

and replace with crushed stone- fine gradation.

3. Material above crushed stone is to be non-granular compacted material.

Standard Proctor. Select non-granular material above embedment.

4. Class "B+" - Non-granular material to be compacted to 95% Std. Proctor.

3. Class "B" and "B-1" - Select non-granular material to be compacted to 95%

3. Class "B-2" - Delete compacted select or granular material above crushed stone

2. Class "C" and "C+" - Compact select non-granular material to 95% Std. Proctor.

4. Modified Class "B-2" Embedment to be used for PVC sanitary sewer pipe.

2. Alley right-of-way is

B = four (4) feet.

Drawing shall be modified as follows:

1. Delete this detail.

Drawing shall be modified as follows

Drawing shall be modified as follows:

Wyes only, no tees.

1. Replace with City Detail.

PVC pipe only. No clay pipe.

designed to handle traffic loads.

Standard Drawing No. 5150 (Westewater Lateral Stub Out

stall green EMS disk at property line.

1. Install green EMS disk at end of latera

1. Delete this detail.

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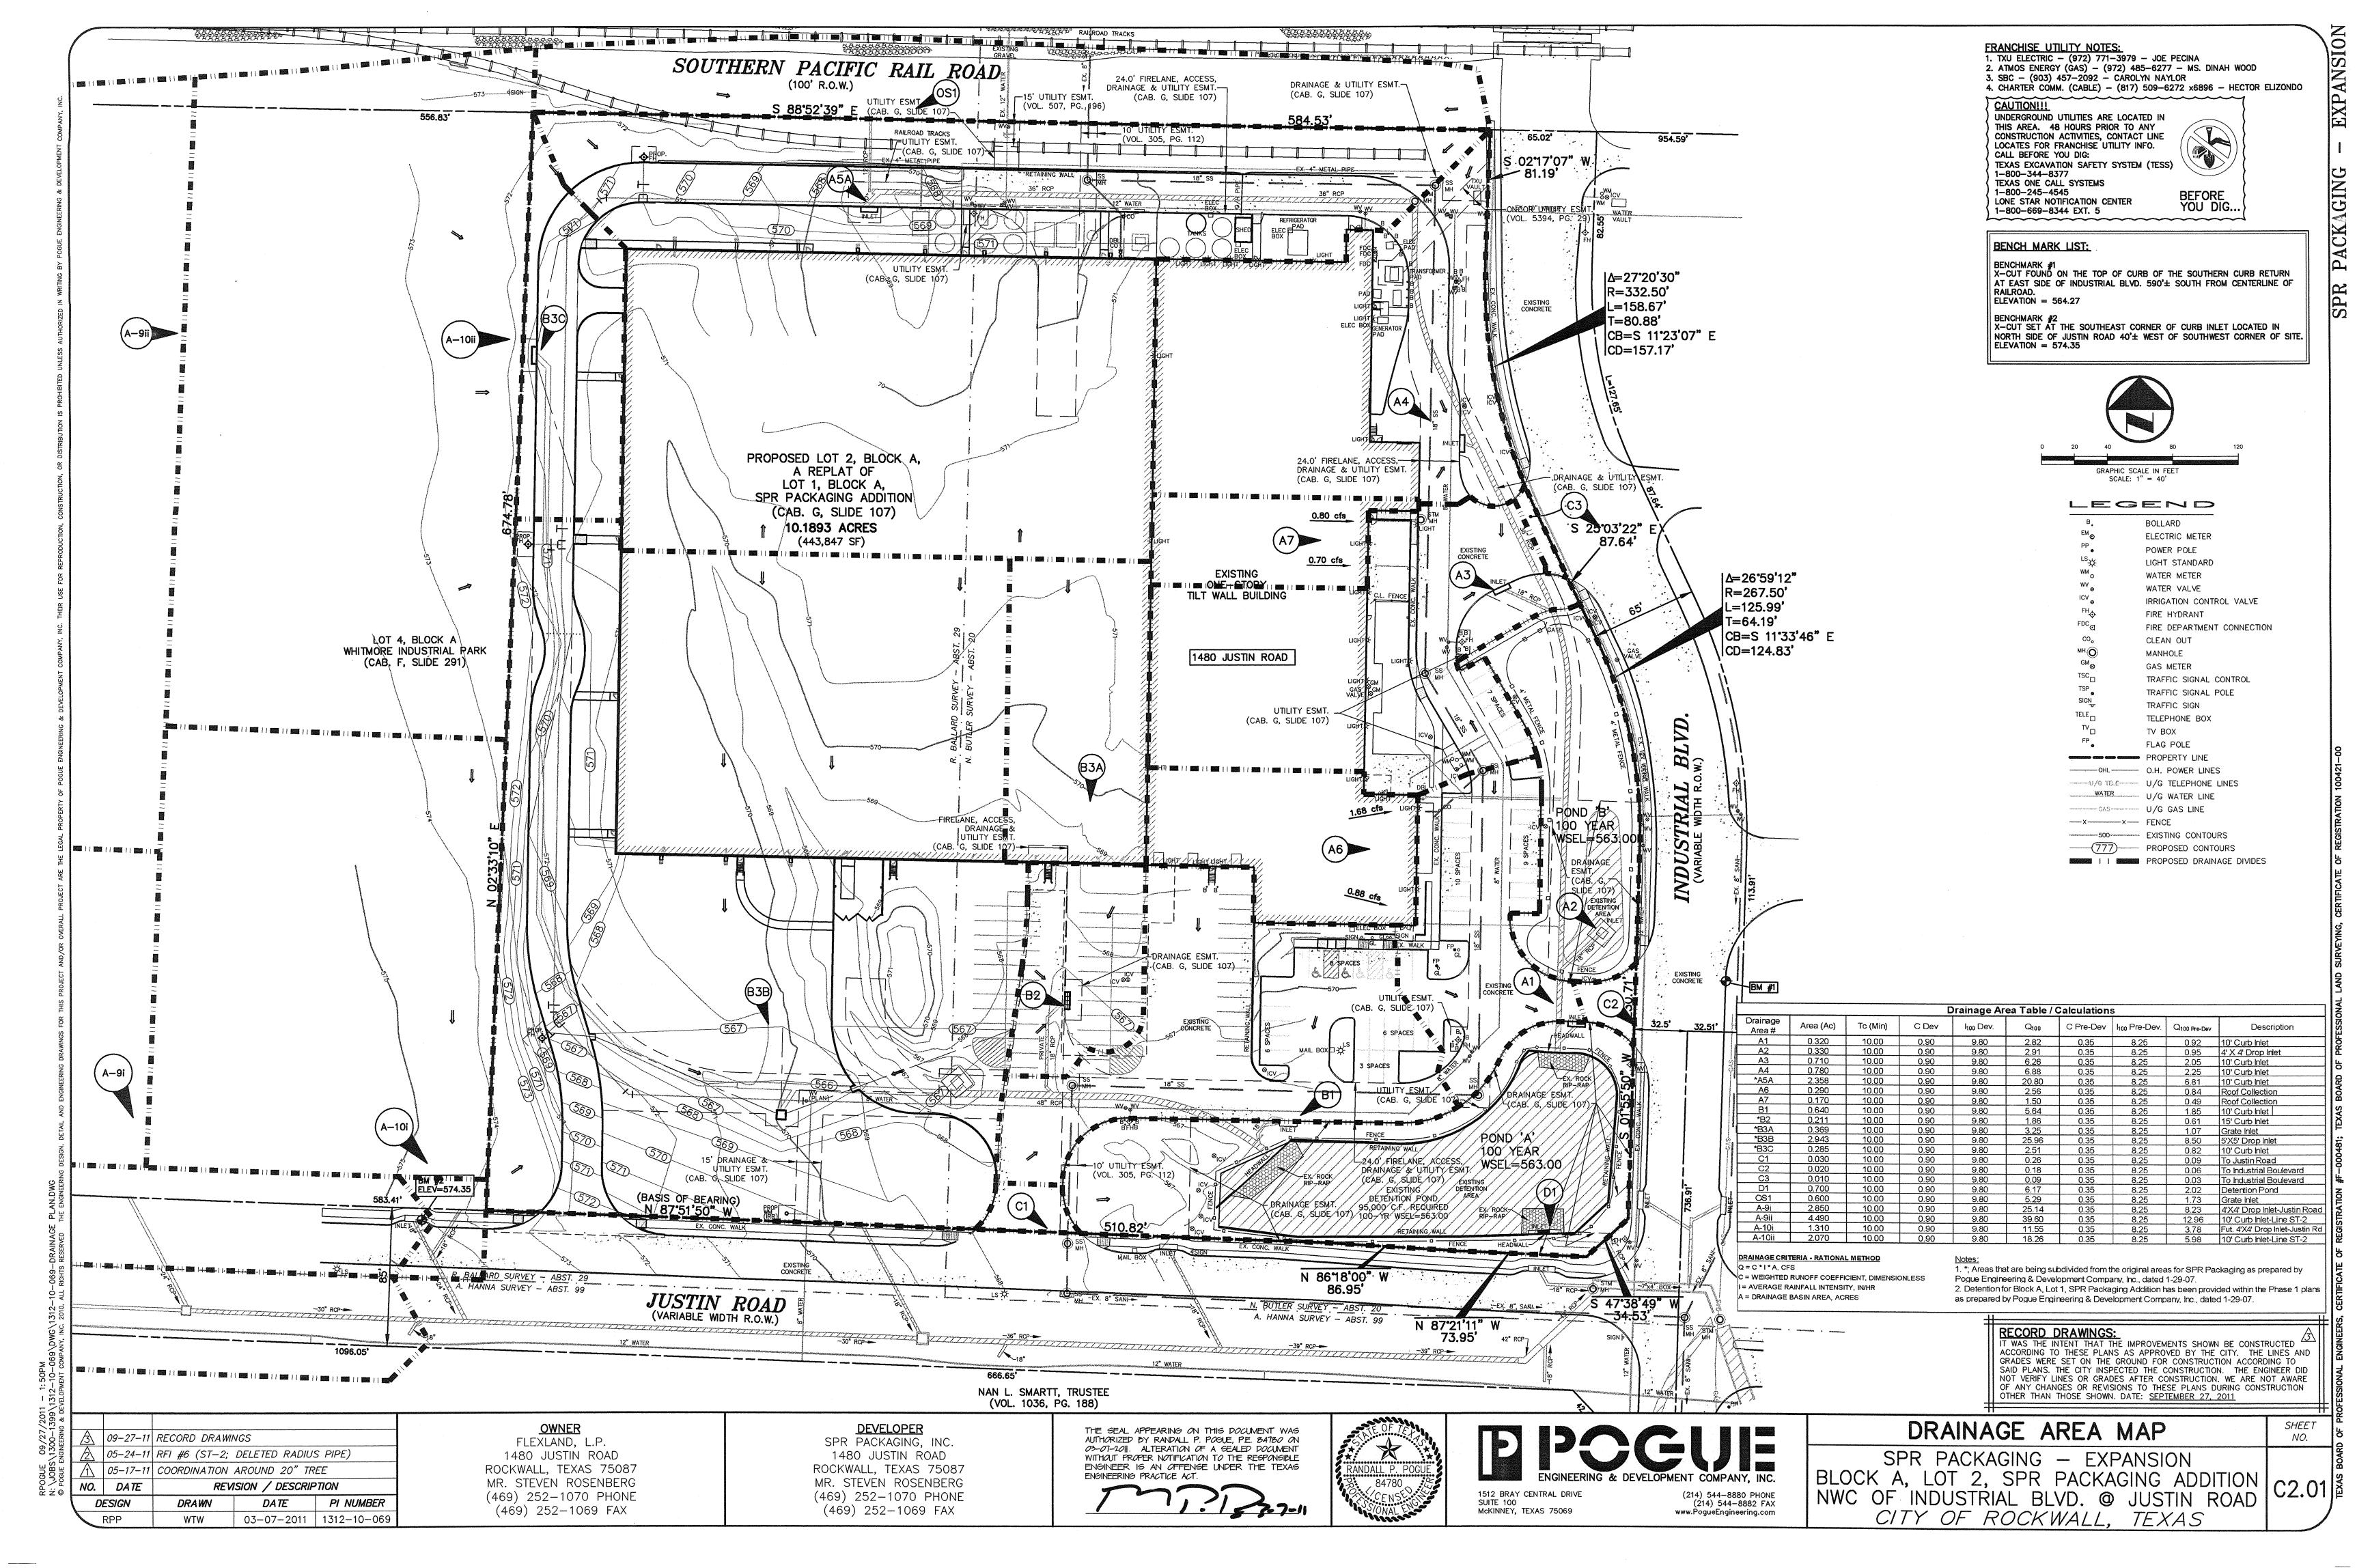
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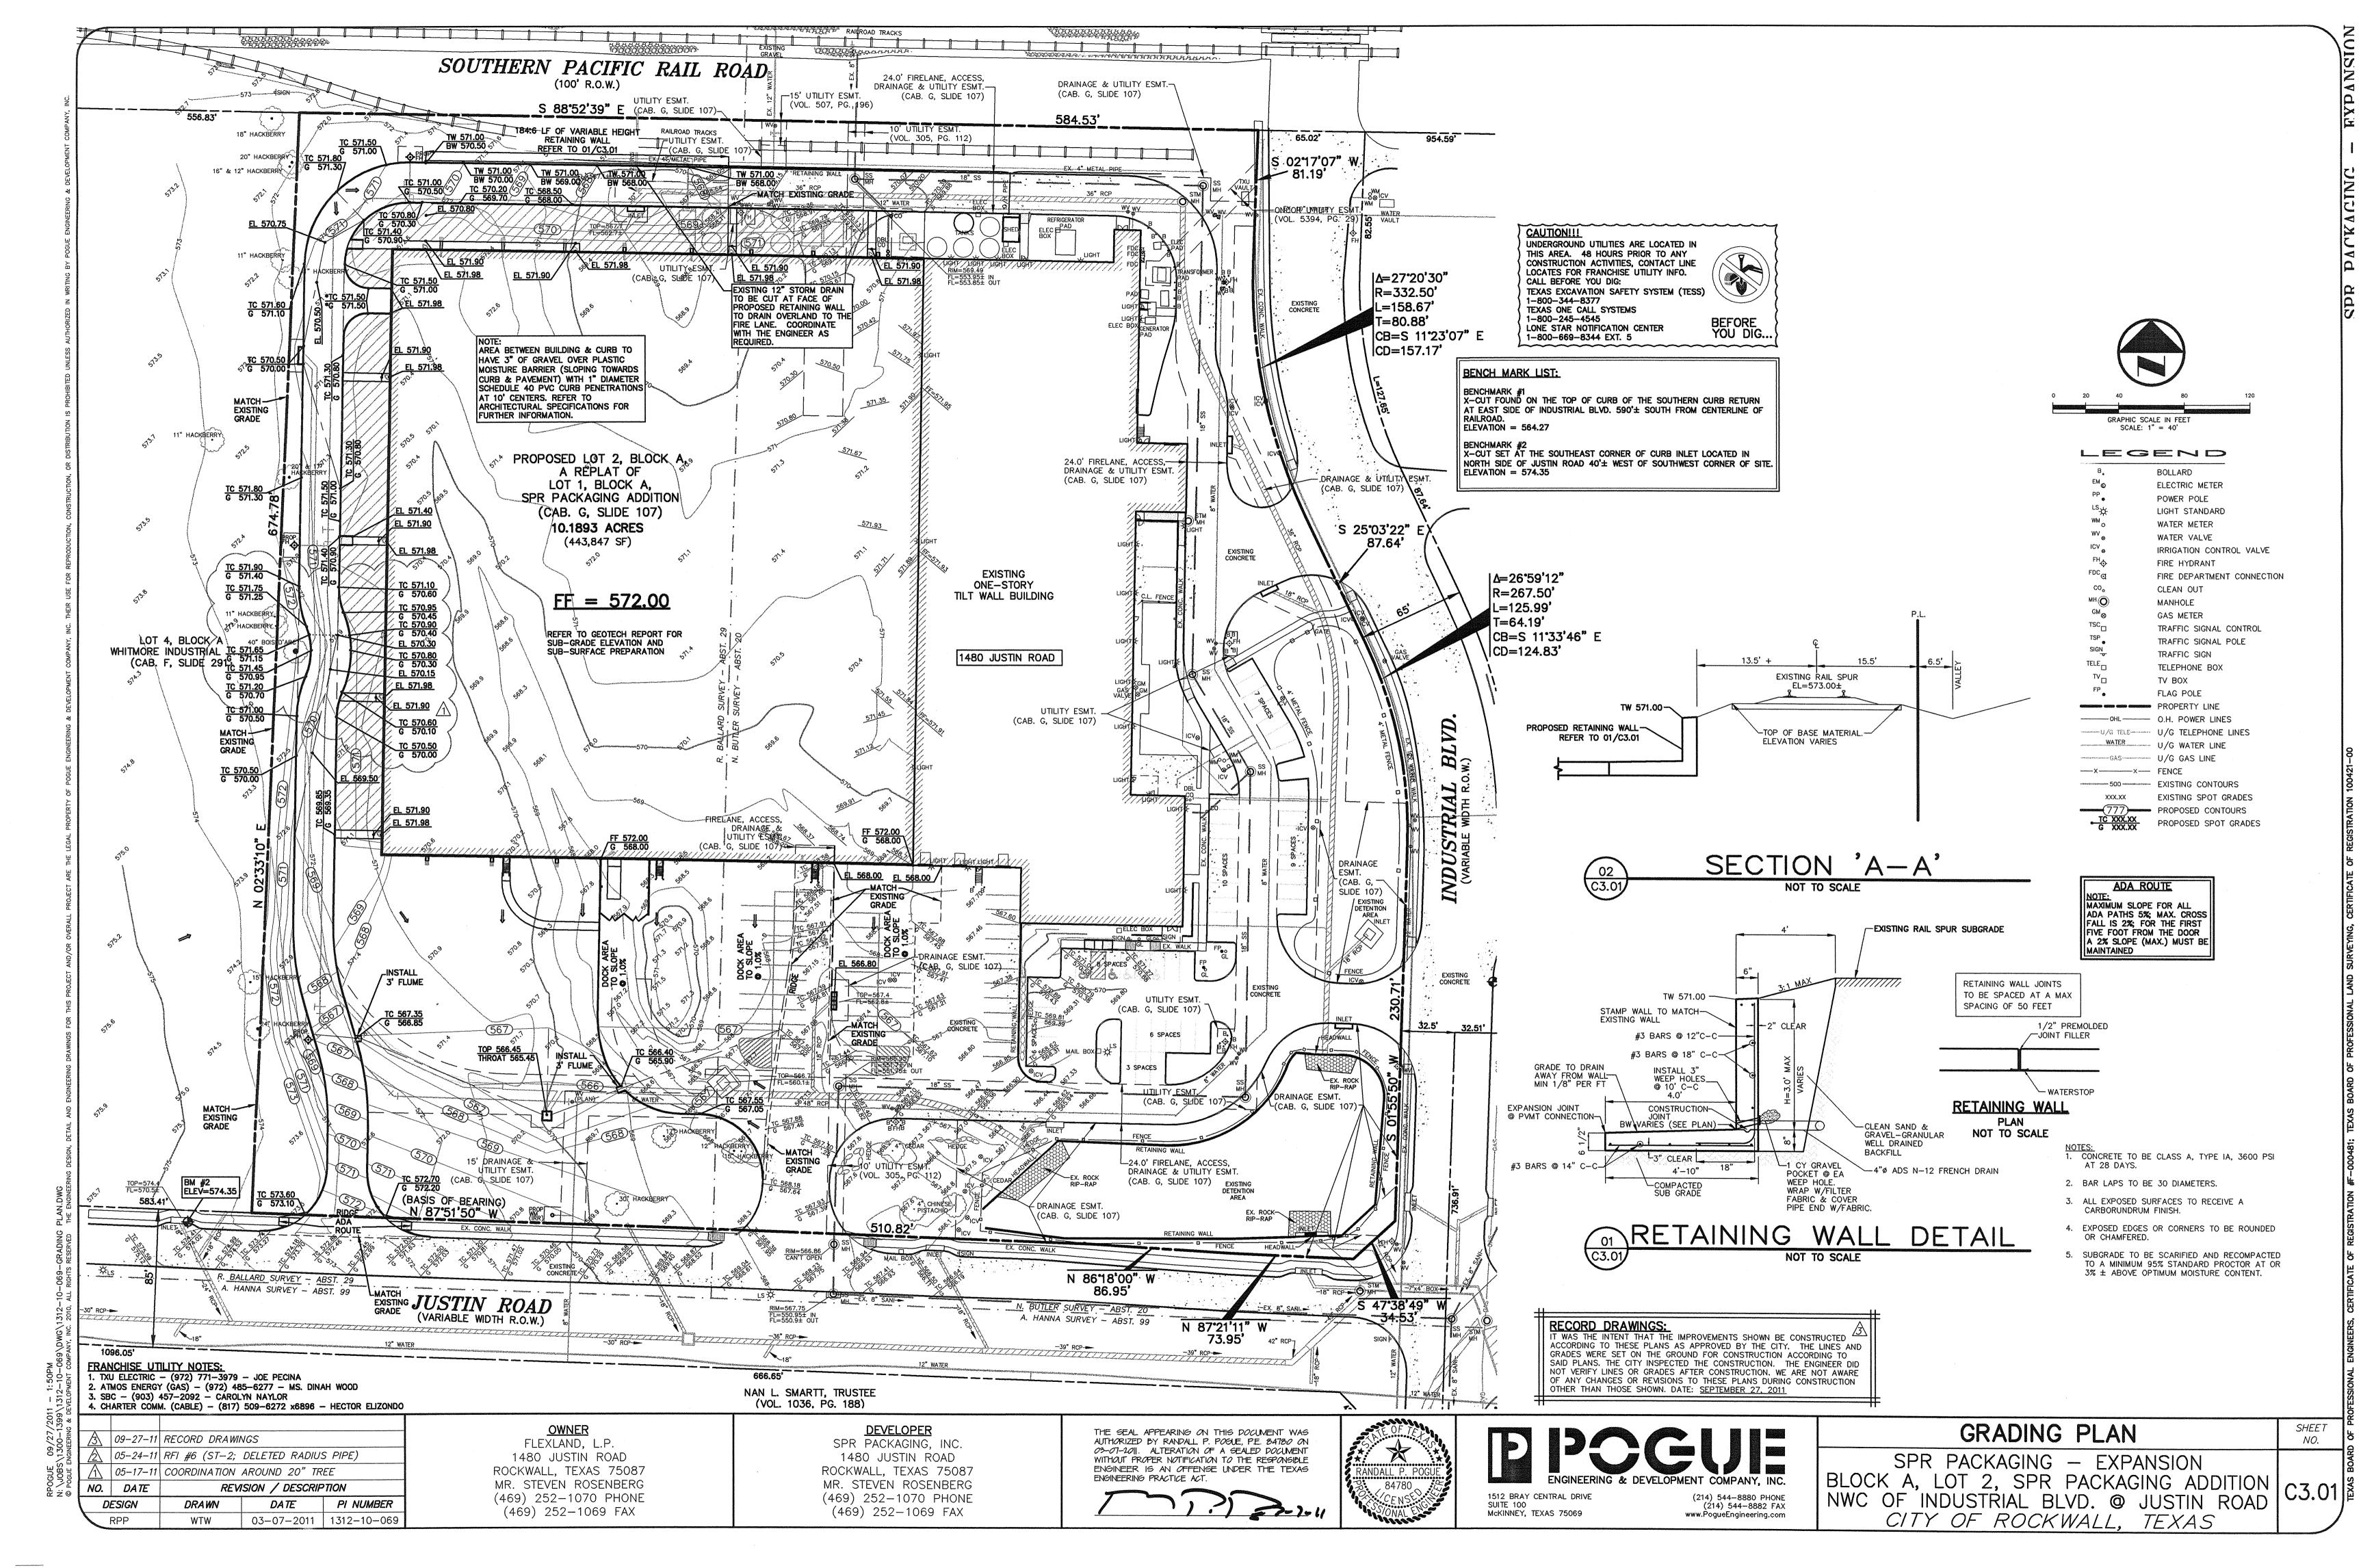
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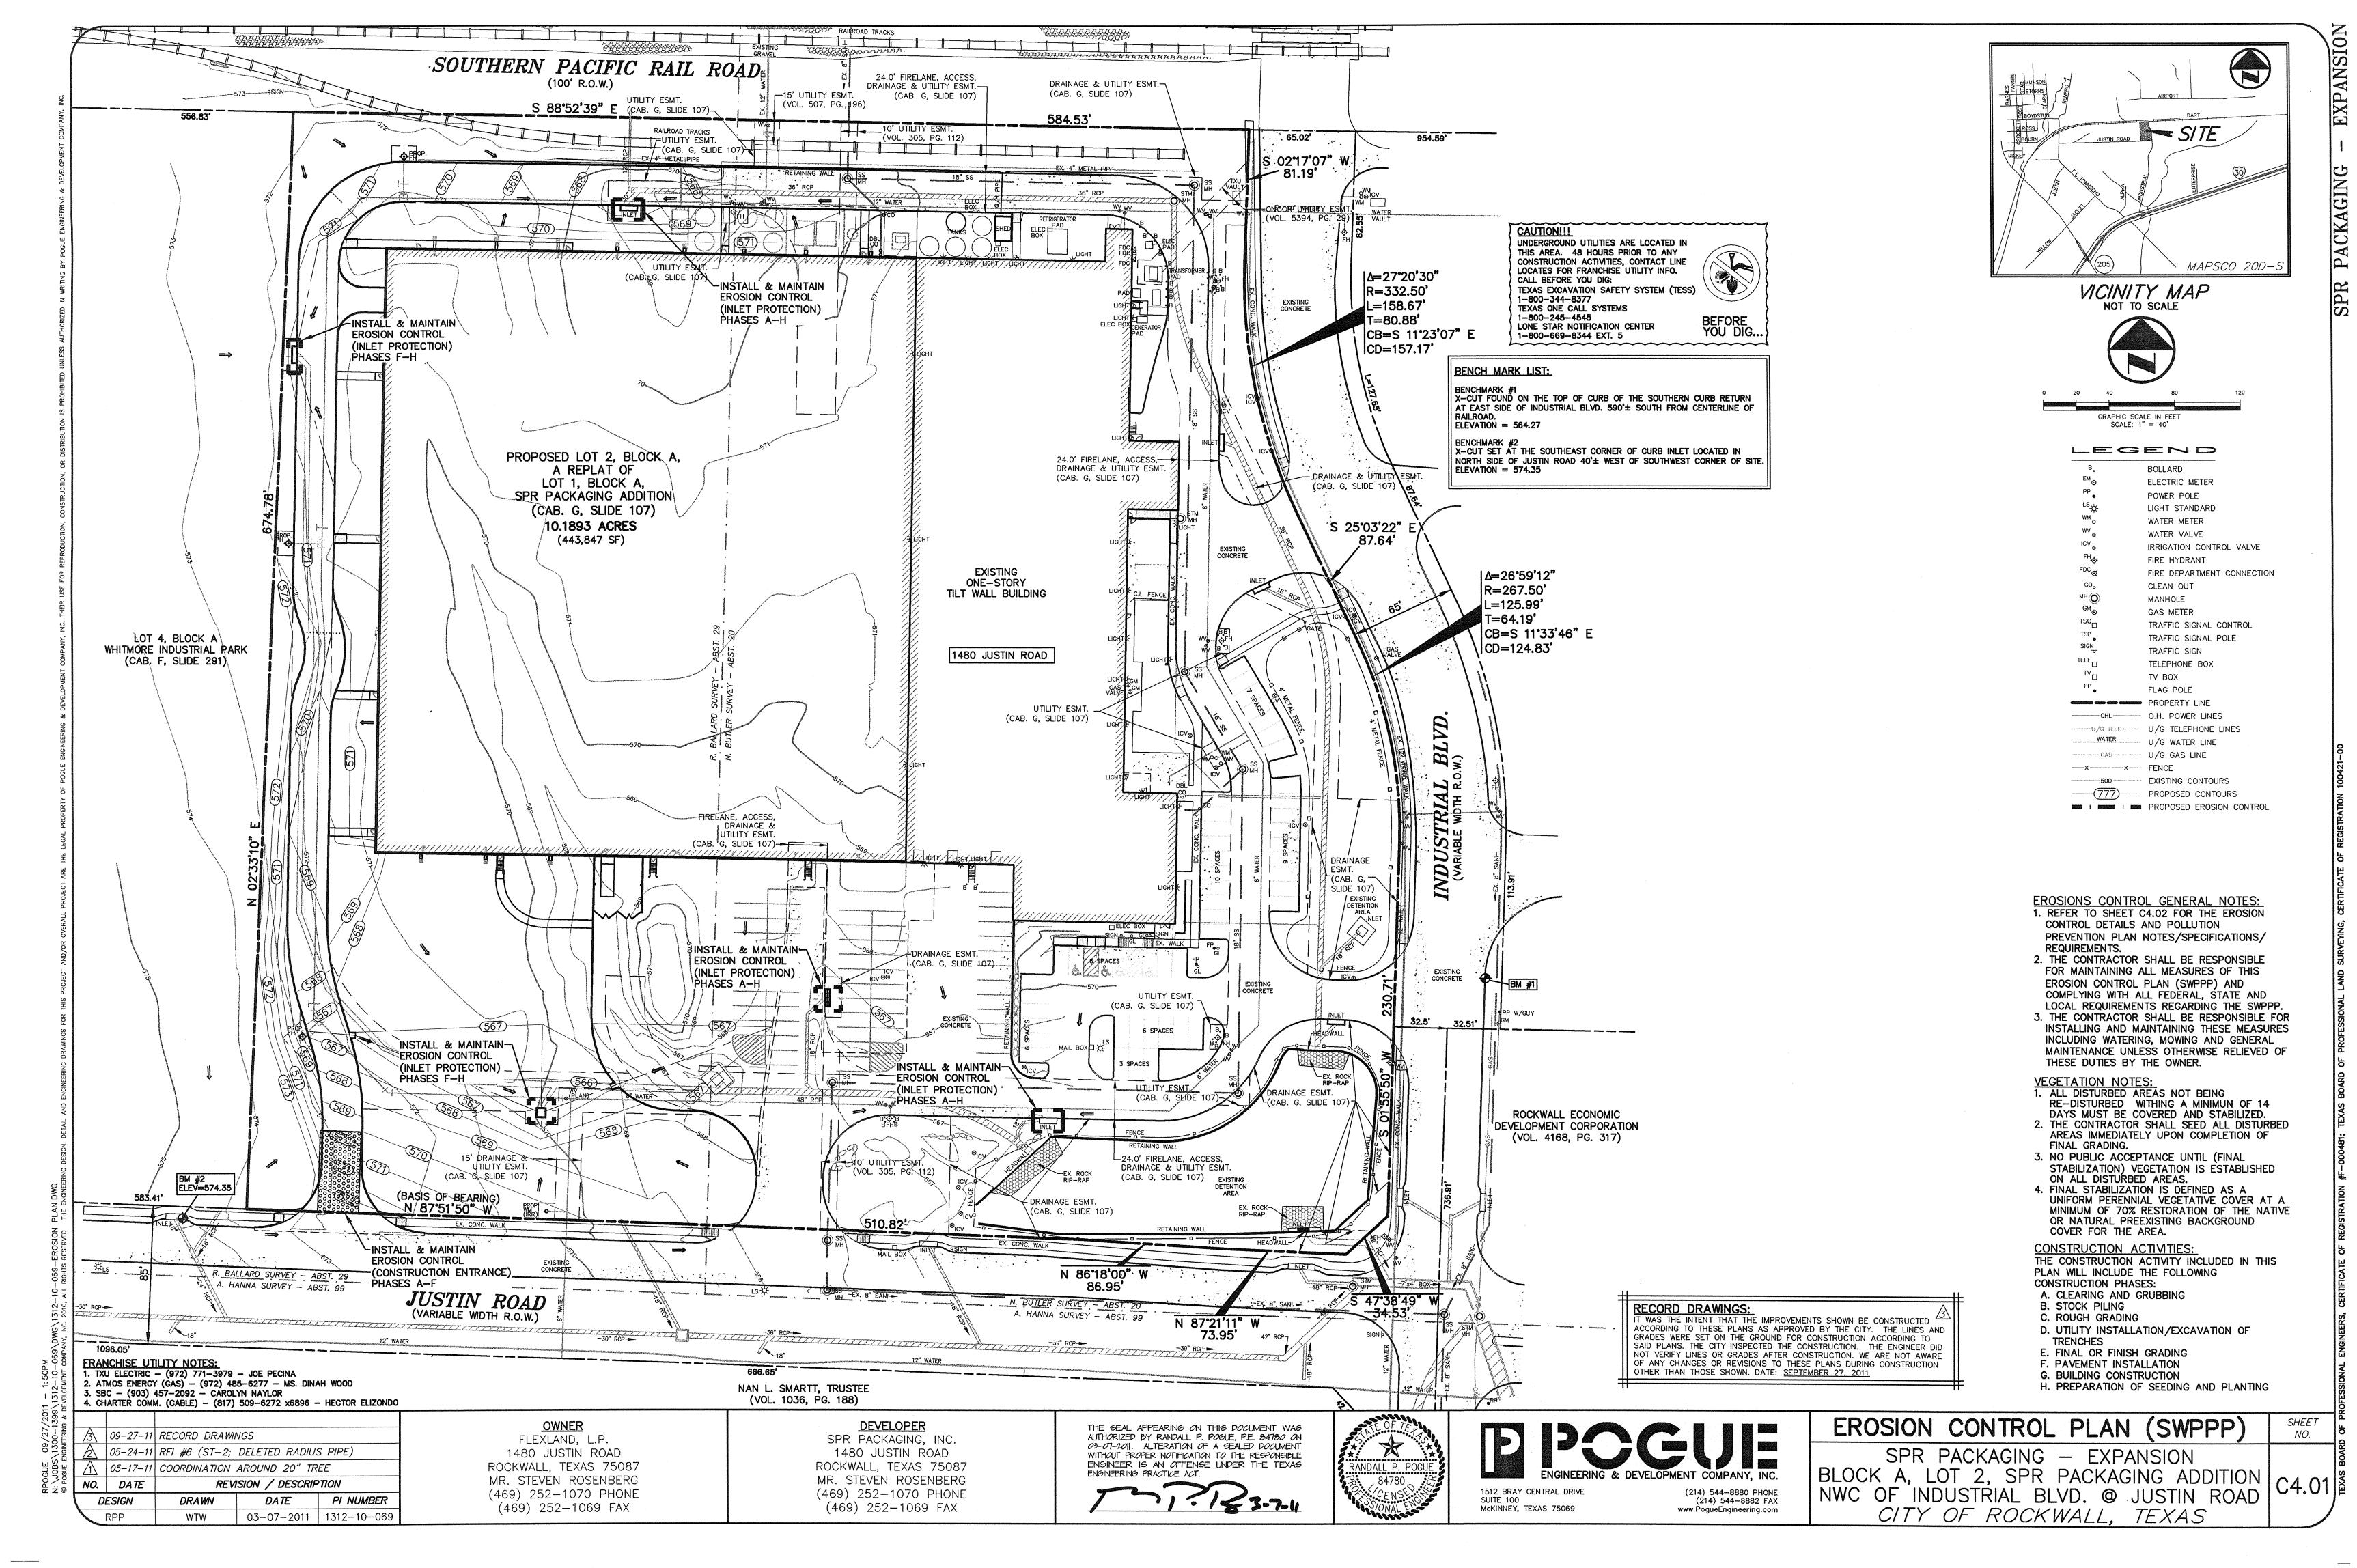
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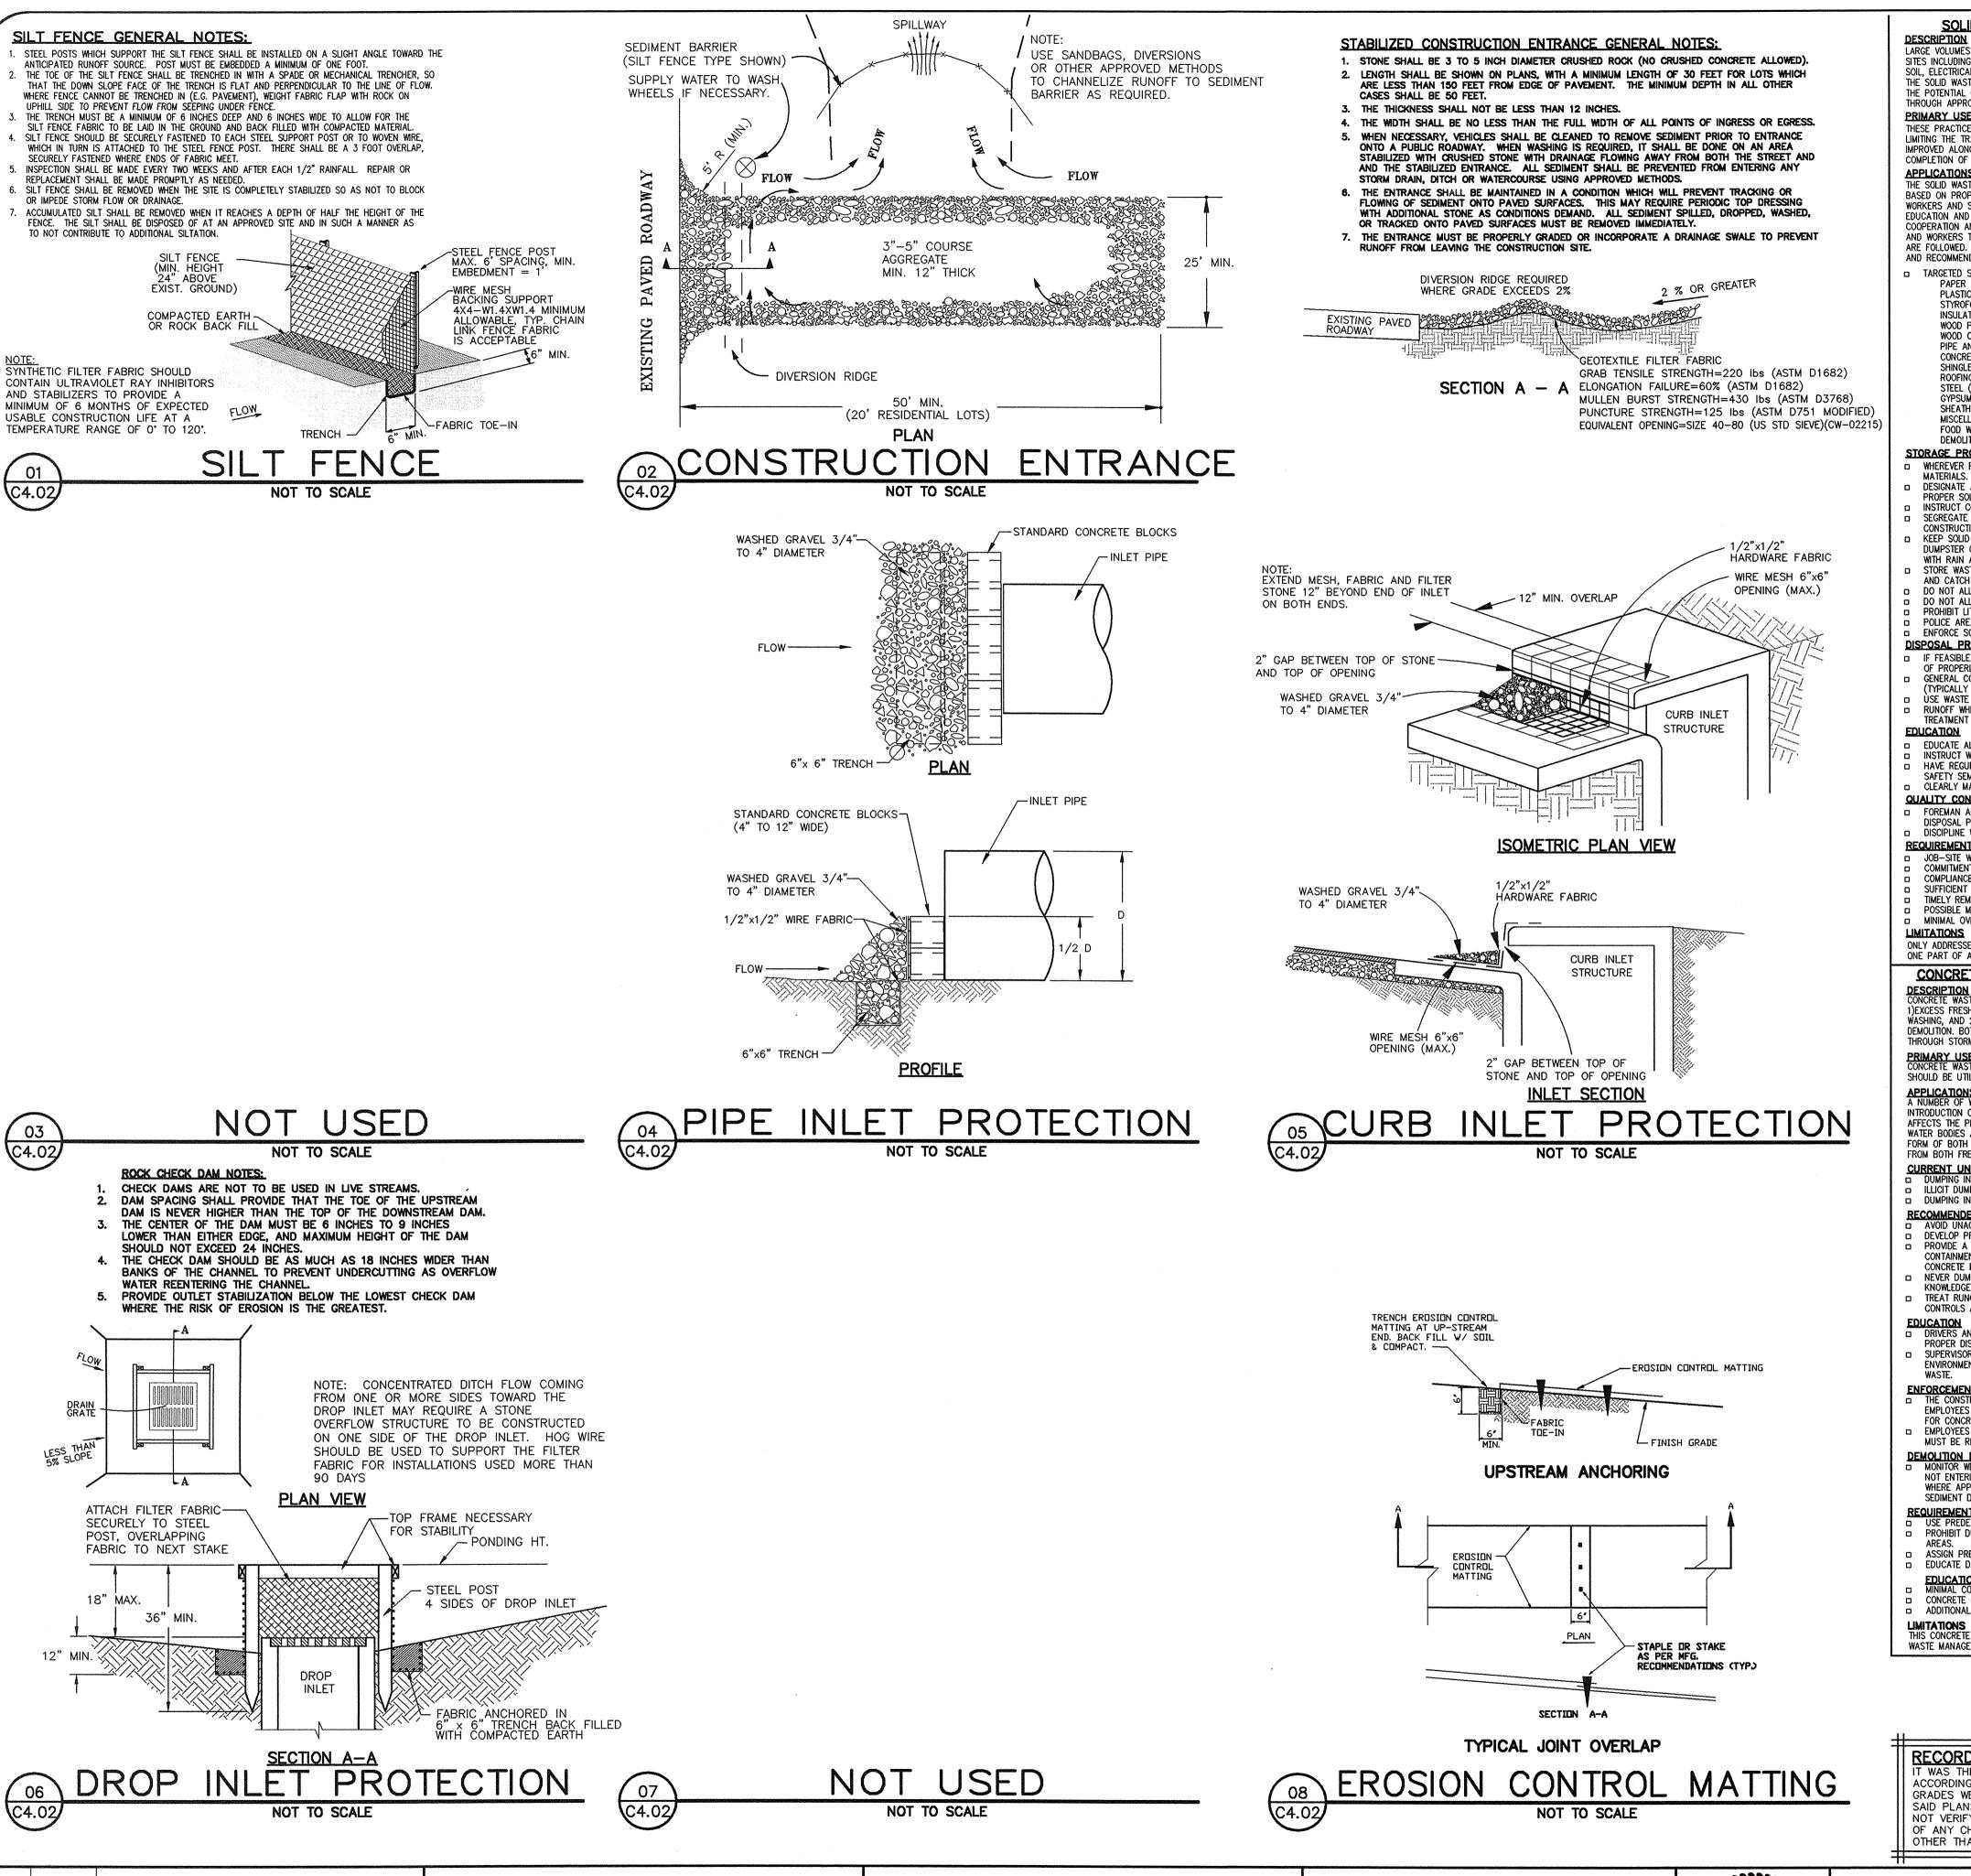
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AND WORKERS TO ENSURE THAT THE RECOMMENDATIONS AND PROCEDURES ARE FOLLOWED. FOLLOWING ARE LISTS DESCRIBING THE TARGETED MATERIALS FLOATABLE MATERIALS AND RECOMMENDED PROCEDURES: TARGETED SOLID WASTE MATERIALS OTHER CONSTRUCTION PAPER AND CARDBOARD CONTAINERS STYROFOAM PACKING AND FORMS **IMPLEMENTATION** INSULATION MATERIALS (NON-HAZARDOUS) REQUIREMENTS WOOD PALLETS WOOD CUTTINGS CAPITAL COSTS PIPE AND ELECTRICAL CUTTINGS CONCRETE, BRICK, AND MORTAR WASTE **→** MAINTENANCE HINGLE CUTTINGS AND WASTE ROOFING TAR TRAINING STEEL (CUTTINGS, NAILS, RUST RESIDUE) GYPSUM BOARD CUTTINGS AND WASTE O SUITABILITY FOR SHEATHING CUTTINGS AND WASTE MISCELLANEOUS CUTTINGS AND WASTE SLOPES > 5% DEMOLITION WASTE LEGEND STORAGE PROCEDURES SIGNIFICANT IMPACT WHEREVER POSSIBLE, MINIMIZE PRODUCTION OF SOLID WASTE DESIGNATE A FOREMAN OR SUPERVISOR TO OVERSEE AND ENFORCE MEDIUM IMPACT PROPER SOLID WASTE PROCEDURES. INSTRUCT CONSTRUCTION WORKERS IN PROPER SOLID WASTE PROCEDURES. O LOW IMPACT SEGREGATE POTENTIALLY HAZARDOUS WASTE FROM NON-HAZARDOUS UNKNOWN OR KEEP SOLID WASTE MATERIALS UNDER COVER IN EITHER A CLOSED QUESTIONABLE IMPACT DUMPSTER OR OTHER ENCLOSED TRASH CONTAINER THAT LIMITS CONTACT WITH RAIN AND RUNOFF. STORE WASTE MATERIALS AWAY FROM DRAINAGE DITCHES, SWALES AND CATCH BASINS. DO NOT ALLOW TRASH CONTAINERS TO OVERFLOW. DO NOT ALLOW WASTE MATERIALS TO ACCUMULATE ON THE GROUND. PROHIBIT LITTERING BY WORKERS AND VISITORS POLICE AREA DAILY FOR LITTER AND DEBRIS. ENFORCE SOLID WASTE HANDLING AND STORAGE PROCEDURES DISPOSAL PROCEDURES □ IF FEASIBLE, SEGRÉGATE RECYCLABLE WASTES FROM NON-RECYCLABLE WASTE MATERIALS AND DISPOSE GENERAL CONSTRUCTION DEBRIS MAY BE HAULED TO A LICENSED CONSTRUCTION DEBRIS LANDFILL (TYPICALLY LESS EXPENSIVE THAN A SANITARY LANDFILL) USE WASTE FACILITIES APPROVED BY LOCAL JURISDICTIO RUNOFF WHICH COMES INTO CONTACT WITH UNPROTECTED WASTE SHALL BE DIRECTED INTO STRUCTURAL TREATMENT SUCH AS SILT FENCE TO REMOVE DEBRIS. EDUCATION EDUCATE ALL WORKERS ON SOLID WASTE STORAGE AND DISPOSAL PROCEDURES. INSTRUCT WORKERS IN IDENTIFICATION OF SOLID WASTE AND HAZARDOUS WASTE HAVE REGULAR MEETINGS TO DISCUSS AND REINFORCE DISPOSAL PROCEDURES (INCORPORATE IN REGULAR CLEARLY MARK ON ALL SOLID WASTE CONTAINERS WHICH MATERIALS ARE ACCEPTABLE. FOREMAN AND/OR CONSTRUCTION SUPERVISOR SHALL MONITOR ON-SITE SOLID WASTE STORAGE AND DISPOSAL PROCEDURES DISCIPLINE WORKERS WHO REPEATEDLY VIOLATE PROCEDURES. REQUIREMENTS JOB-SITE WASTE HANDLING AND DISPOSAL EDUCATION AND AWARENESS PROGRAM. COMMITMENT BY MANAGEMENT TO IMPLEMENT AND ENFORCE SOLID WASTE MANAGEMENT PROGRAM. COMPLIANCE BY WORKERS SUFFICIENT AND APPROPRIATE WASTE STORAGE CONTAINERS TIMELY REMOVAL OF STORED SOLID WASTE MATERIALS. POSSIBLE MODEST COST IMPACT FOR ADDITIONAL WASTE STORAGE CONTAINERS. MINIMAL OVERALL COST IMPACT. ONLY ADDRESSES NON-HAZARDOUS SOLID WASTE. ONE PART OF A COMPREHENSIVE CONSTRUCTION SITE MANAGEMENT PROGRAM. CONCRETE WASTE MANAGEMENT APPLICATIONS DESCRIPTION
CONCRETE WASTE AT CONSTRUCTION SITES COMES IN TWO FORMS; PERIMETER CONTROL SLOPE PROTECTION 1)EXCESS FRESH CONCRETE MIX INCLUDING TRUCK AND EQUIPMEN SEDIMENT TRAPPING VASHING, AND 2) CONCRETE DUST AND CONCRETE DEBRIS RESULTING FROM CHANNEL PROTECTION DEMOLITION. BOTH FORMS HAVE THE POTENTIAL TO IMPACT WATER QUALITY HROUGH STORM WATER RUNOFF CONTACT WITH THE WASTE. TEMPORARY STABILIZATION PERMANENT STABILIZATION PRIMARY USE
CONCRETE WASTE IS PRESENT AT MOST CONSTRUCTION SITES. THIS BMP Waste Management SHOULD BE UTILIZED AT SITES IN WHICH CONCRETE WASTE IS PRESENT. Housekeeping Practices APPLICATIONS
A NUMBER OF WATER QUALITY PARAMETERS CAN BE AFFECTED BY FARGETED CONSTITUENTS INTRODUCTION OF CONCRETE - ESPECIALLY FRESH CONCRETE. CONCRETE AFFECTS THE PH OF RUNOFF, CAUSING SIGNIFICANT CHEMICAL CHANGES II WATER BODIES AND HARMING AQUATIC LIFE. SUSPENDED SOLIDS IN THE O SEDIMENT FORM OF BOTH CEMENT AND AGGREGATE DUST ARE ALSO GENERATED NUTRIENTS FROM BOTH FRESH AND DEMOLISHED CONCRETE WASTE. TOXIC MATERIALS CURRENT UNACCEPTABLE WASTE CONCRETE DISPOSAL PRACTICES

DUMPING IN VACANT AREAS ON THE JOB-SITE. O OIL & GREASE ILLICIT DUMPING OFF-SITE DUMPING INTO DITCHES OR DRAINAGE FACILITIES. FLOATABLE MATERIALS RECOMMENDED DISPOSAL PRACTICES

AVOID UNACCEPTABLE DISPOSAL PRACTICES LISTED ABOVE.
DEVELOP PREDETERMINED, SAFE CONCRETE DISPOSAL AREAS. OTHER CONSTRUCTION PROVIDE A WASHOUT AREA WITH A MINIMUM OF 6 CUBIC FEET OF CONTAINMENT AREA VOLUME FOR EVERY 10 CUBIC YARDS OF IMPLEMENTATION REQUIREMENTS CONCRETE POURED. NEVER DUMP WASTE CONCRETE ILLICITLY OR WITHOUT PROPERTY OWNERS KNOWLEDGE AND CONSENT CAPITAL COSTS TREAT RUNOFF FROM STORAGE AREAS THROUGH THE USE OF STRUCTURAL CONTROLS AS REQUIRED. MAINTENANCE DRIVERS AND EQUIPMENT OPERATORS SHOULD BE INSTRUCTED ON TRAINING PROPER DISPOSAL AND EQUIPMENT WASHING PRACTICES (SEE ABOVE). SUPERVISORS MUST BE MADE AWARE OF THE POTENTIAL O SUITABILITY FOR ENVIRONMENTAL CONSEQUENCES OF IMPROPERLY HANDLED CONCRETE SLOPES > 5% ENFORCEMENT

THE CONSTRUCTION SITE MANAGER OR FOREMAN MUST ENSURE THAT LEGEND EMPLOYEES AND PREMIX COMPANIES FOLLOW PROPER PROCEDURES SIGNIFICANT IMPACT FOR CONCRETE DISPOSAL AND EQUIPMENT WASHING EMPLOYEES VIOLATING DISPOSAL OR EQUIPMENT CLEANING DIRECTIVES MUST BE REEDUCATED OR DISCIPLINED IF NECESSARY DEMOLITION PRACTICES

MONITOR WEATHER AND WIND DIRECTION TO ENSURE CONCRETE DUST IS O LOW IMPACT NOT ENTERING DRAINAGE STRUCTURES AND SURFACE WATERS. HERE APPROPRIATE, CONSTRUCT SEDIMENT TRAPS OR OTHER TYPES OF QUESTIONABLE IMPACT SEDIMENT DETENTION DEVICES DOWNSTREAM OF DEMOLITION ACTIVITIES. USE PREDETERMINED DISPOSAL SITES FOR WASTE CONCRETE. PROHIBIT DUMPING WASTE CONCRETE ANYWHERE BUT PREDETERMINED ASSIGN PREDETERMINED TRUCK AND EQUIPMENT WASHING AREAS
EDUCATE DRIVERS AND OPERATORS ON PROPER DISPOSAL AND EQUIPMENT CLEANING PROCEDURES. EDUCATION
MINIMAL COST IMPACT FOR TRAINING AND MONITORING CONCRETE DISPOSAL COST DEPENDS ON AVAILABILITY AND DISTANCE TO SUITABLE DISPOSAL AREAS. ADDITIONAL COSTS INVOLVED IN EQUIPMENT WASHING COULD BE SIGNIFICANT. THIS CONCRETE WASTE MANAGEMENT PROGRAM IS ONE PART OF A COMPREHENSIVE CONSTRUCTION SITE **RECORD DRAWINGS:** WAS THE INTENT THAT THE IMPROVEMENTS SHOWN BE CONSTRUCTED ACCORDING TO THESE PLANS AS APPROVED BY THE CITY. THE LINES AND GRADES WERE SET ON THE GROUND FOR CONSTRUCTION ACCORDING TO SAID PLANS. THE CITY INSPECTED THE CONSTRUCTION. THE ENGINEER DID NOT VERIFY LINES OR GRADES AFTER CONSTRUCTION. WE ARE NOT AWARE OF ANY CHANGES OR REVISIONS TO THESE PLANS DURING CONSTRUCTION

SOLID WASTE MANAGEMENT

THROUGH APPROPRIATE STORAGE AND DISPOSAL PRACTICES.

PRIMARY USE

APPLICATIONS

COMPLETION OF THE PROJECT.

LARGE VOLUMES OF SOLID WASTE ARE OFTEN GENERATED AT CONSTRUCTION

SOIL, ELECTRICAL WIRING, CUTTINGS, AND A VARIETY OF OTHER MATERIALS.

THE SOLID WASTE MANAGEMENT PRACTICE LISTS TECHNIQUES TO MINIMIZE

THESE PRACTICES SHOULD BE A PART OF ALL CONSTRUCTION PRACTICES. BY

HE POTENTIAL OF STORM WATER CONTAMINATION FROM SOLID WASTE

LIMITING THE TRASH AND DEBRIS ON SITE, STORM WATER QUALITY IS IMPROVED ALONG WITH REDUCED CLEAN UP REQUIREMENTS AT THE

THE SOLID WASTE MANAGEMENT PRACTICE FOR CONSTRUCTION SITES IS

WORKERS AND SUPERVISORS.. KEY ELEMENTS OF THE PROGRAM ARE

EDUCATION AND MODIFICATION OF IMPROPER DISPOSAL HABITS.

BASED ON PROPER STORAGE AND DISPOSAL PRACTICES BY CONSTRUCTION

COOPERATION AND VIGILANCE IS REQUIRED ON THE PART OF SUPERVISORS

SITES INCLUDING: PACKAGING, PALLETS, WOOD WASTE, CONCRETE WASTE.

O SEDIMENT NUTRIENTS TOXIC MATERIALS O OIL & GREASE 16. THE CONTRACTOR MUST COMPLY WITH FEDERAL, STATE AND LOCAL REGULATIONS 17. A COPY OF THE STORM WATER POLLUTION PREVENTION PLAN ALONG WITH THE EPA

**APPLICATIONS** 

PERIMETER CONTROL

SLOPE PROTECTION

SEDIMENT TRAPPING

CHANNEL PROTECTION

TEMPORARY STABILIZATION

PERMANENT STABILIZATION

Waste Management

lousekeeping Practices

TARGETED CONSTITUENTS

3. THE CONSTRUCTION ACTIVITY INCLUDED IN THIS PLAN WILL INCLUDE: CLEARING AND GRUBBING STOCK PILING ROUGH GRADING UTILITY INSTALLATION/EXCAVATION OF TRENCHES CONSTRUCTION FINAL OR FINISH GRADING PAVEMENT INSTALLATION BUILDING CONSTRUCTION PREPARATION OF SEEDING OR PLANTING 4. BEST MANAGEMENT PRACTICES (STRUCTURAL PRACTICES) USED ON THIS PROJECT COULD INCLUDE: SILT FENCING, CONSTRUCTION ENTRANCE, INLET PROTECTION, OUTLET PROTECTION, SUBSURFACE DRAINS, CHECK DAMS, DRAINAGE SWALES, SEDIMENT TRAPS, EARTH DIKE, PIPE SLOPE DRAINS, EROSION CONTROL MATTING, DETENTION/RETENTION PONDS AND SEDIMENT BASINS. 5. THE TOTAL ESTIMATED SITE AREA IS 10.19 ACRES THE TOTAL ESTIMATED SITE AREA TO BE DISTURBED IS 8.43 ACRES THE TOTAL ESTIMATED SITE AREA NOT TO BE DISTURBED IS 1.76 ACRES 6. THE ESTIMATED RUNOFF COEFFICIENT PRIOR TO DEVELOPMENT OF THE PROJECT IS 0.35 7. THE ESTIMATED RUNOFF COEFFICIENT UPON COMPLETION OF THE PROJECT IS 0.90 8. THE SLOPES EXPECTED ON THE SITE UPON COMPLETION OF FINAL GRADING WILL RANGE BETWEEN 1% TO 30% 9. THE STORM WATER EXITING THE SITE IS COLLECTED IN AN EXISTING DRAINAGE SYSTEM MAINTAINED BY THE CITY OF ROCKWALL, TEXAS. 10. THE NAME OF THE RECEIVING WATER BODY IS LAKE RAY HUBBARD, LOCATED APPROXIMATELY 14,800 FEET FROM THE SUBJECT PROPERTY. 11. THE SOILS PRESENT AT THE SITE ARE GENERALLY EXPANSIVE CLAYS. 12. THE CONTRACTOR SHALL PROVIDE EROSION PROTECTION AROUND THE WORK AREA PERIMETER AND AT ALL INLET MOUTHS DURING CONSTRUCTION. 13. THE CONTRACTOR WILL REMOVE ALL EXCESS SOIL FROM CONSTRUCTION VEHICLES PRIOR TO EXITING THE SITE. 14. ALL DISTURBED AREAS WHICH WILL NOT BE RE-DISTURBED FOR A MINIMUM OF 14 DAYS MUST BE STABILIZED BY THE CONTRACTOR TO CONTROL EROSION. 15. THE CONTRACTOR SHALL UNDERTAKE PROPER METHODS TO REDUCE DUST GENERATION FROM THE SITE.

POLLUTION CONTROL GENERAL NOTES:

1. THIS PLAN HAS BEEN PREPARED TO PROVIDE MEANS TO PREVENT OR

2. THIS PROJECT CONSISTS OF THE DEVELOPMENT OF 1 LOT ON A 10.19 ACRE TRACT

MINIMIZE POLLUTION OF STORM WATER.

FOR A LIGHT INDUSTRIAL USE.

18. CONTRACTOR SHALL BE RESPONSIBLE FOR SUBMITTAL OF THE EPA'S REQUIREMENT OF A NOTICE OF INTENT (NOI) AND THE NOTICE OF TERMINATION (NOT) AND ANY ADDITIONAL REQUIREMENT PER THE EPA GUIDELINES FOR STORM WATER POLLUTION

(NPDES) PERMIT MUST BE POSTED AT THE CONSTRUCTION SITE THROUGHOUT THE

CONSTRUCTION OF THE PROJECT. IF THE PERMIT HAS NOT BEEN ISSUED, A COPY OF

REGARDING SEDIMENT AND EROSION CONTROL.

NOTICE OF INTENT (NOI) SHALL BE POSTED

19. ALL EROSION CONTROL DEVICES ARE TO BE INSTALLED IN ACCORDANCE WITH THE APPROVED PLANS AND SPECIFICATIONS FOR THIS PROJECT. CHANGES ARE TO BE APPROVED BEFORE CONSTRUCTION BY THE DESIGN ENGINEER AND THE CITY.

20, IF OFF-SITE SOIL BORROW OR SPOIL SITES ARE USED IN CONJUNCTION WITH THIS PROJECT, THE CONTRACTOR SHALL NOTIFY THE CITY INSPECTOR AND BE RESPONSIBLE FOR EROSION CONTROL REQUIREMENTS AS PER FEDERAL, STATE AND LOCAL REQUIREMENTS.

21. INSPECTIONS SHALL BE MADE WEEKLY AND AFTER RAIN STORM EVENTS TO INSURE THAT THE DEVICES ARE FUNCTIONING PROPERLY. WHEN SEDIMENT OR MUD HAS CLOGGED THE VOID SPACES BETWEEN STONES OR MUD IS BEING TRACKED ONTO A PUBLIC ROADWAY THE AGGREGATE PAD MUST BE WASHED DOWN OR REPLACED. RUNOFF FROM THE WASH DOWN OPERATION SHALL NOT BE ALLOWED TO DRAIN DIRECTLY OFF-SITE WITHOUT FIRST FLOWING THROUGH ANOTHER BEST MANAGEMENT PRACTICE (BMP) TO CONTROL OFF-SITE SEDIMENTATION. PERIODIC RE-GRADING OR THE ADDITION OF NEW STONE MAY BE REQUIRED TO MAINTAIN EFFICIENCY OF THE INSTALLATION.

22. MAINTENANCE AND INSPECTIONS PROCEDURES: CONTROL MEASURES SHALL BE INSPECTED AT LEAST ONCE A WEEK OR WITHIN 24 HOURS OF ANY STORM EVENT OF 0.5 INCHES OR GREATER. IF REPAIR IS NECESSARY IT SHALL BE DONE AT THE EARLIEST PRACTICAL DATE BUT IN NO CASE GREATER THAN 48 HOURS.

23. FINAL STABILIZATION IS DEFINED AS A UNIFORM PERENNIAL VEGETATIVE COVER AT A MINIMUM OF 70% RESTORATION OF THE NATIVE OR NATURAL PREEXISTING BACKGROUND

24. SEDIMENTATION PONDS/TRAPS MUST BE CLEANED OUT WHEN SEDIMENTATION ACCUMULATES TO A POINT OF 50% FULL (BY VOLUME).

25. CONTRACTOR SHALL SEED ALL DISTURBED AREAS IMMEDIATELY UPON COMPLETION OF

FINAL GRADING.

26. NO PUBLIC ACCEPTANCE UNTIL (FINAL STABILIZATION) VEGETATION IS ESTABLISHED ON ALL DISTURBED AREAS.

SEQUENCE OF EROSION CONTROL BEST MANAGEMENT PRACTICES:

. INSTALL DOWN SLOPE AND SIDE SLOPE PERIMETER CONTROLS PRIOR TO THE LAND DISTURBING ACTIVITIES.

2. DO NOT DISTURB AN AREA UNTIL IT IS NECESSARY FOR CONSTRUCTION TO PROCEED.

3. COVER AND STABILIZE DISTURBED AREAS AS SOON AS POSSIBLE (WITHIN A MAXIMUM OF 14 DAYS).

4. TIME ACTIVITIES TO LIMIT IMPACT FROM SEASONAL CLIMATE CHANGES OR WEATHER EVENTS.

5. DELAY CONSTRUCTION OF INFILTRATION MEASURES UNTIL THE END OF THE CONSTRUCTION

PROJECT, WHEN UPSTREAM DRAINAGE AREAS HAVE BEEN STABILIZED.

6. DO NOT REMOVE TEMPORARY PERIMETER CONTROLS UNTIL AFTER ALL UPSTREAM AREAS ARE FINAL STABILIZED.

ALLOWABLE NON-STORM WATER DISCHARGES

DISCHARGES FROM FIRE FIGHTING ACTIVITIES. FIRE HYDRANT FLUSHINGS. \* WATER USED TO WASH VEHICLES OR CONTROL DUST.

POTABLE WATER SOURCES (INCLUDING WATERLINE FLUSHINGS CONTAINING LESS THAN 1000 GALLONS). \*

UNCONTAMINATED GROUND WATER (INCLUDING DEWATERING GROUNDWATER INFILTRATION). FOUNDATION OR FOOTING DRAINS WHERE FLOWS ARE NOT CONTAMINATED WITH PROCESS MATERIALS SUCH AS SOLVENTS.

SPRINGS, RIPARIAN HABITATS, WETLANDS AND UNCONTAMINATED GROUNDWATER.

IRRIGATION WATER.

EXTERIOR BUILDING WASH DOWN WITHOUT DETERGENTS.

PAVEMENT WASH WATERS WHERE SPILLS OR LEAKS OF TOXIC OR HAZARDOUS MATERIALS

HAVE NOT OCCURRED (UNLESS ALL SPILL MATERIAL HAS BEEN REMOVED) AND WHERE

AIR CONDITIONING CONDENSATE. \* HEAVILY CHLORINATED WATER (3.5 MG/L OR GREATER FREE CHLORINE) RESULTING FROM WATER LINE STERILIZATION SHALL BE DIRECTED UNDER PERMIT TO THE SANITARY SEWER

UNLESS OTHERWISE NOTED. THE CONTRACTOR SHALL APPLY TO THE ENGINEERING DEPARTMENT FOR A SANITARY SEWER DISCHARGE PERMIT AFTER THE MANDATORY CHLORINE RETENTION TIME (USUALLY 24 HOURS). THE HEAVILY CHLORINATED WATER MAY BE DISCHARGED TO THE SANITARY SEWER, BEGINNING TWO WORKING DAYS AFTER PERMIT APPLICATION.

SPILLS AND RELEASES: (OF REPORTABLE QUANTITIES) THE FOLLOWING STEPS SHALL BE TAKEN

1. NOTIFY THE NATIONAL RESPONSE CENTER (800) 424-8802 OR (202) 426-2675 AS SOON

2. THE SWPPP MUST BE MODIFIED WITHIN 14 DAYS TO PROVIDE A DESCRIPTION OF THE

RELEASE, THE CIRCUMSTANCES LEADING TO THE RELEASE AND THE DATE OF THE RELEASE.

AS YOU HAVE KNOWLEDGE OF THE SPILL.

| 09-27-11 | RECORD DRAWINGS 05-24-11 RFI #6 (ST-2; DELETED RADIUS PIPE) 05-17-11 COORDINATION AROUND 20" TREE NO. DATE REVISION / DESCRIPTION **DESIGN** DRAWN DATE PI NUMBER

03-07-2011 | 1312-10-069

<u>OWNER</u> SPR PACKAGING - EXPANSION 1480 JUSTIN ROAD ROCKWALL, TEXAS 75087 MR. STEVEN ROSENBERG (469) 252-1070 PHONE (469) 252-1069 FAX

<u>DEVELOPER</u> SPR PACKAGING, INC 1480 JUSTIN ROAD ROCKWALL, TEXAS 75087 MR. STEVEN ROSENBERG (469) 252-1070 PHONE (469) 252-1069 FAX

THE SEAL APPEARING ON THIS DOCUMENT WAS AUTHORIZED BY RANDALL P. POGUE, P.E. 84780 ON 03-07-2011. ALTERATION OF A SEALED DOCUMENT WITHOUT PROPER NOTIFICATION TO THE RESPONSIBLE ENGINEER IS AN OFFENSE UNDER THE TEXAS ENGINEERING PRACTICE ACT.





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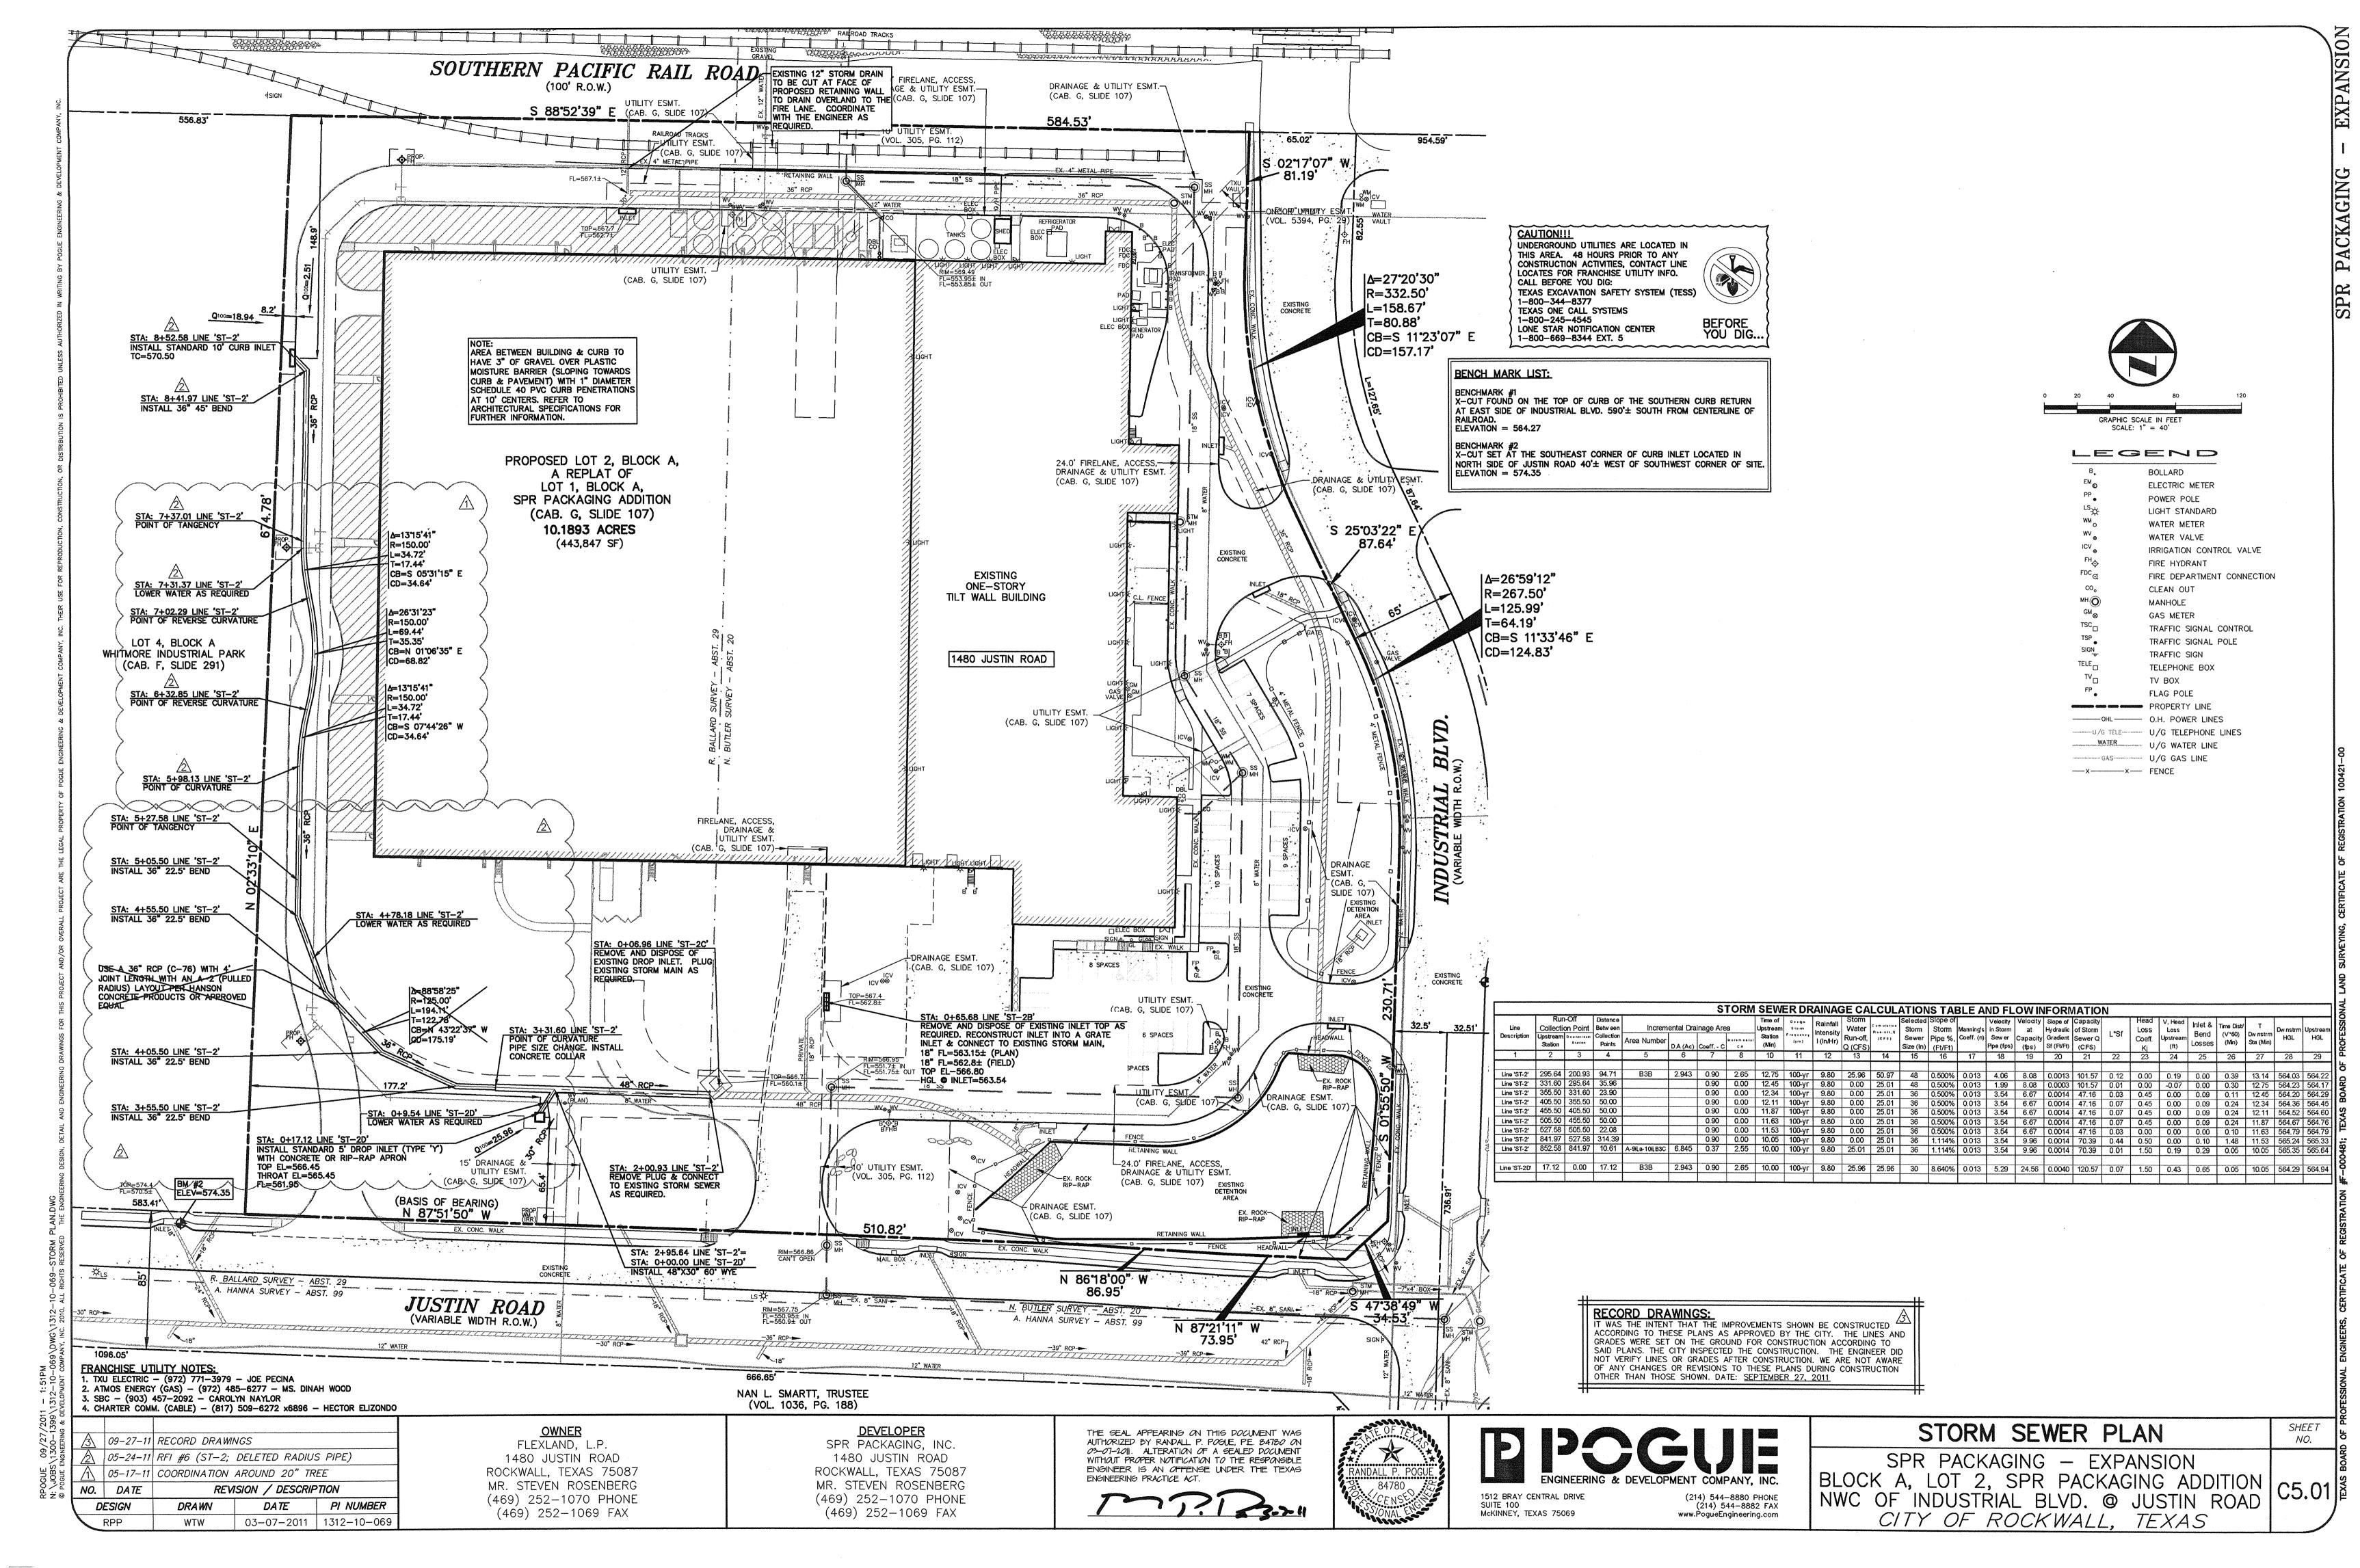
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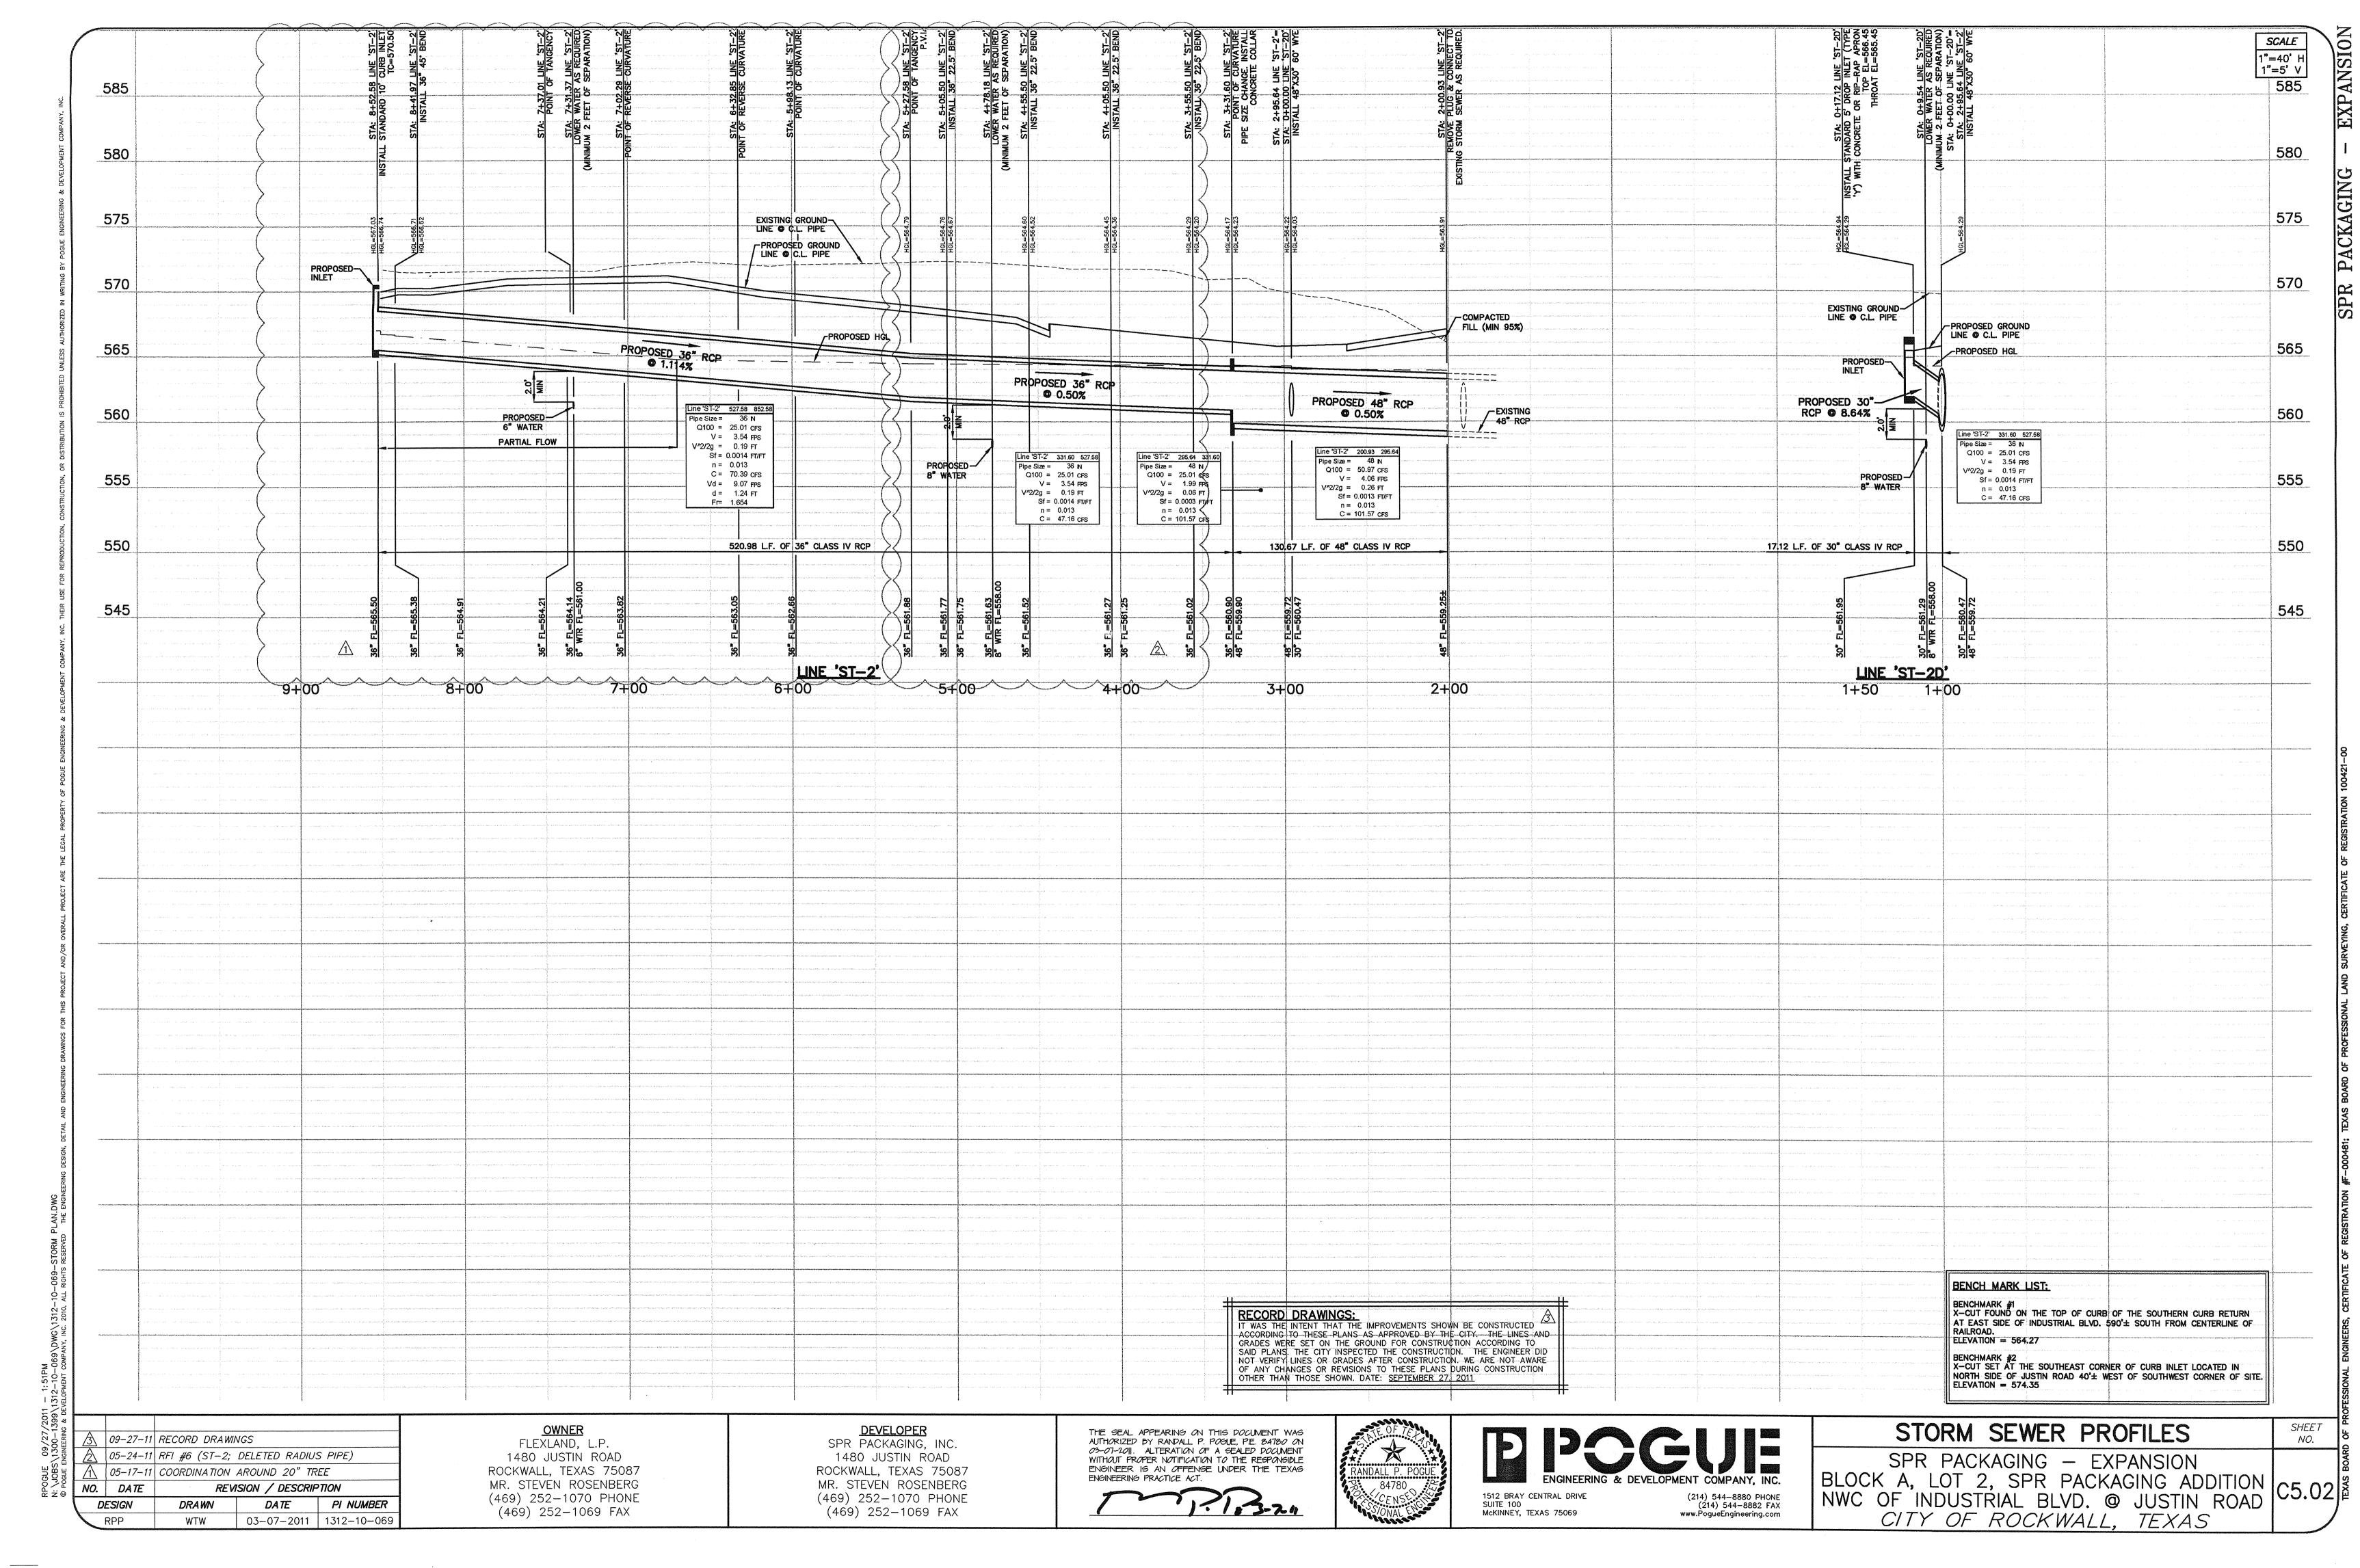
OTHER THAN THOSE SHOWN. DATE: SEPTEMBER 27, 2011


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SPR PACKAGING - EXPANSION BLOCK A, LOT 2, SPR PACKAGING ADDITION C4.02 CITY OF ROCKWALL, TEXAS







- 3. THE HORIZONTAL AND VERTICAL LOCATIONS OF EXISTING SUBSURFACE UTILITIES HAVE BEEN DETERMINED FROM DATA RECORDED BY OTHERS. THE CONTRACTOR SHALL VERIFY THAT ALL NECESSARY CROSSING CLEARANCES BETWEEN EXISTING AND PROPOSED UTILITIES EXIST PRIOR TO CONSTRUCTION OF ANY SUCH CROSSING. IT IS THE RESPONSIBILITY OF THE CONTRACTOR TO VERIFY SIZE AND LOCATION OF ALL UTILITIES PRIOR TO CONSTRUCTION. IT WILL BE THE RESPONSIBILITY OF THE CONTRACTOR TO PROTECT ALL PUBLIC UTILITIES IN THE CONSTRUCTION OF THIS PROJECT.
- 4. IT WILL BE THE RESPONSIBILITY OF THE CONTRACTOR TO PROTECT ALL MANHOLES, CLEAN OUTS, VALVE BOXES, FIRE HYDRANTS, ETC. THEY MUST BE ADJUSTED TO THE PROPER LINE AND GRADE BY THE CONTRACTOR PRIOR TO AND AFTER THE PLACING OF PERMANENT PAVING AND GRADING. UTILITIES MUST BE MAINTAINED TO PROPER LINE AND GRADE THROUGHOUT THE CONSTRUCTION OF THIS PROJECT.
- 5. CONTRACTOR SHALL MAINTAIN ONE SET OF "RECORD DRAWINGS" ON SITE WHICH WILL BE SUBMITTED TO THE OWNER OR ENGINEER UPON COMPLETION OF THE PROJECT. RECORD DRAWINGS SHALL INDICATE THE LOCATION OF ALL SUBTERRANEAN UTILITY IMPROVEMENTS AND/OR RELOCATIONS. THEY SHALL ALSO INCLUDE DIMENSIONAL TIES TO ALL MANHOLES, CULVERTS, INLETS, JUNCTION BOXES, FIRE HYDRANTS, ETC.
- 6. CONTRACTOR SHALL BE RESPONSIBLE FOR MAINTAINING AND BEING IN COMPLIANCE WITH ALL FEDERAL (O.S.H.A. STANDARDS AND REGULATIONS), STATE AND LOCAL REGULATIONS REGARDING TRENCH SAFETY.
- 7. BARRICADING AND PROJECT SIGNS SHALL CONFORM TO "STATE DEPARTMENT OF HIGHWAYS AND PUBLIC TRANSPORTATION BARRICADING AND CONSTRUCTION STANDARDS" ON TXDOT ROADWAYS AND "TEXAS MANUAL ON UNIFORM TRAFFIC CONTROL DEVICES, PART VI" FOR PRIVATE WORK. BARRICADES AND PROJECT SIGNS SHALL ALSO MEET CITY CODE.
- 8. UNLESS OTHERWISE NOTED, THE STORM DRAIN LINES MAY BE OF THE FOLLOWING MATERIALS:
- A. CLASS III. RCP C-76 (CIRCULAR) INSTALLED IN ACCORDANCE WITH THE MANUFACTURER'S SPECIFICATIONS.
- 9. STORM SEWER JOINT MATERIALS MAY BE OF THE FOLLOWING: A. RAM-NECK
- B. CON-SEAL
- C. CEMENT GROUT
- INSTALLED IN ACCORDANCE WITH THE MANUFACTURER'S SPECIFICATIONS.
- 10. STORM SEWER CONNECTIONS FOR NEW INTERCEPTING MAINS SHALL BE FACTORY WYES FOR 48" AND SMALLER PIPE.
- 11. ALL HEADWALLS SHALL BE POURED IN PLACE.
- 12. GRADING OF ALL HANDICAPPED SPACES AND ROUTES SHALL CONFORM TO STATE, LOCAL AND FEDERAL REGULATIONS. THE MAXIMUM CROSS FALL SHALL BE 2% (1' IN 50') AND THE MAXIMUM SLOPE FOR INGRESS/EGRESS ALONG THE ROUTE SHALL BE 5% (1' IN 20'), AND A 2% MAXIMUM SLOPE IN ANY DIRECTION MUST BE MAINTAINED WITHIN THE FIRST 5' FROM ANY ENTRY OR EXIT OF A BUILDING OR LANDING AREA.
- 13. FINAL PAVING, CURB AND SIDEWALK ELEVATIONS SHALL BE PLACED AT THE PROPOSED GRADE ELEVATIONS WITHIN PLUS OR MINUS 0.05 FEET.
- 14. ANY CONCRETE, ROCK, DEBRIS OR MATERIAL DEEMED UNSUITABLE FOR SUB-GRADE BY THE ENGINEER SHALL BE DISPOSED OF OFF SITE AT THE CONTRACTOR'S EXPENSE.
- 15. TRENCH BACK FILL MATERIAL SHALL CONFORM TO THE REQUIREMENTS OF NCTCOG ITEM 6.2.10 AND SHALL BE MECHANICALLY COMPACTED IN ACCORDANCE WITH NCTCOG ITEM 6.2.9 TO A MINIMUM OF 95 PERCENT STANDARD PROCTOR DENSITY UNLESS OTHERWISE SHOWN ON THESE PLANS OR STATED IN THE CITY STANDARD SPECIFICATIONS OR IN THE GEOTECHNICAL REPORT. SEE CITY OF ROCKWALL STANDARDS OF DESIGN & CONSTRUCTION DATED AUGUST 2003, FOR ADDENDUMS.
- 16. EMBEDMENT FOR PIPES SHALL CONFORM TO THE REQUIREMENTS OF NCTCOG ITEM 6.2.9 UNLESS OTHERWISE SHOWN ON THESE PLANS OR NOTED IN THE STANDARD CITY SPECIFICATIONS. CRUSHED STONE BEDDING OR APPROVED EQUAL SHALL BE PROVIDED BY THE CONTRACTOR WHEN ROCK IS ENCOUNTERED IN TRENCHES. THERE SHALL BE NO ADDITIONAL PAY ITEM OF THE CRUSHED STONE BEDDING. IF ROCK IS ENCOUNTERED, ROCK SPOIL SHALL NOT BE USED IN THE UPPER 1.5 FEET OF THE TRENCH. THE UPPER 1.5 FEET OF TRENCH SHALL BE BACK FILLED WITH QUALITY TOPSOIL. SEE CITY OF ROCKWALL STANDARDS OF DESIGN & CONSTRUCTION DATED AUGUST 2003, FOR ADDENDUMS. REFER TO DETAILS.
- 17. IF REQUIRED BY CONSTRUCTION, POWER POLES TO BE BRACED AND/OR RELOCATED AT THE CONTRACTOR'S EXPENSE.
- 18. REFER TO THE GEOTECHNICAL REPORT FOR REQUIREMENTS REGARDING FILL COMPACTION AND RELATED MOISTURE CONTENT.
- 19. DRAINAGE SHALL BE MAINTAINED AWAY FROM ALL FOUNDATIONS, BOTH DURING AND AFTER CONSTRUCTION.
- 20. TREES SHALL REMAIN AND BE PROTECTED UNLESS SPECIFIED OTHERWISE ON THE LANDSCAPE PLAN OR APPROVED BY THE OWNER AND THE CITY.
- ALL UTILITY CONNECTIONS (ROOF DRAIN COLLECTION, WATER, SEWER, ETC.). 22. REFER TO THE PAVING AND DRAINAGE PLANS FOR ADDITIONAL INFORMATION

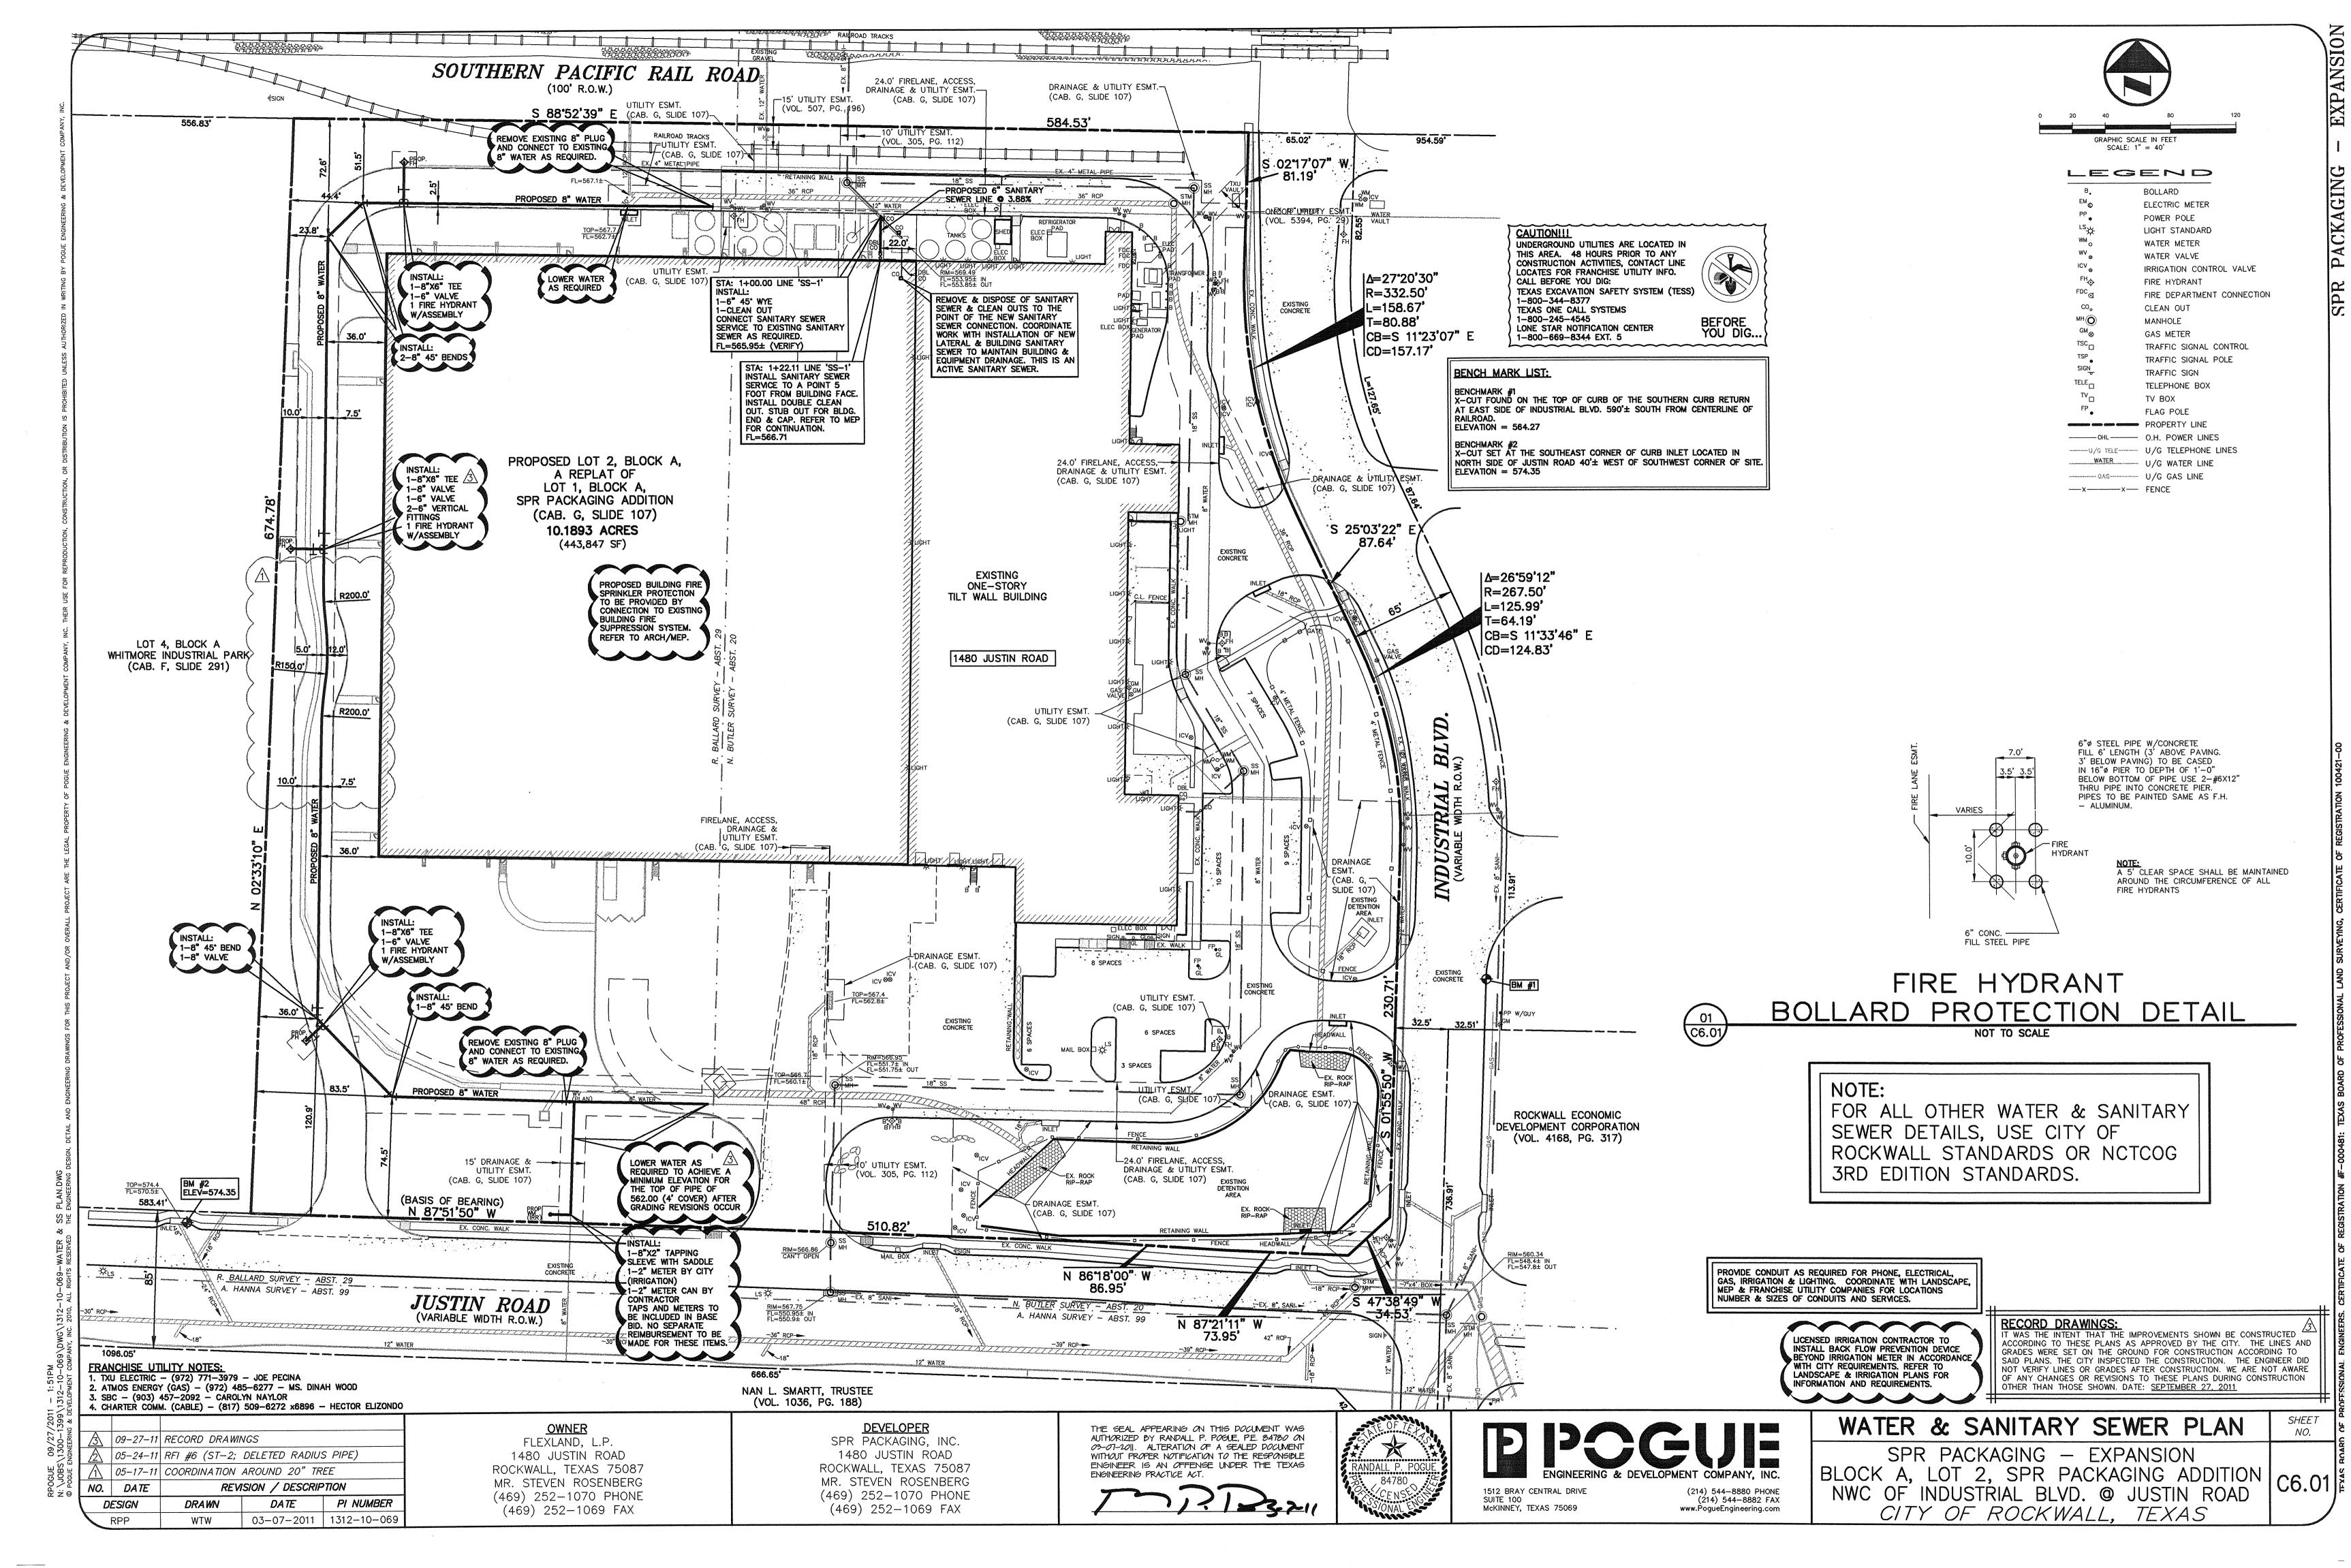21. REFER TO THE ARCHITECTURAL AND M.E.P. PLANS FOR COORDINATION OF

- 23. PRIOR TO THE COMMENCEMENT OF ANY CONSTRUCTION ACTIVITIES, THE CONTRACTOR SHALL SUBMIT BOND AND THREE WAY CONTRACTS TO THE CITY
- 24. ALL FILL SHALL BE COMPACTED WITH A SHEEPS FOOT ROLLER (MIN 95%).

### WATER AND SANITARY SEWER GENERAL NOTES:

- 1. ALL WORK UNLESS OTHERWISE NOTED, SHALL CONFORM TO THE STANDARD SPECIFICATIONS FOR PUBLIC WORKS CONSTRUCTION, AS ISSUED BY THE NORTH CENTRAL TEXAS COUNCIL OF GOVERNMENTS. AND THE CITY OF ROCKWALL STANDARD CONSTRUCTION SPECIFICATIONS. COPIES OF NCTCOG SPECIFICATIONS 3rd VERSION CAN BE OBTAINED BY CONTACTING NCTCOG @ (817) 640-3300
- 2. UNLESS OTHERWISE NOTED, ALL CONCRETE SHALL BE TYPE IA, CLASS 'A', 3000 PSI STRENGTH AT 28 DAYS. CONCRETE FOR INLET AND DRAINAGE STRUCTURES SHALL BE TYPE I, CLASS 'F', 4200 PSI STRENGTH AT 28 DAYS.
- 3. THE HORIZONTAL AND VERTICAL LOCATIONS OF EXISTING SUBSURFACE UTILITIES HAVE BEEN DETERMINED FROM DATA RECORDED BY OTHERS. THE CONTRACTOR SHALL VERIFY THAT ALL NECESSARY CROSSING CLEARANCES BETWEEN EXISTING AND PROPOSED UTILITIES EXIST PRIOR TO CONSTRUCTION OF ANY SUCH CROSSING. IT IS THE RESPONSIBILITY OF THE CONTRACTOR TO VERIFY SIZE AND LOCATION OF ALL UTILITIES PRIOR TO CONSTRUCTION. IT WILL BE THE RESPONSIBILITY OF THE CONTRACTOR TO PROTECT ALL PUBLIC UTILITIES IN THE CONSTRUCTION OF THIS PROJECT.
- 4. IT WILL BE THE RESPONSIBILITY OF THE CONTRACTOR TO PROTECT ALL MANHOLES, CLEAN OUTS, VALVE BOXES, FIRE HYDRANTS, ETC. THEY MUST BE ADJUSTED TO THE PROPER LINE AND GRADE BY THE CONTRACTOR PRIOR TO AND AFTER THE PLACING OF PERMANENT PAVING AND GRADING. UTILITIES MUST BE MAINTAINED TO PROPER LINE AND GRADE THROUGHOUT THE CONSTRUCTION OF THIS PROJECT.
- 5. CONTRACTOR SHALL MAINTAIN ONE SET OF "RECORD DRAWINGS" ON SITE WHICH WILL BE SUBMITTED TO THE OWNER OR ENGINEER UPON COMPLETION OF THE PROJECT. RECORD DRAWINGS SHALL INDICATE THE LOCATION OF ALL SUBTERRANEAN UTILITY IMPROVEMENTS AND/OR RELOCATIONS. THEY SHALL ALSO INCLUDE DIMENSIONAL TIES TO ALL MANHOLES, CULVERTS, INLETS, JUNCTION BOXES, FIRE HYDRANTS, ETC.
- 6. CONTRACTOR SHALL BE RESPONSIBLE FOR MAINTAINING AND BEING IN COMPLIANCE WITH ALL FEDERAL (O.S.H.A. STANDARDS AND REGULATIONS). STATE AND LOCAL REGULATIONS REGARDING TRENCH SAFETY.
- 7. BARRICADING AND PROJECT SIGNS SHALL CONFORM TO "STATE DEPARTMENT OF HIGHWAYS AND PUBLIC TRANSPORTATION BARRICADING AND CONSTRUCTION STANDARDS" ON TXDOT ROADWAYS AND "TEXAS MANUAL ON UNIFORM TRAFFIC CONTROL DEVICES. PART VI" FOR PRIVATE WORK. BARRICADES AND PROJECT SIGNS SHALL ALSO MEET CITY CODE.
- 8. ALL WATER MAINS 12" IN DIAMETER OR LESS SHALL BE PVC C-900, DR 14, CLASS 200.
- 9. ALL WATER MAINS UNLESS OTHERWISE NOTED SHALL HAVE A MINIMUM COVER OF 48 INCHES (4" THRU 8"); 60 INCHES (10" THRU 12"); 72 INCHES (14 INCHES AND LARGER) TO THE TOP OF PIPE BELOW FINISHED GRADES.
- 10. ALL WATER SERVICES TO BE INSTALLED IN ACCORDANCE TO CITY REQUIREMENTS.
- 11. ALL SANITARY SEWER PIPE TO BE PVC SDR-35, UNLESS OTHERWISE NOTED.
- 12. CONTRACTOR TO TEST WATER AND SANITARY SEWER LINES IN ACCORDANCE WITH THE STANDARD CITY SPECIFICATIONS.
- 13. ALL METER BOXES TO BE LOCATED IN NON-TRAFFIC AREAS.
- 14. FIRE SPRINKLER LINE TO BE SIZED AND INSTALLED BY A STATE LICENSED FIRE SPRINKLER CONTRACTOR.
- 15. FIRE HYDRANTS SHALL BE PLACED 3 FEET FROM THE BACK OF CURB LOCATED AS SHOWN ON THE PLANS. THE FIRE HYDRANT SHALL BE CITY APPROVED AND PAINTED TO BE COLOR CODED PER CITY REQUIREMENTS. FIRE HYDRANTS TO HAVE 5 FOOT CLEARANCE AROUND.
- 16. ALL UTILITIES INSTALLED OUTSIDE OF AN EASEMENT SHALL BE INSTALLED BY A LICENSED PLUMBER AND INSPECTED BY THE CITY CODE ENFORCEMENT.
- 17. ALL DUCTILE IRON FITTINGS SHALL BE OF THE MECHANICAL JOINT TYPE OR SLIP JOINT AND SHALL BE CLASS D, OR CLASS 250 ON SIZES 12 INCHES AND SMALLER IN ACCORDANCE WITH A.W.W.A. SPECIFICATIONS C-110-64 AND C-111-64.
- 18. CONCRETE BLOCKING SHALL BE PROVIDED ON WATER MAINS AT ALL TEES. BENDS AND FIRE HYDRANTS PER STANDARD CITY SPECIFICATIONS. PAYMENT FOR CONCRETE BLOCKING SHALL BE SUBSIDIARY TO PIPE INSTALLATION AND SHALL BE INCLUDED IN THE BID PRICE THEREOF.
- 19. ANY CONCRETE, ROCK, DEBRIS OR MATERIAL DEEMED UNSUITABLE FOR SUB-GRADE BY THE ENGINEER SHALL BE DISPOSED OF OFF SITE AT THE CONTRACTOR'S EXPENSE.
- 20. TRENCH BACK FILL MATERIAL SHALL CONFORM TO THE REQUIREMENTS OF NCTCOG ITEM 6.2.10 AND SHALL BE MECHANICALLY COMPACTED IN ACCORDANCE WITH NCTCOG ITEM 6.2.9 TO A MINIMUM OF 95 PERCENT STANDARD PROCTOR DENSITY UNLESS OTHERWISE SHOWN ON THESE PLANS OR STATED IN THE CITY STANDARD SPECIFICATIONS OR IN THE GEOTECHNICAL REPORT.
- 21. EMBEDMENT FOR PIPES SHALL CONFORM TO THE REQUIREMENTS OF VERSION 3 NCTCOG ITEM 6.2.9 UNLESS OTHERWISE SHOWN ON THESE PLANS OR NOTED IN THE STANDARD CITY SPECIFICATIONS. CRUSHED STONE BEDDING OR APPROVED EQUAL SHALL BE PROVIDED BY THE CONTRACTOR WHEN ROCK IS ENCOUNTERED IN TRENCHES. THERE SHALL BE NO ADDITIONAL PAY ITEM OF THE CRUSHED STONE BEDDING. IF ROCK IS ENCOUNTERED. ROCK SPOIL SHALL NOT BE USED IN THE UPPER 1.5 FEET OF THE TRENCH. THE UPPER 1.5 FEET OF TRENCH SHALL BE BACK FILLED WITH QUALITY TOPSOIL. REFER TO DETAILS.
- 22. CLASS "B" EMBEDMENT SHALL BE USED FOR RCP PIPE.
- 23. CLASS "B-3" EMBEDMENT SHALL BE USED FOR PVC PIPE FOR WATER.
- 24. ROCK EMBEDMENT SHALL BE USED FOR PVC SEWER PIPE.
- 25. NOT USED
- 26. NOT USED
- 27. IF REQUIRED BY CONSTRUCTION, POWER POLES TO BE BRACED AND/OR RELOCATED AT THE CONTRACTOR'S EXPENSE.

### WATER AND SANITARY SEWER GENERAL NOTES CONT.:

- 28. REFER TO THE GEOTECHNICAL REPORT FOR REQUIREMENTS REGARDING FILL COMPACTION AND RELATED MOISTURE CONTENT.
- 29. TREES SHALL REMAIN AND BE PROTECTED UNLESS SPECIFIED OTHERWISE ON THE LANDSCAPE PLAN OR APPROVED BY THE OWNER AND THE CITY.
- 30. REFER TO THE ARCHITECTURAL AND M.E.P. PLANS FOR COORDINATION OF ALL UTILITY CONNECTIONS (ROOF DRAIN COLLECTION, WATER, SEWER, ETC.).
- 31. CONTRACTOR TO VERIFY ALL EXISTING UTILITIES FLOW LINES PRIOR TO BEGINNING CONSTRUCTION.
- 32. CONTRACTOR SHALL TIE A 1" WIDE PIECE OF RED PLASTIC FLAGGING TO THE END OF SEWER SERVICE AND SHALL LEAVE A MINIMUM OF 36" OF FLAGGING EXPOSED AFTER BACK FILL. AFTER CURB AND PAVING IS COMPLETE. CONTRACTOR SHALL MARK THE LOCATION OF THE SEWER SERVICE ON THE CURB OR PAVING WITH A RED LETTER 'S' IN ACCORDANCE WITH STANDARD CITY SPECIFICATIONS.
- 33. THE CONTRACTOR TO INSTALL THE WATER SERVICES TO A POINT 2 FEET FROM BACK OF THE CURB LINE AT A DEPTH OF 12 INCHES. THE METER BOX SHALL BE FURNISHED AND INSTALLED BY THE CONTRACTOR AFTER THE PAVING HAS BEEN COMPLETED AND THE FINE GRADING BEHIND THE CURB AND PAVING AREAS. EACH SERVICE LOCATION SHALL BE MARKED ON THE CURB OR PAVING WITH A BLUE LETTER "W" IN ACCORDANCE WITH STANDARD CITY SPECIFICATIONS AND TIED TO PROPERTY CORNERS ON THE "RECORD DRAWINGS"
- 34. VALVE BOXES SHALL BE FURNISHED AND SET ON EACH GATE VALVE. AFTER FINAL GRADING AND ALIGNMENT HAS BEEN COMPLETED, THE CONTRACTOR SHALL POUR A CONCRETE PAD BLOCK (24"X24"X6") AROUND ALL VALVES AS TO PROVIDE THE FINISHED GRADE OF THE PAD TO BE EQUAL TO THE FINISHED GRADES ADJACENT TO THE VALVES.
- 35. WHEN WATER AND SANITARY SEWER MAINS ARE INSTALLED, THEY SHALL BE INSTALLED NO CLOSER THAN NINE (9) FEET TO EACH OTHER IN ALL DIRECTIONS AS MEASURED FROM THE OUTSIDE OF THE PIPES. PARALLEL LINES SHALL BE INSTALLED IN SEPARATE TRENCHES. WHERE THE NINE FOOT SEPARATION DISTANCE CANNOT BE ACHIEVED OR MAINTAINED, THE FOLLOWING GUIDELINES SHALL APPLY:
  - A. WHERE A SANITARY SEWER PARALLELS A WATER LINE, THE SEWER SHALL BE CONSTRUCTED OF CAST IRON, DUCTILE IRON OR PVC PIPE MEETING ASTM SPECIFICATIONS WITH A PRESSURE RATING FOR BOTH THE PIPE AND JOINTS OF 150 PSI. THE VERTICAL SEPARATION SHALL BE A MINIMUM OF 2 FEET BETWEEN OUTSIDE DIAMETERS AND THE HORI-ZONTAL SEPARATION SHALL BE A MINIMUM OF FOUR FEET BETWEEN OUTSIDE DIAMETERS. THE SEWER SHALL BE LOCATED BELOW THE WATER. B. WHERE A SANITARY SEWER CROSSES A WATERLINE AND THE SEWER IS CONSTRUCTED OF CAST IRON, DUCTILE IRON OR PVC WITH A MINIMUM PRESSURE RATING OF 150 PSI, AN ABSOLUTE MINIMUM DISTANCE OF SIX INCHES BETWEEN OUTSIDE DIAMETERS SHALL BE MAINTAINED. IN ADDITION, THE SEWER SHALL BE LOCATED BELOW THE WATERLINE WHERE POSSIBLE AND ONE LENGTH OF SEWER PIPE MUST BE CENTERED ON THE WATERLINE. C. WHERE A SANITARY SEWER CROSSES UNDER A WATERLINE AND THE SEWER IS CONSTRUCTED OF ABS TRUSS PIPE, SIMILAR SEMI-RIGID PLASTIC COMPOSITE PIPE. CLAY PIPE OR CONCRETE PIPE WITH GASKETED JOINTS, A MINIMUM OF TWO FOOT SEPARATION DISTANCE SHALL BE MAINTAINED. IN ADDITION, THE SEWER SHALL BE LOCATED BELOW THE WATERLINE WHERE POSSIBLE AND ONE LENGTH OF THE SEWER PIPE MUST BE CENTERED ON THE WATERLINE.
  - D. WHERE A SEWER CROSSES OVER A WATERLINE ALL PORTIONS OF THE SEWER WITHIN NINE FEET OF THE WATERLINE SHALL BE CONSTRUCTED OF CAST IRON, DUCTILE IRON OR PVC PIPE WITH A PRESSURE RATING OF AT LEAST 150 PSI USING APPROPRIATE ADAPTERS. IN LIEU OF THIS PROCEDURE THE NEW CONVEYANCE MAY BE ENCASED IN A JOINT OF 150 PSI PRESSURE CLASS PIPE AT LEAST 18 FEET LONG AND TWO NOMINAL SIZES LARGER THAN THE NEW CONVEYANCE. THE SPACE AROUND THE CARRIER PIPE SHALL BE SUPPORTED AT FIVE FEET INTERVALS WITH SPACERS OR BE FILLED TO THE SPRING LINE WITH WASHED SAND. THE ENCASEMENT PIPE SHOULD BE CENTERED ON THE CROSSING AND BOTH ENDS SEALED WITH CEMENT GROUT OR MANUFACTURED SEAL.
  - E. THE SEWER NEED NOT BE DISTURBED WHERE A NEW WATERLINE IS TO BE INSTALLED PARALLEL TO AN EXISTING SEWER THAT SHOWS NO EVIDENCE OF LEAKAGE AND THE WATERLINE IS INSTALLED ABOVE THE SEWER A MIN-IMUM OF TWO FEET VERTICALLY AND FOUR FEET HORIZONTALLY. SHOULD EXCAVATION FOR THE WATERLINE PRODUCE EVIDENCE THAT THE SEWER IS LEAKING, THE SEWER MUST BE REPAIRED OR REPLACED AS DESCRIBED IN SUBPARAGRAPHS (A) OR (D) OF THIS PARAGRAPH.
  - F. THE SEWER NEED NOT BE DISTURBED WHERE A NEW WATERLINE IS TO CROSS OVER (BY TWO FEET OR MORE) EXISTING SEWER SHOWING NO EVIDENCE OF LEAKAGE. SHOULD EXCAVATION FOR THE WATERLINE PRODUCE EVIDENCE THAT THE SEWER IS LEAKING, THEN THE SEWER MUST BE REPAIRED OR REPLACED AS DESCRIBED IN SUBSECTIONS (C) OF (D) OF THIS PARAGRAPH.
- 36. REFER TO THE WATER AND SEWER PLANS FOR ADDITIONAL INFORMATION RELATED TO SAID CONSTRUCTION.
- 37. PRIOR TO THE COMMENCEMENT OF ANY CONSTRUCTION ACTIVITIES, THE CONTRACTOR SHALL SUBMIT BOND AND THREE WAY CONTRACTS TO THE CITY AND OWNER AS REQUIRED.
- 38. CONTRACTOR SHALL INSTALL BLUE EMS DISKS (WATER LINE) AT EVERY CHANGE IN DIRECTION, VALVES, & SERVICES. CONTRACTOR SHALL INSTALL GREEN EMS DISKS (SEWER) AT EVERY CHANGE IN DIRECTION, MANHOLE, CLEANOUT, AND SERVICES.

NO SAND OR GRANULAR MATERIAL ALLOWED FOR USE IN BACKFILL ABOVE ROCK EMBEDMENT.

ALL FILL SHALL BE COMPACTED WITH SHEEPS FOOT ROLLER AT A MINIMUM OF 95%.

# RECORD DRAWNGS:

IT WAS THE INTENT THAT THE IMPROVEMENTS SHOWN BE CONSTRUCTED ACCORDING TO THESE PLANS AS APPROVED BY THE CITY. THE LINES AND GRADES WERE SET ON THE GROUND FOR CONSTRUCTION ACCORDING TO SAID PLANS. THE CITY INSPECTED THE CONSTRUCTION. THE ENGINEER DID NOT VERIFY LINES OR GRADES AFTER CONSTRUCTION. WE ARE NOT AWARE OF ANY CHANGES OR REVISIONS TO THESE PLANS DURING CONSTRUCTION OTHER THAN THOSE SHOWN. DATE: SEPTEMBER 27, 2011

### LANDSCAPING GENERAL NOTES:

- 1. ALL MATERIALS FOR TURF GRASS PROVIDED SHALL BE IN ACCORDANCE WITH THE STANDARD SPECIFICATIONS FOR PUBLIC WORKS CONSTRUCTION, LATEST EDITION, AS ISSUED BY THE NORTH CENTRAL TEXAS COUNCIL OF GOVERNMENTS, AND THE CITY SPECIFICATIONS AND AS NOTED IN THE PLANS AND CONTRACT DOCUMENTS.
- 2. BERMUDA GRASS SEED. TURF GRASS SEED SHALL BE "CYNODON DACTYLON" (COMMON BERMUDA GRASS). THE SEED SHALL BE HARVESTED WITHIN ONE YEAR PRIOR TO PLANTING, FREE OF JOHNSON GRASS, FIELD BIND WEED, DODDER SEED. AND FREE OF OTHER WEED SEED TO THE LIMITS ALLOWABLE UNDER THE FEDERAL SEED ACT AND APPLICABLE SEED LAWS. THE SEED SHALL NOT BE A MIXTURE. THE SEED SHALL BE HULLED, EXTRA FANCY GRADE, TREATED WITH FUNGICIDE AND HAVE A GERMINATION AND PURITY THAT SHALL PRODUCE, AFTER ALLOWANCE FOR FEDERAL SEED ACT TOLERANCES, A PURE LIVE SEED CONTENT OF NOT LESS THAN 85%, USING THE FORMULA: PURITY PERCENT TIME (GERMINATION PERCENT TIMES PLUS HARD OR SOUND SEED FIVE PERCENT). SEED SHALL BE LABELED IN ACCORDANCE WITH U.S. DEPARTMENT OF AGRICULTURE RULES AND REGULATIONS.
- A. CERTIFICATE SUBMITTAL. PRIOR TO PLANTING, PROVIDE THE OWNER AND ENGINEER WITH THE STATE OF TEXAS CERTIFICATE STATING ANALYSIS OF PURITY AND GERMINATION OF SEED.
- 3. RYE GRASS SEED. TURF GRASS SEED SHALL BE "LOLIUM MULTIFLORUM" (ITALIAN OR ANNUAL RYE GRASS). THE SEED SHALL BE HARVESTED WITHIN ONE YEAR PRIOR TO PLANTING AND SHALL BE FREE OF PERENNIAL RYE GRASS SEED, OTHER GRASS SEED AND WEED SEED TO THE LIMITS ALLOWABLE UNDER THE FEDERAL SEED ACT AND APPLICABLE SEED LAWS. SEED SHALL BE AT LEASE 95% PURE AND SHALL HAVE A 90% MINIMUM GERMINATION RATE.
- A. CERTIFICATE SUBMITTAL. PRIOR TO PLANTING, PROVIDE THE OWNER AND ENGINEER WITH THE STATE OF TEXAS CERTIFICATE STATING ANALYSIS OF PURITY AND GERMINATION OF SEED.
- 4. TIMES OF HYDROMULCHING SHALL BE AS FOLLOWS:
- A. SEPTEMBER 1 TO APRIL 1 RYE GRASS SEED SHALL BE APPLIED. B. APRIL 2 TO AUGUST 31 - BERMUDA GRASS SEED SHALL BE APPLIED.
- 5. 75% 80% OF ALL DISTURBED AREAS SHALL HAVE MINIMUM 1" (HEIGHT) OF GRASS ESTABLISHED PRIOR TO CITY ACCEPTANCE.
- 6. REFER TO LANDSCAPE DRAWINGS FOR ADDITIONAL NOTES AND SPECIFICATIONS. IN THE EVENT OF CONFLICT, MOST STRINGENT INTERPRETATION, SPECIFICATION, OR REQUIREMENTS SHALL APPLY.

09-27-11 RECORD DRAWINGS 05-24-11 RFI #6 (ST-2; DELETED RADIUS PIPE) | 05-17-11 | COORDINATION AROUND 20" TREE REVISION / DESCRIPTION NO. DATE PI NUMBER DESIGN DRAWN DATE 03-07-2011 | 1312-10-069 WTW


RELATED TO SAID CONSTRUCTION.

AND OWNER AS REQUIRED.

<u>OWNER</u> FLEXLAND, L.P. 1480 JUSTIN ROAD ROCKWALL, TEXAS 75087 MR. STEVEN ROSENBERG (469) 252-1070 PHONE (469) 252-1069 FAX

**DEVELOPER** SPR PACKAGING, INC. 1480 JUSTIN ROAD ROCKWALL, TEXAS 75087 MR. STEVEN ROSENBERG (469) 252-1070 PHONE (469) 252-1069 FAX

THE SEAL APPEARING ON THIS DOCUMENT WAS AUTHORIZED BY RANDALL P. POGUE, P.E. 84780 ON 03-07-2011. ALTERATION OF A SEALED DOCUMENT WITHOUT PROPER NOTIFICATION TO THE RESPONSIBLE ENGINEER IS AN OFFENSE UNDER THE TEXAS ENGINEERING PRACTICE ACT.

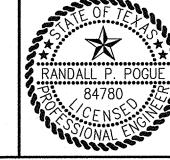




GENERAL NOTES SHEET

SPR PACKAGING - EXPANSION BLOCK A, LOT 2, SPR PACKAGING ADDITION NWC OF INDUSTRIAL BLVD. @ JUSTIN ROAD CITY OF ROCKWALL, TEXAS

NO.

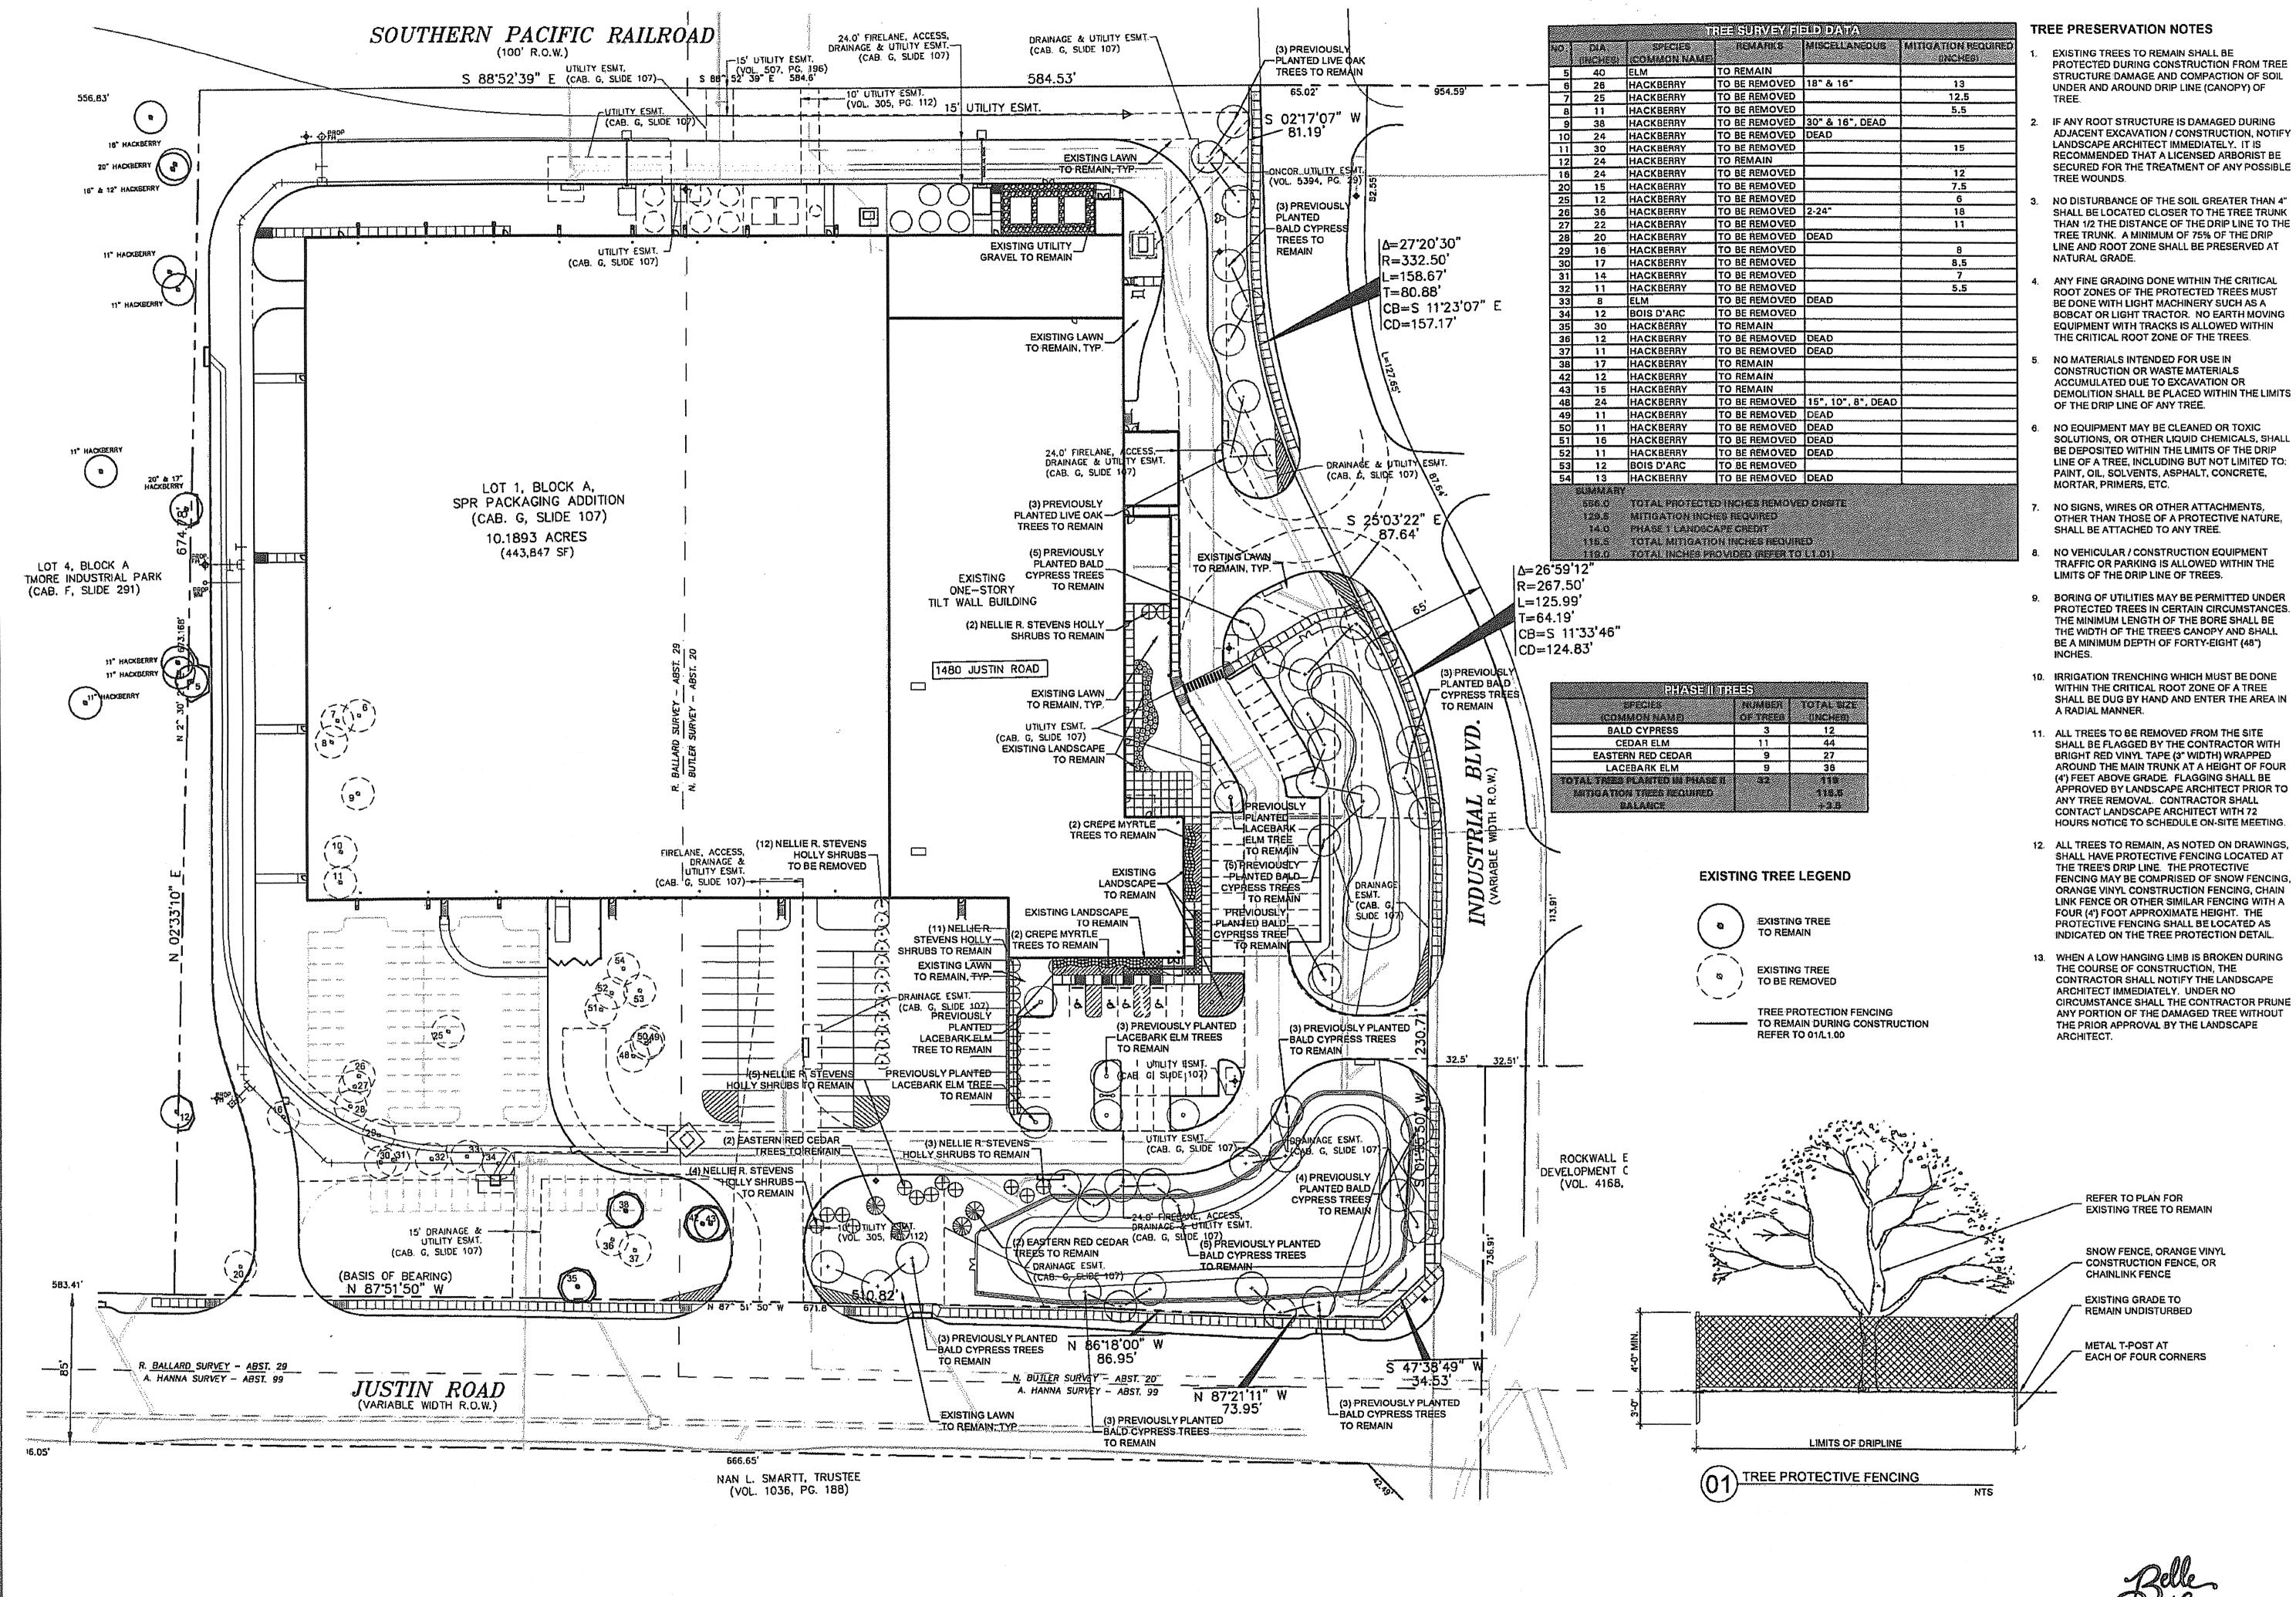

TREE PRESERVATION PLAN

0 20 40 60 80 120

SCALE IN FEET: 1"=40'-0"

Belle 823 Brookhurst Drive Dallas, Texas 75218 214.708.5274 www.bellefirma.com checked KH date 03/07/2011

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NOTE: ALL TREES SHALL HAVE STRAIGHT TRUNKS AND BE MATCHING WITHIN VARIETIES.

PLANT LIST IS AN AID TO BIDDERS ONLY. CONTRACTOR SHALL VERIFY ALL QUANTITIES ON PLAN.

ALL HEIGHTS AND SPREADS ARE MINIMUMS. ALL PLANT MATERIAL SHALL MEET OR EXCEED REMARKS AS INDICATED.

### LANDSCAPE NOTES

- 1. CONTRACTOR SHALL VERIFY ALL EXISTING AND PROPOSED SITE ELEMENTS AND NOTIFY LANDSCAPE ARCHITECT OF ANY DISCREPANCIES. SURVEY DATA OF EXISTING CONDITIONS WAS SUPPLIED BY OTHERS.
- 2. CONTRACTOR SHALL LOCATE ALL EXISTING UNDERGROUND UTILITIES AND NOTIFY LANDSCAPE ARCHITECT OF ANY CONFLICTS. CONTRACTOR SHALL **EXERCISE CAUTION WHEN WORKING IN THE VICINITY OF** UNDERGROUND UTILITIES.
- 3. CONTRACTOR SHALL PROVIDE A MINIMUM 2% SLOPE AWAY FROM ALL STRUCTURES, UNLESS NOTED OTHERWISE ON GRADING PLAN.
- 4. CONTRACTOR SHALL FINE GRADE AREAS TO ACHIEVE FINAL CONTOURS AS INDICATED. LEAVE AREAS TO RECEIVE TOPSOIL 1" BELOW FINAL FINISHED GRADE IN
- 5. ALL PLANTING BEDS AND LAWN AREAS SHALL BE SEPARATED BY STEEL EDGING. NO STEEL EDGING SHALL BE INSTALLED ADJACENT TO BUILDINGS, WALKS, OR CURBS. CUT STEEL EDGING AT 45 DEGREE ANGLE WHERE IT INTERSECTS WALKS AND CURBS.
- 6. TOP OF MULCH SHALL BE 1/2" MINIMUM BELOW THE TOP OF WALKS AND CURBS.
- 7. ALL LAWN AREAS SHALL BE HYDROMULCH BERMUDAGRASS, UNLESS OTHERWISE NOTED ON THE
- 8. ALL LANDSCAPE AREAS SHALL BE 100% IRRIGATED WITH AN UNDERGROUND AUTOMATIC IRRIGATION SYSTEM AND SHALL INCLUDE RAIN AND FREEZE SENSORS,
- 9. CONTRACTOR SHALL PROVIDE BID PROPOSAL LISTING UNIT PRICES FOR ALL MATERIAL PROVIDED.
- 10. CONTRACTOR SHALL BE RESPONSIBLE FOR OBTAINING ALL REQUIRED LANDSCAPE AND IRRIGATION PERMITS.

### **MAINTENANCE NOTES**

- 1. THE OWNER, TENANT AND THEIR AGENT, IF ANY, SHALL BE JOINTLY AND SEVERALLY RESPONSIBLE FOR THE MAINTENANCE OF ALL LANDSCAPE.
- 2. ALL LANDSCAPE SHALL BE MAINTAINED IN A NEAT AND ORDERLY MANNER AT ALL TIMES. THIS SHALL INCLUDE MOWING, EDGING, PRUNING, FERTILIZING, WATERING, WEEDING AND OTHER SUCH ACTIVITIES COMMON TO LANDSCAPE MAINTENANCE.
- 3. ALL LANDSCAPE AREAS SHALL BE KEPT FREE OF TRASH LITTER, WEEDS AND OTHER SUCH MATERIAL OR PLANTS NOT PART OF THIS PLAN.
- 4. ALL PLANT MATERIAL SHALL BE MAINTAINED IN A HEALTHY AND GROWING CONDITION AS IS APPROPRIATE FOR THE SEASON OF THE YEAR.
- 5. ALL PLANT MATERIAL WHICH DIES SHALL BE REPLACED WITH PLANT MATERIAL OF EQUAL OR BETTER VALUE.
- 6. CONTRACTOR SHALL PROVIDE SEPARATE BID PROPOSAL FOR ONE YEAR'S MAINTENANCE TO BEGIN AFTER FINAL ACCEPTANCE.

## HYDROMULCH NOTES

- 1. CONTRACTOR SHALL SCARIFY, RIP AND LOOSEN ALL AREAS TO BE HYDROMULCHED TO A MINIMUM DEPTH OF
- 2. BERMUDAGRASS SEED SHALL BE EXTRA HULLED AND TREATED LAWN TYPE, SHALL BE DELIVERED TO THE SITE IN ITS ORIGINAL UNOPENED CONTAINER AND SHALL MEET STATE LAW REQUIREMENTS.
- 3. FIBER SHALL BE ONE HUNDRED PERCENT (100%) WOOD CELLULOSE FIBER, DELIVERED TO THE SITE IN ITS ORIGINAL UNOPENED CONTAINER AS MANUFACTURED BY 'CONWEB' OR EQUAL.
- 4. FIBER TACK SHALL BE DELIVERED TO THE SITE IN ITS ORIGINAL UNOPENED CONTAINER AND SHALL BE TERRO-TACK ONE', AS MANUFACTURED BY GROWERS, INC. OR EQUAL.
- 5. HYDROMULCH WITH BERMUDAGRASS SEED AT A RATE OF TWO (2) POUNDS PER ONE THOUSAND (1000) SQUARE
- 6. USE A 4'X8' BATTER BOARD AGAINST ALL BED AREAS.
- 7. IF INSTALLATION OCCURS BETWEEN SEPTEMBER 1 AND MAY 1, ALL HYDROMULCH AREAS TO BE WINTER RYEGRASS, AT A RATE OF FOUR (4) POUNDS PER ONE THOUSAND (1000) SQUARE FEET. CONTRACTOR SHALL BE REQUIRED TO RE-HYDROMULCH WITH BERMUDAGRASS THE FOLLOWING GROWING SEASON AS PART OF THIS CONTRACT.
- 8. ALL LAWN AREAS TO BE HYDROMULCHED SHALL HAVE ONE HUNDRED (100%) PERCENT COVERAGE PRIOR TO FINAL ACCEPTANCE.

NO TREES WITHIN 5'-0" OF ANY UTILITIES.

### **GENERAL LAWN NOTES**

- 1. CONTRACTOR SHALL COORDINATE OPERATIONS AND AVAILABILITY OF EXISTING TOPSOIL WITH ON-SITE CONSTRUCTION MANAGER.
- 2. CONTRACTOR SHALL LEAVE LAWN AREAS 1" BELOW FINAL FINISHED GRADE PRIOR TO TOPSOIL INSTALLATION.
- 3. CONTRACTOR SHALL FINE GRADE AREAS TO ACHIEVE FINAL CONTOURS AS INDICATED ON CIVIL PLANS. ADJUST CONTOURS TO ACHIEVE POSITIVE DRAINAGE AWAY FROM BUILDINGS. PROVIDE UNIFORM ROUNDING AT TOP AND BOTTOM OF SLOPES AND OTHER BREAKS IN GRADE. CORRECT IRREGULARITIES AND AREAS WHERE WATER MAY STAND.
- 4. ALL LAWN AREAS SHALL BE FINE GRADED, IRRIGATION TRENCHES COMPLETELY SETTLED AND FINISH GRADE APPROVED BY THE OWNER'S CONSTRUCTION MANAGER OR LANDSCAPE ARCHITECT PRIOR TO LAWN INSTALLATION.
- 5. CONTRACTOR SHALL REMOVE ALL ROCKS 3/4" DIAMETER AND LARGER, DIRT CLODS, STICKS, CONCRETE SPOILS, ETC. PRIOR TO PLACING TOPSOIL AND LAWN INSTALLATION.
- 6. CONTRACTOR SHALL MAINTAIN ALL LAWN AREAS UNTIL FINAL ACCEPTANCE. THIS SHALL INCLUDE, BUT NOT LIMITED TO: MOWING, WATERING, WEEDING, CULTIVATING, CLEANING AND REPLACING DEAD OR BARE AREAS TO KEEP PLANTS IN A VIGOROUS, HEALTHY
- CONTRACTOR SHALL GUARANTEE ESTABLISHMENT OF ACCEPTABLE TURF AREA AND SHALL PROVIDE REPLACEMENT FROM LOCAL SUPPLY IF NECESSARY.

### PRUNING AND TRIMMING NOTES

- 1. CONTRACTOR SHALL SCHEDULE ON-SITE MEETING WITH LANDSCAPE ARCHITECT TO REVIEW PRUNING **GUIDELINES PRIOR TO COMMENCING ANY WORK.**
- 2. PRUNE ALL EXISTING TREES ON-SITE USING THE FOLLOWING GUIDELINES.
- 3. ALL TREES SHALL BE TRIMMED SO THAT NATURAL SHAPES OF THE PLANTS ARE RETAINED.
- 4. DO NOT 'TOP' OR HEAD' TREES.
- 5. IF BALLING OR SHEARING OF TREES HAS OCCURRED IN THE PAST, DISCONTINUE THIS PRACTICE AND ALLOW PLANTS TO GROW INTO NATURAL SHAPE.
- 6. REMOVE SUCKERS, DEAD, DYING, DISEASED, BROKEN AND / OR WEAK BRANCHES FROM ALL TREES ALONG THE MAIN TRUNK STRUCTURE AND WITHIN THE BRANCHING
- CONTRACTOR SHALL PRUNE EXISTING DECIDUOUS HARDWOOD BY REMOVING LOWER LIMBS TO RAISE THE CANOPY, THE BOTTOM OF THE CANOPY SHALL BE RAISED TO 12'-0" ABOVE GRADE FOR DECIDUOUS HARDWOOD TREES, WHEN POSSIBLE. THE INTEGRITY OF THE CANOPY AND STRUCTURE OF THE TREE SHALL BE MAINTAINED. DO NOT CUT OR PRUNE CENTRAL
- 8. CONTRACTOR SHALL THIN THE CANOPY BY ONE-FOURTH, PRUNE TREE TO EVENLY SPACE BRANCHES WITHIN THE CANOPY WHENEVER POSSIBLE REMOVE THOSE LIMBS THAT CROSS OTHERS, DOUBLE LEADERS AND THOSE THAT EXCESSIVELY EXTEND BEYOND THE NATURAL CROWN OF THE TREE.
- 9. CONTRACTOR SHALL PROVIDE DEEP ROOT FEEDING AND INVIGORATION OF EXISTING TREES. THIS SHALL BE ORGANIC BASED NUTRIENTS BASED FOR ROOT GROWTH AND LEAF GROWTH STIMULATION.
- 10. CONTRACTOR SHALL BE REQUIRED TO CHIP ALL REMOVED BRANCHES, LEAFS, ETC.

### LANDSCAPE TABULATIONS THE CITY OF ROCKWALL, TEXAS

SCREENING OF OFF-STREET LOADING DOCKS 1, 6' height screening of loading docks required from all public

STREET LANDSCAPING 1. 10' wide landscape buffer with one tree per 50 f.f.

JUSTIN ROAD - 872 LL (13) trees, 3" cal.

INDUSTRIAL BLVD, - 664 Lf. (14) trees, 3° cal. (14) trees, 3" cal.

(13) trees, 3" cal.

3,193 s.f. (5%)

118,332 a.f. (27%)

118,332 a.f. (27%)

214.708.5274 www.bellefirma.com

### PARKING LOT LANDSCAPING 5% of the interior parking lot shall be landscape. One (1) large tree per 10 spaces. No required parking space more than 80' from a tree.

Total interior parking lot area = 59,504 s.f. Total parking spaces = 100 spaces

### 2,975 s.f. (5%) (10) trees, 3" cal.

(10) trees, 3" cal. all spaces within 80° of tree all spaces within 80° of tree SITE LANDSCAPING 10% of the total site shall be landscaped for LIGHT

### 100% of the total requirements shall be located in the front of and along side buildings for "LL"

Total site = 10.18 AC; 443,848 s.f.

### 44,385 s.f. (10%) 44,385 a.f. (100%)

DETENTION BASINS 1. One (1) large tree per 750 s.f. of dry land area.

SOUTH DETENTION POND - 15,507 s.f. (21) trees, 3" cal. (21) trees, 3° cal.

EAST DETENTION POND - 10,725 s.f. (14) troes, 3" cal.

> 823 Brookhurst Drive Dallas, Texas 75218

sheet

job no

### PART 1 - GENERAL

### 1.1 REFERENCED DOCUMENTS

A. Refer to Landscape Plans, notes, details, bidding requirements, special provisions, and schedules for additional requirements.

### 1.2 DESCRIPTION OF WORK

- A. Work included: Furnish all supervision, labor, materials, services, equipment and appliances required to complete the work covered in conjunction with the landscaping covered in these specifications and landscaping plans, including:
- Planting (trees, shrubs and grasses)
- Bed preparation and fertilization
- Notification of sources
- Water and maintenance until final acceptance
- 5. Guarantee

### 1.3 REFERENCE STANDARDS

- A. American Standard for Nursery Stock published by American Association of Nurserymen: 27 October 1980, Edition; by American National Standards Institute, Inc. (260.1) - plant material
- B. American Joint Committee on Horticultural Nomenclature: 1942 Edition of Standardized Plant Names.
- C. Texas Association of Nurserymen, Grades and Standards
- D. Hortis Third, 1976 Comell University

# 1.4 NOTIFICATION OF SOURCES AND SUBMITTALS

A. Samples: Provide representative quantities of sandy loam soil, mulch, bed mix material, gravel and crushed stone. Samples shall be approved by Owner's Authorized Representative before use on the

### 1.5 JOB CONDITIONS

- A. General Contractor to complete the following punch list: Prior to Landscape Contractor initiating any portion of landscape installation, General Contractor shall leave planting bed areas three (3") inches below final finish grade of sidewalks, drives and curbs as shown on the drawings. All lawn areas to receive solid sod shall be left one (1") inch below the final finish grade of sidewalks, drives and curbs. All construction debris shall be removed prior to Landscape Contractor beginning any work.
- B. Storage of materials and equipment at the job site will be at the risk of the Landscape Contractor. The Owner cannot be held responsible for theft or damage.

### 1.6 MAINTENANCE AND GUARANTEE

- 1. The Landscape Contractor shall be held responsible for the maintenance of all work from the time of planting until final acceptance by the Owner. No trees, shrubs, groundcover or grass will be accepted unless they show healthy growth and satisfactory foliage conditions.
- 2. Maintenance shall include watering of trees and plants, cultivation, weeding spraying, edging, pruning of trees, mowing of grass, cleaning up and all other work necessary of maintenance.
- 3 A written notice requesting final inspection and acceptance should be submitted to the Owner at least seven (7) days prior to completion. An on-site inspection by the Owner's Authorized Representative will be completed prior to written acceptance.
- 1. Trees, shrubs and groundcover shall be guaranteed for a twelve (12) month period after final acceptance. The Contractor shall

- replace all dead materials as soon as weather permits and upon notification of the Owner, Plants, including trees, which have partially died so that shape, size, or symmetry have been damaged, shall be considered subject to replacement. In such cases, the opinion of the Owner shall be final.
- a. Plants used for replacement shall be of the same size and kind as those originally planted and shall be planted as originally specified. All work, including materials, labor and equipment used in replacements, shall carry a twelve (12) month guarantee. Any damage, including ruts in lawn or bed areas, incurred as a result of making replacements shall be 1.8 PRODUCT DELIVERY, STORAGE AND HANDLING immediately repaired.
- b. At the direction of the Owner, plants may be replaced at the start of the next year's planting season. In such cases, dead plants shall be removed from the premises immediately.
- c. When plant replacements are made, plants, soil mix, fertilizer and mulch are to be utilized as originally specified and re-inspected for full compliance with the contract requirements. All replacements are to be included under "Work" of this section,
- 2. The Owner agrees that for the guarantee to be effective, he will water plants at least twice a week during dry periods and cultivate beds once a month after final acceptance.
- 3. The above guarantee shall not apply where plants die after acceptance because of injury from storms, hall, freeze, insects, diseases, injury by humans, machines or theft.
- Acceptance for all landscape work shall be given after final inspection by the Owner provided the job is in a complete, undamaged condition and there is a stand of grass in all lawn areas. At that time, the Owner will assume maintenance on the accepted work.
- C. Repairs: Any necessary repairs under the Guarantee must be made within ten (10) days after receiving notice, weather permitting. In the event the Landscape Contractor does not make repairs accordingly, the Owner, without further notice to Contractor, may provide materials and men to make such repairs at the expense to the Landscape Contractor.

### 1.7 QUALITY ASSURANCE

- A. General: Comply with applicable federal, state, county and local PART 2 PRODUCTS regulations governing landscape materials and work.
- B. Personnel: Employ only experienced personnel who are familiar with the required work. Provide full time supervision by a qualified foreman acceptable to Landscape Architect

- C. Selection of Plant Material: 1. Make contact with suppliers immediately upon obtaining notice of contract acceptance to select and book materials. Develop a program of maintenance (pruning and fertilization) which will ensure the purchased materials will meet and / or exceed project specifications.
- Substitutions: Do not make plant material substitutions, if the specified landscape material is not obtainable, submit proof of non-availability to Landscape Architect, together with proposal for use of equivalent material. At the time bids are submitted, the Contractor is assumed to have located the materials necessary to complete the job as specified.
- 3. Landscape Architect will provide a key identifying each tree location on site. Written verification will be required to document material selection, source and delivery schedules to site.
- 4. Measurements: Measure trees with branches and trunks or canes in their normal position. Do not prune to obtain required sizes. Take caliper measurements six inches above ground for trees up to and including 4" caliper size, and twelve inches above ground for larger sizes. Measure main body of all plant material of height and spread dimensions, do not measure from branch or root
- 5. Owner's Authorized Representative shall inspect all plant material with requirements for genus, species, cultivar / variety size and

NOT TO SCALE

### 6. Owner's Authorized Representative retains the right to further inspect all plant material upon arrival to the site and during installation for size and condition of root balls and root systems, limbs, branching habit, insects, injuries and latent defects.

7. Owner's Authorized Representative may reject unsatisfactory or defective material at any time during the process work. Remove 2.2 SOIL PREPARATION MATERIALS rejected materials immediately from the site and replace with acceptable material at no additional cost to the Owner. Plants damaged in transit or at job site shall be rejected.

- 1. Balled and Burlapped (B&B) Plants: Dig and prepare shipment in a manner that will not damage roots, branches, shape and future
- 2. Container Grown Plants: Deliver plants in rigid container to hold ball shape and protect root mass.

- Deliver packaged materials in sealed containers showing weight, analysis and name of manufacturer. Protect materials from deterioration during delivery and while stored on site.
- Deliver only plant materials that can be planted in one day unless adequate storage and watering facilities are available on job site.
- Protect root balls by heeling in with sawdust or other approved moisture retaining material if not planted within 24 hours of
- 4. Protect plants during delivery to prevent damage to root balls or desiccation of leaves. Keep plants moist at all times. Cover all materials during transport.
- 5. Notify Owner's Authorized Representative of delivery schedule 72 hours in advance job site.
- 6. Remove rejected plant material immediately from job site.
- 7. To avoid damage or stress, do not lift, move, adjust to plumb, or otherwise manipulate plants by trunk or stems.

- A. General: Well-formed No. 1 grade or better nursery grown stock. Listed plant heights are from tops of root balls to nominal tops of plants. Plant spread refers to nominal outer width of the plant, not to the outer leaf tips. Plants will be individually approved by the Owner's Authorized Representative and his decision as to their acceptability shall be final.
- Quantities: The drawings and specifications are complimentary. Anything called for on one and not the other is as binding as if shown and called for on both. The plant schedule is an aid to bidders only. Confirm all quantities on plan.
- C. Quality and size; Plant materials shall conform to the size given on the PART 3 EXECUTION plan, and shall be healthy, symmetrical, well-shaped, full branched and well rooted. The plants shall be free from injunous insects, diseases, 3,1 BED PREPARATION & FERTILIZATION injuries to the bark or roots, broken ranches, objectionable disfigurements, insect eggs and larvae, and are to be of specimen
- Approval: All plants which are found unsuitable in growth, or are in any unhealthy, badly shaped or undersized condition will be rejected by the Owner's Authorized Representative either before or after planting and shall be removed at the expense of the Landscape Contractor and replaced with acceptable plant as specified at no additional cost to the
- Trees shall be healthy, full-branched, well-shaped, and shall meet the minimum trunk and diameter requirements of the plant schedule. Balls shall be firm, neat, slightly tapered and well wrapped in burlap. Any tree loose in the ball or with a broken root ball at time of planting will be rejected. Balls shall be ten (10") Inched in diameter for each one (1") inch of trunk diameter, measured six (6") inched above ball. (Nomenclature confirms to the customary nursery usage. For clarification, the term "multi-trunk" defines a plant having three (3) or

## more trunks of nearly equal diameter.)

Pruning: All pruning of trees and shrubs, as directed by the Landscape Architect prior to final acceptance, shall be executed by the Landscape Contractor at no additional cost to the Owner.

- 1. Friable, fertile, dark, loamy soil, free of clay lumps, subsoil, stones and other extraneous material and reasonably free of weeds and foreign grasses. Loam containing Dallasgrass or Nutgrass shall
- 2. Physical properties as follows:
- a. Clay between 7-27 percent b. Silt - between 15-25 percent c. Sand - less than 52 percent
- Organic matter shall be 3%-10% of total dry weight.
- 4. If requested, Landscape Contractor shall provide a certified soil analysis conducted by an approved soil testing laboratory verifying that sandy loam meets the above requirements.
- B. Organic Material: Compost with a mixture of 80% vegetative matter and 20% animal waste. Ingredients should be a mix of course and fine
- C. Premixed Bedding Soil as supplied by Vital Earth Resources, surface in original place of growth. Gladewater, Texas; Professional Bedding Soil as supplied by Living Earth Technology, Dallas, Texas or Acid Gro Municipal Mix as supplied by Soil Building Systems, Dallas, Texas or approved equal.
- D. Sharp Sand: Sharp sand must be free of seeds, soil particles and
- E. Mulch: Double Shredded Hardwood Mulch, partially decomposed, dark brown. Living Earth Technologies or approved equal.
- F. Organic Fertilizer: Fertilaid, Sustane, or Green Sense or equal as recommended for required applications. Fertilizer shall be delivered to the site in original unopened containers, each bearing the
- G. Commercial Fertilizer: 10-20-10 or similar analysis. Nitrogen source to be a minimum 50% slow release organic Nitrogen (SCU or UF) with a minimum 8% sulfur and 4% iron, plus icronutrients.
- H. Peat: Commercial sphagnum peat moss or partially decomposed shredded pine bark or other approved organic material.

### 2,3 MISCELLANEOUS MATERIALS

- A. Steel Edging: 3/16" x 4" x 16" dark green, DURAEDGE® steel landscape edging manufactured by The J.D. Russell Company under its trade name DURAEDGE Heavy Duty Steel.
- :B. Staking Material for Shade Trees: refer to details.

manufacturer's guaranteed statement of analysis.

- A. Landscape Contractor to inspect all existing conditions and report any deficiencies to the Owner.
- 8. All planting areas shall be conditioned as follows:
- 1. Prepare new planting bads by scraping away existing grass and weeds as necessary. Till existing soil to a depth of six (6") inches prior to placing compost and fertilizer. Apply fertilizer as per Manufacturer's recommendations. Add six (6") inches of compost and till into a depth of six (6") inches of the topsoil. Apply organic fertifizer such as Sustans or Green Sense at the rate of twenty (20) pounds per one thousand (1,000) square feet.
- 2. All planting areas shall receive a two (2") inch layer of specified mulch.
- 3. Backfill for tree pits shall be as follows: Use existing top soil

### on site (use imported topsoil as needed) free from large clumps, rocks, debris, caliche, subsoils, etc., placed in nine (9") inch layers and watered in thoroughly,

### 3.2 INSTALLATION

- A. Maintenance of plant materials shall begin immediately after each plant is delivered to the site and shall continue until all construction has been satisfactorily accomplished.
- B. Plant materials shall be delivered to the site only after the beds are prepared and areas are ready for planting. All shipments of nursery materials shall be thoroughly protected from the drying winds during transit. All plants which cannot be planted at once, after delivery to the site, shall be well protected against the possibility of drying by wind and Balls of earth of B & B plants shall be kept covered with soil or other acceptable material. All plants remain the property of the Contractor until final
- C. Position the trees and shrubs in their intended location as per
- D. Notify the Owner's Authorized Representative for inspection and approvel of all positioning of plant materials.
- E. Excavate pits with vertical sides and horizontal bottom. Tree pits shall be large anough to permit handling and planting without injury to balls of earth or roots and shall be of such depth that, when planted and settled, the crown of the plant shall bear the same relationship to the finish grade as it did to soil
- F. Shrub and tree pits shall be no less than twenty-four (24") inches wider than the lateral dimension of the earth ball and six 3,3 CLEANUP AND ACCEPTANCE (6") inches deeper than it's vertical dimension. Remove and hauf from site all rocks and stones over three-quarter (%") inch in diameter. Plants should be thoroughly moist before removing
- G. Dig a wide, rough sided hole exactly the same depth as the height of the ball, especially at the surface of the ground. The sides of the hole should be rough and jagged, never slick or END OF SECTION
- H. Percolation Test: Fill the hole with water. If the water level does not percolate within 24 hours, the tree needs to move to another location or have drainage added. Install a PVC stand pipe per tree planting detail as approved by the Landscape Architect if the percolation test fails.
- Backfill only with 5 parts existing soil or sandy loam and 1 part bed preparation. When the hole is dug in solid rock, topsoil from the same area should not be used. Carefully settle by watering to prevent air pockets. Remove the burlap from the top 1/2 of the ball, as well as all nylon, plastic string and wire. Container trees will usually be root bound, if so follow standard nursery practice of 'root scoring'.
- J. Do not wrap trees.
- K. Do not over prune.
- L. Mulch the top of the ball. Do not plant grass all the way to the trunk of the tree. Leave the area above the top of the ball and mulch with at least two (2") inches of specified mulch.
- M. All plant bods and trees to be mulched with a minimum settled thickness of two (2") inches over the entire bed or pit.
- N. Obstruction below ground: In the event that rock, or underground construction work or obstructions are encountered in any plant pit excavation work to be done under this section, alternate locations may be selected by the Owner. Where locations cannot be changed, the obstructions shall be removed to a depth of not less than three (3') feet below grade and no less than six (6") inches below the bottom of ball when plant is properly set at the required grade. The work of this underground obstructions encountered at the cost of the Landscape
- O. Trees and large shrubs shall be staked as site conditions require. Position stakes to secure trees against seasonal prevailing winds.

- P. Pruning and Mulching: Pruning shall be directed by the Landscape Architect and shall be pruned in accordance with standard horticultural practice following Fine Pruning, Class I pruning standards provided by the National Arborist Association.
- Dead wood, suckers, broken and badly bruised branches shall be removed, General tipping of the branches is not permitted. Do not cut terminal branches.
- 2. Pruning shall be done with clean, sharp tools.
- 3. Immediately after planting operations are completed, all tree pits shall be covered with a layer of organic material two (2") inches in depth. This limit of the organic material for trees shall be the diameter of the plant pit.


### Q. Steel Curbing Installation:

- 1. Curbing shall be aligned as indicated on plans. Stake out limits of steel curbing and obtain Owners approval prior to installation.
- All steel curbing shall be free of kinks and abrupt bends.
- 3. Top of curbing shall be 1/2" maximum height above final finished
- 4. Stakes are to be installed on the planting bed side of the curbing. as opposed to the grass side.

### Do not install steel edging along sidewalks or curbs.


6. Cut steel edging at 45 degree angle where edging meets

Cleanup; During the work, the premises shall be kept neat and orderly at all times. Storage areas for all materials shall be so organized so that they, too, are neat and orderly. All trash and debris shall be removed from the site as work progresses. Keep paved areas clean by sweeping or hosing them at end of each work day.

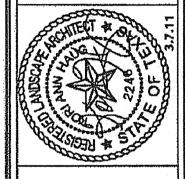

ob no

823 Brookhurst Drive Dallas, Texas 75218 214.708.5274

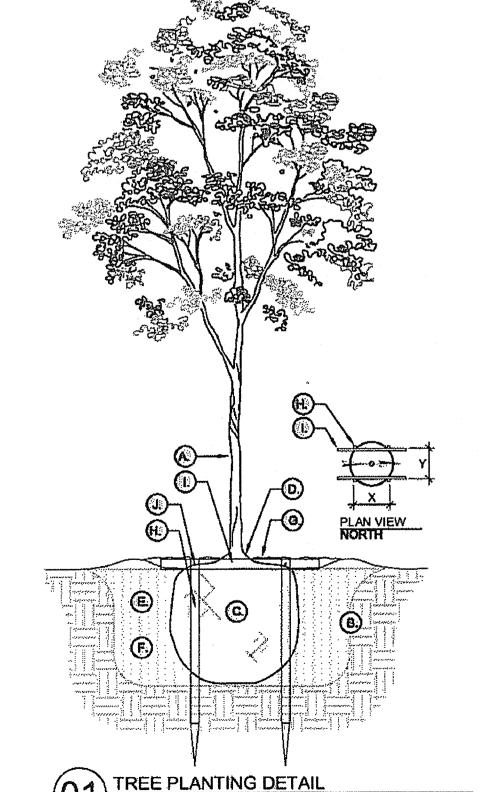

# TREE PLANTING DETAIL LEGEND

(A) TREE: TREES SHALL CONFORM WITH LATEST AMERICAN STANDARD FOR NURSERY STOCK, www.anla.org

(B.) TREE PIT: WIDTH TO BE AT LEAST TWO

(2) TIMES THE DIAMETER OF THE ROOT

AND ANY OTHER FOREIGN OBJECT:

MULCH, AND AT LEAST TWO INCHES

ENDO/ECTO

- BALL CENTER TREE IN HOLE & REST ROOT BALL ON UNDISTURBED NATIVE (C) ROOT BALL: REMOVE TOP 1/3 BURLAP
- CONTAINER GROWN STOCK TO BE INSPECTED FOR GIRDLING ROOTS.\*\* D) ROOT FLARE: ENSURE THAT ROOT FLARE IS EXPOSED \*\*, FREE FROM

ABOVE GRADE.

MYCORRHIZAE

- (E) BACKFILL: USE EXISTING NATIVE SOIL (no amendments) WATER THOROUGHLY TO ELIMINATE AIR POCKETS. (F) FUNGI: APPLY DIVERSE ARRAY
- INOCULANT;\*\* APPLICATION RATE PER MANUFACTURERS SPECIFICATIONS. (G) MULCH: DOUBLE SHREDDED HARDWOOD MULCH 2 INCH DEPTH W/

ROOT FLARE IS EXPOSED.

UNTREATED #1 LUMBER.

2" HT. WATERING RING; ENSURE THAT

(H) VERTICAL STAKES: 2in, by 2in, UNTREATED #1 LUMBER LENGTH OF VERTICAL STAKES TO EXTEND 1 1/2 TIMES THE HEIGHT OF ROOT BALL.\*\* (13) LATERAL SUPPORT: 2in. by 2in.

LENGTH OF LATERAL SUPPORTS TO BE

1 1/2 TIMES DIAMETER OF ROOT BALL.

FASTENERS: 2 1/2in. COARSE THREAD UNFINISHED DRYWALL SCREWS, (2) each PER VERTICAL STAKE; (B) TOTAL. NOTE; PRE-DRILL HOLES IN LATERALS & VERTICALS.


# TREE PLANTING NOTES

NOT APPARENT.

- **GIRDLING ROOTS & ROOT FLARE: TREES** SHALL BE REJECTED WHEN GIRDLING ROOTS ARE PRESENT & ROOT FLARE IS
- FUNGI INOCULANT: CONTRACTOR TO USE MycoApply Endo/Ecto OR EQUAL

# www.mycoapply.com

- (866.476.7800) INSTALL VERTICAL STAKES FIRST; THEN PRE-DRILL & INSTALL LATERAL
- SUPPORTS. WHEN CONDITIONS EXIST WHICH PREVENT VERTICAL STAKES FROM EXTENDING 1 ½ TIMES INTO PARENT MATERIAL (ie. rock), THE CONTRACTOR SHALL INSTALL STAKES AS DEEP AS
- POSSIBLE. 5. LATERAL SUPPORTS SHALL BE ORIENTED AS SHOWN IN PLAN VIEW.
- QUESTIONS ABOUT INSTALLATION OR FABRICATION OF BELOW-GROUND STAKING SHALL BE DIRECTED TO LANDSCAPE ARCHITECT.
- ALSO REFERENCE SPECIFICATIONS SECTION 02900.

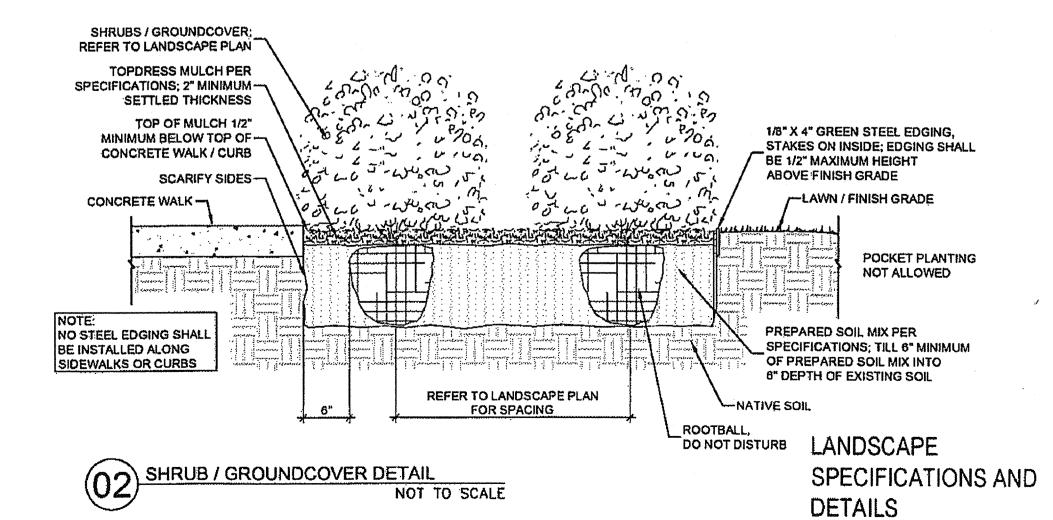

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